


EXTERIOR LIGHTING FIXTURE SCHEDULE							
TYPE	DESCRIPTION	QTY/NO.	LUMPS PER FIXTURE			MOUNTING	REMARKS
			TYPE	WATT	COLOR		
W1	WALL MOUNT	PERFORMANCE IN LIGHTING	LED	15	3000K	SURFACE	C/W ACCESSORIES
B	EXTERIOR LIGHTING BOLLARD	PERFORMANCE IN LIGHTING PL - KWA-B-830-071651	LED	15	3000K	SURFACE	C/W ACCESSORIES
4	CEILING CANOPY	PERFORMANCE IN LIGHTING LFR-480-M-6L35KNO-DM1-LFR-480-1-S	LED	32.89	3000K	SURFACE	C/W ACCESSORIES
5	WALL MOUNT	PERFORMANCE IN LIGHTING PWL-16X-65-46-47	LED	65	4000K	SURFACE	C/W ACCESSORIES

LIGHTING LEGEND	
SYMBOL	DESCRIPTION
	LIGHT FIXTURE - TYPE AS SHOWN
	LIGHT FIXTURES ON EMERGENCY POWER OR NIGHT LIGHT - DO NOT SWITCH
	CEILING MOUNTED LIGHT FIXTURE - TYPE AS SHOWN
	WALL MOUNTED LIGHT FIXTURE - TYPE AS SHOWN
	EXTERIOR POLE MOUNTED LIGHT FIXTURE - TYPE AS SHOWN
	EXTERIOR BOLLARD LIGHT FIXTURE - TYPE AS SHOWN

- GENERAL NOTES**
- TYPICAL
- REFER TO ARCHITECTURAL ELEVATIONS FOR ALL BUILDING MOUNTED LIGHTS. COORDINATE EXACT LOCATION PRIOR TO CONSTRUCTION.
 - FINAL FIXTURE FINISH COLOR SELECTION SHALL BE BY ARCHITECT.
 - ALL LED FIXTURES SHALL BE C/W DRIVERS.
 - ALL EXTERIOR SITE LIGHT FIXTURE TO BE OPERATED BY PHOTOCELL.

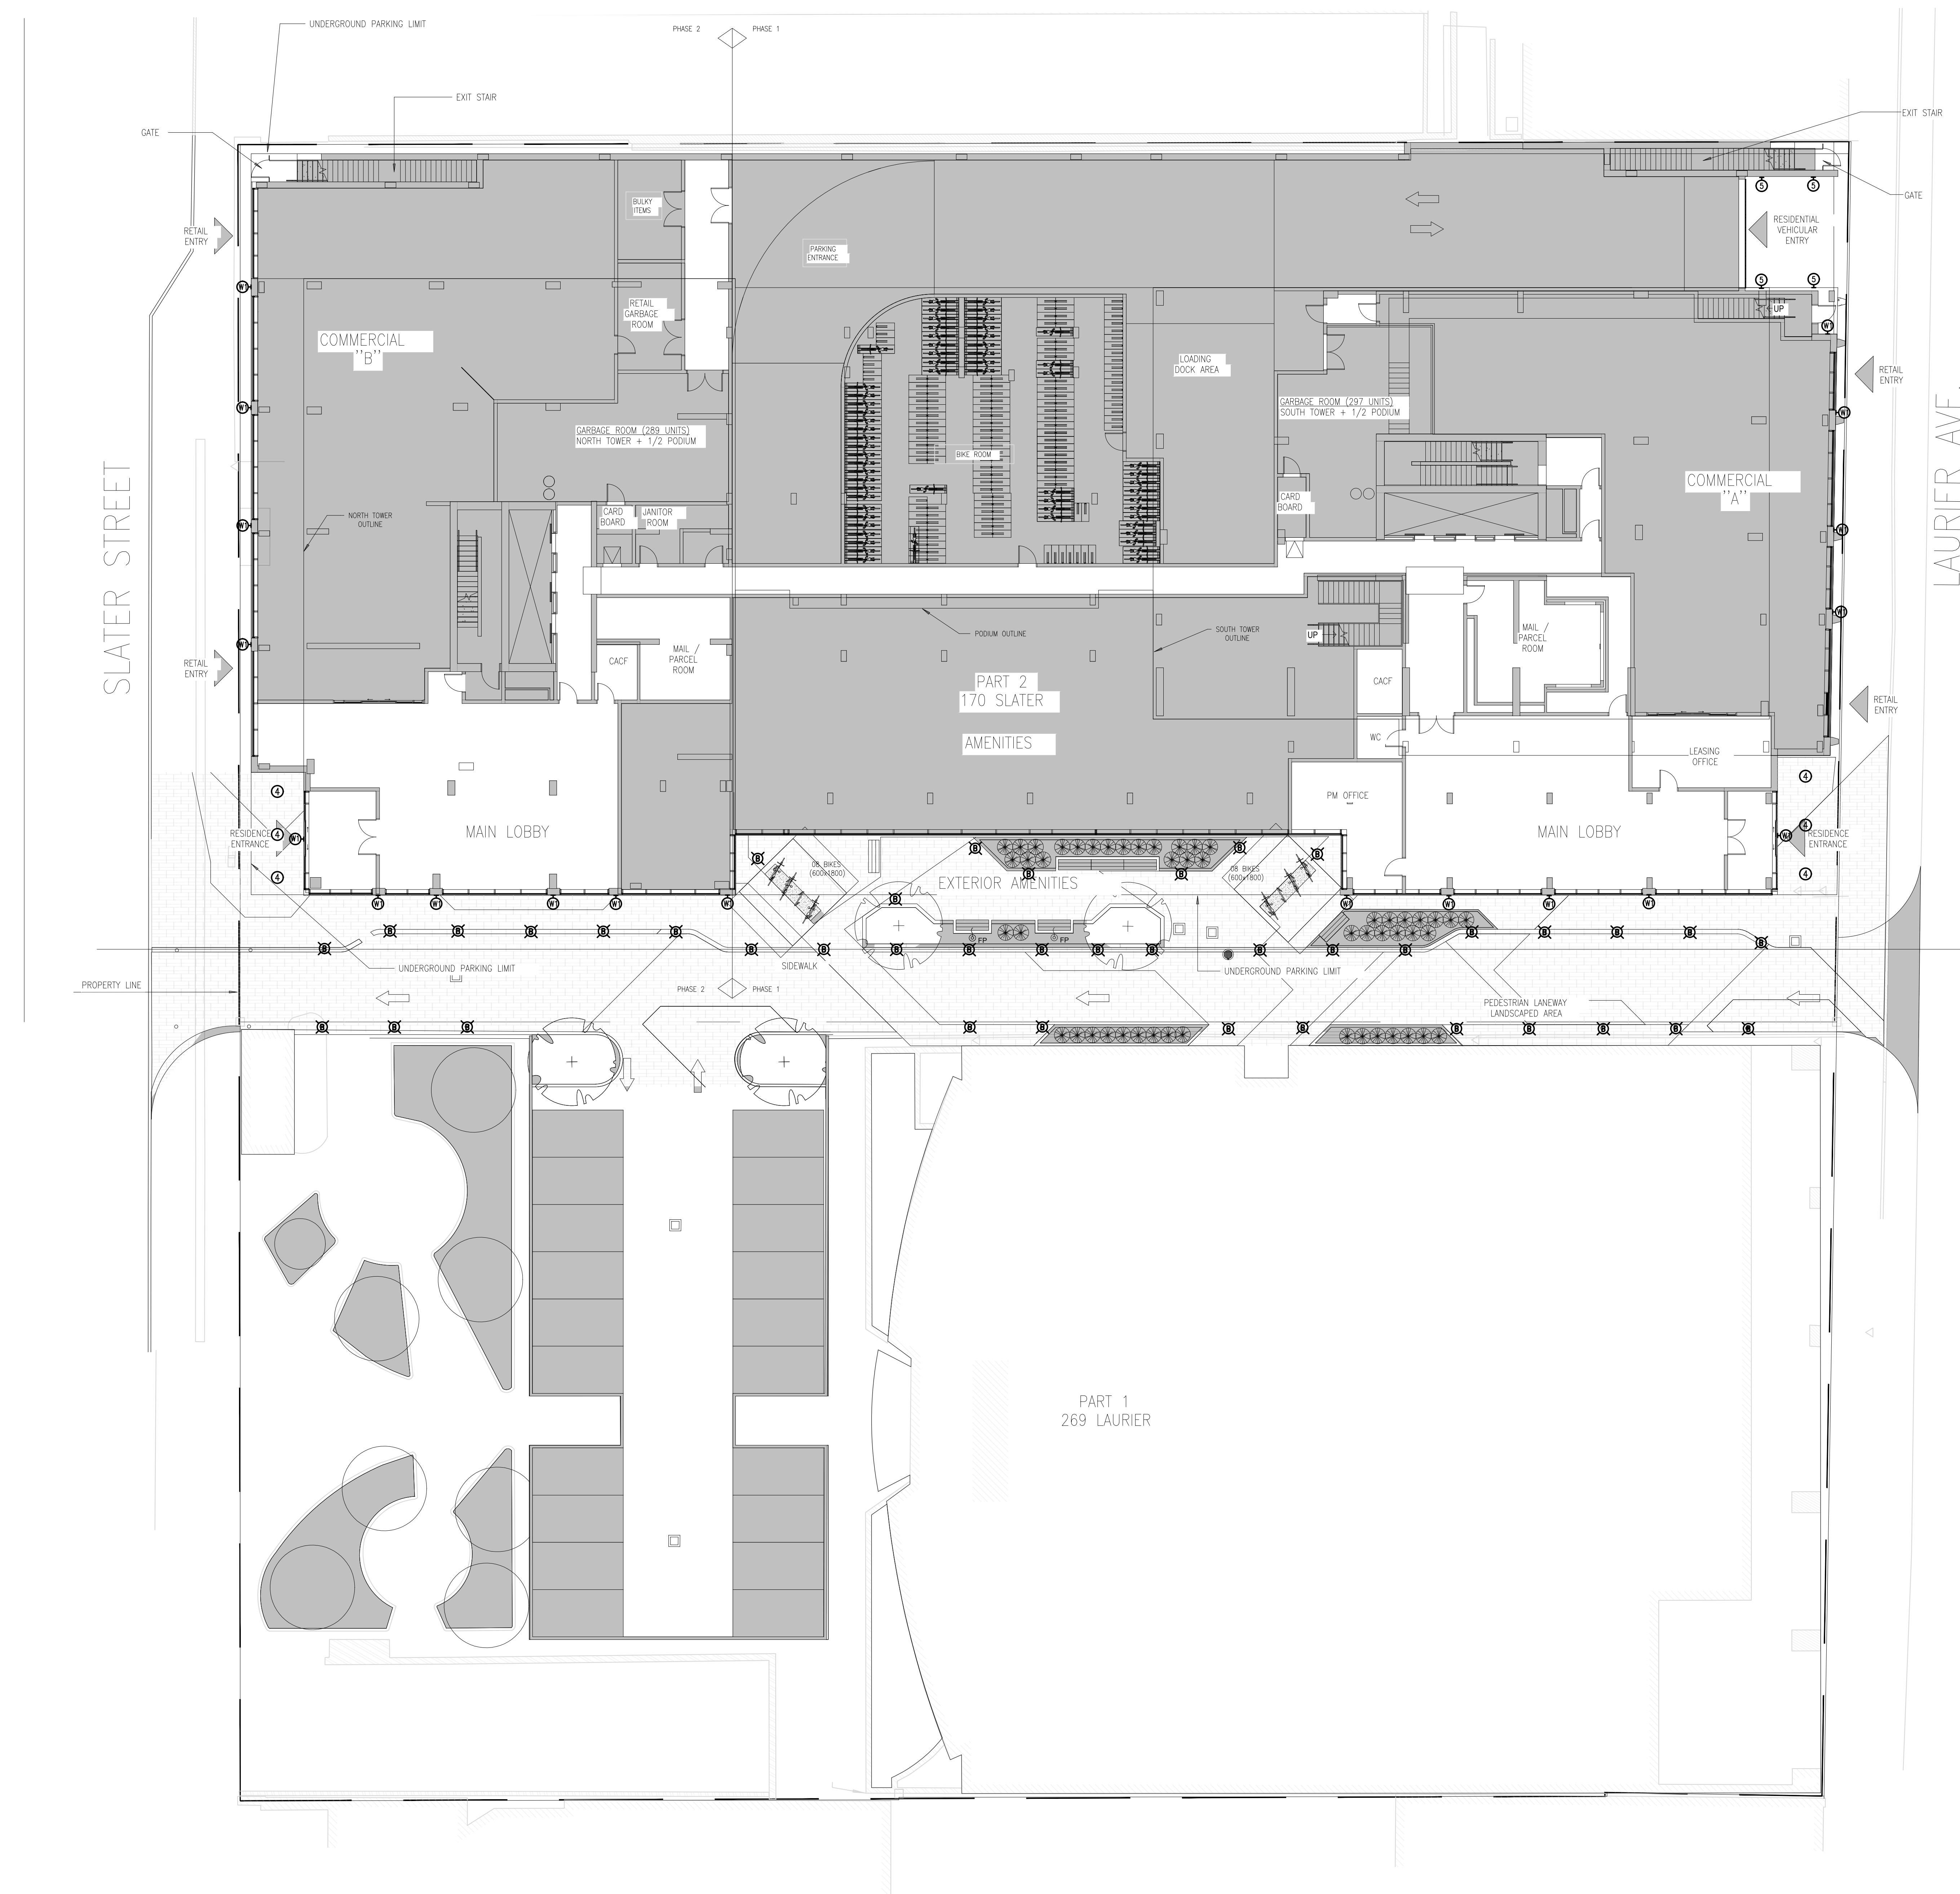

ELECTRICAL SITE PLAN
E1
1:150

2024-04-26	ISSUED FOR SITE PLAN REVIEW		
2024-03-11	ISSUED FOR SITE PLAN		
DATE	REVISION	REV	

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Project north
North du projet


Professional Engineer
D. B. VIVAS
PROFESSIONAL ENGINEER
PROVINCE OF ONTARIO

Project/Projet
170 SLATER STREET
OTTAWA, ON

Drawing/Plan No. de dessin
ELECTRICAL
SITE PLAN

Scale Échelle	AS NOTED 2022-689	Project no./No. du projet 2022-689
Design by Conçu par	LALU	Drawing/Design 2022-689
Drawn by Dessiné par	H.PANDEY	E1
Reviewed by Examiné par	D.VIVAS	

Client

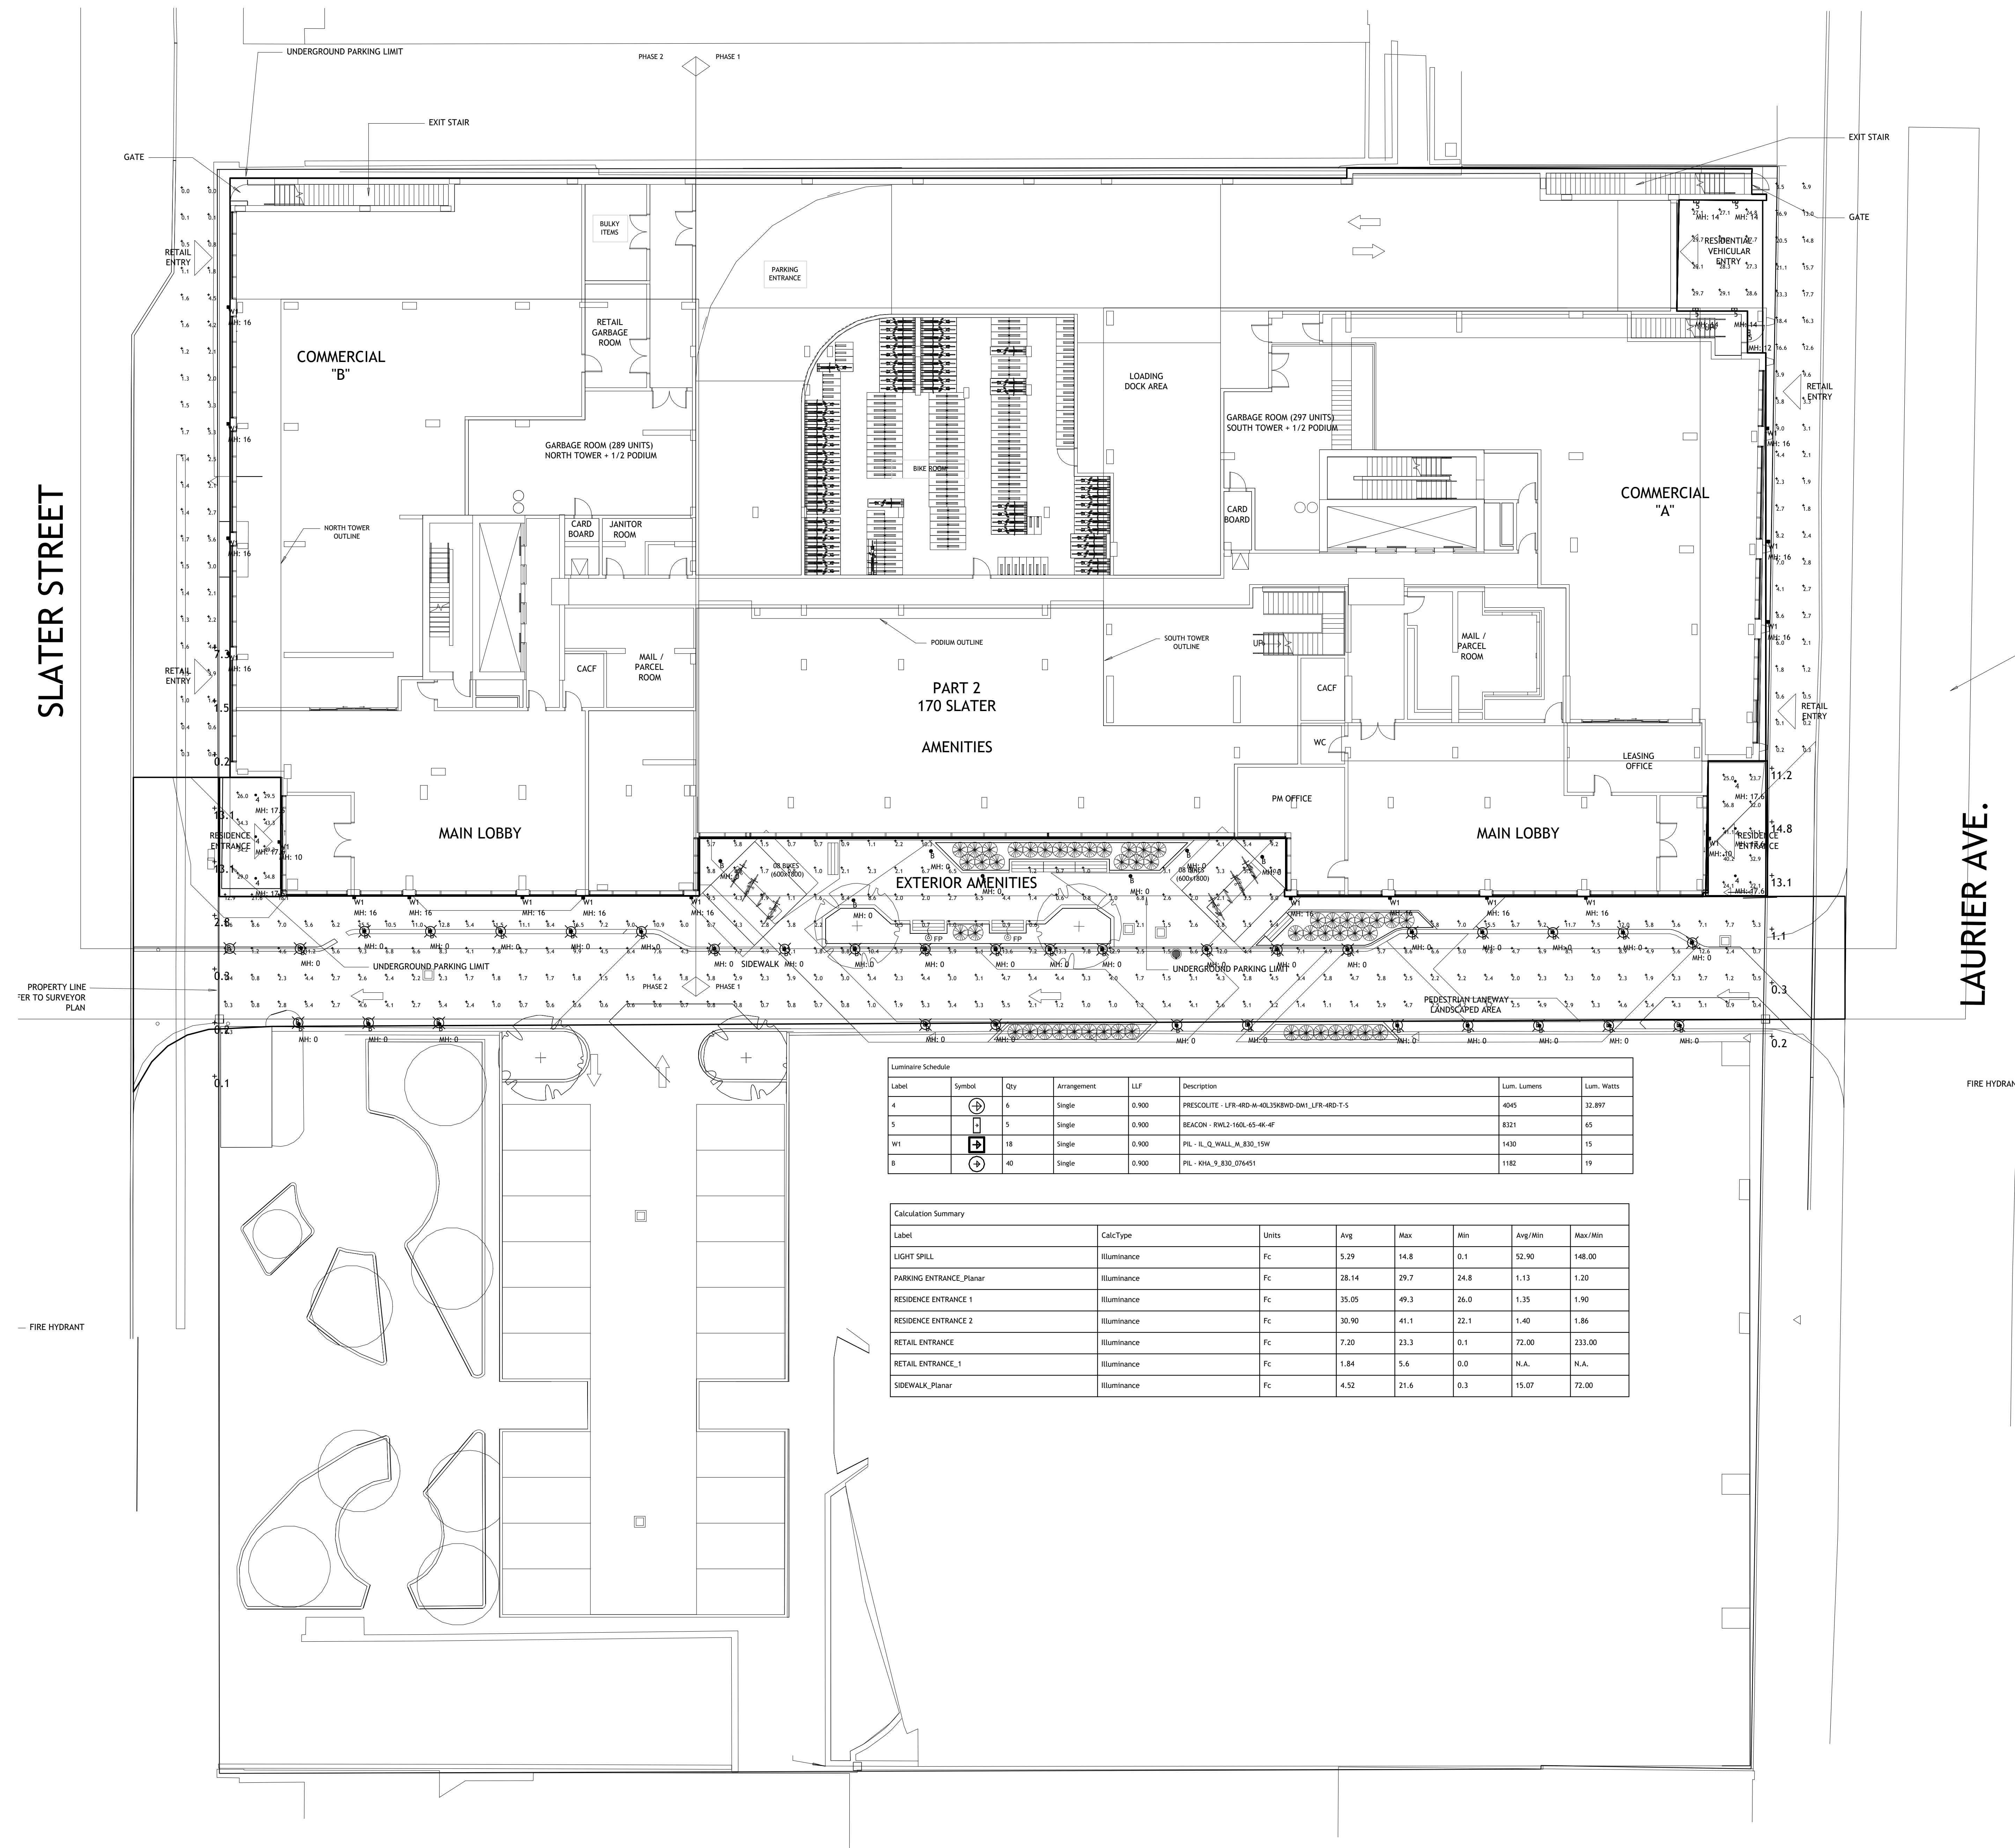

Label	Symbol	Qty	Arrangement	LF	Description	Lum. Lumens	Lum. Watts
A	⊕	4	Single	0.300	RECULITE - 175-400-H-402500W-DNA1_LFR-400-T-5	4075	32.897
S	⊕	5	Single	0.300	SEACOR - PMS2-1605-65-48-4F	8321	65
W1	⊕	18	Single	0.300	PL - H_L_WALL_ALB_15W	1430	15
S	⊕	40	Single	0.300	PL - A14-9_830_075-01	1182	19

Label	CalcType	Units	Avg	Max	Min	Avg/Min	Max/Min
LIGHT SPILL	Illuminance	Fc	5.29	14.8	0.1	52.90	148.00
PARKING ENTRANCE_Planar	Illuminance	Fc	28.14	29.7	24.8	1.13	1.20
RESIDENCE ENTRANCE 1	Illuminance	Fc	35.05	49.3	26.0	1.35	1.90
RESIDENCE ENTRANCE 2	Illuminance	Fc	30.90	41.1	22.1	1.40	1.86
RETAIL ENTRANCE_1	Illuminance	Fc	7.20	23.3	0.1	72.00	233.00
RETAIL ENTRANCE_2	Illuminance	Fc	1.84	5.6	0.0	N.A.	N.A.
SIDEWALK_Planar	Illuminance	Fc	4.52	21.6	0.3	15.07	72.00

1 ELECTRICAL SITE PHOTOMETRIC
E2 1:150

DATE	REVISION	REF
2024-04-26	ISSUED FOR SITE PLAN REVIEW	-
2024-03-11	ISSUED FOR SITE PLAN	-

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Project: 170 Slater Street
Drawn by: H. PANDEY
Checked by: D. VYAS
Professional Engineer
D. B. VYAS
PROFESSIONAL ENGINEER
PROVINCE OF ONTARIO

170 SLATER STREET
OTTAWA, ON

Drawing Title: **ELECTRICAL SITE PHOTOMETRIC**

Scale: AS NOTED
Date: 2022-689
Design by: LAU
Checked by: H. PANDEY
Reviewed by: D. VYAS

Project no./No. du projet: 2022-689
Drawing/Drawn: E2