

OWNER/APPLICANT: REZY PROPERTIES INC.	DEVELOPMENT INFORMATION	GENERAL NOTES
285 MCLEOD ST OTTAWA, ON	ZONING: R5B H(19)         TOTAL # OF UNITS: 31           BYLAW         REQUIREMENT         PROVIDED	IT IS THE RESPONSIBILITY OF THE CONTRACTOR TO VERIFY ALL DIMENSIONS ON SITE AND REPORT ANY
K2P 1A1 613-233-0349	MIN. LOT WIDTH         30.83m           MIN. LOT AREA         832.1 m2	ERRORS AND OMISSIONS TO THE ARCHITECT. ALL CONTRACTORS MUST COMPLY WITH ALL PERTINENT
	MAX. LOT COVERAGE 67% MAX. BUILDING HEIGHT 19m - 13m WITHIN 9m OF FRONT LOT LINE	CODES AND BY-LAWS. DO NOT SCALE DRAWINGS. THESE DRAWINGS MAY NOT BE USED FOR
AKG MANAGEMENT INC. 680 EAGLESON ROAD, BOX 45011 OTTAWA, ON	MIN. FRONT YARD SETBACK         1.65m         1.65m           MIN. REAR YARD SETBACK         5.7m         5.7m           MIN. INTERIOR SIDE YARD         1.2m         1.2m	CONSTRUCTION UNTIL SIGNED. THIS DRAWING IS THE EXCLUSIVE PROPERTY OF COLIZZA BRUNI ARCHITECTURE INCORPORATED. COPYRIGHT
K2M 2G9 613-983-2290	SETBACK     1.2m       MIN. SIDE YARD SETBACK     1.2m	RESERVED.
ARCHITECT:	TOTAL PARKING         7+1V         8 U/G           INDOOR PARKING         7+1V         7+1V U/G	NO. REV DATE REV DESCRIPTION
COLIZZA BRUNI ARCHITECTURE INC. 76 CHAMBERLAIN AVENUE	OUTDOOR PARKING     N/A     0       VISITOR PARKING     1     1       BARRIER-FREE PARKING     0     0	01 24-01-23 ISSUED FOR SPC SUBMISSION
OTTAWA, ON K1S 1V9	BICYCLE PARKING 31 31	02 24-03-21 RE-ISSUED FOR SPC SUBMISSION
613-236-2944	UNIT # OF # OF OCCUPANT	03 24-04-12 RE-ISSUED FOR SPC SUBMISSION
MECHANICAL & ELECTRICAL ENGINEERING: COSMEL CORP.	TYPE         AREA         CONFIGURATION         UNITS         BEDROOMS         LOAD           A         80.14 m <sup>2</sup> 2 BR         1         2         4	04 24-05-03 ISSUED FOR PERMIT SUBMISSION
178, GRéBER BLVD, SUITE 105 GATINEAU, QC	B         44.46 m²         1 BR         1         1         2           B1 (BF)         61.97 m²         2 BR         4         8         16	05 24-05-10 RE-ISSUED FOR SPC SUBMISSION
J8T 6Z6 819-205-3283	C         38.66 m²         1 BR         5         5         10           D         56.00 m²         1 BR & DEN         1         1         2           D1 (BF)         72.03 m²         2 BR         1         2         4	
STRUCTURAL ENGINEERING: GOODEVE STRUCTURAL INC.	D2         56.14 m²         1 BR & DEN         1         1         2           D3         57.90 m²         1 BR & DEN         1         1         2           E         68.72 m²         2 BR         1         2         4	
77 AURIGA DR. NEPEAN, ON	F         83.85 m²         2 BR         1         2         4           G         47.65 m²         1 BR         1         1         2	
K2E 7Z7 613-226-4558	G1 (BF)         54.83 m <sup>2</sup> 1 BR         1         1         2           G2 (BF)         56.66 m <sup>2</sup> 1 BR         1         1         2           H         36.62 m <sup>2</sup> BACHELOR         1         1         2	
CIVIL ENGINEERING:	H1 (BF)         37.91 m²         BACHELOR         1         1         2           H2         47.79 m²         BACHELOR         1         1         2           I         75.71 m²         2 BR         1         2         4	
STANTEC 1331 CLYDE AVE, SUITE 300	J         88.68 m²         2 BR         1         2         4           K         47.48 m²         BACHELOR         1         1         2           L         33.73 m²         BACHELOR         1         1         2	
OTTAWA, ON K2C 3G4 642 722 4420	M         105.81 m²         2 BR & DEN         1         2         4           N         46.08 m²         1 BR         1         1         2	
613-722-4420	O         51.90 m²         1 BR         1         1         2           P         45.74 m²         1 BR         1         1         2           TOTAL         31         42         84	
GEOTECHNICAL ENGINEERING: PATTERSON GROUP 9 AURIGA DR.	BARRIER-FREE UNIT %	
OTTAWA, ON K2E 7T9	# OF         # OF         OCCUPANT         % OF TOTAL           CONFIGURATION UNITS         BEDROOMS         LOAD         3.8.2.1.(5)         BF	
613-226-7381	1 BR         2         2         4         5%         Yes           2 BR         5         10         20         24%         Yes	
LANDSCAPE ARCHITECTURE: STANTEC	BACHELOR 1 1 2 2% Yes	
1331 CLYDE AVE, SUITE 300 OTTAWA, ON	1 BR & DEN         3         3         6         7%         No           2 BR         5         10         20         24%         No	
K2C 3G4 613-722-4420	2 BR & DEN         1         2         4         5%         No           BACHELOR         4         4         8         10%         No	
SURVEYOR:	UNIT FLOOR AREA BY LEVEL	
ANNIS O'SULLIVAN VOLLEBEKK LTD. ONTARIO LAND SURVEYORS	FLOOR LEVEL AREA UNITS BDRMS LOAD	
14 CONCOURSE GATE, SUITE 500, NEPEAN, ON K2E 7S6	T/O BASEMENT SLAB         97.98 m²         2         2         4           T/O MAIN FLOOR SLAB         349.74 m²         6         9         18           T/O SECOND FLOOR SUBFLOOR         397.70 m²         7         10         20	
613-727-0850	T/O THIRD FLOOR SUBFLOOR         390.38 m²         6         9         18           T/O FOURTH FLOOR SUBFLOOR         251.21 m²         5         6         12	
PLANNER: FOTENN PLANNING & DESIGN	T/O FIFTH FLOOR         SUBFLOOR         249.99 m²         5         6         12           TOTAL         1737.00 m²         31         42         84	
396 COOPER ST SUITE 300, OTTAWA, ON	GROSS FLOOR AREA ABOVE/BELOW GRADE	
K2P 2H7 613-730-5709	ABOVE GRADE         GFA OF APARTMENTS         1639.02 m²         84%           ABOVE GRADE         REMAINING GFA         316.81 m²         16%	
	BELOW GRADE GFA OF APARTMENTS     97.98 m <sup>2</sup> 21%       BELOW GRADE REMAINING GFA     364.26 m <sup>2</sup> 79%	
	GROSS BUILDING AREA BY LEVEL	
	FLOOR LEVEL AREA PERCENTAGE	
	T/O MAIN FLOOR SLAB         492.90 m²         19%           T/O SECOND FLOOR SUBFLOOR         496.22 m²         19%	
	T/O THIRD FLOOR         422.88 m²         16%           T/O FOURTH FLOOR SUBFLOOR         333.48 m²         13%           T/O FIFTH FLOOR SUBFLOOR         341.66 m²         13%	
	TOTAL 2580.66 m <sup>2</sup>	
	FLOOR AREA PERCENTAGE           NAME         AREA         PERCENTAGE	
	GFA OF APARTMENTS         1737.00 m <sup>2</sup> 72%           REMAINING GFA         681.07 m <sup>2</sup> 28%	
	TOTAL 2418.07 m <sup>2</sup>	ASSOC/
	SITE & L.O.S. PERCENTAGE PERCENTAGE	ARCHITECTS Z
	NAME AREA REQUIRED PROVIDED	S ARCHITECTS Z
	LANDSCAPE         283.99 m²         30%         34%           BUILDING         548.03 m²         N/A         66%           TOTAL         832.02 m²	
		ANTHONY D. BRUNI
NOTES:		6554 (1)1111 ·····
1. REFER TO LANDSCAPE PLAN FOR		
VEGETATION TYPE AND LOCATION 2. ALL NEW EXTERIOR HARD SURFACES,		
PATHS, AND DRIVES TO BE EQUIPPED WITH SNOW MELTING		COLIZZA BRUNI
3. PROPERTY BOUNDARY INFORMATION DERIVED FROM SURVEY PERFORMED ON		architecture
THE 4TH DAY OF APRIL, 2018 BY ANNIS, O'SULLIVAN, VOLLEBEKK LTD.		
		76 CHAMBERLAIN AVE • OTTAWA • ONTARIO • K1S 1V9
LEGEND:		T 613.236.2944 •F 613.236.6777 •www.colizzabruni.com
		PROJECT NAME
NEW SOFT SCAPE		283 & 285 McLEOD
NEW HARD SCAPE		STREET
NEW RIVER STONE		
		OTTAWA, ON DRAWING TITLE
\$\phi^{FD}\$FLOOR DRAIN		
↔ <sup>₩D</sup> WINDOW WELL DRAIN	GLADSTONE AVE	
X SOFFIT LIGHT		PROJECTIVERTH
WALL MOUNTED LIGHT		
		SCALE DRAWING NO.
	MCLEOD ST	
O PEDESTAL LIGHTING 32"H		BS SP1
AFF ABOVE FINISHED FLOOR		DATE 05/10/24
AFG ABOVE FINISHED GRADE		SCALE AS NOTED DRAWN BY BS DATE 05/10/24 PROJECT NO. 01917
		01917 PLAN NO.:18721

PLAN NO.:18721

$\begin{pmatrix} 1 \end{pmatrix}$	SOUTH ELEVATION
A200	3/16" = 1'-0"



#### GENERAL NOTES:

- ADD 1" TO OVERALL DIMENSIONS FOR WINDOW & DOOR ROUGH STUD OPENINGS [RSO] UNLESS NOTED OTHERWISE
- WINDOW & DOOR [COLOUR: 'BLACK' EXTERIOR, 'WHITE' INTERIOR]
- SOFFITS TO BE PRE-FINSIHED METAL VENTED. COLOUR:
- BLACK INSTALL LIGHT AT EXTERIOR DOORS
- ALL PRE-FINISHED METALS 4" OR LESS TO BE MIN. 26 GA. 4"-6" TO BE MIN. 24 GA. 6" OR GREATER TO BE MIN. 22 GA.
- AN ASTERISK (\*) WITHIN WINDOW TAG DENOTES REQUIREMENT OF SPRINKLER-PROTECTED WINDOW SYSTEM IN ACCORDANCE WITH CAN/ULC-S136:2021 AS PER
- OBC 3.1.8.18. AN ASTERISK (\*) WITHIN WINDOW TAG DENOTES REQUIREMENT OF SPRINKLER-PROTECTED WINDOW SYSTEM IN ACCORDANCE WITH CAN/ULC-S136:2021 AS PER

#### MATERIALS LEGEND

OBC 3.1.8.18.

MV - MASONRY VENEER [COLOUR: RED]

SW - SYNTHETIC WOOD RIBBED SIDING AS PER MANUFACTURER. NEW TECHWOOD CANADA. [COLOUR: BLACK OR CHARCOAL GREY. INSTALLED VERTICALLY]

CB - CEMENT BOARD BY KOL. [COLOUR: LIGHT GREY] CP - CEMENT PARGING

SR - SLOPED STEEL ROOFING [COLOUR: BLACK OR CHARCOAL GREY]

**GL** - INSULATED GLAZING UNITS

L - INTEGRATED PRE-FINISHED MECHANICAL LOUVRE [COLOUR: BLACK]

### AL - PRE-FINISHED ANNODIZED ALUMINUM WINDOW FRAME [COLOUR: BLACK]

C - CANOPY

YPICAL WINDOW LEGEND		
•		
•	GL	
	——GL	

#### **GENERAL NOTES**

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0	)3	24-04-12	RE-ISSUED FOR SPC SUBMISSION
0	)4	24-05-03	ISSUED FOR PERMIT SUBMISSION
0	)5	24-05-10	RE-ISSUED FOR SPC SUBMISSION



### COLIZZA BRUNI architecture

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### 283 & 285 McLEOD STREET

OTTAWA, ON

### DRAWING TITLE SOUTH ELEVATION

DRAWING NO.

SCALE AS NOTED DRAWN BY DATE 05/10/24

PROJECT NO. 01917

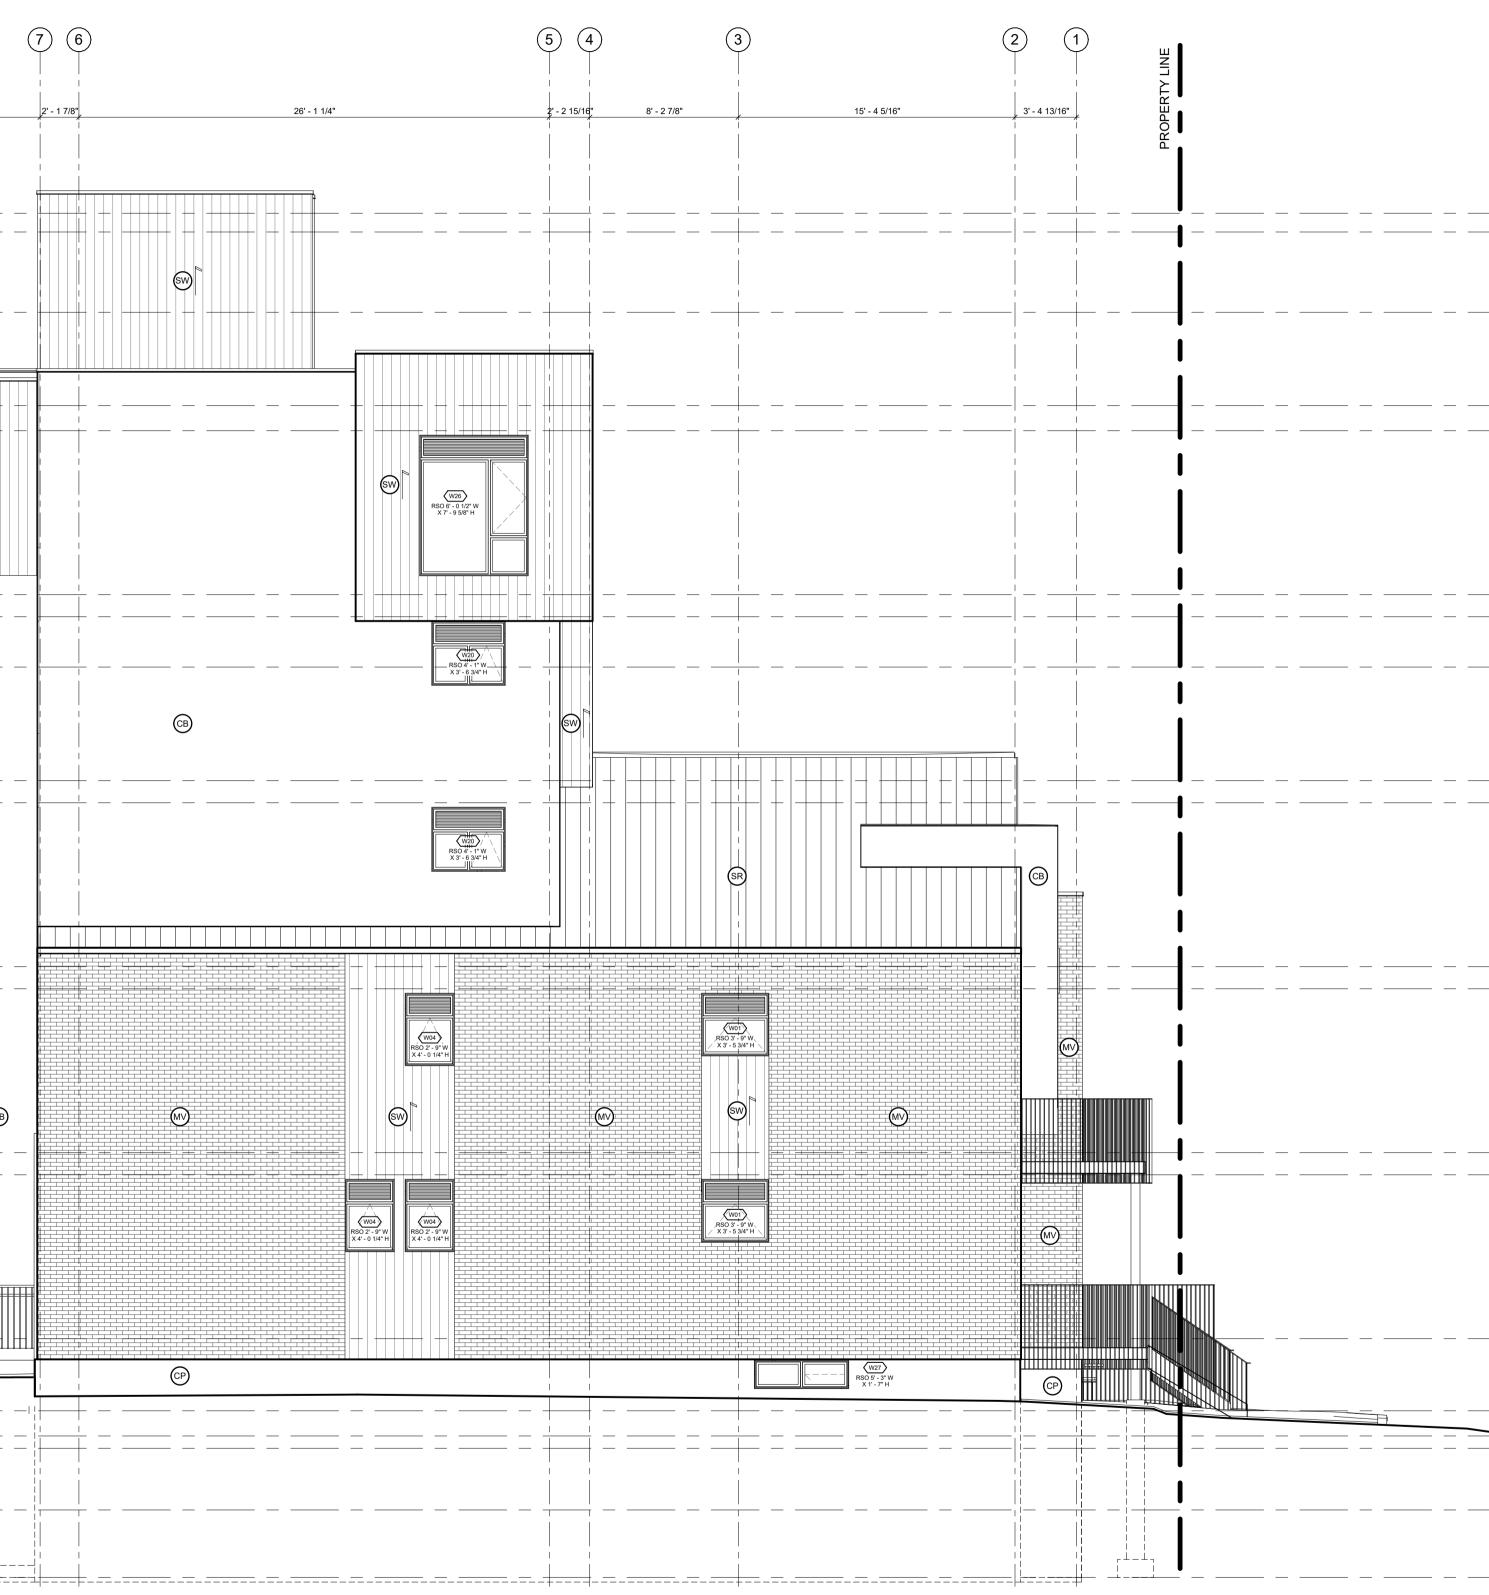
A200

\_\_\_\_

			2' - 3 11/16" 14' - 4 1/8"
		РКО	
	91.33 T/O PENTHOUSE ROOF SUBFLOOR		
	(91.33) T/O PENTHOUSE ROOF SUBFLOOR       50         91.02       T/O PENTHOUSE FLOOR WALL PLATE		
	89.66 MAX BUILDING HEIGHT		
	õ	I	
	88.08 T/O ROOF SUBFLOOR		
	87.66 T/O FIFTH FLOOR WALL PLATE		
	9 1 1/8.		
	84.89         T/O FIFTH FLOOR         50         70           84.89         T/O FIFTH FLOOR         70         70		
	84.51 T/O FOURTH FLOOR WALL PLATE		
	(83.66) MAX BLDG HEIGHT WITHIN 9m OF FRONT LOT LINE		
	م 1		CB
	81.74 T/O FOURTH FLOOR_SUBFLOOR		
		1	
	9 - 1 1/8"		RS
	78.60 T/O THIRD FLOOR SUBFLOOR		
[13.00]	78.22 T/O SECOND FLOOR WALL PLATE		
13/10	1/8"		
42 - 1	9. 		
	75.45 T/O SECOND FLOOR		
	75.08 T/O MAIN FLOOR WALL PLATE		
	9' - 1 1/8"		
	72.30 T/O MAIN FLOOR SLAB		
	71.09) T/O SLAB AT ENTRY	+	
	(71.09)         T/O SLAB AT ENTRY		
	70.45 AVERAGE EXISTING GRADE	<b>↑</b>	
	69.41 T/O BASEMENT SLAB		
	0 		
	(68.27) U/S RAFT SLAB	•	

98

1 WEST ELEVATION A201 3/16" = 1'-0"



#### GENERAL NOTES:

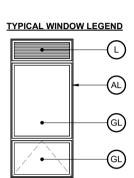
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#### MATERIALS LEGEND

- MV MASONRY VENEER [COLOUR: RED]
- SW SYNTHETIC WOOD RIBBED SIDING AS PER MANUFACTURER. NEW TECHWOOD CANADA. [COLOUR: BLACK OR CHARCOAL GREY. INSTALLED VERTICALLY]
- CB CEMENT BOARD BY KOL. [COLOUR: LIGHT GREY]
- **CP** CEMENT PARGING SR - SLOPED STEEL ROOFING [COLOUR: BLACK OR CHARCOAL GREY
- **GL** INSULATED GLAZING UNITS
- L INTEGRATED PRE-FINISHED MECHANICAL LOUVRE [COLOUR: BLACK]

### AL - PRE-FINISHED ANNODIZED ALUMINUM WINDOW FRAME [COLOUR: BLACK]

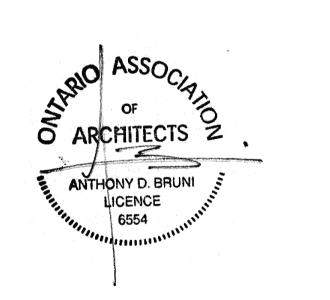
**C** - CANOPY



#### **GENERAL NOTES**

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### 283 & 285 McLEOD STREET

OTTAWA, ON

DRAWING TITLE
WEST
ELEVATION

DRAWING NO.

AS NOTED DRAWN BY DATE 05/10/24

SCALE

PROJECT NO. 01917

A201



1 NORTH ELEVATION A202 3/16" = 1'-0"

#### GENERAL NOTES:

- ADD 1" TO OVERALL DIMENSIONS FOR WINDOW & DOOR ROUGH STUD OPENINGS [RSO] UNLESS NOTED OTHERWISE
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- INTERIOR] SOFFITS TO BE PRE-FINSIHED METAL VENTED. COLOUR:
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- OBC 3.1.8.18. AN ASTERISK (\*) WITHIN WINDOW TAG DENOTES REQUIREMENT OF SPRINKLER-PROTECTED WINDOW SYSTEM IN ACCORDANCE WITH CAN/ULC-S136:2021 AS PER

#### MATERIALS LEGEND

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CB - CEMENT BOARD BY KOL. [COLOUR: LIGHT GREY]

**CP** - CEMENT PARGING

SR - SLOPED STEEL ROOFING [COLOUR: BLACK OR CHARCOAL GREY]

GL - INSULATED GLAZING UNITS

L - INTEGRATED PRE-FINISHED MECHANICAL LOUVRE [COLOUR: BLACK]

### AL - PRE-FINISHED ANNODIZED ALUMINUM WINDOW FRAME [COLOUR: BLACK]

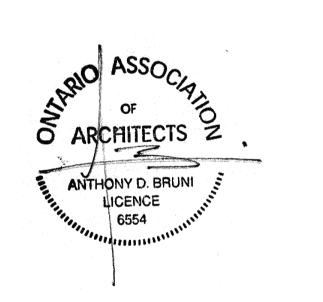
**C** - CANOPY

PICAL WINDOW LEGEND		
•		
	(AL)	
•	GL	
	GL	

#### **GENERAL NOTES**

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# COLIZZA BRUNI architecture

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### PROJECT NAME

### 283 & 285 McLEOD STREET

OTTAWA, ON

## DRAWING TITLE ELEVATION

DRAWING NO.

AS NOTED DRAWN BY DATE 05/10/24

SCALE

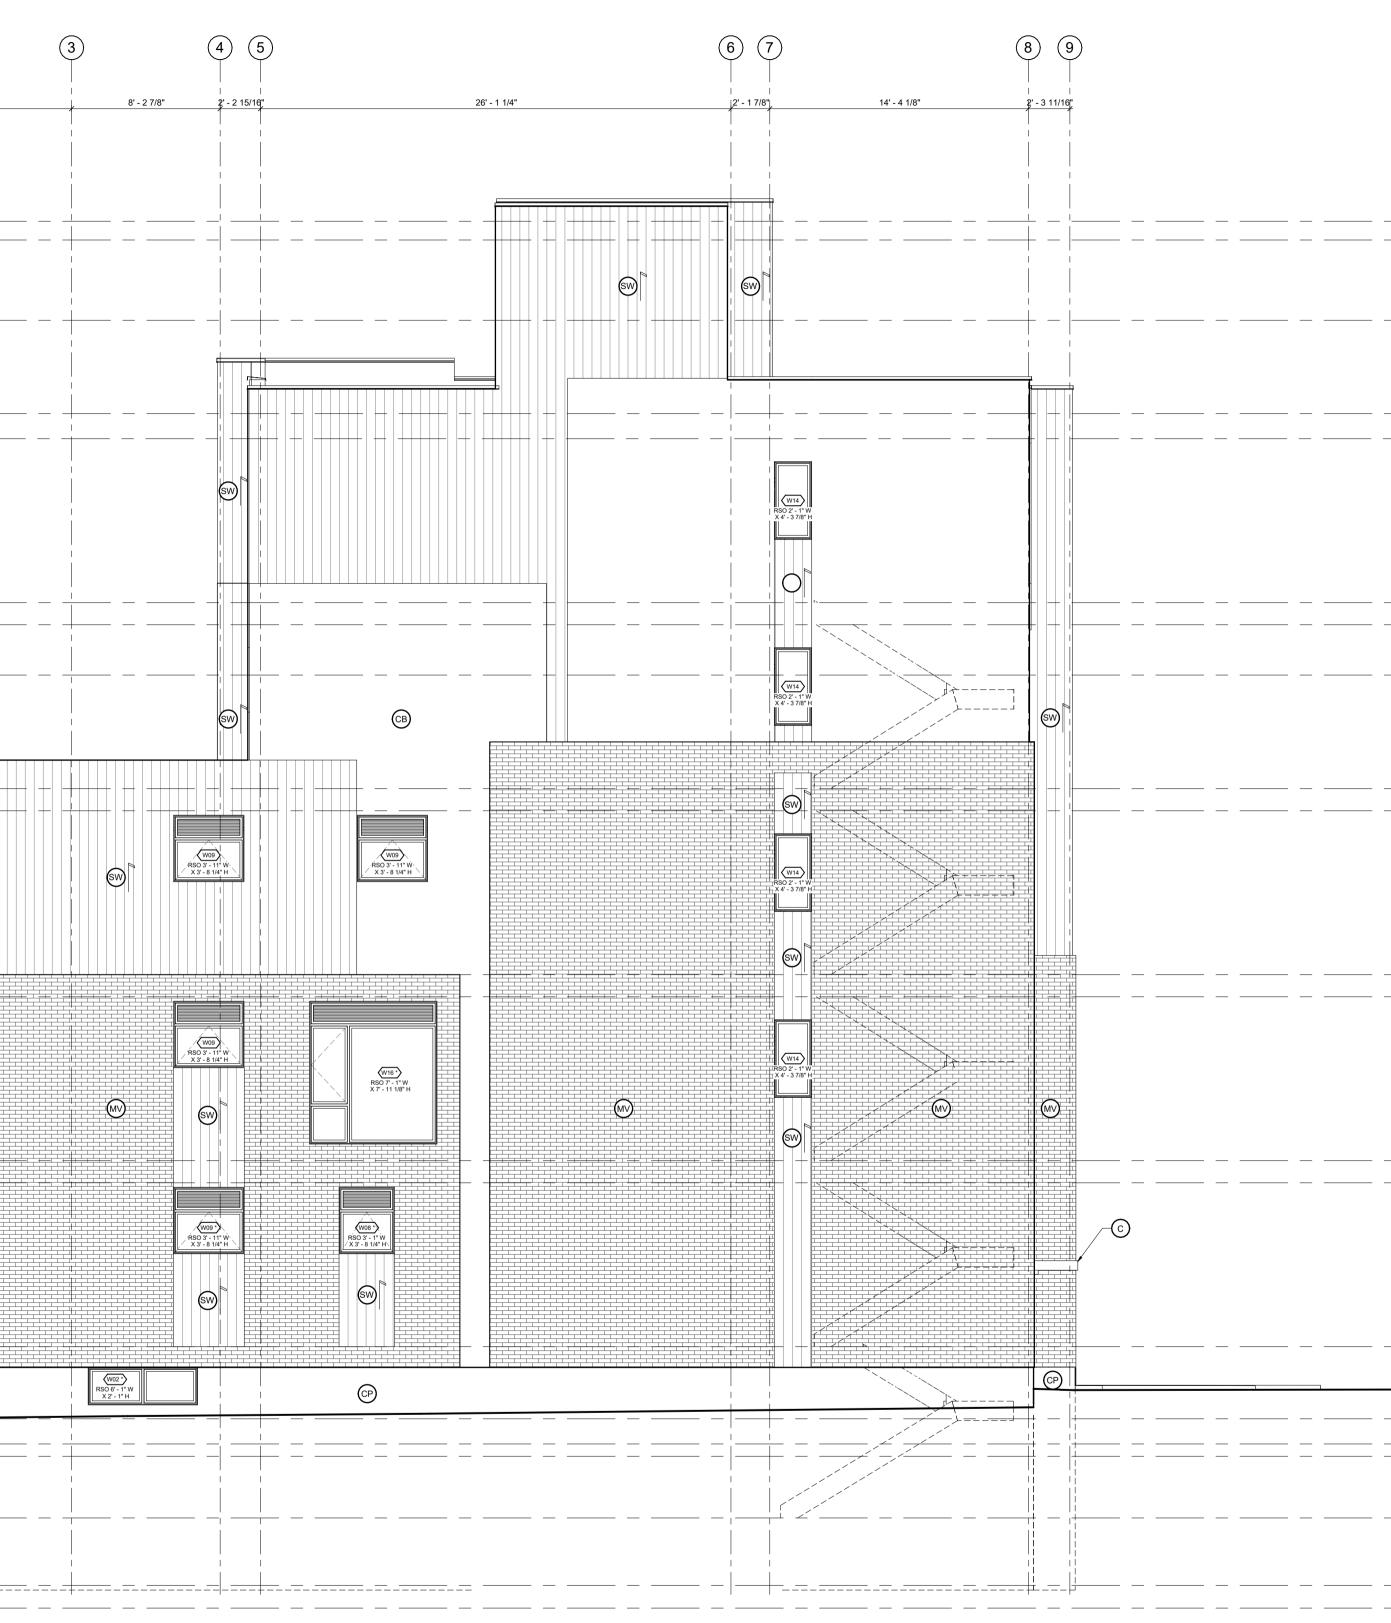
PROJECT NO. 01917

A202

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			PROPERTY LINE	   3'-4 13/16"     	15' ·
	$\sim$		R		
	91.33 T/O PENTHOUSE ROOF SUBFLOOR		 ·		
	89.66 MAX BUILDING HEIGHT	5.			
<b>\</b>		7 <u>1/2</u> "		+ +	
	88.08 T/O ROOF SUBFLOOR		 - 		
	87.66 T/O FIFTH FLOOR WALL PLATE		 		
		- 1/8"			
		ັ, ັກ			
	84.89 T/O FIFTH FLOOR SUBFLOOR				
	84.51 T/O FOURTH FLOOR WALL PLATE 83.66 MAX BLDG HEIGHT WITHIN 9m OF FRONT LOT LINE				
		9' - 1 1/8"			
	$\frown$				
	81.74         T/O FOURTH FLOOR SUBFLOOR           81.37         T/O THIRD FLOOR WALL PLATE		 		
		δ		(CB)	
		9 - 1 1			W23 RSO 5' - 1" W X 8' - 10 1/8" H
	78.60 T/O THIRD FLOOR_SUBFLOOR		 		
13.00]	78.22 T/O SECOND FLOOR WALL PLATE		 		
42' - 7 13/16" [13.00]		9' - 1 1/8"			
4					
	(75.45)         T/O SECOND FLOOR SUBFLOOR				
		1/8"			
		9-11-	0 6		
	72.30 T/O MAIN FLOOR SLAB				
	71.09 T/O SLAB AT ENTRY	5 - 4 3/4"			
	70.66         AVERAGE GRADE           70.45         AVERAGE EXISTING GRADE				
	69.41 T/O BASEMENT SLAB				
	$\frown$	ດ ເ			
	68.27         U/S RAFT SLAB		 ·	<u>+</u> –	·



#### GENERAL NOTES:

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#### MATERIALS LEGEND

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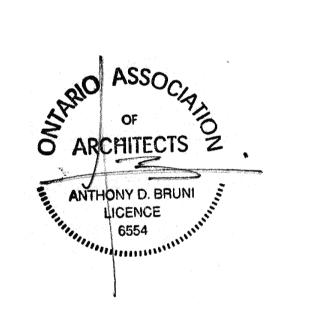
C - CANOPY

PICAL WINDOW LEGEND			
•			
	(AL)		
•	GL		
	GL		

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### PROJECT NAME

### 283 & 285 McLEOD STREET

OTTAWA, ON

SCALE

DATE 05/10/24

01917

PROJECT NO.

AS NOTED DRAWN BY

### DRAWING TITLE EAST ELEVATION

DRAWING NO.

A203