

#### **SITE PLAN GENERAL NOTES:**

- 1. ALL GENERAL SITE INFORMATION AND CONDITIONS COMPILED FROM EXISTING PLANS AND SURVEYS
- 2. DO NOT SCALE THIS DRAWING 3. REPORT ANY DISCREPANCIES PRIOR TO COMMENCING WORK. NO RESPONSIBILITY IS BORN BY THE CONSULTANT FOR UNKNOWN SUBSURFACE CONDITIONS
- 4. CONTRACTOR TO CHECK AND VERIFY ALL DIMENSIONS ON SITE AND REPORT ANY ERRORS AND/OR OMISSIONS TO THE CONSULTANT
- 5. REINSTATE ALL AREAS AND ITEMS DAMAGED AS A RESULT OF CONSTRUCTION ACTIVITIES TO THE SATISFACTION OF THE
- 6. CONTRACTOR TO LAYOUT PLANTING BEDS, PATHWAYS ETC. TO APPROVAL OF CONSULTANT PRIOR TO ANY JOB EXCAVATION
- 7. THE ACCURACY OF THE POSITION OF UTILITIES IS NOT GUARANTEED - CONTRACTOR TO VERIFY PRIOR TO EXCAVATION 8. INDIVIDUAL UTILITY COMPANY MUST BE CONTACTED FOR CONFIRMATION OF UTILITY EXISTENCE AND LOCATION PRIOR TO
- 9. ALL DISTURBED AREAS TO BE RESTORED TO ORIGINAL CONDITION OR BETTER UNLESS OTHERWISE NOTED

#### **SITE PLAN KEYNOTES:**

- 1 OTTAWA HYDRO SETBACK / CLEARANCES
- 2 PROPOSED RETAINING WALL
- 3 EXISTING HYDRO TRANSFORMER ON CONCRETE PAD
- 4 PLAYGROUND AREA
- 5 SNOW STORAGE
- 6 NEW LANDSCAPE STAIR
- 7 NOT IN USE
- 8 BOLLARDS ALONG PROPOSED WOONERF, TYP.
- 9 EASEMENT
- 10 PARKING GARAGE SIGNAL
- 11 DEPRESSED CURB
- 12 EXISTING (NONCOMPLIANT) BIKE RACKS TO REMAIN. EXISTING RACKS NOT INCLUDED IN NEW BIKE PARKING
- 13 NOT IN USE
- 14 AREA DRAIN. REFER TO CIVIL DOCUMENTS

#### **SITE PLAN LEGEND:**

- EXISTING BUILDING (NOT IN SCOPE) FIRE ACCESS ROUTE
- EXTENT OF EASEMENT
- **ASPHALT PAVING NEW**
- **ASPHALT PAVING EXISTING**
- CONCRETE SIDEWALK NEW CONCRETE SIDEWALK - EXISTING
- GRASS NEW
- **GRASS EXISTING** PAVER TYPE 1 - NEW
- CONCRETE PAD
- **EMERGENCY EXIT**
- SERVICE DOORS
- GROUND LEVEL SUITE ENTRANCE
- BUILDING MAIN ENTRANCE (PRINCIPAL
- FIRE FIGHTING ENTRANCE) PROPERTY LINE / EASEMENT
- -WTR-WTR- NEW DOMESTIC WATER
- -san-san- NEW SANITARY
- —st——st— NEW STORM
- —H——H— NEW ELECTRICAL SERVICE (BELOW GRADE)
- —н—— н— GAS
- CATCH BASIN
- CATCH BASIN EXISTING
- •◯<sub>LS</sub> LIGHT STANDARD
- LIGHT STANDARD EXISTING
- FIRE HYDRANT
- FIRE HYDRANT EXISTING
- $\bigotimes_{\mathsf{MH}}$  MANHOLE
- MANHOLE EXISTING
- UP UTILITY POLE UTILITY POLE EXISTING

DROPPED CURB

SIAMESE CONNECTION

DRAWING NO. ₹

WITH ALL OTHER PROJECT DRAWINGS AND 4. DO NOT SCALE DRAWINGS. CONTRACTOR SHALL

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SPECIFICATIONS.

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NOTES

3 2024-10-08 Issued for SPC

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1 2024-07-19 Issued for 66% REV DATE ISSUE

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**CO-OPERATIVE** OTTAWA ONTARIO, CANADA

PROJECT

BLOCK 3 **REDEVELOPMENT** 


1360 OGILVIE ROAD GLOUCESTER, ON K1J 9M6

**OVERALL SITE PLAN** 

PROJECT NO: 2022-2040 DRAWN: KM APPROVED: PM SCALE: As indicated

DATE PRINTED: 2024-10-09 5:01:27 PM REV

A100

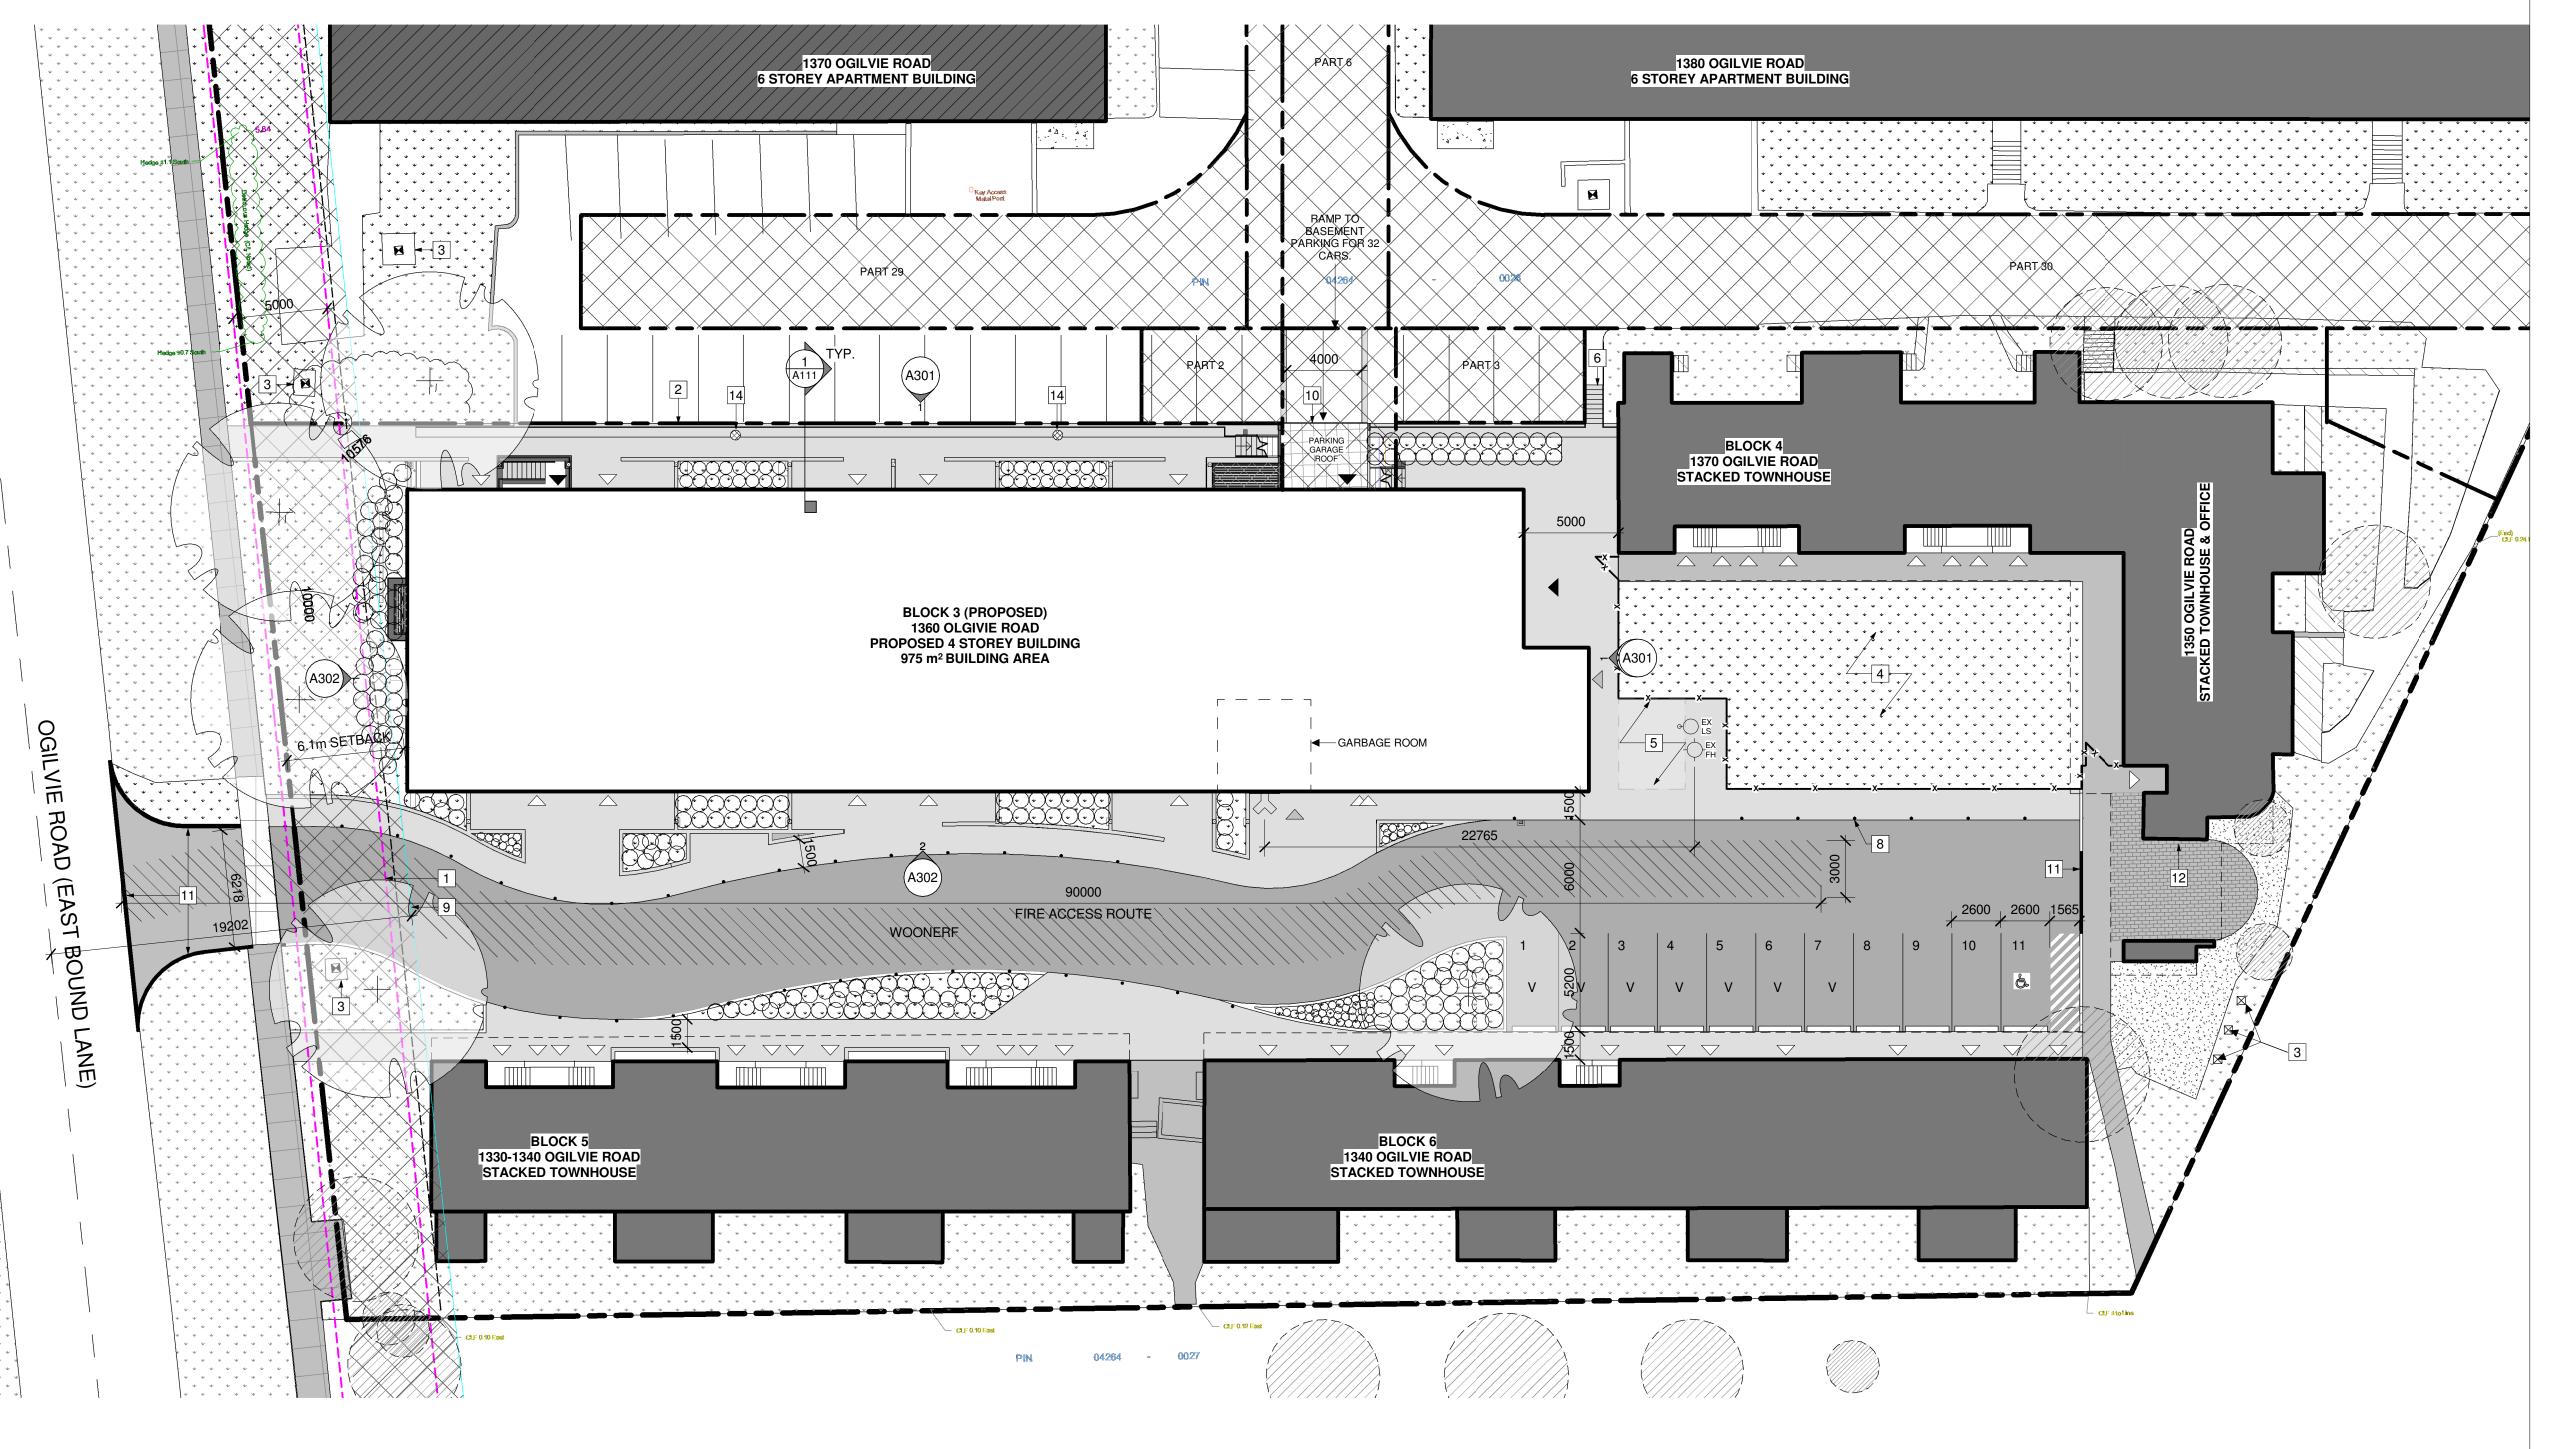

1 PROPOSED SITE PLAN

	DEVELOPMENT INFO		ZONING INFO									
	LEGAL DESCRIPTION		ZONING PROVISION	REQUIRED	PROVIDED	ZONING PROVISION	REQUIRED	PROVIDED	PARKING QUEING + LOADING	REQUIRED	<u>PROVIDED</u>	1-B
	BLOCKS C, D, AND L REGISTERED PLAN		MIN. LOT WIDTH	No minimum	47.68m	GROUND FACADE	The ground floor facade facing a public	Building is located within 6.1m of the front lot line.	RESIDENTIAL SPACES	94	43	2-B
4M-172 CITY OF OTTAWA		MIN. LOT AREA	No minimum	5367m²	ACTIVATION	street of a building located within 4.5 m of	No active entrances face	VISITOR SPACES	16	7	3-B 4-B	
	BASED ON INFORMATION FROM A SURVEY		MIN. FRONT YARD SETBACK	Minimum: 0m	6.1m		the front lot line must include: a minimum of	Oglivie Ha.	ACCESSIBLE PARKING	-	3	5-B 1-B
	PREPARED BY ANNIS, ( VOLLEBEKK LTD. DATE	O'SULLIVAN,	MIN. INTERIOR SIDE YARD SETBACK	No minimum	N/A		one active entrance from each individual		BICYCLE PARKING	39	39	2-B
	MUNICIPAL ADDRESS	.D JOL1 5, 2025	MIN. REAR YARD SETBACK	7.5m	N/A		occupancy located immediately adjacent		DRIVEWAY WIDTH	3m @ single traffic lane	4m for single traffic lane,	
	1360 OGILVIE RD, OTTA	AWA, ON K1J 9M6	MAX. HEIGHT	40m	14.15m		to the front lot line			6m @ double	driveway to parking garage	
	0.77		AMENITY AREA	468m2	552m²	MINIMUM GLAZING OF GROUND FLOOR FACADE	50% of the surface area of the ground	7.7 m2/ 72m2 = 10.7% glazing		traffic lane	6m for double	APA
	SITE AREA	12,912m <sup>2</sup>	LANDSCAPED AREA	no minimum	349.5m <sup>2</sup>		floor façade facing Ogilvie, from the				traffic lane, parking lot	ST <i>A</i>
	BUILDING AREA	975m <sup>2</sup>		AMENITY BREAKDO	JWM		average grade up 4.5 metres, must be					
	GROSS FLOOR AREA BUILDING HEIGHT	3,900m <sup>2</sup> 14.15m , 4 STOREYS		Ground Floor Amenit Balconies:			comprised of transparent glazing and active customer or					
	ZONE	AM10 H(40)		Playground:	242m2		resident entrance access doors					
	ZONE	AW1011(40)					400033 40013					DW

DWELLING UNIT TYPE	BLOCK				TOTAL		
DWELLING UNIT TYPE	3(NEW)	4	5	6	TOTAL		
1-BEDROOM	26			1	27		
2-BEDROOM	4	7	6	6	23		
3-BEDROOM	9	7	6	4	26		
4-BEDROOM				1	1	NOTES:	
5-BEDROOM				1	1		
1-B(SENIOR)					0	1. PARKING FIGURE SITE ONLY	ES IN TABLE REFLECT BLC
2-B(SENIOR)					0	2. TOTAL SITE PAR	KING (INCLUDING BLC SITE
TOTAL	39	14	12	13	78	170 SPACES	
		RI C		ARKING LEG	END	TOTAL REQUIRED	TOTAL PARKING
	Π	BI C	OCK	AINNING LLC	TOTAL	TOTAL REQUIRED	TOTAL PARKING
DWELLING UNIT TYPE	3(NEW)	4	5	6		PARKING	PROVIDED
APARTMENT (1.2)	39				39	47	
STACKED (1.2)	0	14	12	13	39	47	3
VISITOR PARKING (0.2)						16	
						109	total: 4
			А	MENITY LEG	GEND		
	BLOCK			TOTAL	TOTAL REQUIRED	TOTAL AMENITY SPACE	
	3(NEW)	4	5	6	TOTAL	AMENITY SPACE (m2)	PROVIDED (m2)

ACCOMODATIONS LEGEND

39 14 12

DWELLING UNITS

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CONCRETE SIDEWALK - NEW CONCRETE SIDEWALK - EXISTING

**GRASS - NEW** 

**GRASS - EXISTING** PAVER TYPE 1 - NEW

CONCRETE PAD

**EMERGENCY EXIT** 

SERVICE DOORS

GROUND LEVEL SUITE ENTRANCE BUILDING MAIN ENTRANCE (PRINCIPAL

FIRE FIGHTING ENTRANCE) PROPERTY LINE / EASEMENT

-x-x- FENCE PER LANDSCAPE

-wtr-wtr- NEW DOMESTIC WATER

-san-san- NEW SANITARY

—st——st— NEW STORM

—H——H— NEW ELECTRICAL SERVICE (BELOW GRADE)

—н——н— GAS

CB CATCH BASIN

CATCH BASIN EXISTING

∘ LIGHT STANDARD

LIGHT STANDARD EXISTING

- FIRE HYDRANT

FIRE HYDRANT EXISTING

 $\bigotimes_{\mathsf{MH}}$  MANHOLE

UP UTILITY POLE

UTILITY POLE EXISTING SIAMESE CONNECTION

MANHOLE EXISTING

— DROPPED CURB

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**CIVIL ENGINEERS** 

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613-836-2184

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NOTES

SPECIFICATIONS.

CLIENT

OTTAWA

PROJECT

BLOCK 3

4 2024-10-08 Issued for SPC

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**BETTER LIVING** 

**CO-OPERATIVE** 

**REDEVELOPMENT** 

GLOUCESTER, ON K1J 9M6

PROPOSED SITE PLAN

ONTARIO, CANADA

1360 OGILVIE ROAD

PROJECT NO: 2022-2040

KM

PM

1:200 DATE PRINTED: 2024-10-09 5:01:30 PM

DRAWN:

SCALE:

REV

APPROVED:

1 2024-07-19 Issued for 66%

REV DATE ISSUE

name address

email


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DRAWING NO. 7 A110



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CIVIL ENGINEER address address phone

email

CIVIL ENGINEERS McIntosh Perry 115 Walgreen Road Carp, Ontario 613-836-2184 info@mcintoshperry.com
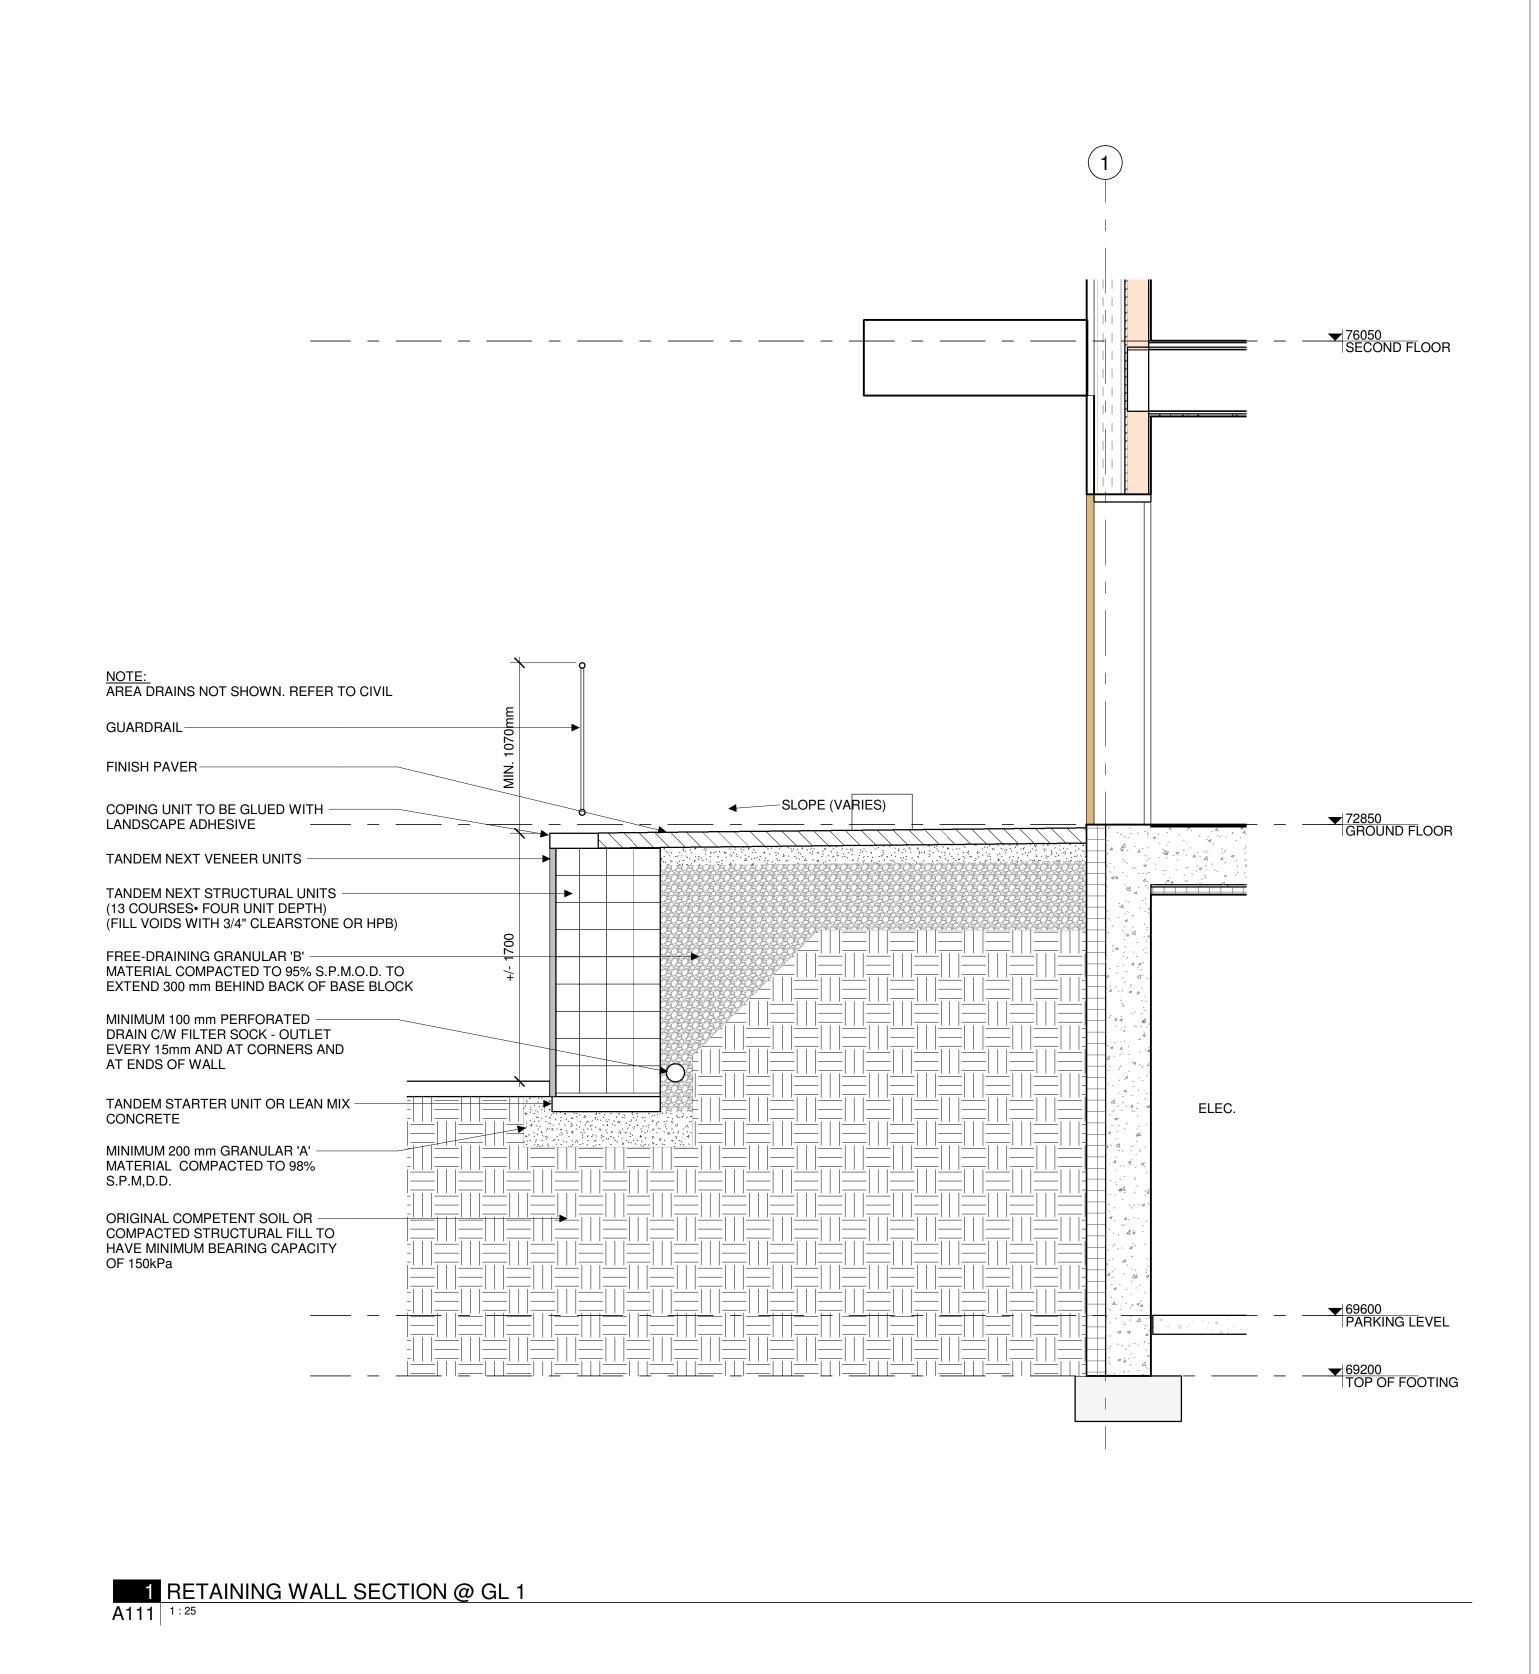
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CLIENT

#### **BETTER LIVING CO-OPERATIVE** OTTAWA

ONTARIO, CANADA

PROJECT

### BLOCK 3 **REDEVELOPMENT**

1360 OGILVIE ROAD GLOUCESTER, ON K1J 9M6 TITLE


SITE DETAILS

PROJECT NO: 2022-2040 DRAWN: DF APPROVED: DH

1:25 DATE PRINTED: 2024-10-09 5:01:32 PM

REV

DRAWING NO. 7 A111 8

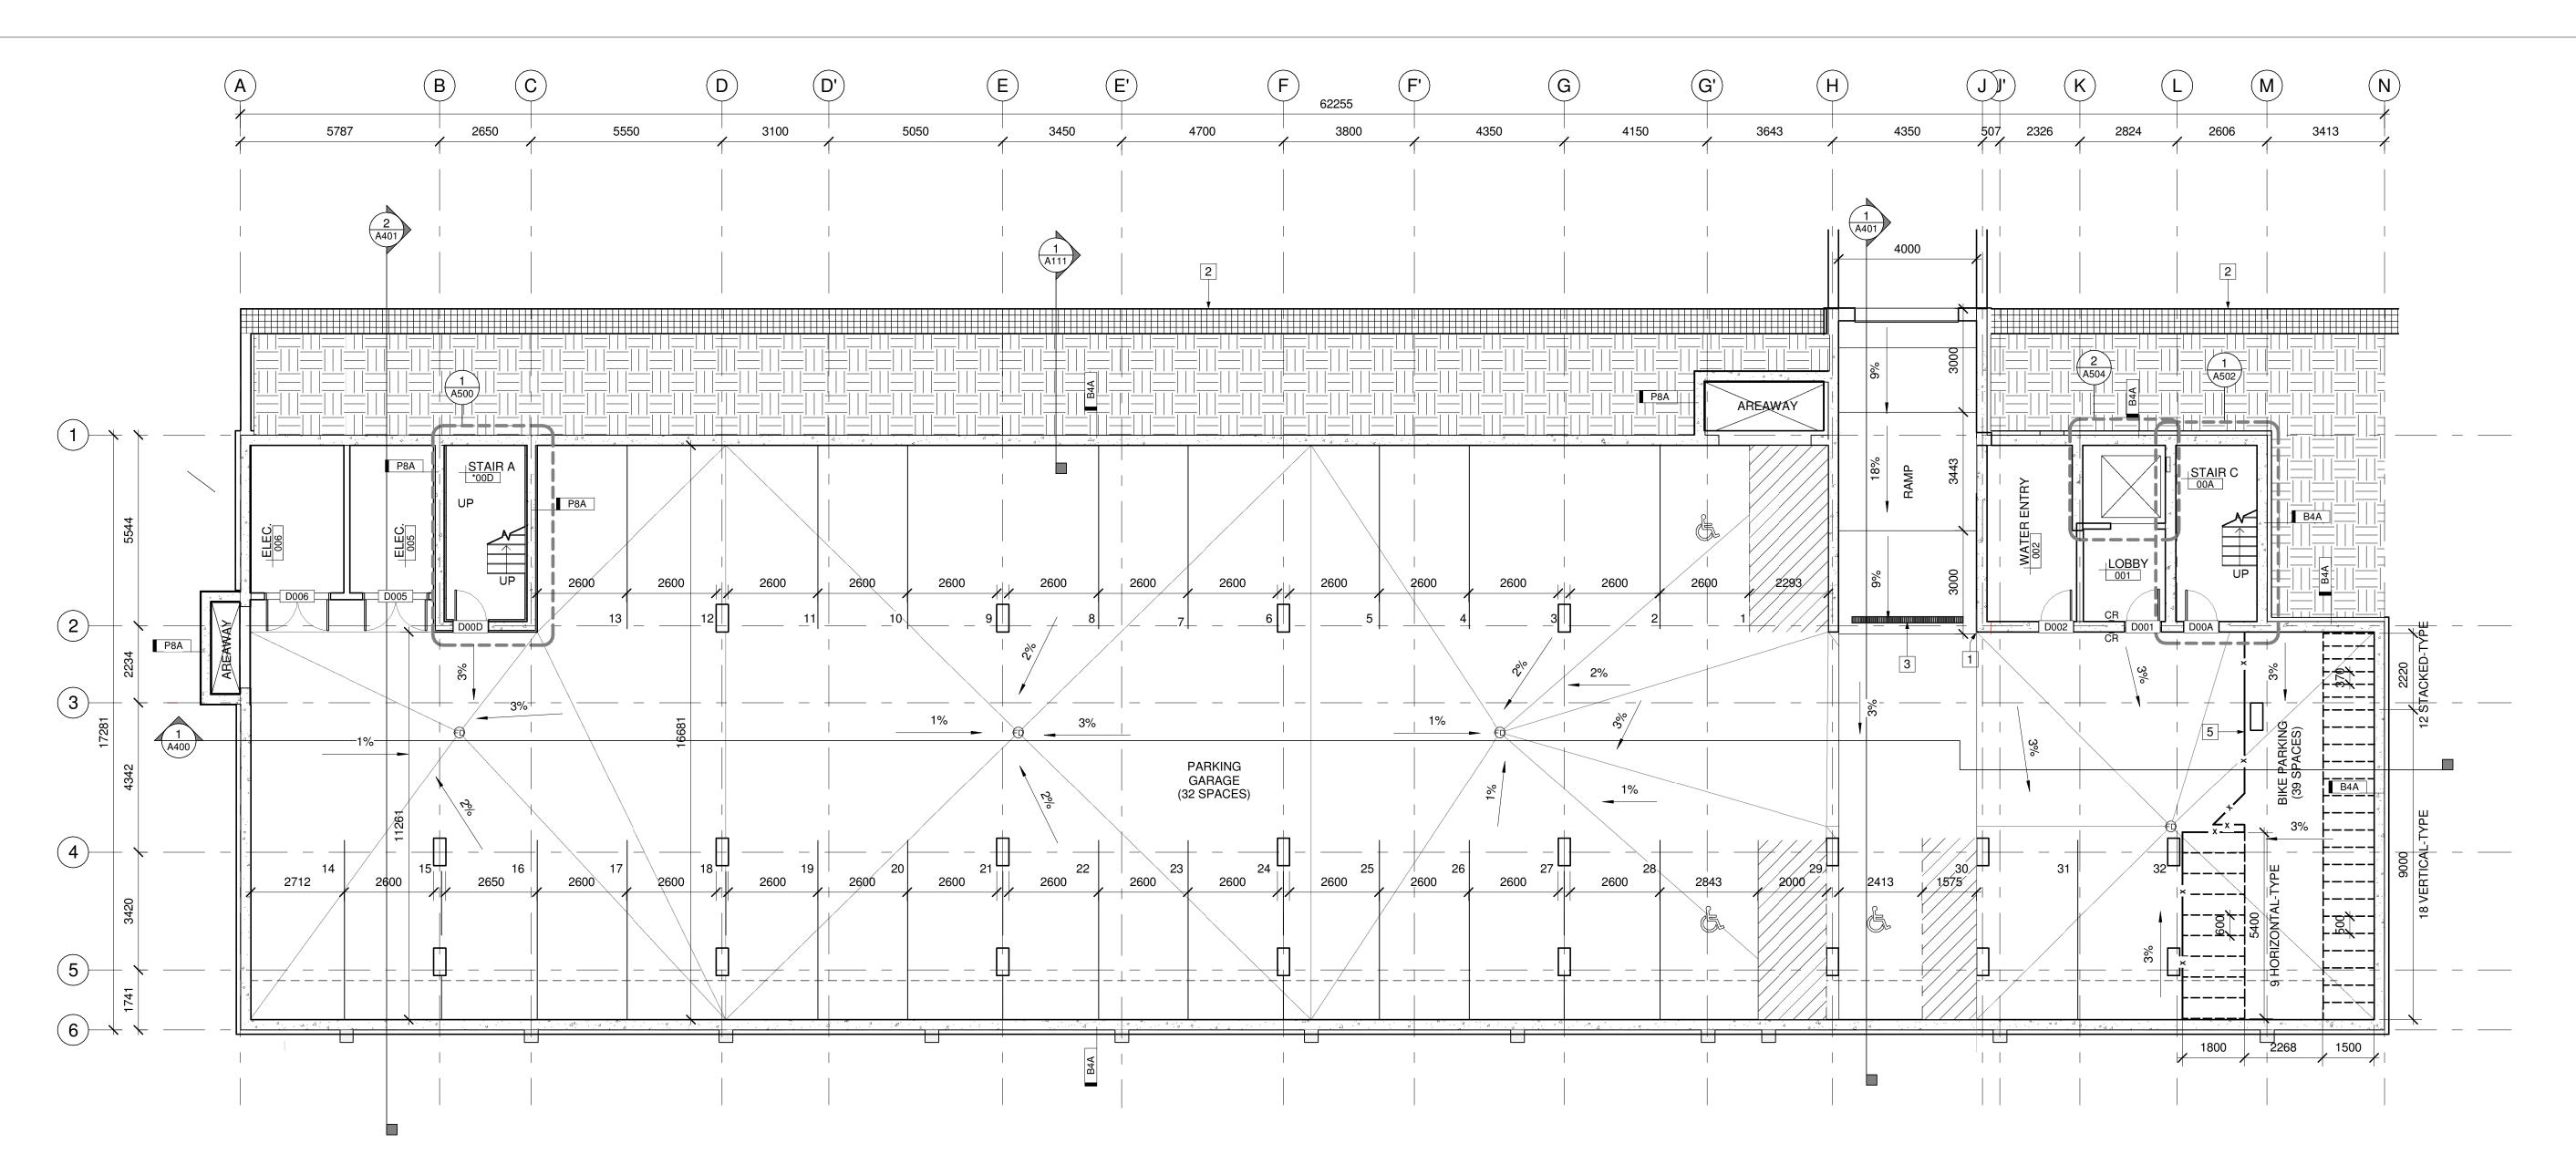

1 UNDERGROUND PARKING LEVEL

#### **GENERAL REFERENCE PLAN NOTES:**

- 1. ALL DIMENSIONS ARE TO FACE OF FRAMING UNLESS OTHERWISE NOTED.
- 2. ALL DOOR DIMENSIONS ARE TO THE CENTRE OR INSIDE OF FRAME.
- 1 PARKING GARAGE SIGNAL

#### **LEGEND**:

3. ALL WINDOW DIMENSIONS ARE TO THE CENTER OR OUTSIDE OF FRAME.

#### **UNDERGROUND PARKING PLAN KEYNOTES:**

- TRENCH DRAIN, REFER TO MECHANICAL DOCUMENTS
- SECURE FENCE TO FLOOR SLAB AND TO U/S SLAB ABOVE

- 5 SECURE BIKE STORAGE. CHAINLINK FENCE W/ ACCESS DOOR.

- 2 RETAINING WALL
- 4 NOT IN USE

NOT IN CONTRACT

NEW CONSTRUCTION 45 MIN. FIRE RESISTANCE RATING

60 MIN. FIRE RESISTANCE RATING 90 MIN. FIRE RESISTANCE RATING

SHEAR WALL PER STRUCTURAL LOAD-BEARING WALL PER STRUCTURAL

DOOR

CARD READER

# Ottawa, Ontario,K2P 2R3 STRUCTURAL ENGINEER Cunliffe & Associates 200, 1550 Carling Avenue Ottawa, Ontario K1Z 8S8

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CLIENT

# **BETTER LIVING CO-OPERATIVE**

OTTAWA ONTARIO, CANADA

PROJECT

### BLOCK 3 REDEVELOPMENT


1360 OGILVIE ROAD GLOUCESTER, ON K1J 9M6

# **UNDERGROUND PARKING PLAN**

PROJECT NO: 2022-2040 DRAWN: DF

APPROVED: PM 1:100 DATE PRINTED: 2024-10-09 5:01:35 PM

REV DRAWING NO. 🕹

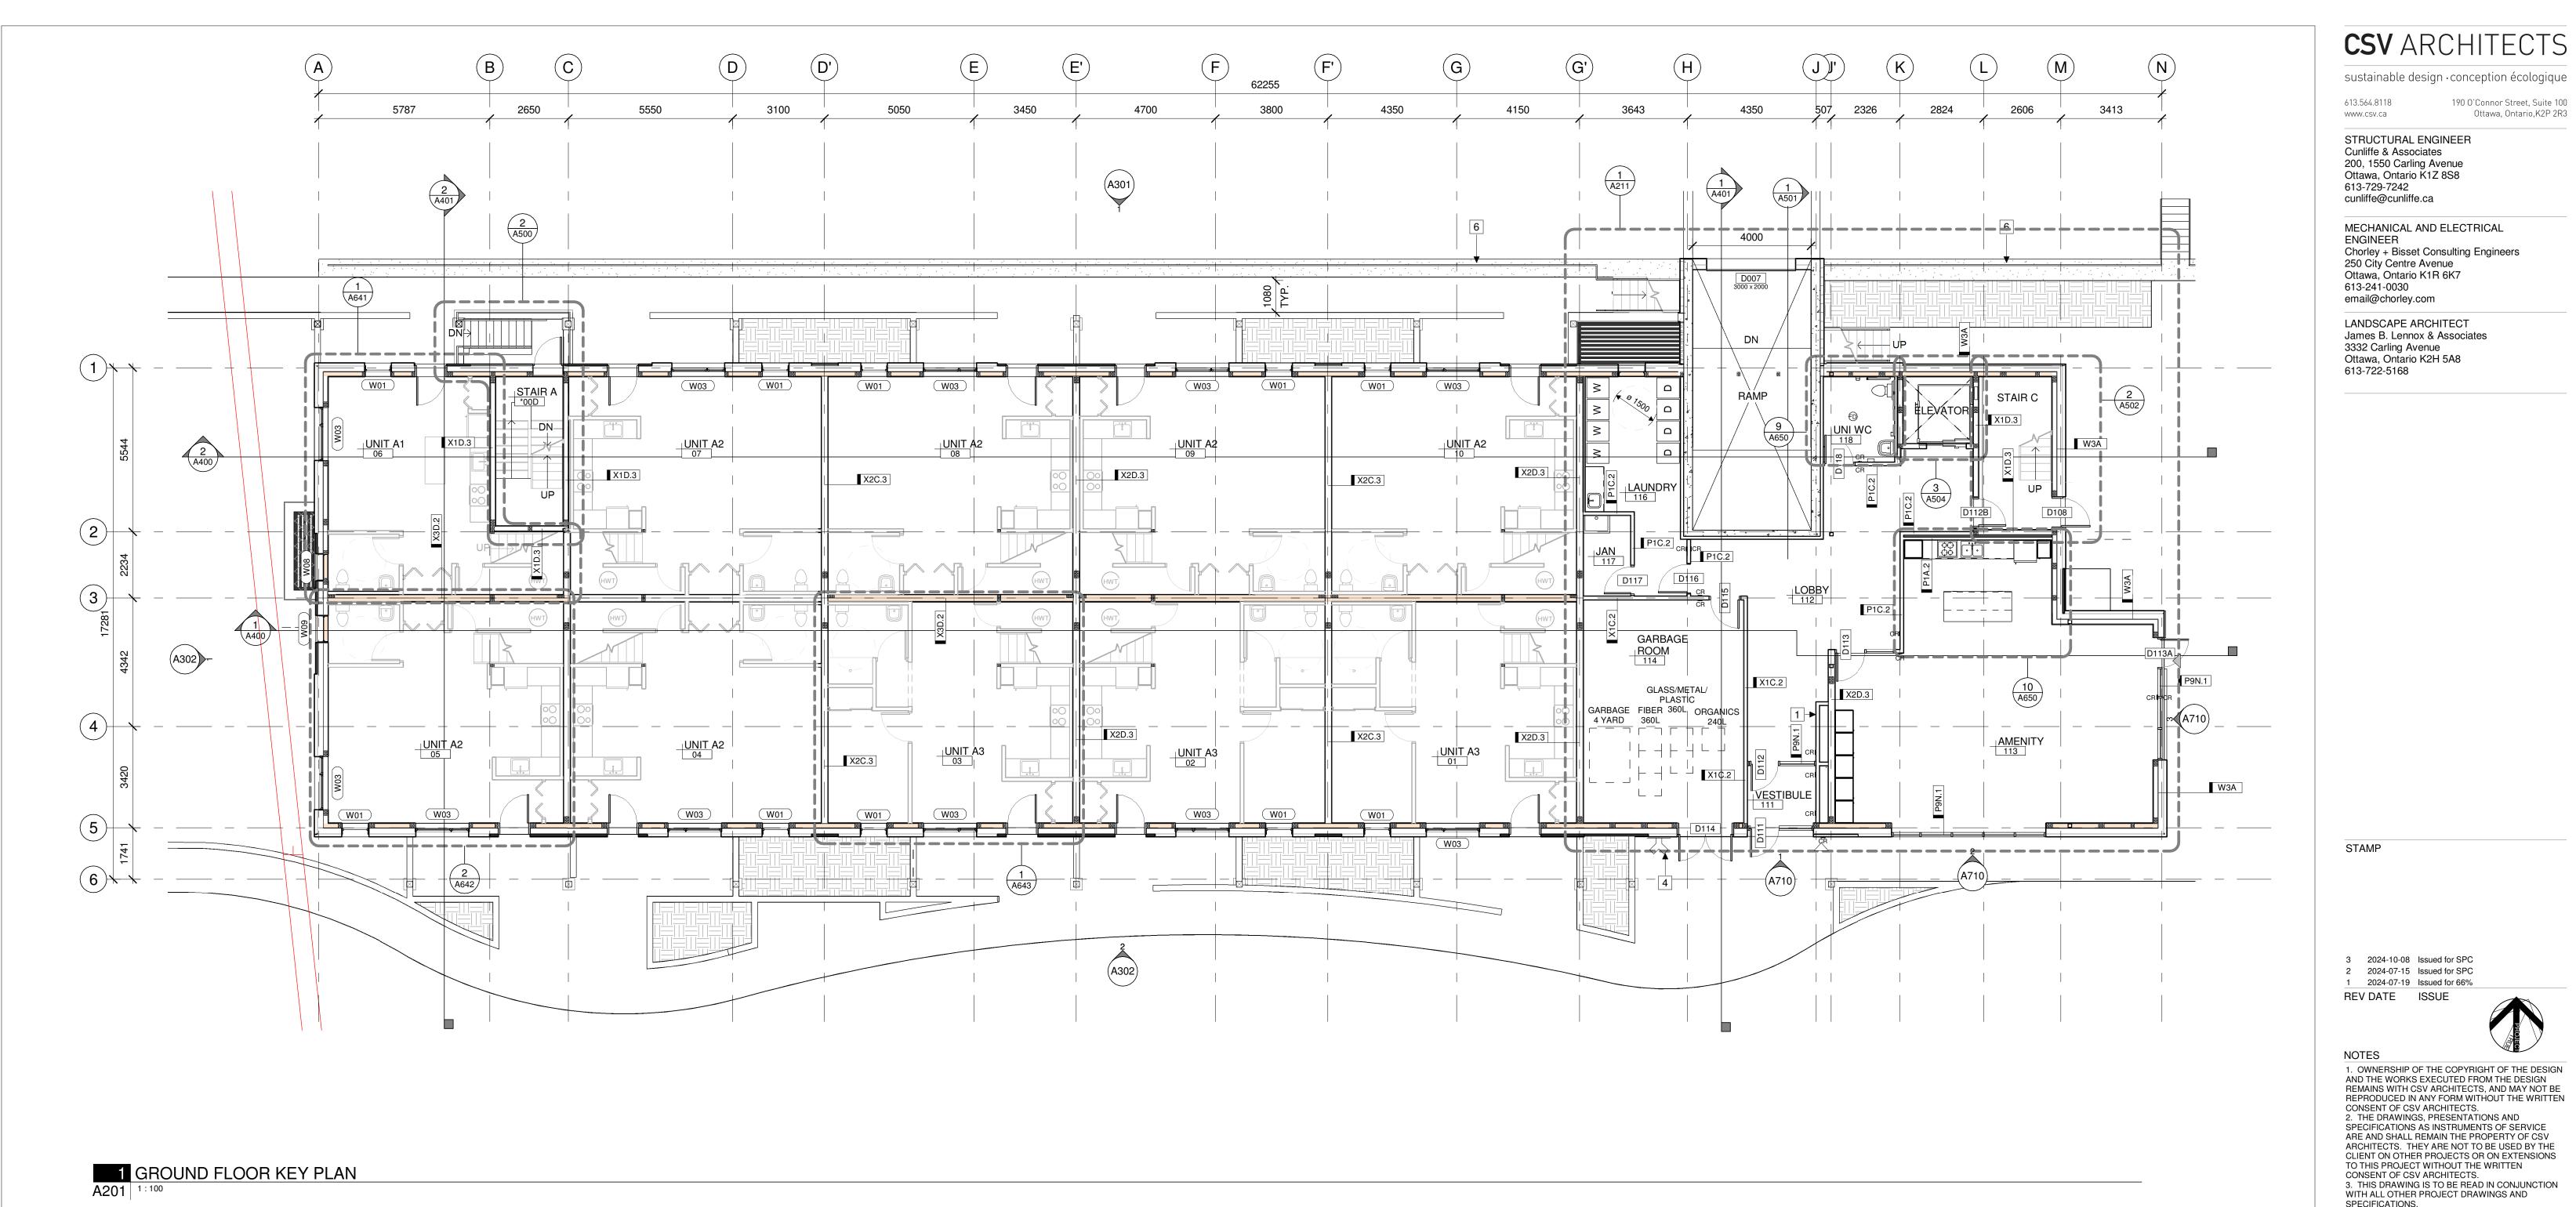

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- 3. ALL WINDOW DIMENSIONS ARE TO THE CENTER OR OUTSIDE OF FRAME.

#### **REFERENCE PLAN KEYNOTES:**

- 1 MAILBOXES
- 2 NOT IN USE
- 3 CANOPY ABOVE
- 4 FIRE DEPARTMENT CONNECTION
- 5 FIRE ALARM CONTROL PANEL
- 6 RETAINING WALL C/W GUARDRAIL

#### LEGEND:

NOT IN CONTRACT

NEW CONSTRUCTION 45 MIN. FIRE RESISTANCE RATING 60 MIN. FIRE RESISTANCE RATING 90 MIN. FIRE RESISTANCE RATING

SHEAR WALL PER STRUCTURAL LOAD-BEARING WALL PER STRUCTURAL

DOOR OPERATOR

DRAWING NO. 🕹

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Ottawa, Ontario,K2P 2R3

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OTTAWA ONTARIO, CANADA

PROJECT

# **BLOCK 3 REDEVELOPMENT**

1360 OGILVIE ROAD GLOUCESTER, ON K1J 9M6

#### **GROUND FLOOR PLAN**

DRAWN: KM, DF APPROVED: PM 1:100 DATE PRINTED: 2024-10-09 5:01:37 PM REV

PROJECT NO: 2022-2040

A201





# **ELEVATION NOTES:**

CONTRACTOR TO COORDINATE WITH MANUFACTURER'S SPECIFICATIONS AND INSTALLATIONS GUIDELINES FOR ALL MATERIAL SEALING, TRANSITIONS, SEPARATIONS, FLASHING DETAILS, CONNECTIONS, ANCHORAGES, ETC. CONTRACTOR TO PROVIDE DETAIL DRAWINGS OR MOCK-UP FOR ARCHITECT'S REVIEW AND APPROVAL FOR ALL SPECIAL CONDITIONS NOT SHOWN IN THE CONTRACT DOCUMENTS.

- **ELEVATION KEYNOTES:** 1 CURTAIN WALL
- 2 CANOPY
- 3 JULIETTE BALCONY
- 4 PREFINISHED METAL FLASHING 5 ROOFTOP ACCESS
- 6 ELEVATOR OVERRUN & ROOFTOP ACCESS
- 7 GARAGE DOOR
- 8 NEW LANDSCAPE STAIR C/W HANDRAIL AND GUARDRAIL
- 9 EMERGENCY EXIT STAIR

# **ELEVATION LEGEND:**

HATCH SYMBOL DESCRIPTION

HATCH PATTERNS SHOWN ARE FOR GRAPHIC PURPOSES ONLY AND SHOULD BE COORDINATED WITH ACTUAL SPECIFIED MATERIALS.

BRICK VENEER MANUFACTURER: COLOUR:
ALUMINUM COMPOSITE PANEL MANUFACTURER: COLOUR:
ALUMINUM COMPOSITE PANEL MANUFACTURER: COLOUR:
WOOD SIDING MANUFACTURER: COLOUR:
FASCIA MANUFACTURER: COLOUR:

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# **BETTER LIVING CO-OPERATIVE**

OTTAWA ONTARIO, CANADA

PROJECT

# BLOCK 3 **REDEVELOPMENT**

1360 OGILVIE ROAD GLOUCESTER, ON K1J 9M6

# **ELEVATIONS**

PROJECT NO: 2022-2040 DRAWN: Author APPROVED: Approver As indicated

REV

DATE PRINTED: 2024-10-09 5:01:40 PM DRAWING NO. 7

A301



#### **ELEVATION NOTES:**


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- 1 CURTAIN WALL
- 2 CANOPY
- 3 JULIETTE BALCONY
- 4 PREFINISHED METAL FLASHING
- 5 ROOFTOP ACCESS
- 6 ELEVATOR OVERRUN & ROOFTOP ACCESS
- 7 GARAGE DOOR
- 8 NEW LANDSCAPE STAIR C/W HANDRAIL AND GUARDRAIL
- 9 EMERGENCY EXIT STAIR

#### **ELEVATION LEGEND:**

HATCH PATTERNS SHOWN ARE FOR GRAPHIC PURPOSES ONLY AND SHOULD BE COORDINATED WITH ACTUAL SPECIFIED MATERIALS.



# **CSV** ARCHITECTS

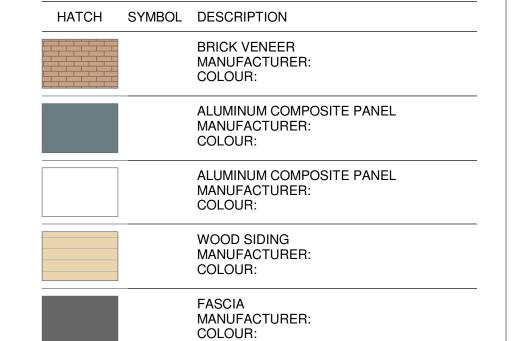sustainable design · conception écologique

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CLIENT

# **BETTER LIVING CO-OPERATIVE**

OTTAWA ONTARIO, CANADA

PROJECT

TITLE

# **BLOCK 3 REDEVELOPMENT**

1360 OGILVIE ROAD GLOUCESTER, ON K1J 9M6

# **ELEVATIONS**

PROJECT NO: 2022-2040 DRAWN: Author APPROVED: Approver As indicated

REV

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