

ZONING INFO

MIN. LOT WIDTH

MIN. LOT AREA

SETBACK

MAX. HEIGHT

AMENITY AREA

MIN. FRONTAGE

FRONTAGE

LANDSCAPED AREA

MIN. FRONT YARD SETBACK

MIN. INTERIOR SIDE YARD

MIN. REAR YARD SETBACK

43.5m OF BUILDING WALLS / 109.7m OF

ENTIRE FRONTAGE = 39% OF

ZONING PROVISION

PROVIDED

47.68m

5323.54m²

6.1m

N/A

N/A

13.25m

552m²

349.5m²

4.3m

227m2

242m2

Ground Floor Amenity: 83m2

<u>REQUIRED</u>

No minimum

No minimum

Minimum: 0m

No minimum

7.5m

no minimum

4.5m

Balconies:

Playground:

ZONING PROVISION

MINIMUM GLAZING OF

GROUND FLOOR

FACADE

GROUND FACADE

ACTIVATION

REQUIRED

include: a minimum of

one active entrance

from each individual

occupancy located

to the front lot line

area of the ground

floor façade facing

average grade up 4.5

Ogilvie, from the

metres, must be

transparent glazing

resident entrance

access doors

and active customer or

comprised of

immediately adjacent

<u>PROVIDED</u>

10.7% glazing

The ground floor Building is located facade facing a public within 6.1m of the

street of a building front lot line. No

located within 4.5 m of active entrances

the front lot line must face Ogilvie Rd.

50% of the surface 7.7 m2/72m2 =

PARKING QUEING + LOADING

RESIDENTIAL SPACES

ACCESSIBLE PARKING

VISITOR SPACES

BICYCLE PARKING

DRIVEWAY WIDTH

REQUIRED

39

3m @ single

6m @ double

traffic lane

PROVIDED

43

4m for single

traffic lane,

driveway to

parking garage

6m for double

traffic lane,

parking lot

DEVELOPMENT INFO

4M-172 CITY OF OTTAWA

BLOCKS C, D, AND L REGISTERED PLAN

REFERENCE SURVEY
BASED ON INFORMATION FROM A SURVEY

PREPARED BY ANNIS, O'SULLIVAN,

VOLLEBEKK LTD. DATED JULY 5, 2023

1360 OGILVIE RD, OTTAWA, ON K1J 9M6

5323.54m²

2558.69m²

5028.37m²

12,910.6m²

975m²

3,900m²

AM10 H(40)

14.15m, 4 STOREYS

LEGAL DESCRIPTION

MUNICIPAL ADDRESS

<u>SITE AREAS</u> BETTER LIVING CO-OP

COMMUNITY WORKS

GROSS FLOOR AREA

BIRCHWOOD


BUILDING AREA

BUILDING HEIGHT

TOTAL

ZONE



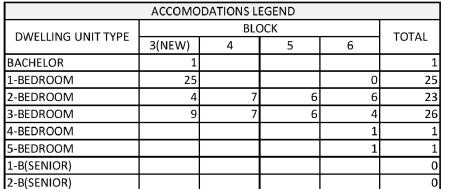

. PARKING FIGURES IN TABLE REFLECT BLC SITE ONLY 2. TOTAL SITE PARKING(INCLUDING BLC SITE):

			P.A	ARKING LEG	END		
DWELLING LINE TYPE		BLO	CK		TOTAL	TOTAL REQUIRED	TOTAL PARKING
DWELLING UNIT TYPE	3(NEW)	4	5	6	TOTAL	PARKING	PROVIDED
APARTMENT (1.2)	39				39	47	
STACKED (1.2)	0	14	12	12	38	46	3
VISITOR PARKING (0.2)						15	
						108	total: 4

AMENITY LEGEND							
		BLOCK				TOTAL REQUIRED	TOTAL AMENITY SPACE
	3(NEW)	4	5	6	TOTAL	AMENITY SPACE (m2)	PROVIDED (m2)
DWELLING UNITS	39	14	12	12	77	462	552

SITE PLAN GENERAL NOTES:

- 1. ALL GENERAL SITE INFORMATION AND CONDITIONS COMPILED FROM EXISTING PLANS AND SURVEYS
- 2. DO NOT SCALE THIS DRAWING 3. REPORT ANY DISCREPANCIES PRIOR TO COMMENCING WORK. NO RESPONSIBILITY IS BORN BY THE CONSULTANT FOR UNKNOWN SUBSURFACE CONDITIONS
- 4. CONTRACTOR TO CHECK AND VERIFY ALL DIMENSIONS ON SITE AND REPORT ANY ERRORS AND/OR OMISSIONS TO THE
- 5. REINSTATE ALL AREAS AND ITEMS DAMAGED AS A RESULT OF CONSTRUCTION ACTIVITIES TO THE SATISFACTION OF THE CONSULTANT
- 6. CONTRACTOR TO LAYOUT PLANTING BEDS, PATHWAYS ETC. TO APPROVAL OF CONSULTANT PRIOR TO ANY JOB EXCAVATION 7. THE ACCURACY OF THE POSITION OF UTILITIES IS NOT
- GUARANTEED CONTRACTOR TO VERIFY PRIOR TO EXCAVATION 8. INDIVIDUAL UTILITY COMPANY MUST BE CONTACTED FOR CONFIRMATION OF UTILITY EXISTENCE AND LOCATION PRIOR TO
- 9. ALL DISTURBED AREAS TO BE RESTORED TO ORIGINAL CONDITION OR BETTER UNLESS OTHERWISE NOTED

SITE PLAN LEGEND:

CONSULTANT

EXISTING BUILDING (NOT IN SCOPE) FIRE ACCESS ROUTE EASEMENT / ROW ASPHALT PAVING - NEW ASPHALT PAVING - EXISTING CONCRETE SIDEWALK - NEW **CONCRETE SIDEWALK - EXISTING GRASS - NEW GRASS - EXISTING** PAVER TYPE 1 - NEW

PROPERTY LINE

CONCRETE PAD

EMERGENCY EXIT

SERVICE DOORS

BUILDING MAIN ENTRANCE / TOWN ENTRANCE

- - - - - EXTENT OF EASEMENT / ROW

STAMP

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- 2 2024-07-15 Issued for SPC
- 1 2024-07-19 Issued for 66%

REV DATE ISSUE

NOTES

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CLIENT

BETTER LIVING CO-OPERATIVE

OTTAWA ONTARIO, CANADA

PROJECT

1360 OGILVIE ROAD GLOUCESTER, ON K1J 9M6

OVERALL SITE PLAN


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REV

DRAWING NO. ₹

A100

BLOCK 3 **REDEVELOPMENT**



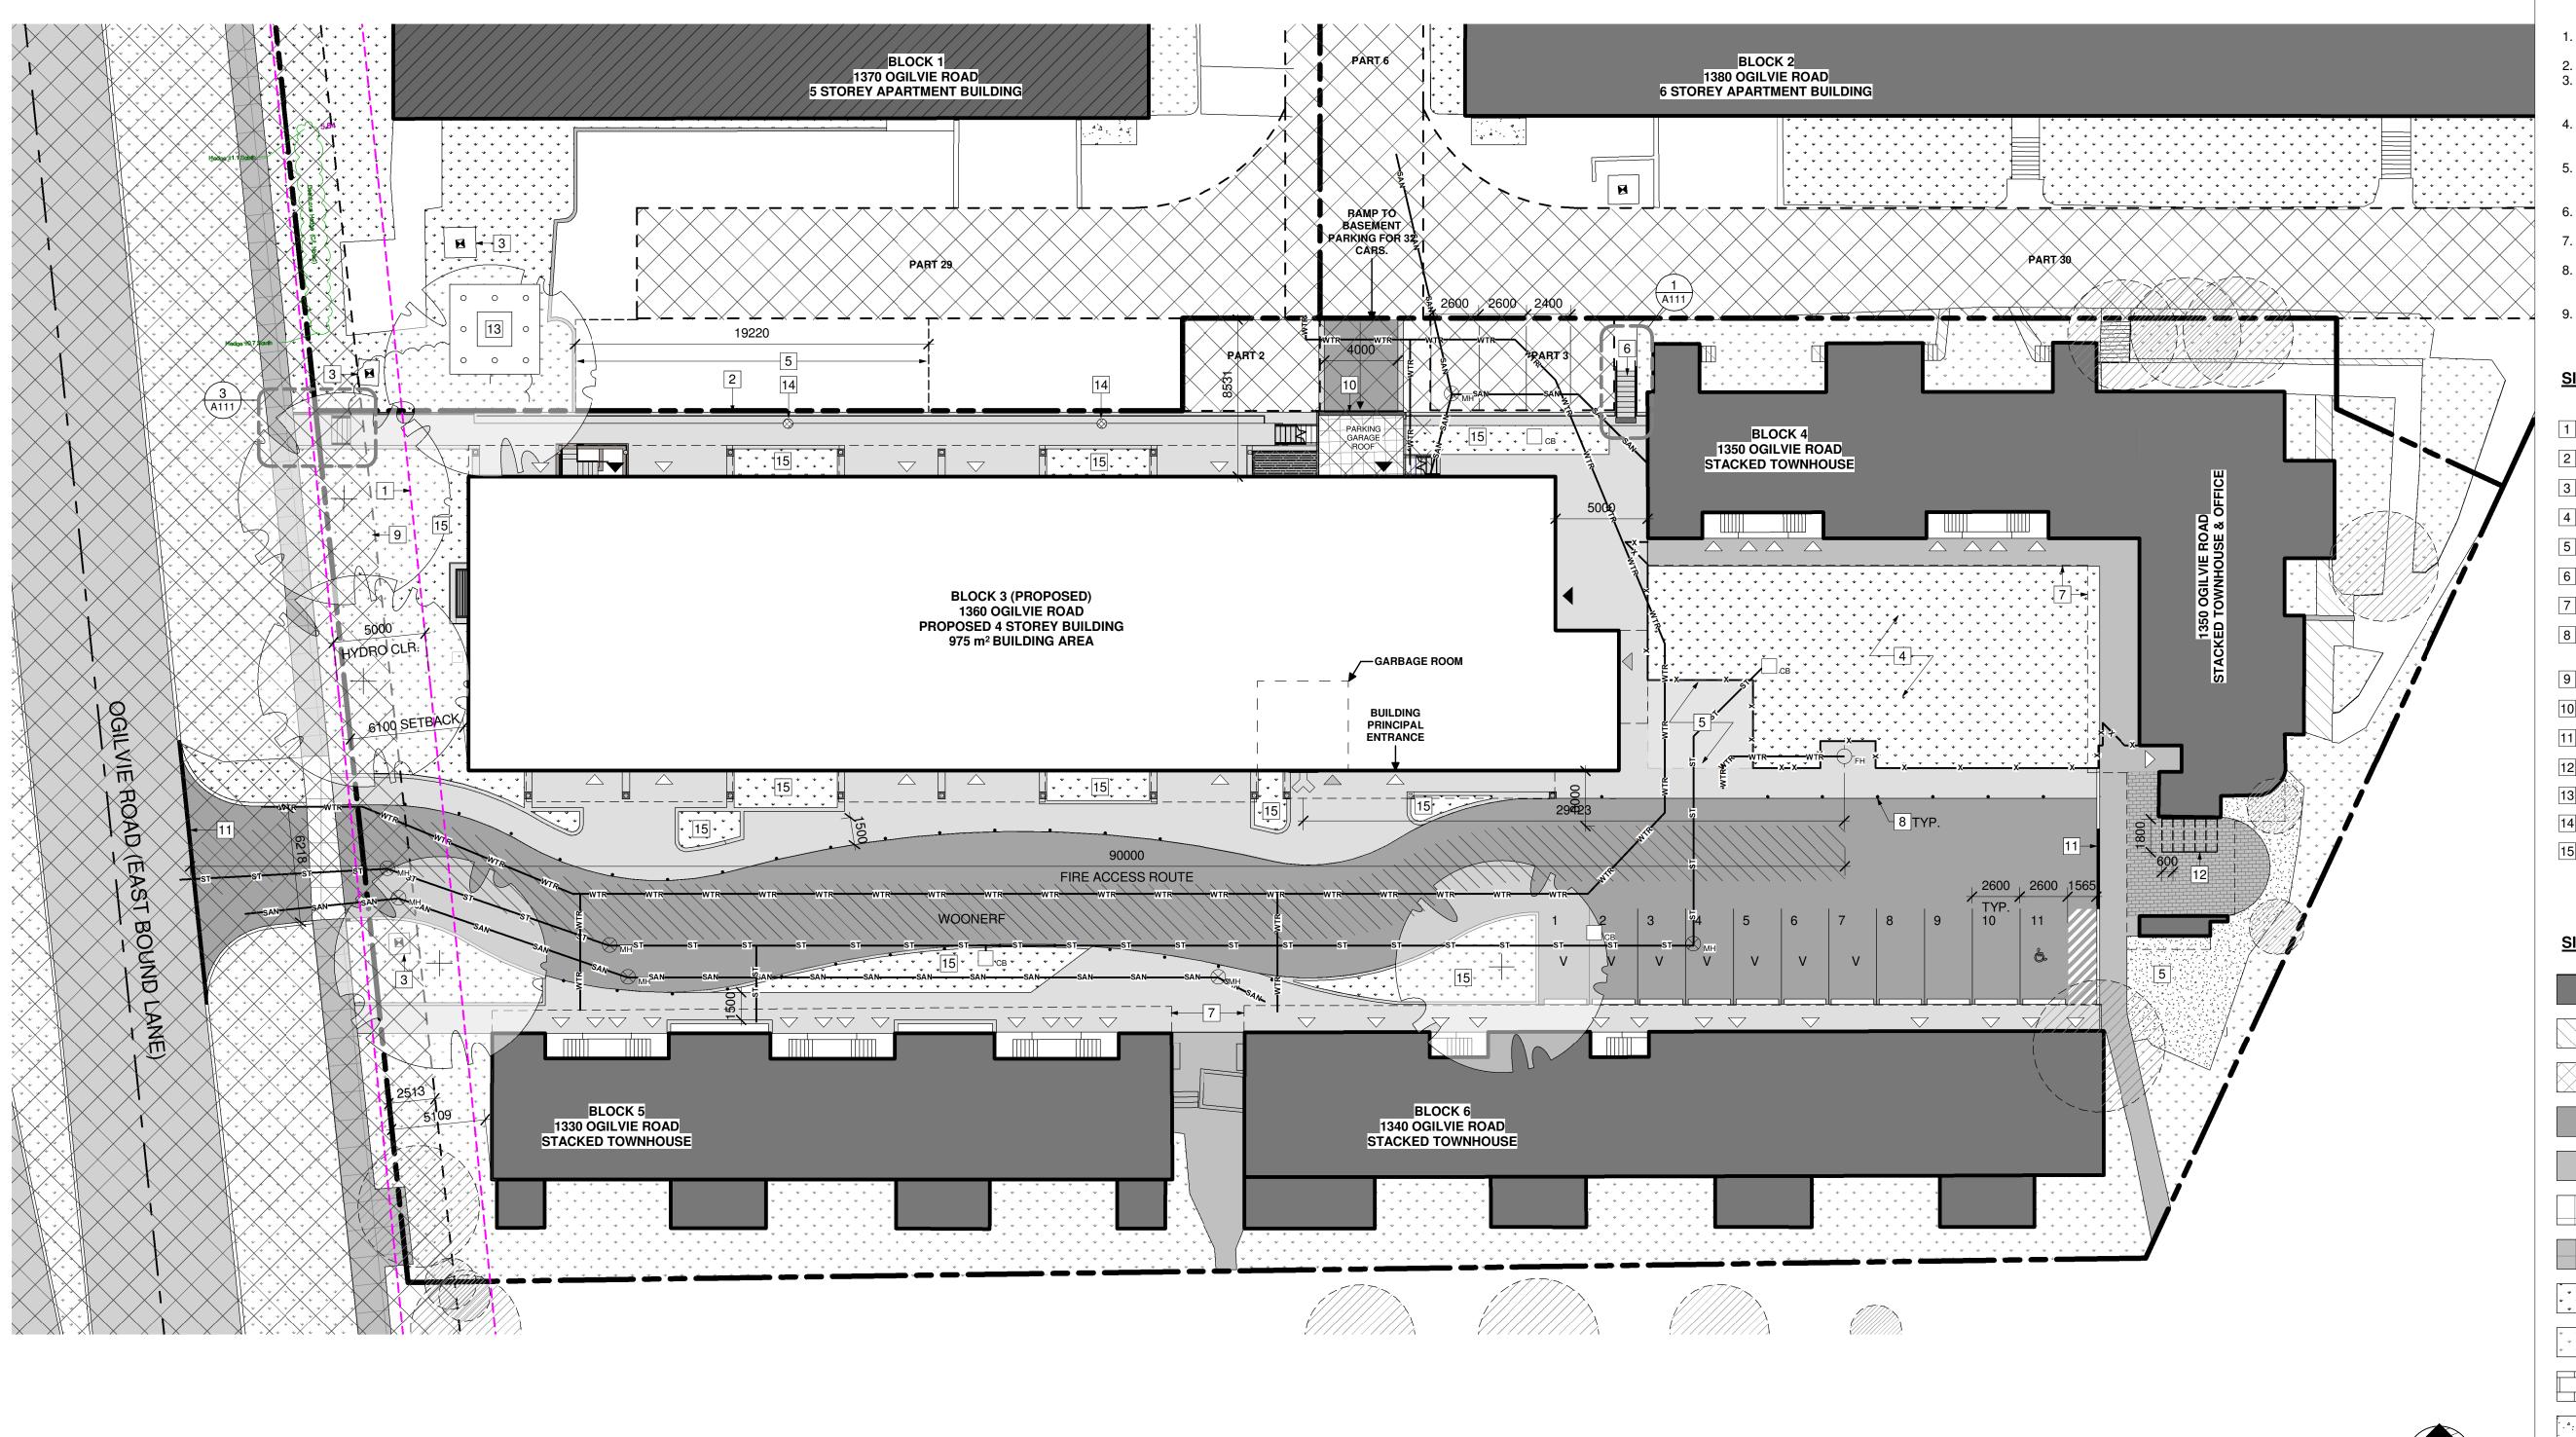

ACCOMODATIONS LEGEND

DEVELOPMENT INFO		ZONING INFO								
LEGAL DESCRIPTION		ZONING PROVISION	REQUIRED	PROVIDED	ZONING PROVISION	REQUIRED	PROVIDED	PARKING QUEING + LOADING	REQUIRED	PROVIDED
BLOCKS C, D, AND L R 4M-172 CITY OF OTTA		MIN. LOT WIDTH	No minimum	47.68m	GROUND FACADE	The ground floor	Building is located	RESIDENTIAL SPACES	92	43
REFERENCE SURVEY	WVA	MIN. LOT AREA	No minimum	5323.54m ²	ACTIVATION	facade facing a public street of a building	front lot line. No	VISITOR SPACES	15	7
BASED ON INFORMAT PREPARED BY ANNIS,		MIN. FRONT YARD SETBACK	Minimum: 0m	6.1m		located within 4.5 m o the front lot line must	face Ogilvie Rd.	ACCESSIBLE PARKING	-	3
VOLLEBEKK LTD. DAT		MIN. INTERIOR SIDE YARD	No minimum	N/A		include: a minimum of one active entrance	•	BICYCLE PARKING	39	44
MUNICIPAL ADDRESS 1360 OGILVIE RD, OTT	AWA ONKILOME	SETBACK	7.5	NVA		from each individual occupancy located		DRIVEWAY WIDTH	3m @ single	4m for single
	AWA, ON KIS SINO	MIN. REAR YARD SETBACK	7.5m	N/A		immediately adjacent to the front lot line			traffic lane	traffic lane, driveway to
SITE AREAS BETTER LIVING CO-OP	5323.54m²	MAX. HEIGHT	40m	13.25m	MINIMUM GLAZING OF	50% of the surface	7.7 m2/ 72m2 =		6m @ double traffic lane	parking garage
COMMUNITY WORKS BIRCHWOOD	2558.69m ² 5028.37m ²	AMENITY AREA	462m2	552m ²	GROUND FLOOR FACADE	area of the ground floor façade facing	10.7% glazing			6m for double traffic lane,
TOTAL	12,910.6m ²	LANDSCAPED AREA	no minimum	349.5m ²		Ogilvie, from the average grade up 4.5				parking lot
BUILDING AREA	975m ²	MIN. FRONTAGE	4.5m	4.3m		metres, must be comprised of				
GROSS FLOOR AREA	3,900m ²	FRONTAGE CALCULATION:	AMENITY BRI			transparent glazing and active customer of	or			
BUILDING HEIGHT	14.15m , 4 STOREYS	43.5m OF BUILDING WALLS / 109.7m OF ENTIRE FRONTAGE = 39% OF	Balconies:	Amenity: 83m2 227m2		resident entrance access doors	•			
	4440 11/40)	FRONTAGE	Playground:	242m2	1	400000 40010				

242m2

Playground:

FRONTAGE

AM10 H(40)

ZONE

	-(•	_	•		TOTAL SITE PAR	NZINIO.
BACHELOR	1				1		OFFICE, RESIDENT, AND
1-BEDROOM	25			0	25	VISITOR PAF	RKING SPACES: 170 SPACES
2-BEDROOM	4	7	6	6	23		ONLY RESIDENT AND VISITO OFFICE: 154 SPACES
3-BEDROOM	9	7	6	4	26	LAGLODING	OITIOL. 134 SFACES
4-BEDROOM				1	1		
5-BEDROOM				1	1		
1-B(SENIOR)					0		
2-B(SENIOR)					0		
TOTAL	39	14	12	12	77		
						•	
			P	ARKING LEG	GEND		
DWELLING LINE TVDE		BLO	OCK		TOTAL	TOTAL REQUIRED	TOTAL PARKING
DWELLING UNIT TYPE	3(NEW)	4	5	6		PARKING	PROVIDED
APARTMENT (1.2)	39				39	47	
STACKED (1.2)	0	14	12	12	38	46	36
VISITOR PARKING (0.2)						15	7
						108	total: 43
			А	MENITY LEG	SEND		
		BLO	OCK		TOTAL	TOTAL REQUIRED	TOTAL AMENITY SPACE
	2/ME/A/)	1	Г		IOIAL	AMENITY CDACE (m.2)	חוס עוס דיי אייט אייט אייט אייט אייט אייט אייט

1. PARKING FIGURES IN TABLE REFLECT BLC

SITE ONLY

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- ALL DISTURBED AREAS TO BE RESTORED TO ORIGINAL CONDITION OR BETTER UNLESS OTHERWISE NOTED

SITE PLAN KEYNOTES:

- OTTAWA HYDRO SETBACK / CLEARANCES
- NEW RETAINING WALL PER 1/A111
- EXISTING HYDRO TRANSFORMER ON CONCRETE PAD
- PLAYGROUND AREA (N.I.C)
- SNOW STORAGE
- NEW LANDSCAPE STAIR
- EXISTING ROOF OVERHANG
- BOLLLARDS ALONG PROPOSED WOONERF, REFER TO
- LANDSCAPE ROW EASEMENT
- LOCATION OF TRAFFIC SIGNAL
- DEPRESSED CURB
- NEW BIKE RACKS (5 TOTAL)
- NEW TRANSFORMER PER ELECTRICAL DOCUMENTS
- AREA DRAIN. REFER TO CIVIL DOCUMENTS
- SOFT LANDSCAPING PER LANDSCAPE

SITE PLAN LEGEND:

EXISTING BUILDING (NOT IN SCOPE)

FIRE ACCESS ROUTE

EASEMENT / ROW

ASPHALT PAVING - NEW

ASPHALT PAVING - EXISTING

CONCRETE SIDEWALK - NEW

CONCRETE SIDEWALK - EXISTING

GRASS - NEW GRASS - EXISTING

PAVER TYPE 1 - NEW

CONCRETE PAD

PROPERTY LINE

— — — — EXTENT OF EASEMENT / ROW OTTAWA HYDRO SETBACK _____

____ x ____ FENCING PER LANDSCAPE

NEW DOMESTIC WATER **NEW SANITARY**

NEW STORM NEW ELECTRICAL SERVICE BELOW GRADE

СВ CATCH BASIN

— н —

--FH FIRE HYDRANT

 \bigotimes_{MH} MANHOLE $\stackrel{\textstyle \curvearrowleft}{\longrightarrow}$ SIAMESE CONNECTION

EMERGENCY EXIT

SERVICE DOORS BUILDING MAIN ENTRANCE / \triangle TOWN ENTRANCE

MECHANICAL AND ELECTRICAL **ENGINEER** Chorley + Bisset Consulting Engineers 250 City Centre Avenue Ottawa, Ontario K1R 6K7 613-241-0030 email@chorley.com

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STAMP 9 2025-09-04 Re-Issued for SPC 8 2025-03-17 Reissued for SPC

7 2025-02-19 Issued for Permit 6 2025-02-13 Permit Coordination 5 2024-11-08 Issued for 80% Review

4 2024-10-08 Issued for SPC

2 2024-07-15 Issued for SPC 1 2024-07-19 Issued for 66%

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CLIENT

PROJECT

BETTER LIVING CO-OPERATIVE OTTAWA

ONTARIO, CANADA

BLOCK 3 **REDEVELOPMENT**

1360 OGILVIE ROAD GLOUCESTER, ON K1J 9M6

TITLE


PROPOSED SITE PLAN

PROJECT NO: 2022-2040 DRAWN: KM APPROVED: PM SCALE: As indicated DATE PRINTED: 2025-09-03 4:44:30 PM


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A110


19156



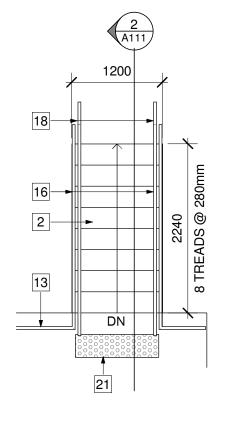


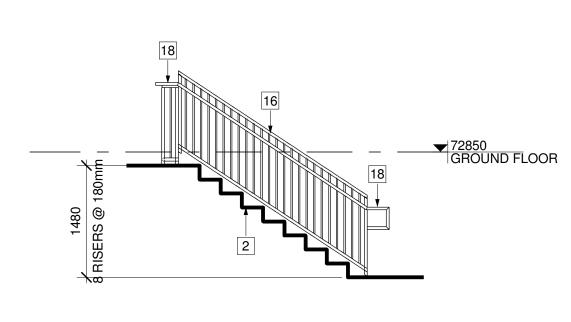


2 STAIR SECTION

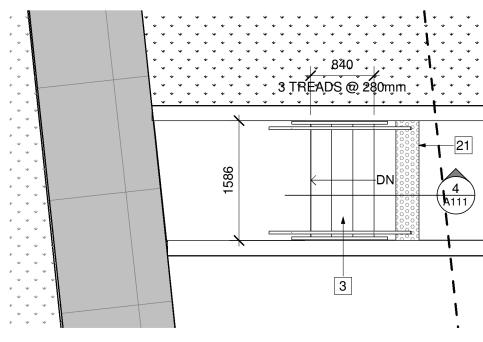

3 SITE STAIR A PLAN DETAIL

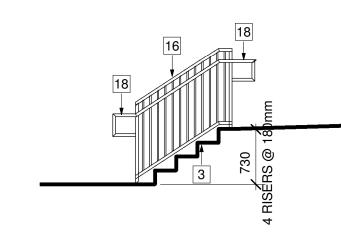

4 STAIR SECTION

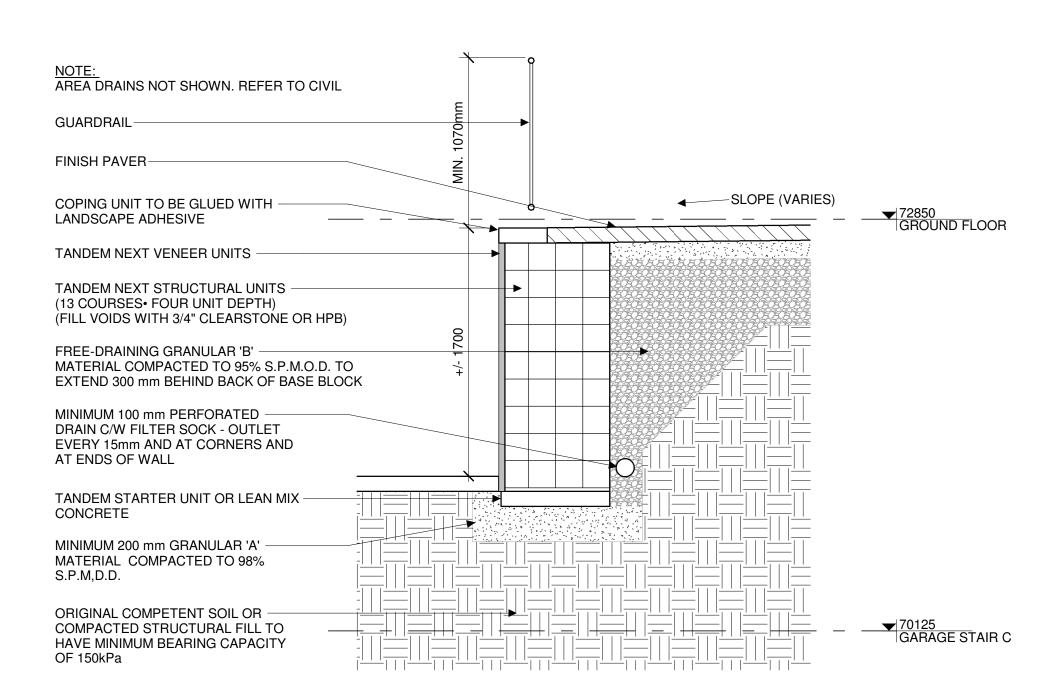

5 RETAINING WALL SECTION @ GL 1
A111 1:25

GENERAL STAIR NOTES:

- 1. DEMARCATE LEADING EDGE OF TREADS AND LEADING EDGE OF LANDING WITH COLOUR CONTRAST/DISTINCTIVE VISUAL PATTERN.
- 2. CONTRACTOR TO PROVIDE ENGINEERED STAMPED SHOP DRAWINGS OF STAIRS, HANDRAILS AND GUARDS SEALED AND SIGNED BY A PROFESSIONAL STRUCTURAL ENGINEER LICENSED IN THE PROVINCE OF ONTARIO.
- 3. PROVIDE 50mm MIN. CLEARANCE BETWEEN HANDRAIL AND ANY ADJACENT SURFACE.
- 4. ALL METAL COMPONENTS FOR GUARDS AND HANDRAILS TO BE PRIMED AND PAINTED. COLOUR PER FINISH PLANS
- 5. PROVIDE 50mm MIN. CLEARANCE BETWEEN HANDRAIL AND ANY ADJACENT SURFACE.
- 6. PROVIDE COLOUR CONTRASTING AND SLIP RESISTANT STRIP ALONG EDGE OF NOSINGS AS PER OBC 2012 3.4.6.1. VISUAL INDICATOR STRIP TO BE INT INTEGRATED INTO TREAD LINER FINISH MATERIAL.

STAIR KEYNOTES:

STAIR TYPE

- WOOD STAIR
- PRECAST CONCRETE STAIR
- CAST-IN-PLACE CONCRETE STAIR
- STEEL PAN TREAD C/W CLOSED RISER & CONCRETE
- FILL ,PAINTED. STAIR FINISH PER FLOOR FINISH PLAN
- INTERMEDIATE LANDING SEE STRUCTURAL

GUARDRAIL/HANDRAIL TYPE

- 38mm Ø METAL WALL MOUNTED HANDRAIL PER OBC 3.4.6.5
- 38mm Ø WOOD WALL MOUNTED HANDRAIL
- 1070mm HIGH STEEL GUARD C/W 16mm Ø BALUSTERS @ 100mm O.C.
- 915mm HIGH CONTINUOUS 38mm Ø METAL HANDRAIL MOUNTED TO STAIR STRINGER C/W 16mm Ø BALUSTERS @ 100mm O.C.
- 915mm HIGH CONTINUOUS 38mmØ METAL HANDRAIL MOUNTED TO 1070mm HIGH METAL GUARD C/W 16mm Ø BALUSTERS @ 100mm O.C. CONNECTED TO STRINGERS WITH MOUNTING PLATE
- 915mm HIGH CONTINUOUS 38mmØ METAL HANDRAIL MOUNTED TO 1070mm HIGH METAL GUARD C/W 16mm Ø BALUSTERS @ 100mm O.C. CAST INTO PRECAST CONCRETE
- WALL MOUNTED HANDRAIL BRACKET, PAINTED TYP.
- 300mm HANDRAIL EXTENSION (TYP.)

305mm TACTILE INDICATOR STRIP TO COMPLY WITH OBC 3.4.6.1 AND 3.8.3.18 (2) REFER TO SPECS - TYP. EXTEND FULL WIDTH OF STAIRS AS SHOWN.

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LANDSCAPE ARCHITECT James B. Lennox & Associates 3332 Carling Avenue Ottawa, Ontario K2H 5A8 613-722-5168

CIVIL ENGINEER address

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CLIENT

BETTER LIVING CO-OPERATIVE

AND APPLICABLE MUNICIPAL REGULATIONS.

OTTAWA ONTARIO, CANADA

PROJECT

BLOCK 3 **REDEVELOPMENT**

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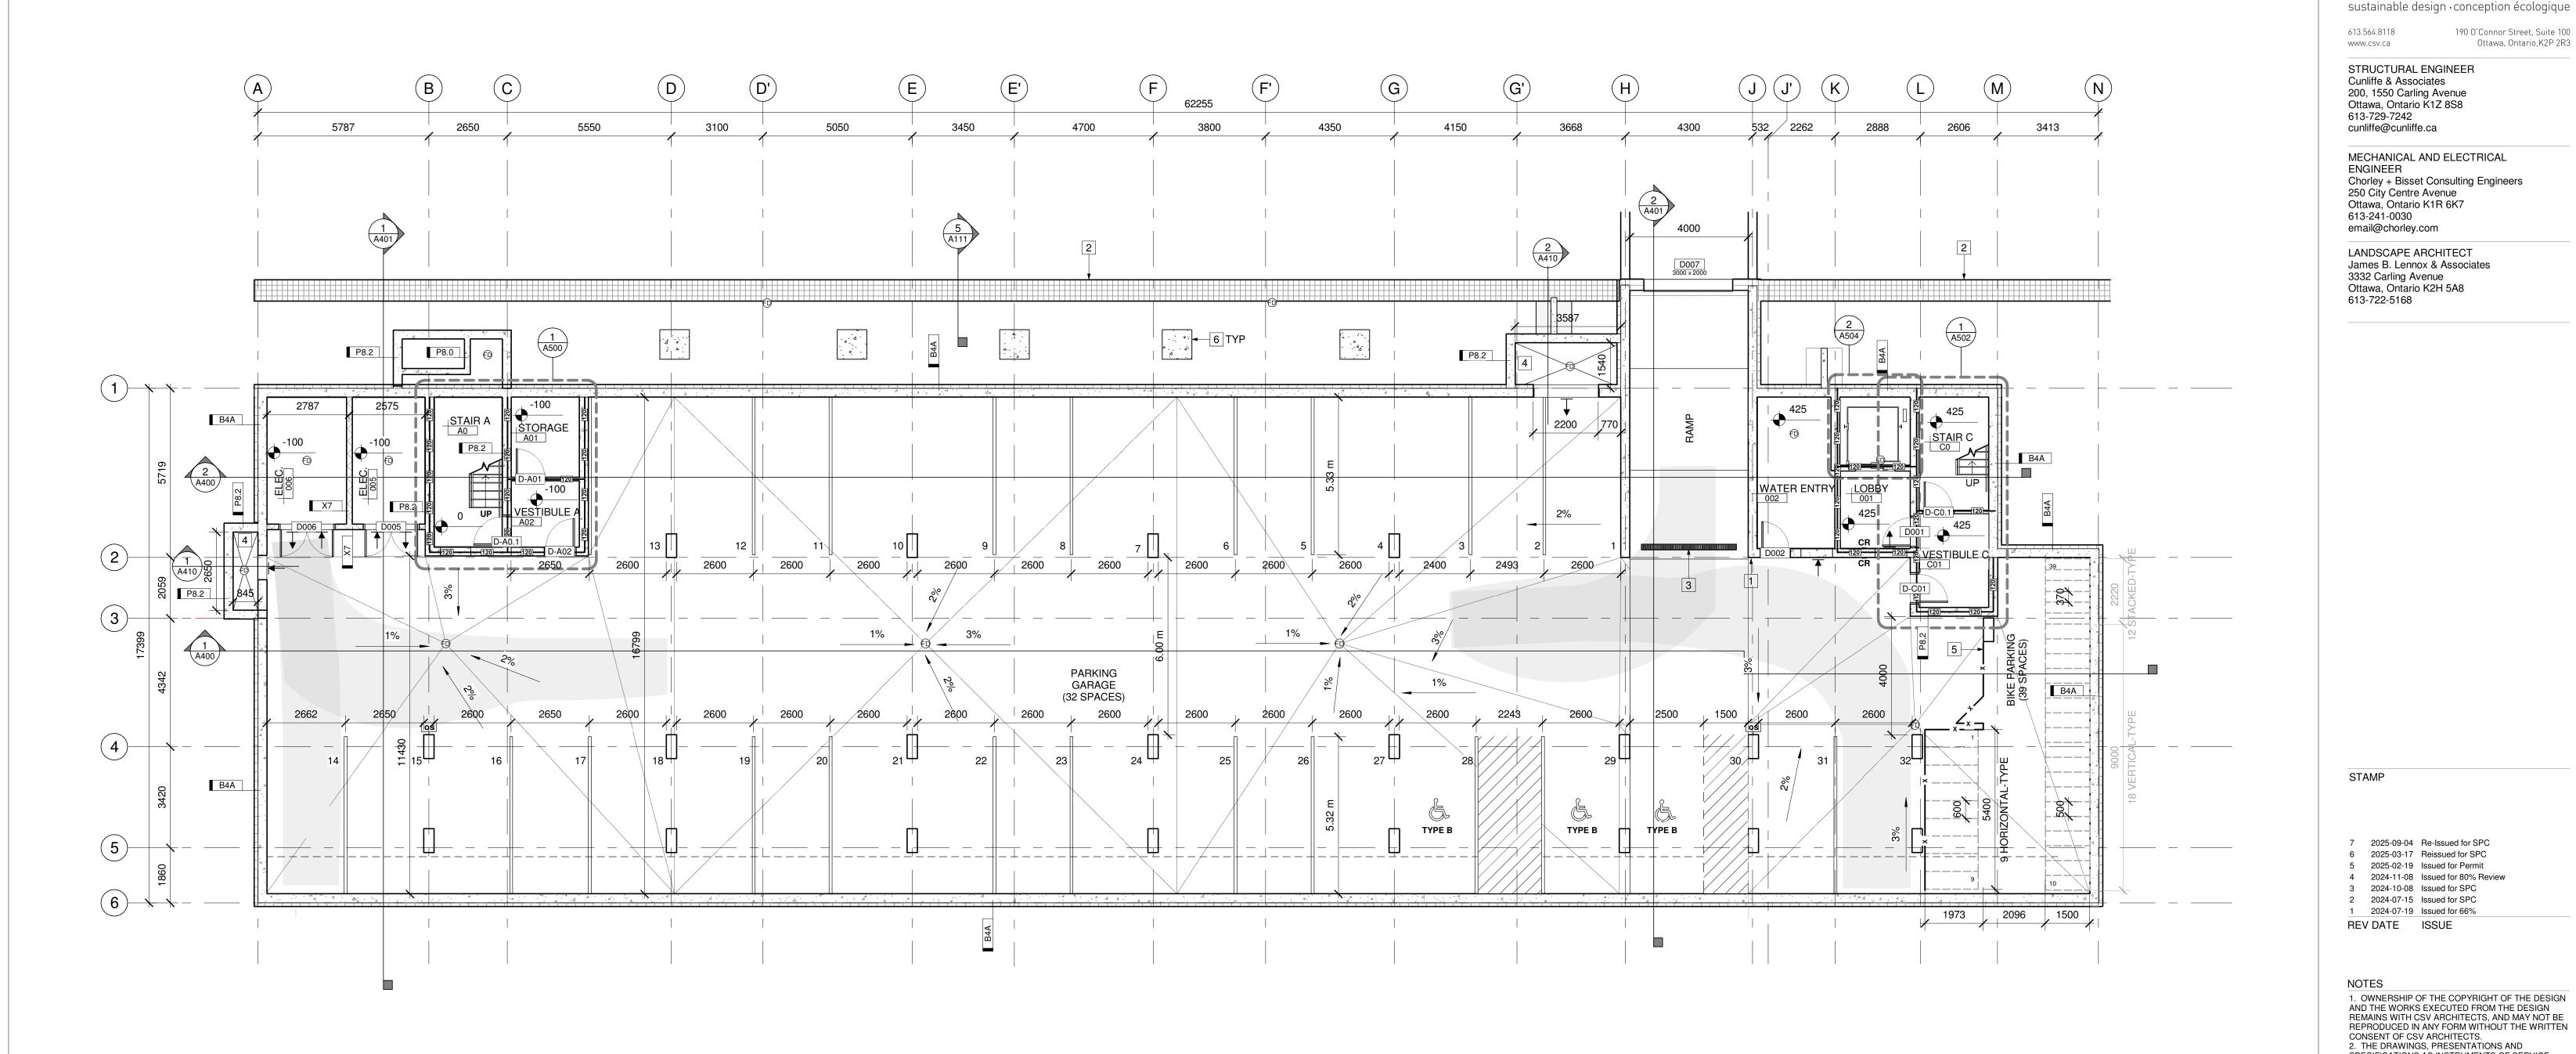
SITE DETAILS

PROJECT NO: 2022-2040 DRAWN: DF APPROVED: DH

As indicated DATE PRINTED: 2025-09-03 4:44:34 PM

REV

DRAWING NO. 7 A111 6



1 UNDERGROUND PARKING LEVEL

GENERAL REFERENCE PLAN NOTES:

- 1. ALL DIMENSIONS ARE TO FACE OF FRAMING UNLESS OTHERWISE NOTED.
- 2. ALL DOOR DIMENSIONS ARE TO THE CENTRE OR INSIDE OF FRAME. 3. ALL WINDOW DIMENSIONS ARE TO THE CENTER OR OUTSIDE OF FRAME.

UNDERGROUND PARKING PLAN KEYNOTES:

- 1 LOCATION OF TRAFFIC SIGNAL
- 2 PRE-ENGINEEREDE RETAINING WALL
- 3 TRENCH DRAIN, REFER TO MECHANICAL DOCUMENTS
- 4 AREAWAY
- 5 SECURE BIKE STORAGE. CHAINLINK FENCE W/ ACCESS DOOR. SECURE FENCE TO FLOOR SLAB AND TO U/S SLAB ABOVE
- 6 PIER FOOTING PER STRUCTURAL DOCUMENTS

LEGEND:

EARTH BACKFILL

ACCESSIBLE PARKING AISLE

— 0 MIN. FIRE RESISTANCE RATING 45 MIN. FIRE RESISTANCE RATING

60 MIN. FIRE RESISTANCE RATING 90 MIN. FIRE RESISTANCE RATING

CARD READER

DOOR

FLOOR DRAIN, REFER TO MECHANICAL.

OS OS SENSOR, WALL INTAKE LOUVRE

EXHAUST LOUVRE

REV

A200 B

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CLIENT

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NOTES

7 2025-09-04 Re-Issued for SPC 2025-03-17 Reissued for SPC 2025-02-19 Issued for Permit 4 2024-11-08 Issued for 80% Review 3 2024-10-08 Issued for SPC 2 2024-07-15 Issued for SPC 1 2024-07-19 Issued for 66% REV DATE ISSUE

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OTTAWA ONTARIO, CANADA

PROJECT

BLOCK 3 REDEVELOPMENT


1360 OGILVIE ROAD GLOUCESTER, ON K1J 9M6

UNDERGROUND PARKING PLAN

PROJECT NO: 2022-2040 DRAWN: DF APPROVED: PM 1:100

DRAWING NO. 7

DATE PRINTED: 2025-09-03 4:44:38 PM

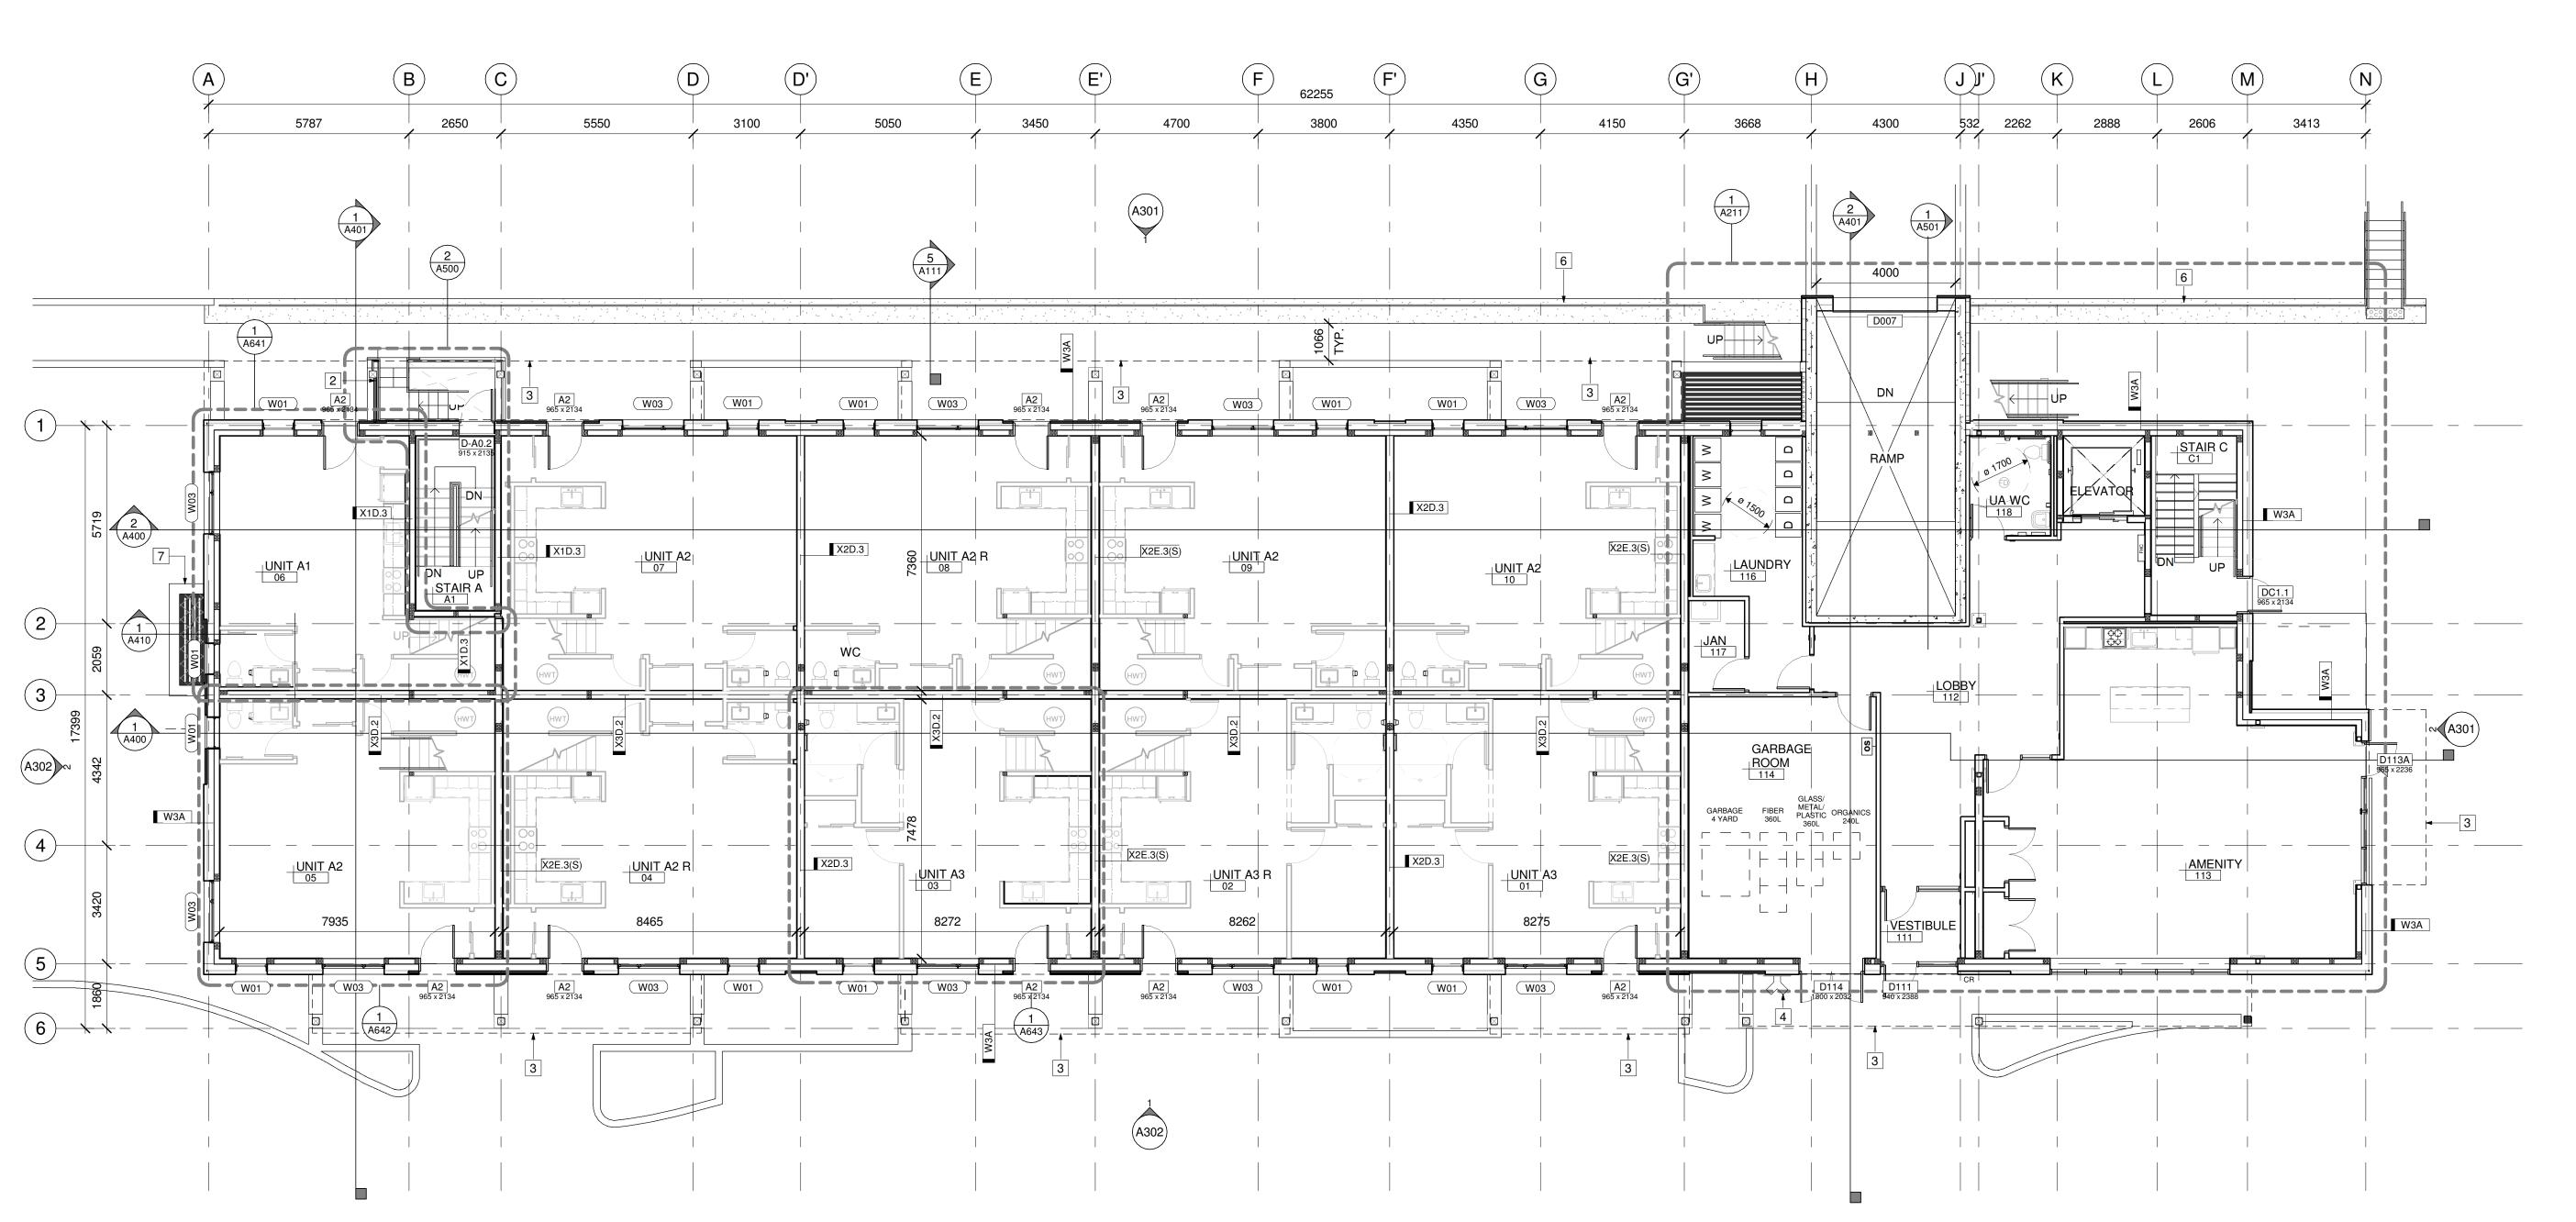

1 GROUND FLOOR KEY PLAN

GENERAL REFERENCE PLAN NOTES:

- 1. ALL DIMENSIONS ARE TO FACE OF FRAMING UNLESS OTHERWISE NOTED.
- 2. ALL DOOR DIMENSIONS ARE TO THE CENTRE OR INSIDE OF FRAME. 3. ALL WINDOW DIMENSIONS ARE TO THE CENTER OR OUTSIDE OF FRAME.

REFERENCE PLAN KEYNOTES:

- 1 MAILBOXES
- 2 PRIVACY SCREEN
- 3 CANOPY ABOVE
- 4 FIRE DEPARTMENT CONNECTION
- 5 FIRE ALARM CONTROL PANEL
- 6 RETAINING WALL C/W GUARDRAIL
- 7 BASEMENT AREAWELL, REFER TO A410

EXISTING BUILDING (NOT IN SCOPE) FIRE ACCESS ROUTE

EXTENT OF EASEMENT

ASPHALT PAVING - NEW

ASPHALT PAVING - EXISTING CONCRETE SIDEWALK - NEW

CONCRETE SIDEWALK - EXISTING

GRASS - NEW

SITE PLAN LEGEND:

GRASS - EXISTING PAVER TYPE 1 - NEW

CONCRETE PAD

LEGEND:

NOT IN CONTRACT NEW CONSTRUCTION

— 0 MIN. FIRE RESISTANCE RATING 45 MIN. FIRE RESISTANCE RATING 60 MIN. FIRE RESISTANCE RATING

90 MIN. FIRE RESISTANCE RATING 120 MIN. FIRE RESISTANCE RATING

DOOR

DOOR OPERATOR

GROUND FLOOR PLAN

PROJECT NO: 2022-2040 DRAWN: KM, DF APPROVED: PM

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James B. Lennox & Associates 3332 Carling Avenue Ottawa, Ontario K2H 5A8

MECHANICAL AND ELECTRICAL

Chorley + Bisset Consulting Engineers 250 City Centre Avenue Ottawa, Ontario K1R 6K7

4 2024-11-08 Issued for 80% Review 3 2024-10-08 Issued for SPC 2 2024-07-15 Issued for SPC

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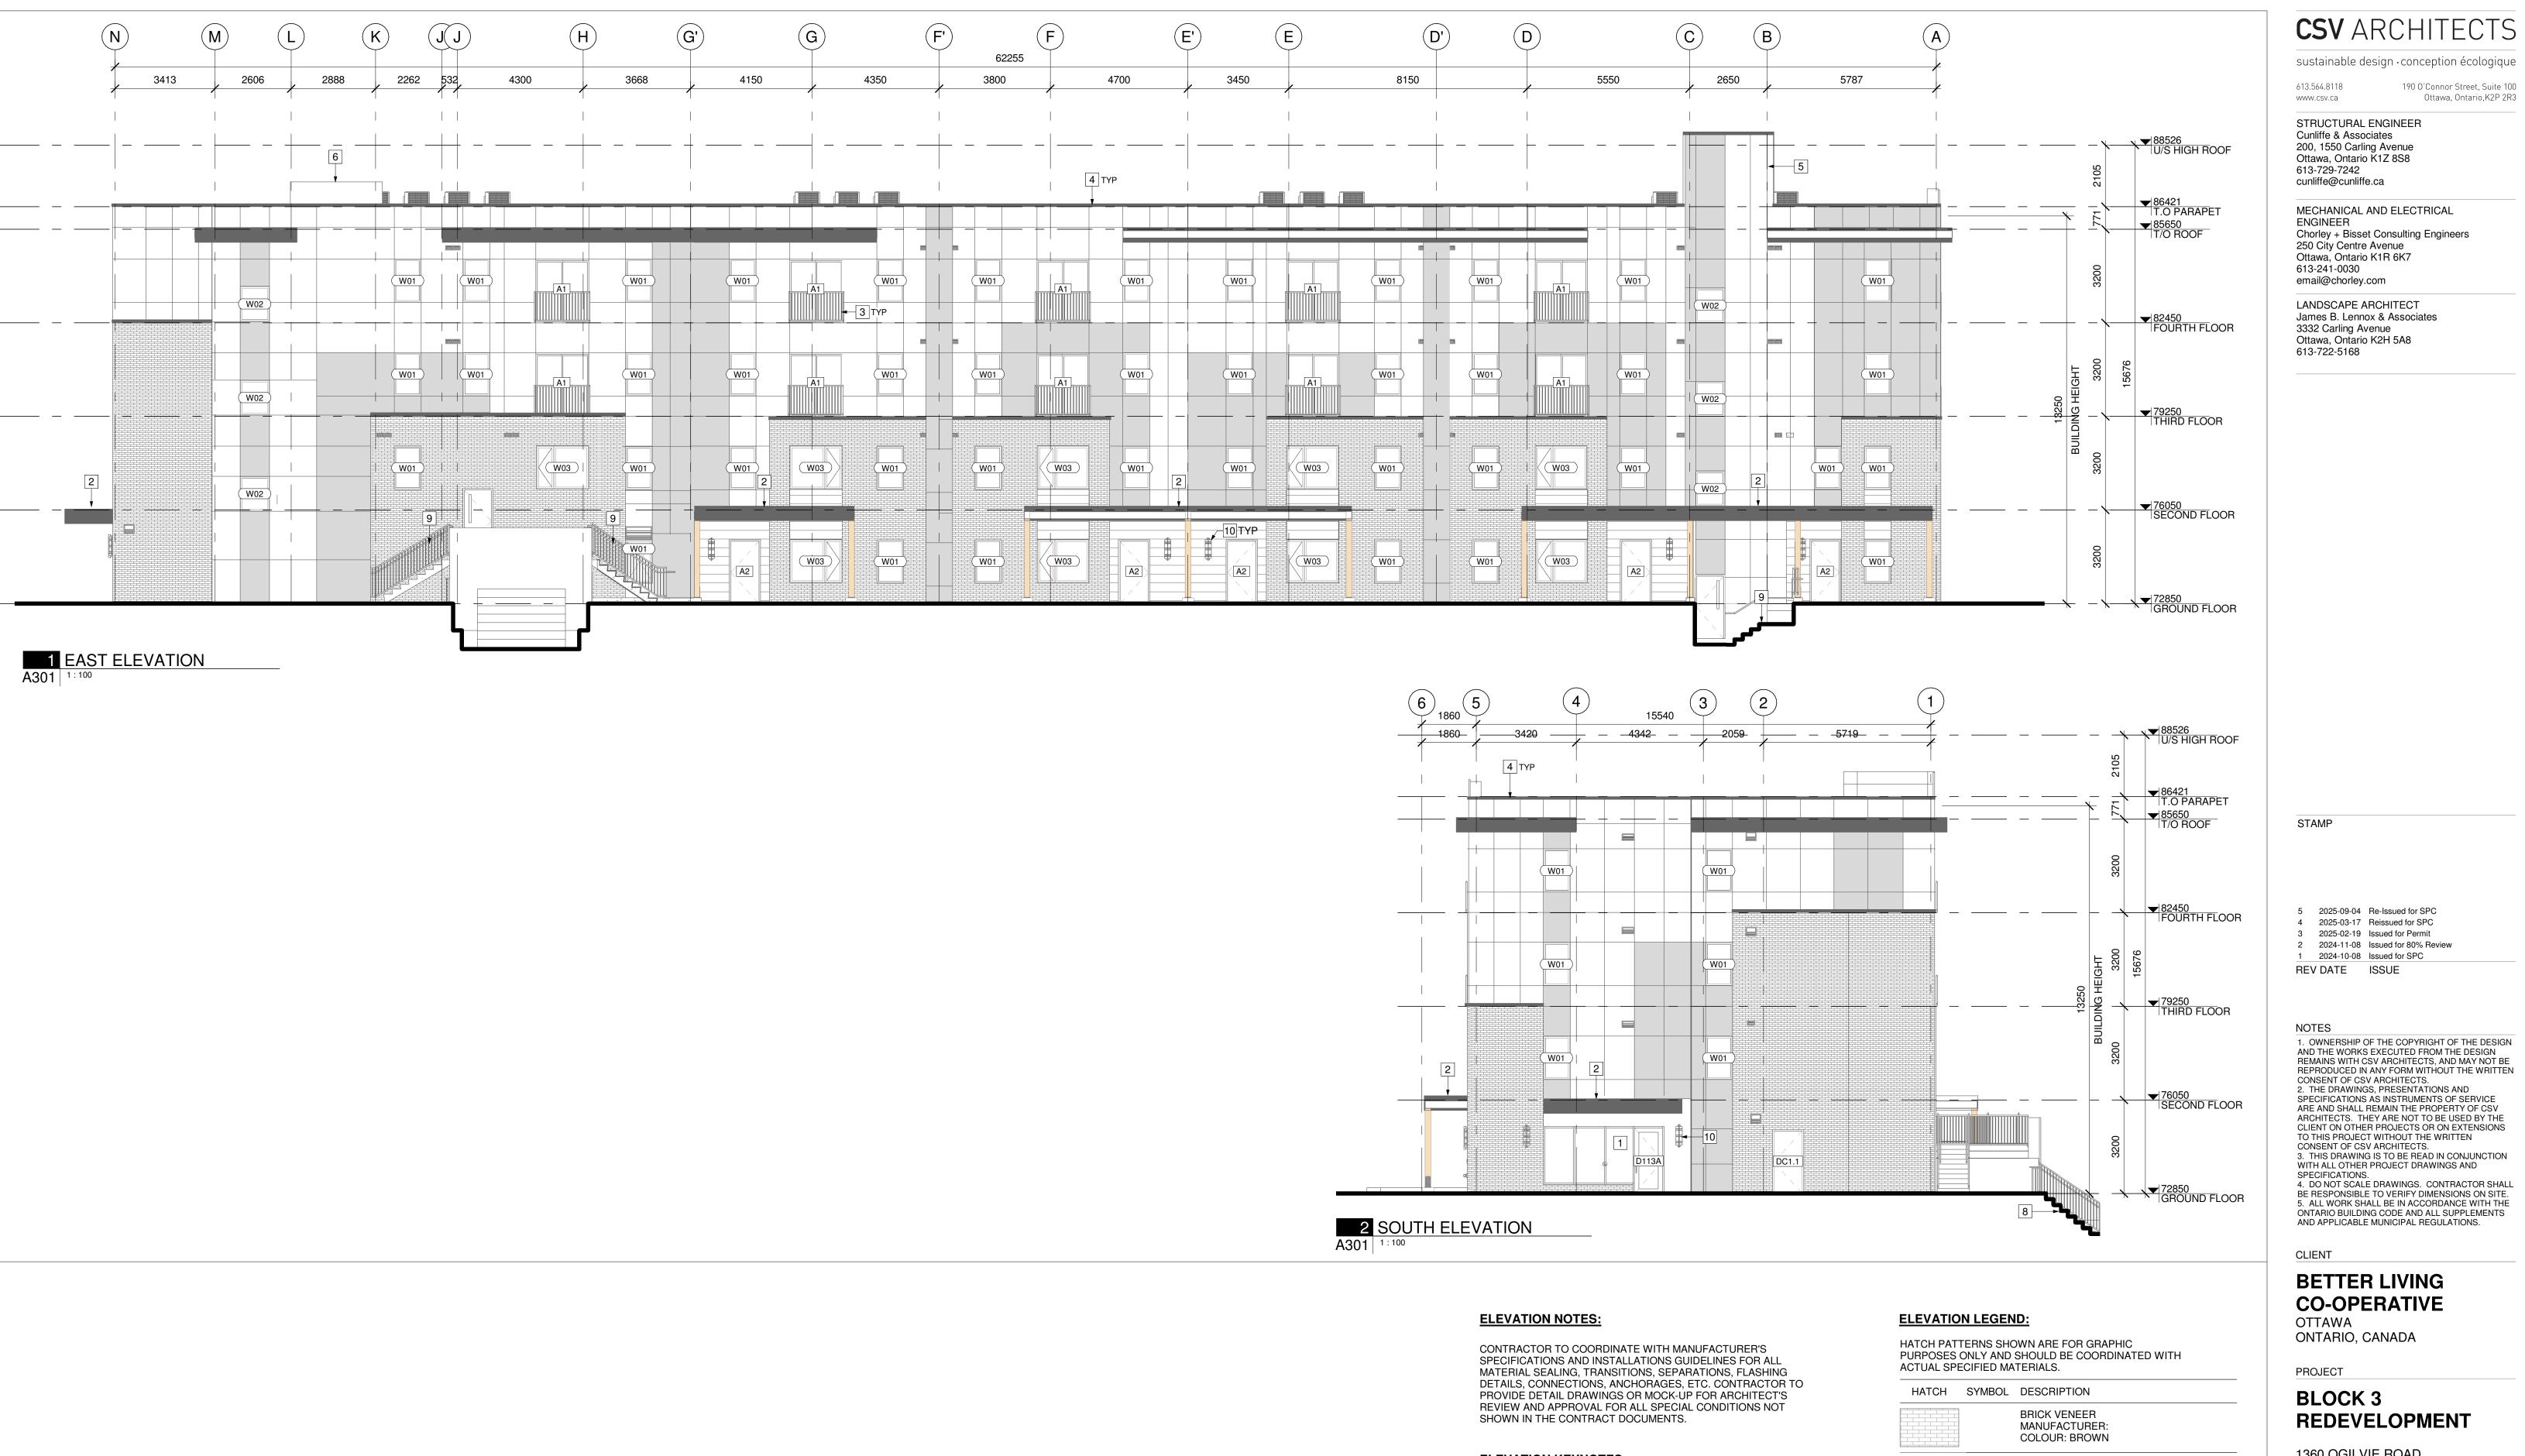
PROJECT

BLOCK 3 **REDEVELOPMENT**

1360 OGILVIE ROAD GLOUCESTER, ON K1J 9M6


As indicated DATE PRINTED: 2025-09-03 4:44:43 PM DRAWING NO. ₹

A201



ELEVATION KEYNOTES:

- 1 STOREFRONT WALL SYSTEM
- 2 CANOPY
- 3 JULIETTE BALCONY
- 4 PREFINISHED METAL FLASHING
- 5 ROOFTOP ACCESS
- 6 ELEVATOR OVERRUN 7 GARAGE DOOR
- 8 NEW LANDSCAPE STAIR C/W HANDRAIL AND GUARDRAIL
- 9 EMERGENCY EXIT STAIR
- 10 EXTERIOR LIGHT FIXTURE

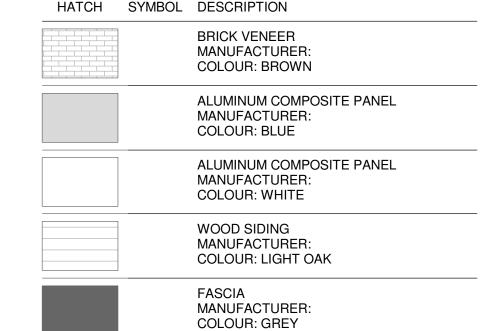

OTTAWA ONTARIO, CANADA

PROJECT

BLOCK 3 **REDEVELOPMENT**

2025-09-04 Re-Issued for SPC

1360 OGILVIE ROAD GLOUCESTER, ON K1J 9M6 TITLE

EXTERIOR ELEVATIONS

PROJECT NO: 2022-2040 DRAWN: DF APPROVED: DH As indicated DATE PRINTED: 2025-09-03 4:44:54 PM


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A301





ELEVATION NOTES:

CONTRACTOR TO COORDINATE WITH MANUFACTURER'S SPECIFICATIONS AND INSTALLATIONS GUIDELINES FOR ALL MATERIAL SEALING, TRANSITIONS, SEPARATIONS, FLASHING DETAILS, CONNECTIONS, ANCHORAGES, ETC. CONTRACTOR TO PROVIDE DETAIL DRAWINGS OR MOCK-UP FOR ARCHITECT'S REVIEW AND APPROVAL FOR ALL SPECIAL CONDITIONS NOT SHOWN IN THE CONTRACT DOCUMENTS.

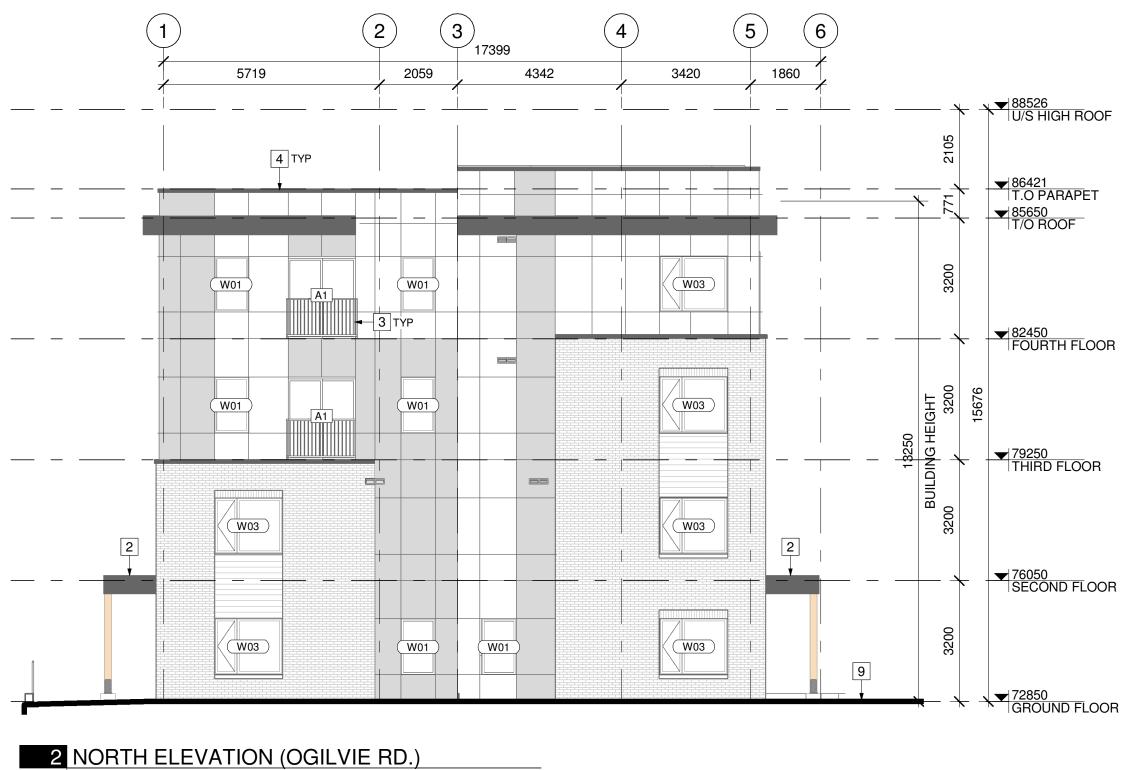ELEVATION KEYNOTES:

- 1 STOREFRONT WALL SYSTEM
- 2 CANOPY
- 3 JULIETTE BALCONY
- 4 PREFINISHED METAL FLASHING
- 5 ROOFTOP ACCESS
- 6 ELEVATOR OVERRUN
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- 9 EMERGENCY EXIT STAIR
- 10 EXTERIOR LIGHT FIXTURE

ELEVATION LEGEND:

HATCH PATTERNS SHOWN ARE FOR GRAPHIC PURPOSES ONLY AND SHOULD BE COORDINATED WITH ACTUAL SPECIFIED MATERIALS.

HATCH	SYMBOL	DESCRIPTION
		BRICK VENEER MANUFACTURER: COLOUR: BROWN
		ALUMINUM COMPOSITE PANEL MANUFACTURER: COLOUR: BLUE
		ALUMINUM COMPOSITE PANEL MANUFACTURER: COLOUR: WHITE
		WOOD SIDING MANUFACTURER: COLOUR: LIGHT OAK
		FASCIA MANUFACTURER: COLOUR: GREY

CSV ARCHITECTS

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MECHANICAL AND ELECTRICAL **ENGINEER** Chorley + Bisset Consulting Engineers 250 City Centre Avenue Ottawa, Ontario K1R 6K7 613-241-0030

LANDSCAPE ARCHITECT James B. Lennox & Associates 3332 Carling Avenue Ottawa, Ontario K2H 5A8 613-722-5168

email@chorley.com

STAMP

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CLIENT

BETTER LIVING CO-OPERATIVE

OTTAWA ONTARIO, CANADA

PROJECT

BLOCK 3 **REDEVELOPMENT**

1360 OGILVIE ROAD GLOUCESTER, ON K1J 9M6

TITLE **EXTERIOR ELEVATIONS**

PROJECT NO: 2022-2040 DRAWN: DF APPROVED: DH As indicated

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A302