

traffic lane,

parking lot

STACKED (1.2)

VISITOR PARKING (0.2)

DWELLING UNITS

BLOCK

3(NEW) 4

floor façade facing

average grade up 4.5

and active customer or

Ogilvie, from the

metres, must be

transparent glazing

resident entrance

comprised of

access doors

349.5m²

227m2

242m2

no minimum

Balconies:

Playground:

AMENITY BREAKDOWN

Ground Floor Amenity: 83m2

SITE AREA

ZONE

BUILDING AREA

BUILDING HEIGHT

GROSS FLOOR AREA

12,912m²

975m²

3,900m²

AM10 H(40)

14.15m, 4 STOREYS

LANDSCAPED AREA

SITE PLAN GENERAL NOTES:

- 1. ALL GENERAL SITE INFORMATION AND CONDITIONS COMPILED FROM EXISTING PLANS AND SURVEYS
- 2. DO NOT SCALE THIS DRAWING 3. REPORT ANY DISCREPANCIES PRIOR TO COMMENCING WORK. NO RESPONSIBILITY IS BORN BY THE CONSULTANT FOR UNKNOWN SUBSURFACE CONDITIONS
- 4. CONTRACTOR TO CHECK AND VERIFY ALL DIMENSIONS ON SITE AND REPORT ANY ERRORS AND/OR OMISSIONS TO THE CONSULTANT
- 5. REINSTATE ALL AREAS AND ITEMS DAMAGED AS A RESULT OF CONSTRUCTION ACTIVITIES TO THE SATISFACTION OF THE
- 6. CONTRACTOR TO LAYOUT PLANTING BEDS, PATHWAYS ETC. TO APPROVAL OF CONSULTANT PRIOR TO ANY JOB EXCAVATION 7. THE ACCURACY OF THE POSITION OF UTILITIES IS NOT
- GUARANTEED CONTRACTOR TO VERIFY PRIOR TO EXCAVATION 8. INDIVIDUAL UTILITY COMPANY MUST BE CONTACTED FOR CONFIRMATION OF UTILITY EXISTENCE AND LOCATION PRIOR TO
 - 9. ALL DISTURBED AREAS TO BE RESTORED TO ORIGINAL CONDITION OR BETTER UNLESS OTHERWISE NOTED

SITE PLAN KEYNOTES:

- 1 OTTAWA HYDRO SETBACK / CLEARANCES
- 2 PROPOSED RETAINING WALL
- 3 EXISTING HYDRO TRANSFORMER ON CONCRETE PAD
- 4 PLAYGROUND AREA
- 5 SNOW STORAGE
- 6 NEW LANDSCAPE STAIR
- 7 EXISTING TREE TO REMAIN, REFER TO LANDSCAPE
- 8 BOLLARDS ALONG PROPOSED WOONERF, TYP.
- 9 EASEMENT
- 10 PARKING GARAGE SIGNAL
- 11 DEPRESSED CURB
- 12 EXISTING (NONCOMPLIANT) BIKE RACKS TO REMAIN. EXISTING RACKS NOT INCLUDED IN NEW BIKE PARKING
- 13 NEW HYDRO TRANSFORMER ON CONCRETE PAD

SITE PLAN LEGEND:

AREA NOT IN SCOPE			
EXISTING BUILDING (NOT IN SCOPE)			
EXTENT OF EASEMENT			

- ASPHALT PAVING NEW
- ASPHALT PAVING EXISTING CONCRETE SIDEWALK - NEW
- CONCRETE SIDEWALK EXISTING **GRASS - NEW**
- **GRASS EXISTING** PAVER TYPE 1 - NEW
- CONCRETE PAD
- **EMERGENCY EXIT** SERVICE DOORS
- **BUILDING MAIN ENTRANCE**
- PROPERTY LINE
- -x-x- FENCE PER LANDSCAPE
- -san-san- NEW SANITARY
- -st-st- NEW STORM
- —H——H— NEW ELECTRICAL SERVICE (BELOW GRADE) —н——н— GAS
 - CATCH BASIN
 - CATCH BASIN EXISTING
 - LIGHT STANDARD
 - LIGHT STANDARD EXISTING
 - FIRE HYDRANT
 - FIRE HYDRANT EXISTING
 - \bigotimes_{MH} MANHOLE MANHOLE EXISTING UTILITY POLE

total: 43

PROVIDED (m2)

TOTAL REQUIRED TOTAL AMENITY SPACE

AMENITY SPACE (m2)

- UTILITY POLE EXISTING
- SIAMESE CONNECTION

— DROPPED CURB

CSV ARCHITECTS

sustainable design · conception écologique 190 O'Connor Street, Suite 100 613.564.8118

Ottawa, Ontario,K2P 2R3 www.csv.ca STRUCTURAL ENGINEER Cunliffe & Associates 200, 1550 Carling Avenue Ottawa, Ontario K1Z 8S8

613-729-7242

613-722-5168

cunliffe@cunliffe.ca

MECHANICAL AND ELECTRICAL **ENGINEER** Chorley + Bisset Consulting Engineers 250 City Centre Avenue Ottawa, Ontario K1R 6K7 613-241-0030

email@chorley.com LANDSCAPE ARCHITECT James B. Lennox & Associates 3332 Carling Avenue Ottawa, Ontario K2H 5A8

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CLIENT

BETTER LIVING CO-OPERATIVE

OTTAWA ONTARIO, CANADA

PROJECT


BLOCK 3 **REDEVELOPMENT**

1360 OGILVIE ROAD GLOUCESTER, ON K1J 9M6

OVERALL SITE PLAN

PROJECT NO: 2022-2040 DRAWN: KM APPROVED: PM As indicated DATE PRINTED: 2024-07-15 2:34:08 PM

DRAWING NO. REV

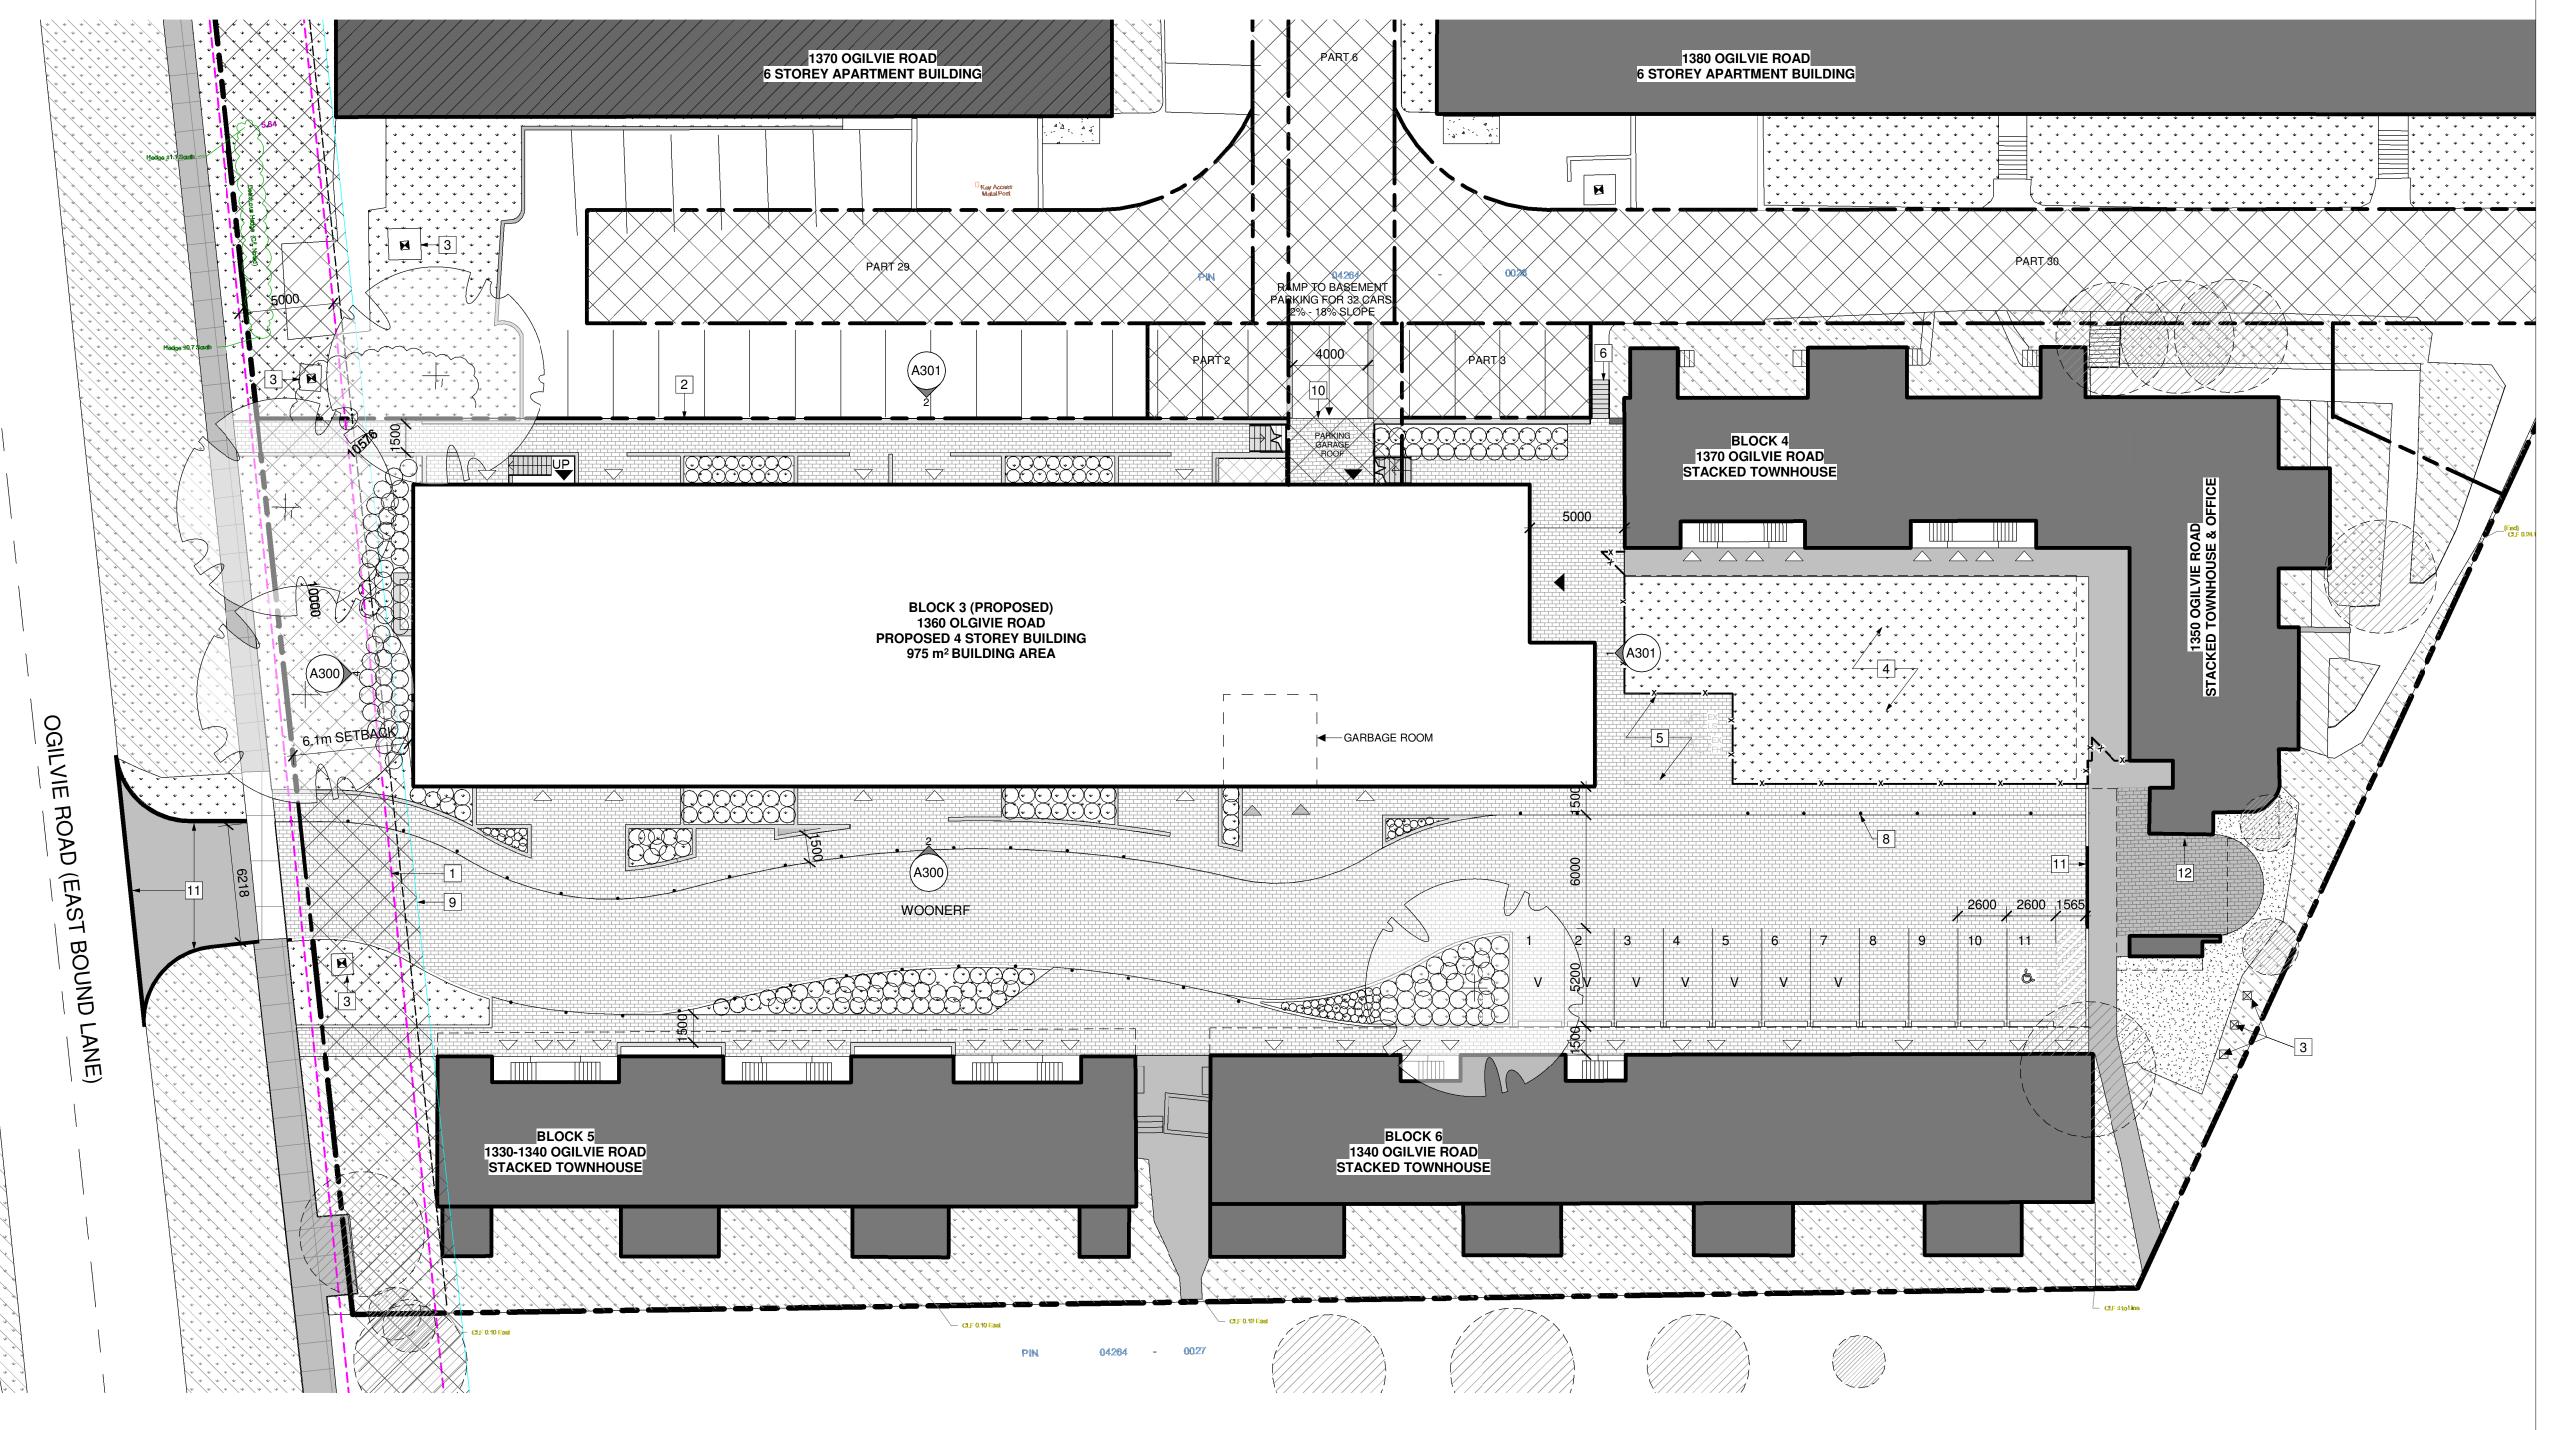

1 DDODOCED CITE DI ANI

AM10 H(40)

1 PROPOSED SITE PLAN

ZONE

		<u> </u>						·		
DEVELOPMENT INF	<u>:0</u>	ZONING INFO								
LEGAL DESCRIPTION		ZONING PROVISION	REQUIRED	PROVIDED	ZONING PROVISION	REQUIRED	<u>PROVIDED</u>	PARKING QUEING + LOADING	REQUIRED	PROVIDED
BLOCKS C, D, AND L REGISTERED PLAN 4M-172 CITY OF OTTAWA		MIN. LOT WIDTH	No minimum	47.68m	GROUND FACADE ACTIVATION	The ground floor facade facing a public	Building is located within 6.1m of the front lot line.	RESIDENTIAL SPACES	94	43
REFERENCE SURVEY	AVVA	MIN. LOT AREA	No minimum	5367m²	ACTIVATION	street of a building located within 4.5 m of	No active entrances face	VISITOR SPACES	16	7
	ATION FROM A SURVEY	MIN. FRONT YARD SETBACK	Minimum: 0m	6.1m		the front lot line must include: a minimum of	ogvio rta.	ACCESSIBLE PARKING	-	3
PREPARED BY ANNI VOLLEBEKK LTD. DA	S, O'SULLIVAN,	MIN. INTERIOR SIDE YARD SETBACK	No minimum	N/A		one active entrance from each individual		BICYCLE PARKING	39	39
MUNICIPAL ADDRESS		MIN. REAR YARD SETBACK	7.5m	N/A		occupancy located immediately adjacent		DRIVEWAY WIDTH	3m @ single traffic lane	4m for single traffic lane,
1360 OGILVIE RD, O	TTAWA, ON K1J 9M6	MAX. HEIGHT	40m	14.15m	MINUMUM OF AZING OF	to the front lot line 50% of the surface	7.7 0/.70 0 10.70/		6m @ double traffic lane	driveway to parking garage
SITE AREA	12,912m²	AMENITY AREA	468m2	552m ²	MINIMUM GLAZING OF GROUND FLOOR FACADE	area of the ground floor façade facing	7.7 m2/ 72m2 = 10.7% glazing		traffic farie	6m for double traffic lane,
BUILDING AREA	975m²	LANDSCAPED AREA	no minimum	349.5m ²		Ogilvie, from the average grade up 4.5				parking lot
GROSS FLOOR AREA	3,900m²		AMENITY BREAK			metres, must be comprised of				
BUILDING HEIGHT	14.15m , 4 STOREYS		Ground Floor Ame Balconies:	227m2		transparent glazing and active customer or				
7015	AN440 LI(40)		Playground:	242m2		resident entrance				

access doors

DWELLING UNIT TYPE	BLOCK				TOTAL			
DWELLING UNIT TYPE	3(NEW)	4	5	6	TOTAL			
1-BEDROOM	26			1	27			
2-BEDROOM	4	7	6	6	23			
3-BEDROOM	9	7	6	4	26			
4-BEDROOM				1	1	NOTES:		
5-BEDROOM				1	1	1 1. PARKING FIGURES IN TABLE REFLECT BL SITE ONLY 2. TOTAL SITE PARKING (INCLUDING BLC SI		
1-B(SENIOR)					0			
2-B(SENIOR)					0			
TOTAL	39	14	12	13	78			
		BLC		ARKING LEG		TOTAL REQUIRED	TOTAL PARKING	
DWELLING UNIT TYPE		BLO	OCK		TOTAL	TOTAL REQUIRED	TOTAL PARKING	
51122	3(NEW)	4	5	6		PARKING	PROVIDED	
APARTMENT (1.2)	39				39	47		
STACKED (1.2)	0	14	12	13	39	47	36	
VISITOR PARKING (0.2)						16	7	
<u>.</u>						109	total: 43	
					'			
			Al	MENITY LEG	SEND			
	BLOCK				TOTAL	TOTAL REQUIRED	TOTAL AMENITY SPACE	
	3(NEW)	4	5	6	TOTAL	AMENITY SPACE (m2)	PROVIDED (m2)	

ACCOMODATIONS LEGEND

39 14 12

DWELLING UNITS

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5 SNOW STORAGE6 NEW LANDSCAPE STAIR

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9 EASEMENT

10 PARKING GARAGE SIGNAL

11 DEPRESSED CURB

EXISTING (NONCOMPLIANT) BIKE RACKS TO REMAIN.
EXISTING RACKS NOT INCLUDED IN NEW BIKE PARKING

13 NEW HYDRO TRANSFORMER ON CONCRETE PAD

SITE PLAN LEGEND:

AREA NOT IN SCOPE
EXISTING BUILDING (NOT SCOPE)
EXTENT OF EASEMENT
ASPHALT PAVING - NEW

ASPHALT PAVING - EXISTING

CONCRETE SIDEWALK - NEW

CONCRETE SIDEWALK - EXISTING

GRASS - NEW

GRASS - EXISTING

PAVER TYPE 1 - NEW

CONCRETE PAD

▲ EMERGENCY EXIT△ SERVICE DOORS

△ BUILDING MAIN ENTRANCE

PROPERTY LINE

-x——x— FENCE PER LANDSCAPE

-wtr-wtr- NEW DOMESTIC WATER

-san--san- NEW SANITARY

—st——st— NEW STORM

—H——H— NEW ELECTRICAL SERVICE (BELOW GRADE)

—H——H— GAS

CATCH BASIN

CATCH BASIN EXISTING

LIGHT STANDARD

• LIGHT STANDARD EXISTING

- FIRE HYDRANT

- FIRE HYDRANT EXISTING

• UTILITY POLE

SIAMESE CONNECTION

UTILITY POLE EXISTING

— DROPPED CURB

CSV ARCHITECTS

190 O'Connor Street, Suite 100

sustainable design · conception écologique

613.564.8118

cunliffe@cunliffe.ca

email@chorley.com

address phone

email

STRUCTURAL ENGINEER
Cunliffe & Associates
200, 1550 Carling Avenue
Ottawa, Ontario K1Z 8S8
613-729-7242

MECHANICAL AND ELECTRICAL ENGINEER Chorley + Bisset Consulting Engineers 250 City Centre Avenue Ottawa, Ontario K1R 6K7 613-241-0030

LANDSCAPE ARCHITECT
James B. Lennox & Associates
3332 Carling Avenue
Ottawa, Ontario K2H 5A8
613-722-5168

CIVIL ENGINEER
name
address

CIVIL ENGINEERS
McIntosh Perry
115 Walgreen Road
Carp, Ontario
613-836-2184
info@mcintoshperry.com

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CLIENT

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OTTAWA ONTARIO, CANADA

BLOCK 3 REDEVELOPMENT

1360 OGILVIE ROAD GLOUCESTER, ON K1J 9M6


TITLE

PROPOSED SITE PLAN

PROJECT NO: 2022-2040
DRAWN: KM
APPROVED: PM
SCALE: 1:200

REV

SCALE: 1 : 200
DATE PRINTED: 2024-07-15 2:34:10 PM

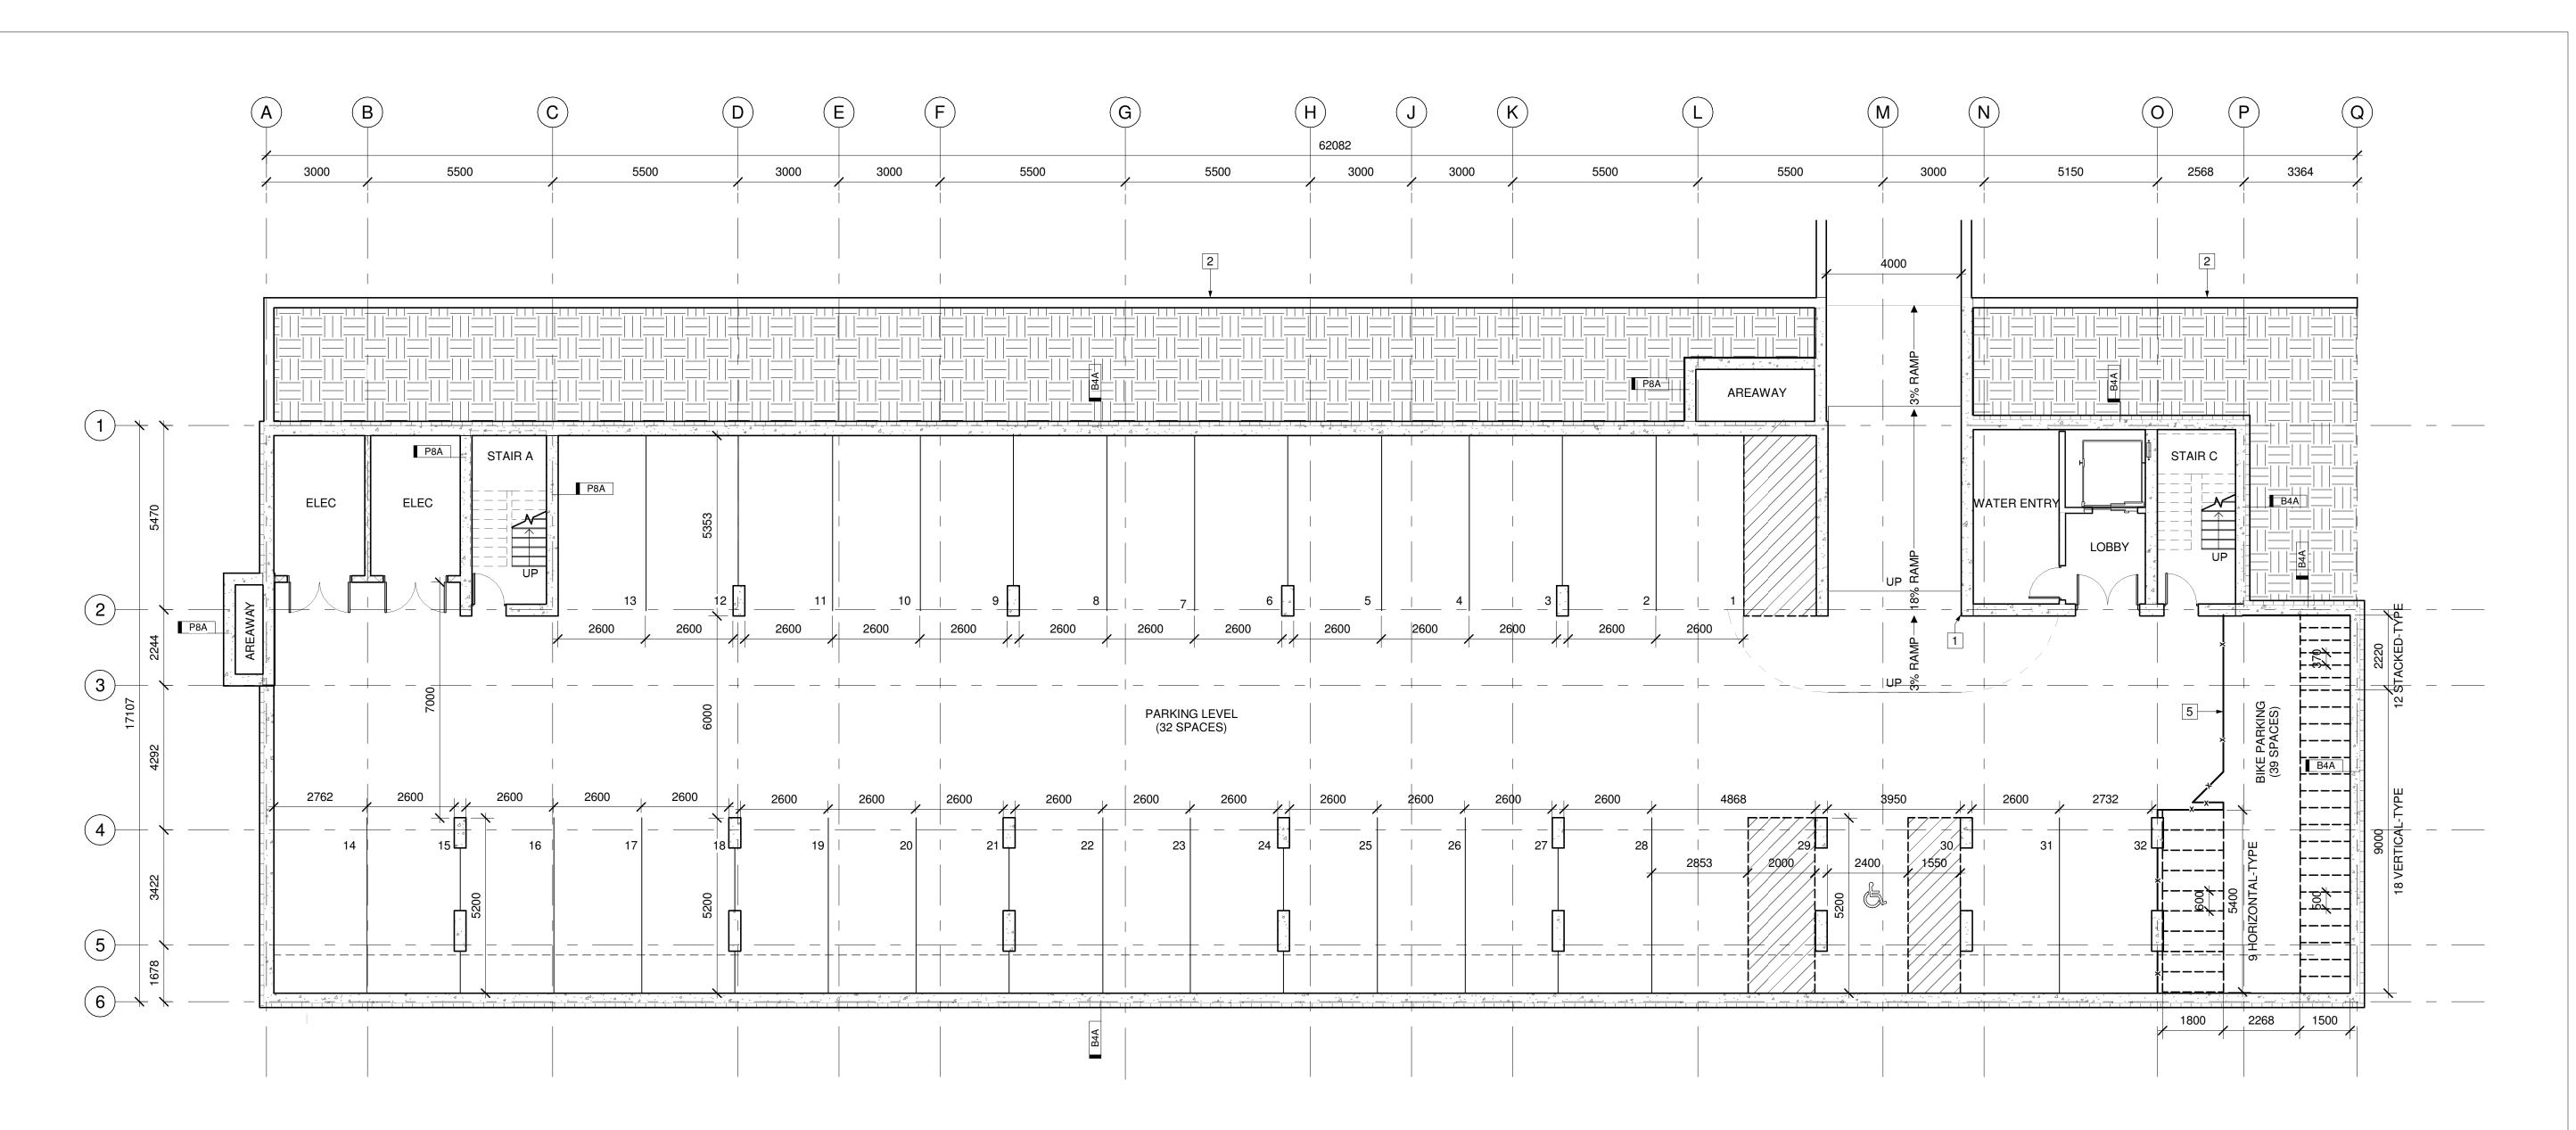

1 UNDERGROUND PARKING LEVEL

GENERAL REFERENCE PLAN NOTES:

- 1. ALL DIMENSIONS ARE TO FACE OF FRAMING UNLESS OTHERWISE NOTED.
- 2. ALL DOOR DIMENSIONS ARE TO THE CENTRE OR INSIDE OF FRAME.

UNDERGROUND PARKING PLAN KEYNOTES:

- 1 PARKING GARAGE SIGNAL
- 3 NOT IN USE

- 4 PIPE SLEEVE
- SECURE FENCE TO FLOOR SLAB AND TO U/S SLAB ABOVE

- 5 SECURE BIKE STORAGE. CHAINLINK FENCE W/ ACCESS DOOR.

3. ALL WINDOW DIMENSIONS ARE TO THE CENTER OR OUTSIDE OF FRAME.

- 2 RETAINING WALL PER STRUCTURAL DOCUMENTS

LEGEND:

NOT IN CONTRACT

NEW CONSTRUCTION 45 MIN. FIRE RESISTANCE RATING

60 MIN. FIRE RESISTANCE RATING 90 MIN. FIRE RESISTANCE RATING

SHEAR WALL PER STRUCTURAL LOAD-BEARING WALL PER STRUCTURAL

DOOR DOOR OPERATOR

CSV ARCHITECTS

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STRUCTURAL ENGINEER

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MECHANICAL AND ELECTRICAL **ENGINEER** Chorley + Bisset Consulting Engineers 250 City Centre Avenue Ottawa, Ontario K1R 6K7 613-241-0030 email@chorley.com

LANDSCAPE ARCHITECT James B. Lennox & Associates 3332 Carling Avenue Ottawa, Ontario K2H 5A8 613-722-5168

CIVIL ENGINEER address address

phone email

CIVIL ENGINEERS McIntosh Perry 115 Walgreen Road Carp, Ontario 613-836-2184 info@mcintoshperry.com

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CLIENT

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ONTARIO, CANADA

PROJECT


BLOCK 3 REDEVELOPMENT

1360 OGILVIE ROAD GLOUCESTER, ON K1J 9M6

UNDERGROUND PARKING PLAN

PROJECT NO: 2022-2040 DRAWN: DF APPROVED: PM 1:100

DATE PRINTED: 2024-07-15 2:34:13 PM REV DRAWING NO.

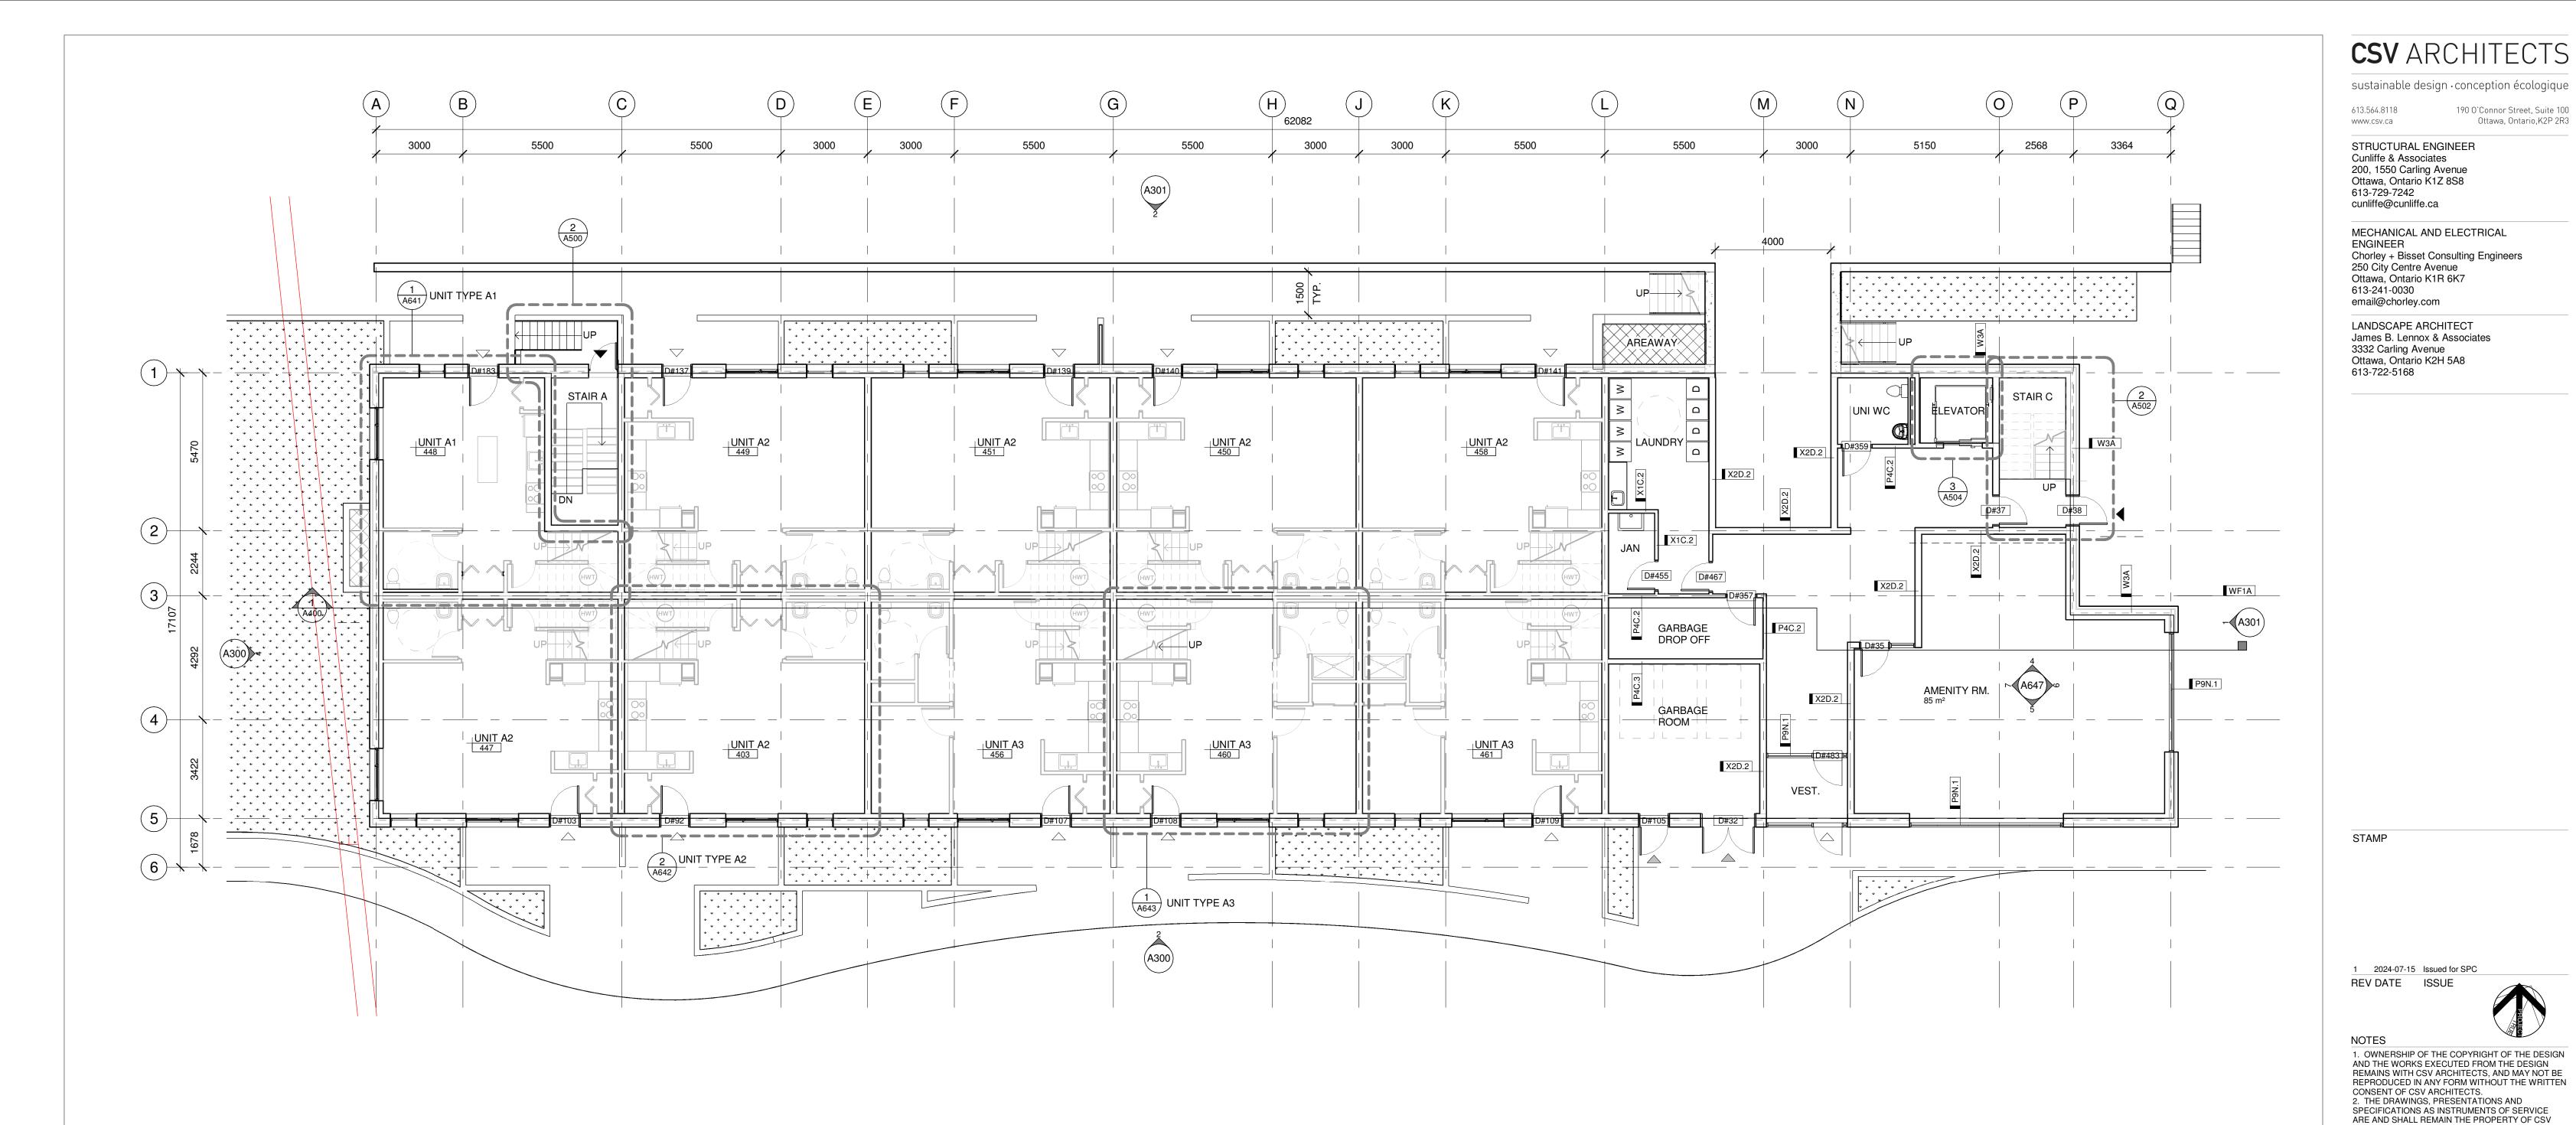

1 GROUND FLOOR KEY PLAN

GENERAL REFERENCE PLAN NOTES:

- 1. ALL DIMENSIONS ARE TO FACE OF FRAMING UNLESS OTHERWISE NOTED.
- 2. ALL DOOR DIMENSIONS ARE TO THE CENTRE OR INSIDE OF FRAME. 3. ALL WINDOW DIMENSIONS ARE TO THE CENTER OR OUTSIDE OF FRAME.

REFERENCE PLAN KEYNOTES:

- 1 MAILBOXES
- 2 GARBAGE BINS
- 3 CANOPY ABOVE
- 4 FIRE DEPARTMENT CONNECTION
- 5 FIRE ALARM CONTROL PANEL

NOT IN CONTRACT NEW CONSTRUCTION

45 MIN. FIRE RESISTANCE RATING 60 MIN. FIRE RESISTANCE RATING 90 MIN. FIRE RESISTANCE RATING

SHEAR WALL PER STRUCTURAL LOAD-BEARING WALL PER STRUCTURAL

LEGEND:

DOOR OPERATOR

PROJECT NO: 2022-2040 DRAWN: KM, DF APPROVED: PM 1:100 DATE PRINTED: 2024-07-15 2:34:16 PM

CO-OPERATIVE

DRAWING NO.

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CONSENT OF CSV ARCHITECTS.

SPECIFICATIONS.


ONTARIO, CANADA

PROJECT

OTTAWA

BLOCK 3 REDEVELOPMENT

1360 OGILVIE ROAD GLOUCESTER, ON K1J 9M6 **GROUND FLOOR PLAN**

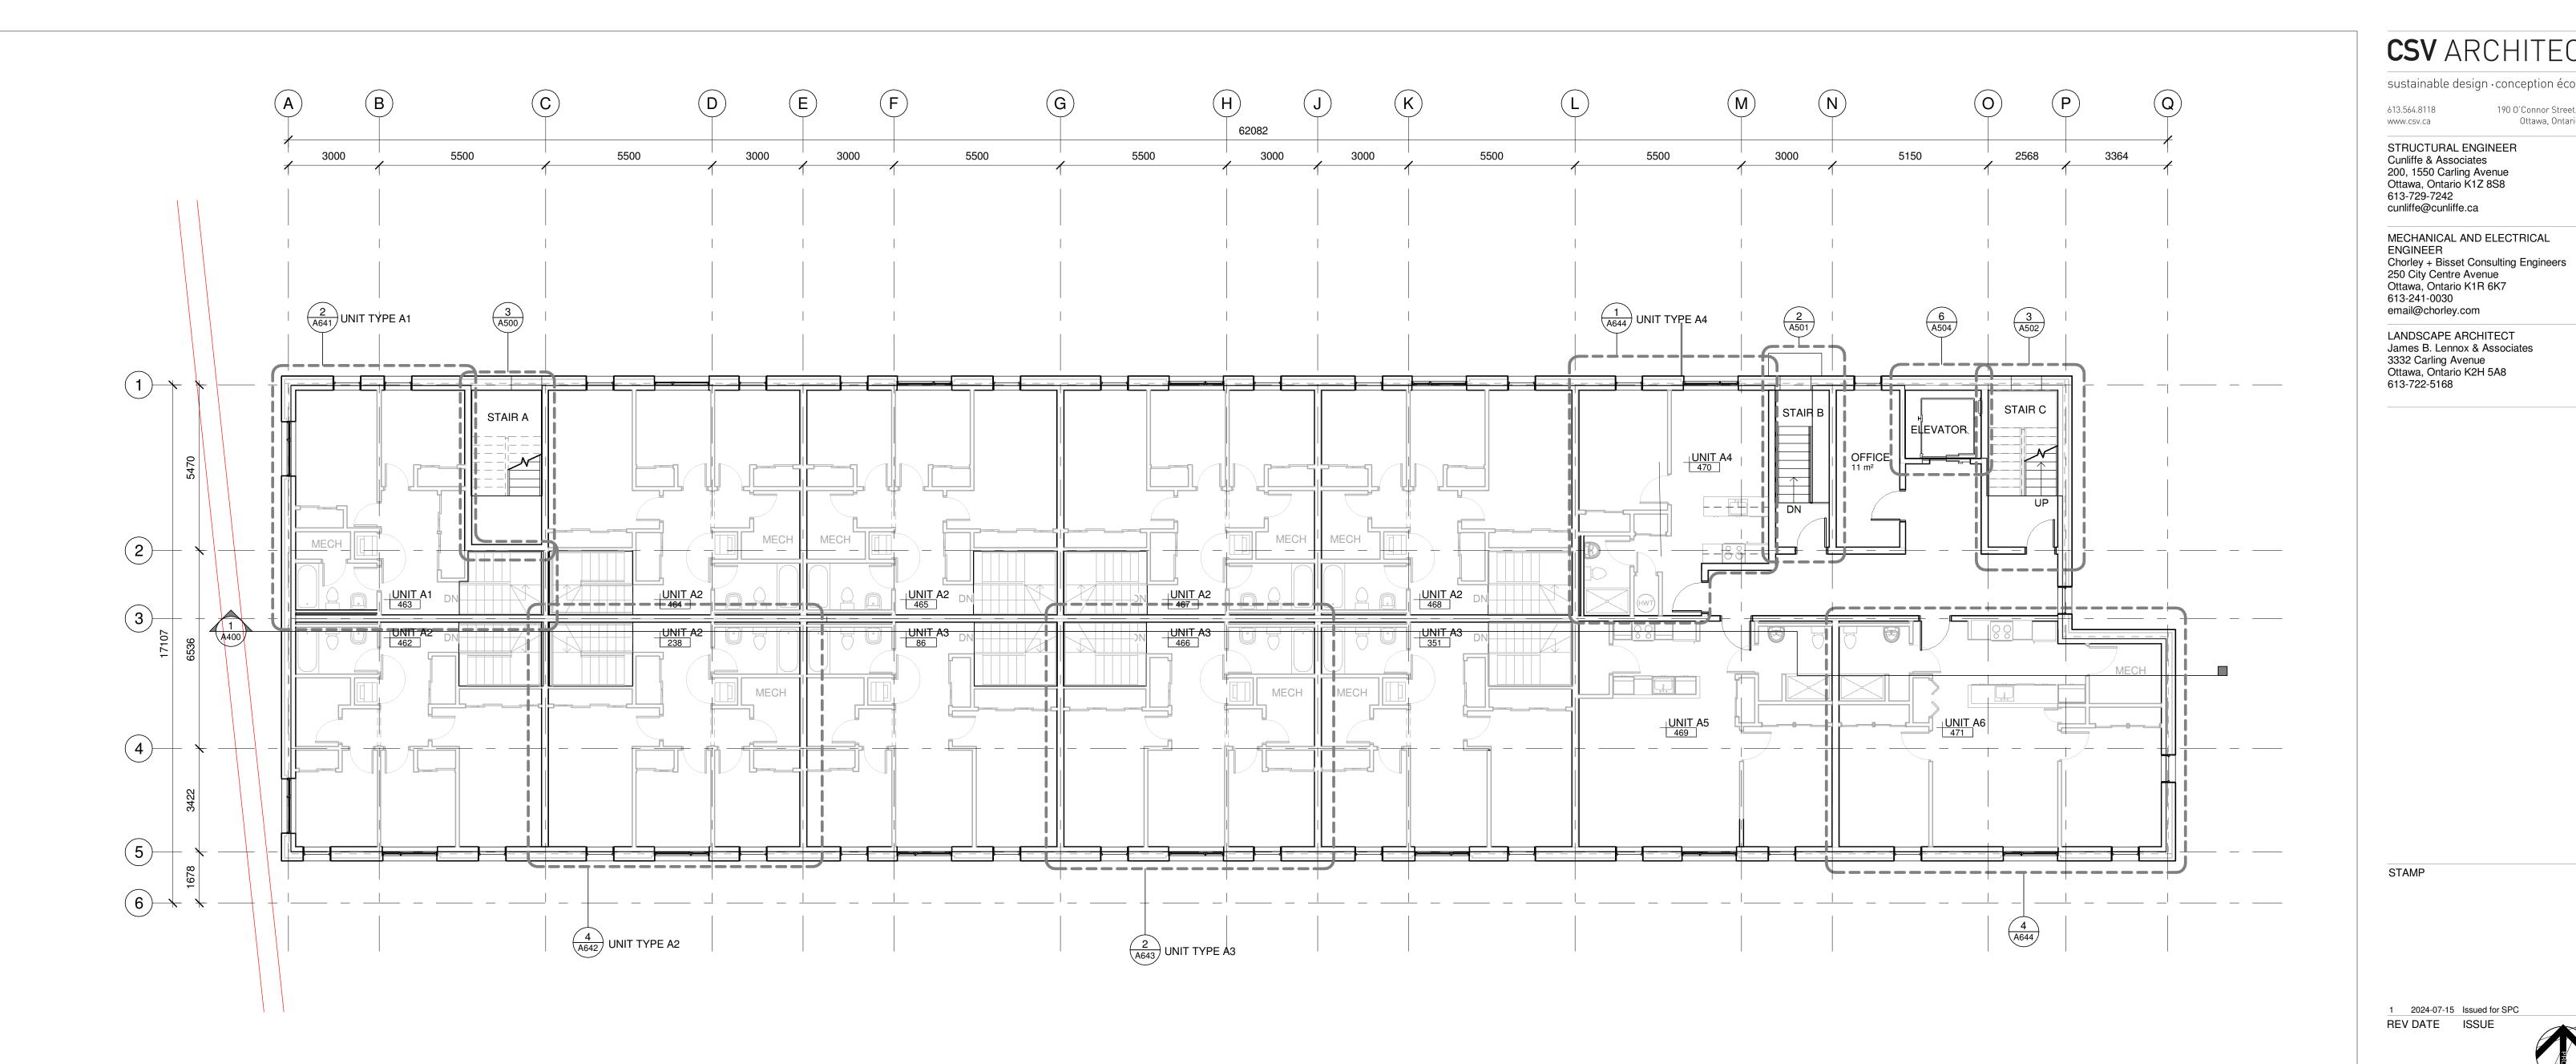

1 SECOND FLOOR KEY PLAN
A203 1:100

GENERAL REFERENCE PLAN NOTES:

- 1. ALL DIMENSIONS ARE TO FACE OF FRAMING UNLESS OTHERWISE NOTED.
- 2. ALL DOOR DIMENSIONS ARE TO THE CENTRE OR INSIDE OF FRAME. 3. ALL WINDOW DIMENSIONS ARE TO THE CENTER OR OUTSIDE OF FRAME.

REFERENCE PLAN KEYNOTES:

- 1 MAILBOXES
- 2 GARBAGE BINS
- 3 CANOPY ABOVE
- 4 FIRE DEPARTMENT CONNECTION
- 5 FIRE ALARM CONTROL PANEL

LEGEND:

NOT IN CONTRACT

45 MIN. FIRE RESISTANCE RATING 60 MIN. FIRE RESISTANCE RATING 90 MIN. FIRE RESISTANCE RATING

SHEAR WALL PER STRUCTURAL LOAD-BEARING WALL PER STRUCTURAL

NEW CONSTRUCTION

DOOR

DOOR OPERATOR

SECOND FLOOR PLAN

REDEVELOPMENT

GLOUCESTER, ON K1J 9M6

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BETTER LIVING

CO-OPERATIVE

ONTARIO, CANADA

1360 OGILVIE ROAD

SPECIFICATIONS.

CLIENT

OTTAWA


PROJECT

BLOCK 3

PROJECT NO: 2022-2040 DRAWN: KM, DF APPROVED: PM 1:100 DATE PRINTED: 2024-07-15 2:34:19 PM

DRAWING NO.

CSV ARCHITECTS sustainable design · conception écologique 613.564.8118 190 O'Connor Street, Suite 100 Ottawa, Ontario,K2P 2R3 STRUCTURAL ENGINEER

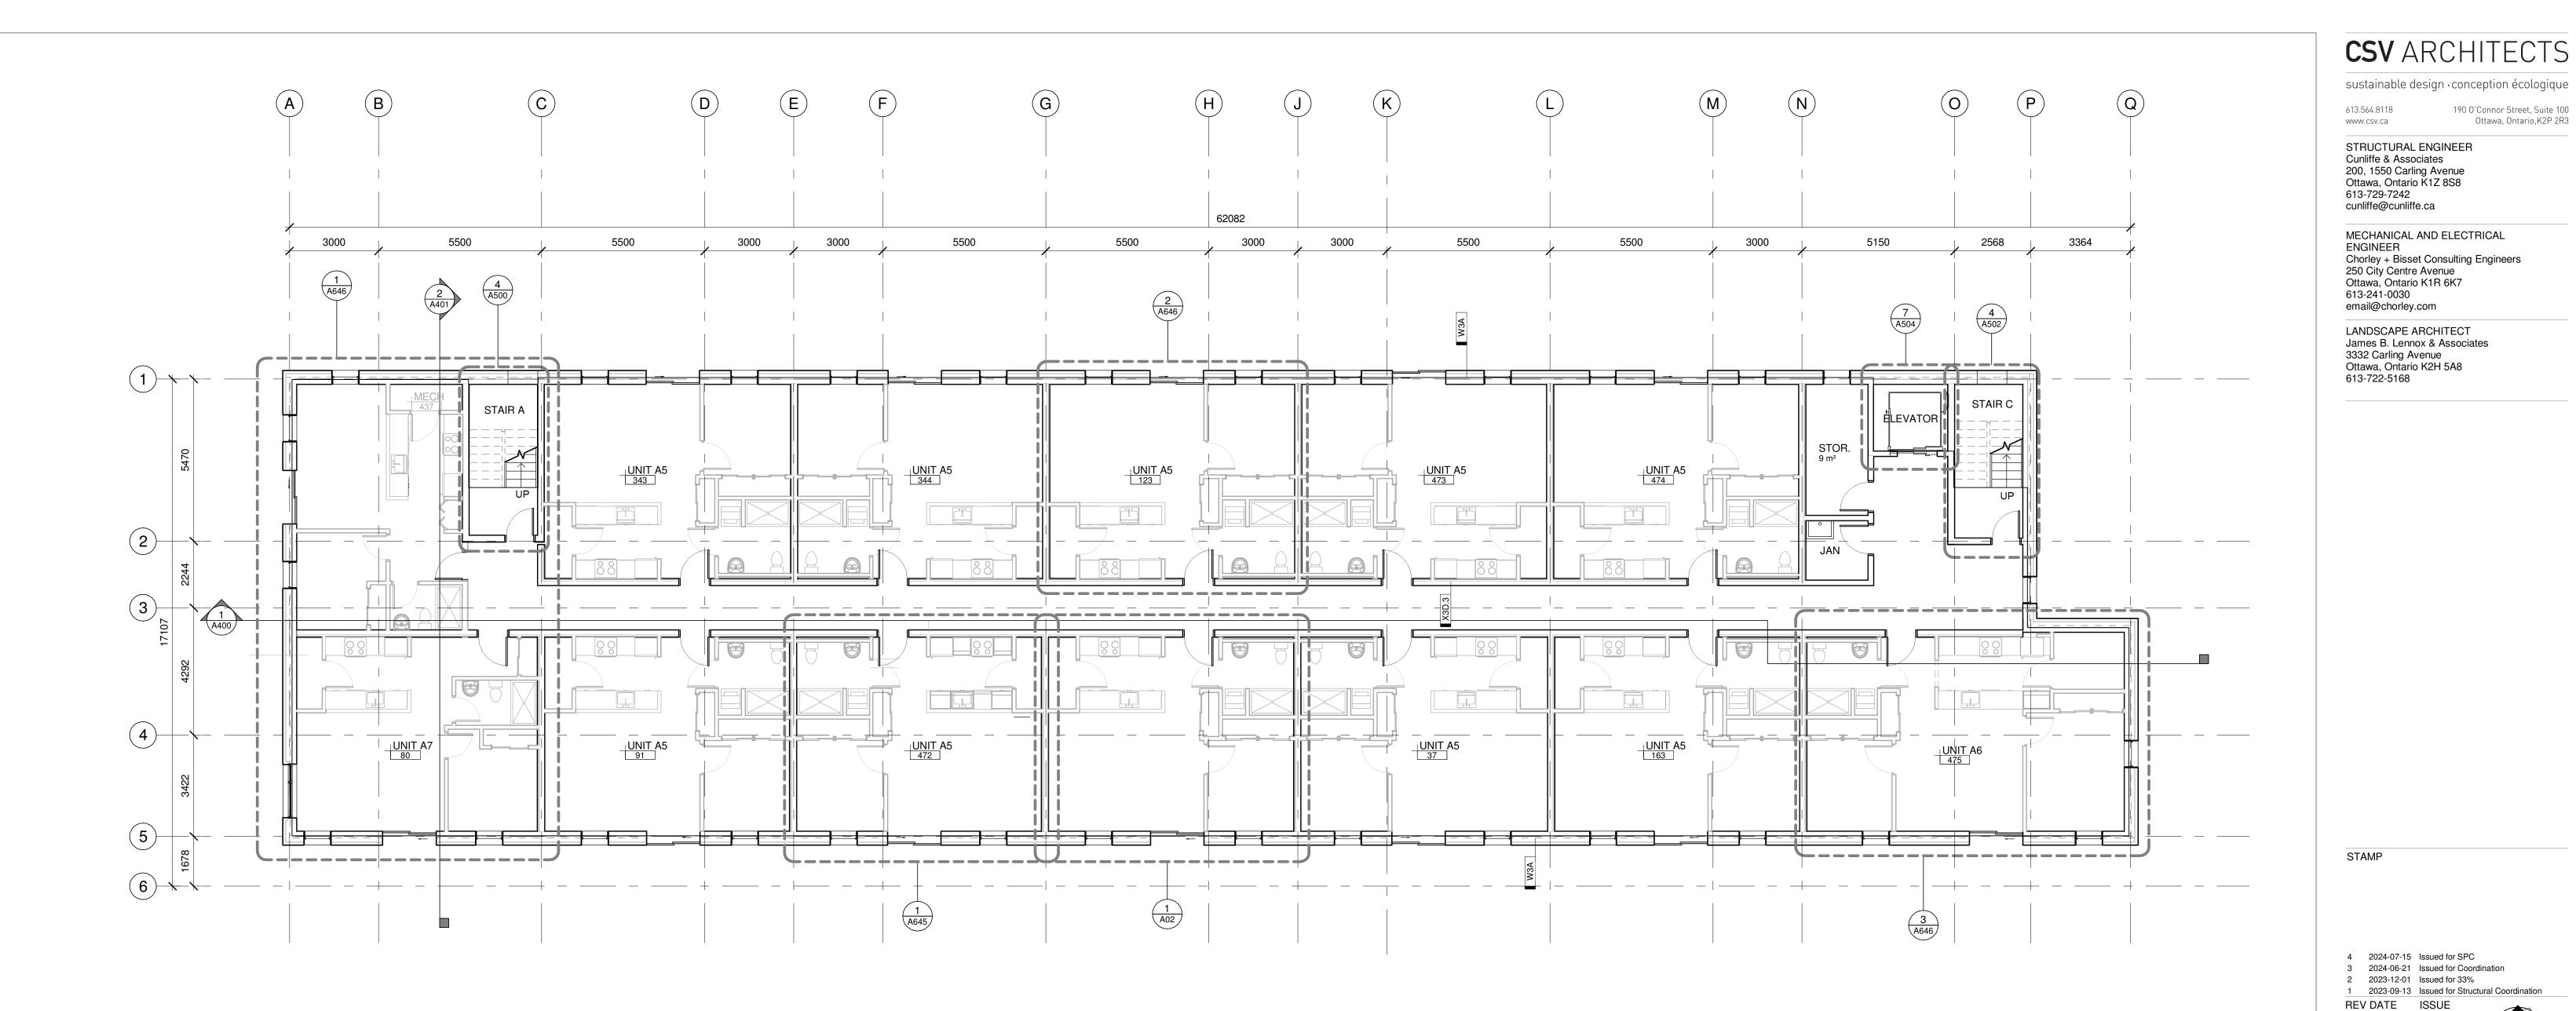

1 THIRD FLOOR KEY PLAN

GENERAL REFERENCE PLAN NOTES:

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REFERENCE PLAN KEYNOTES:

- 1 MAILBOXES
- 2 GARBAGE BINS
- 3 CANOPY ABOVE
- 4 FIRE DEPARTMENT CONNECTION
- 5 FIRE ALARM CONTROL PANEL

LEGEND:

NOT IN CONTRACT

NEW CONSTRUCTION 45 MIN. FIRE RESISTANCE RATING

60 MIN. FIRE RESISTANCE RATING 90 MIN. FIRE RESISTANCE RATING

> SHEAR WALL PER STRUCTURAL LOAD-BEARING WALL PER STRUCTURAL

DOOR OPERATOR

PROJECT NO: 2022-2040 DRAWN: KM, DF APPROVED: PM 1:100 DATE PRINTED: 2024-07-15 2:34:22 PM

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CONSENT OF CSV ARCHITECTS.

BETTER LIVING

CO-OPERATIVE

REDEVELOPMENT

GLOUCESTER, ON K1J 9M6

THIRD AND FOURTH

FLOOR PLAN (TYP.)

ONTARIO, CANADA

1360 OGILVIE ROAD

SPECIFICATIONS.

CLIENT

OTTAWA


PROJECT

BLOCK 3

REV

DRAWING NO.

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CIVIL ENGINEER name address address phone
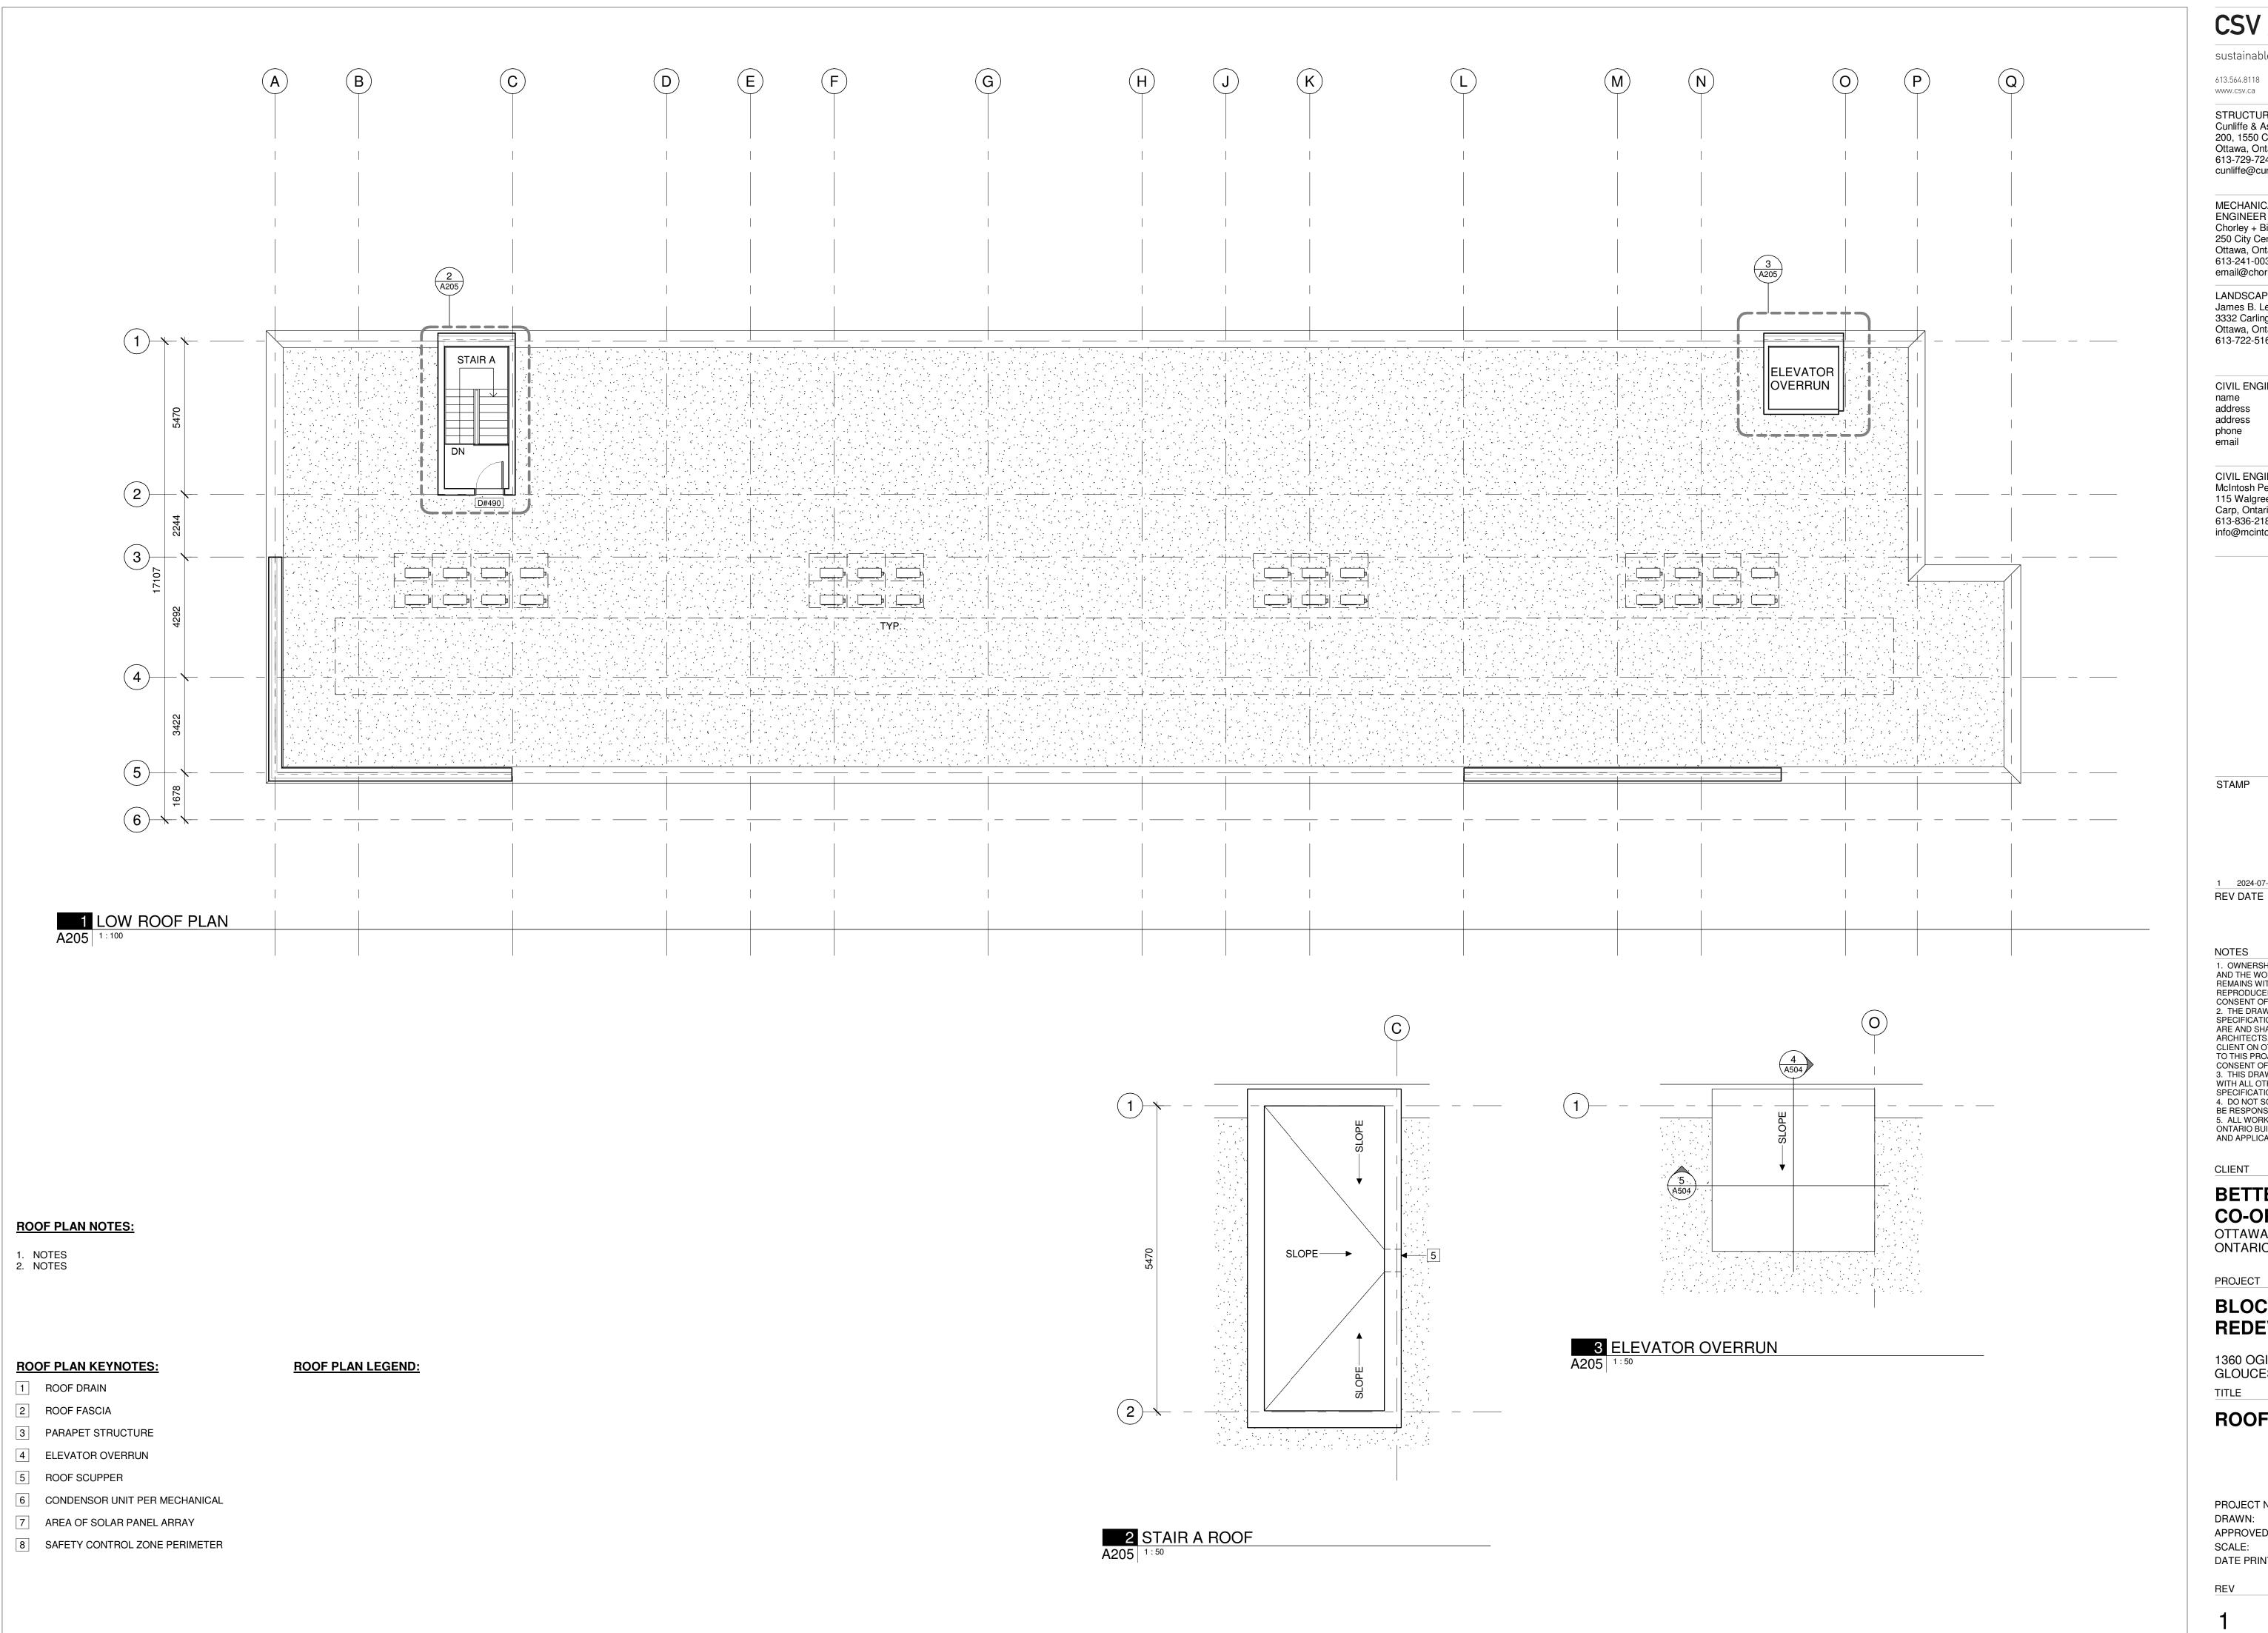
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BETTER LIVING CO-OPERATIVE

OTTAWA ONTARIO, CANADA

PROJECT

BLOCK 3 REDEVELOPMENT

1360 OGILVIE ROAD GLOUCESTER, ON K1J 9M6

ROOF PLAN


PROJECT NO: 2022-2040 DRAWN: DF, JW APPROVED: PM

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2 WEST ELEVATION



ELEVATION NOTES:

CONTRACTOR TO COORDINATE WITH MANUFACTURER'S SPECIFICATIONS AND INSTALLATIONS GUIDELINES FOR ALL MATERIAL SEALING, TRANSITIONS, SEPARATIONS, FLASHING DETAILS, CONNECTIONS, ANCHORAGES, ETC. CONTRACTOR TO PROVIDE DETAIL DRAWINGS OR MOCK-UP FOR ARCHITECT'S REVIEW AND APPROVAL FOR ALL SPECIAL CONDITIONS NOT SHOWN IN THE CONTRACT DOCUMENTS.

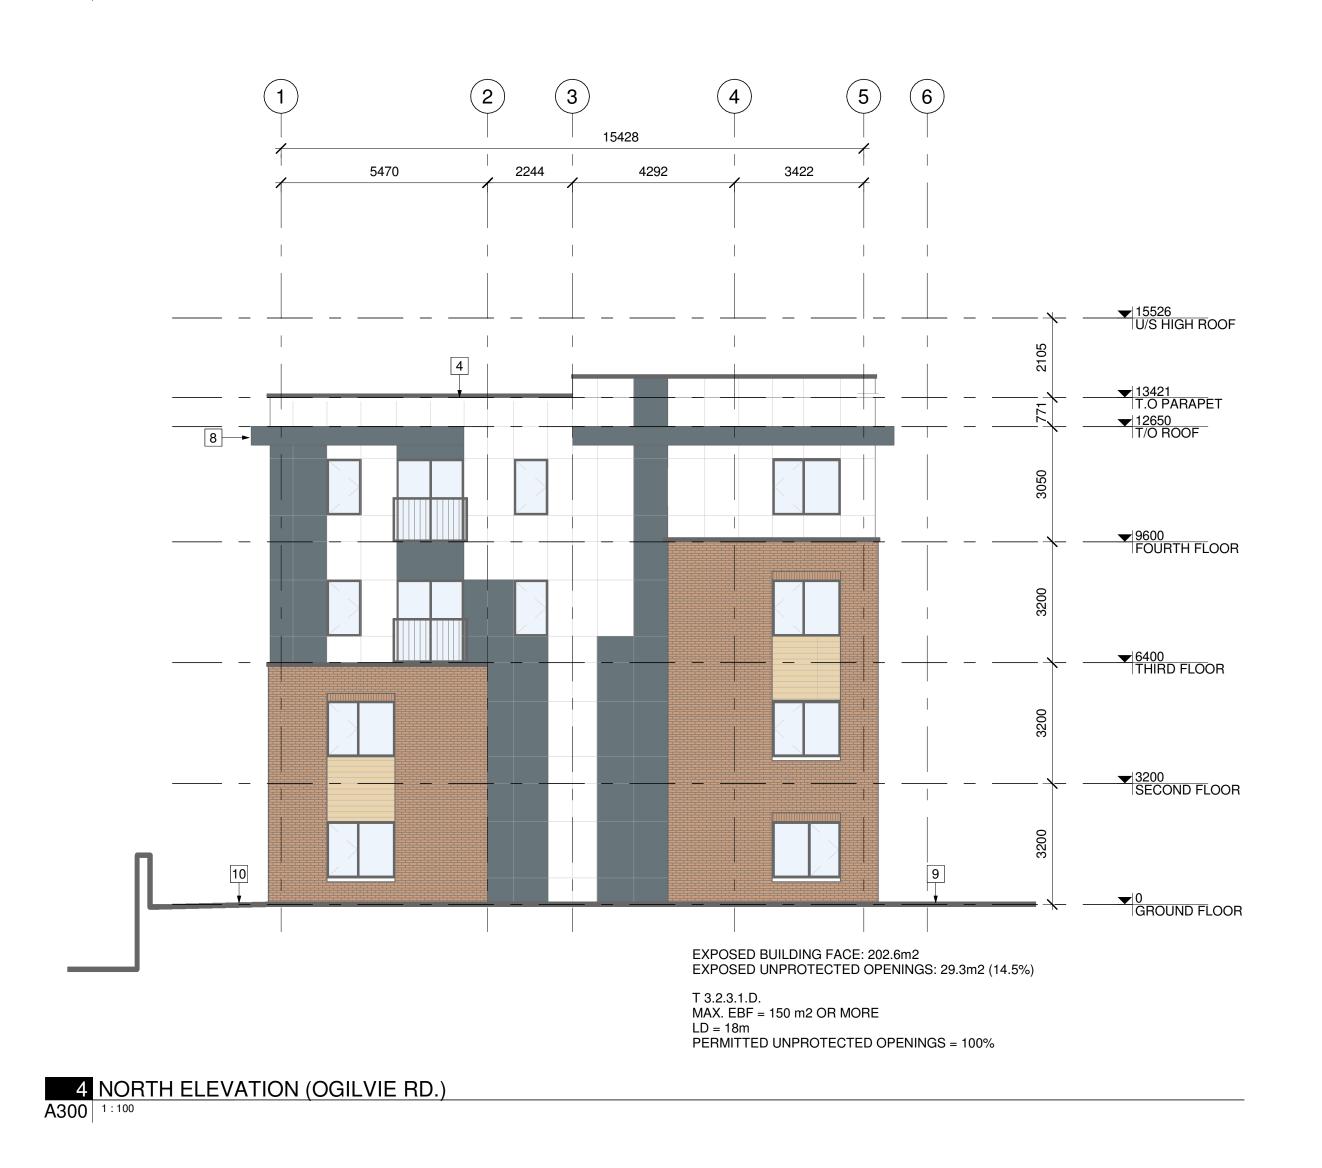ELEVATION KEYNOTES:

- 1 CURTAIN WALL
- 2 CANOPY
- 3 JULIETTE BALCONY
- 4 PREFINISHED METAL FLASHING
- 5 CONCRETE UPSTAND
- 6 ELEVATOR OVERRUN & ROOFTOP ACCESS
- 7 GARAGE DOOR
- 8 ROOF FASCIA
- 9 FINISHED GRADE
- 10 CEMENT PAVEMENT

ELEVATION LEGEND:

HATCH SYMBOL DESCRIPTION

HATCH PATTERNS SHOWN ARE FOR GRAPHIC PURPOSES ONLY AND SHOULD BE COORDINATED WITH ACTUAL SPECIFIED MATERIALS.

BRICK VENEER MANUFACTURER: COLOUR:
ALUMINUM COMPOSITE PANEL MANUFACTURER: COLOUR:
ALUMINUM COMPOSITE PANEL MANUFACTURER: COLOUR:
WOOD SIDING MANUFACTURER: COLOUR:
FASCIA MANUFACTURER: COLOUR:

CSV ARCHITECTS

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613.564.8118 190 O'Connor Street, Suite 100 Ottawa, Ontario,K2P 2R3 www.csv.ca

STRUCTURAL ENGINEER Cunliffe & Associates 200, 1550 Carling Avenue Ottawa, Ontario K1Z 8S8 613-729-7242 cunliffe@cunliffe.ca

MECHANICAL AND ELECTRICAL **ENGINEER** Chorley + Bisset Consulting Engineers 250 City Centre Avenue Ottawa, Ontario K1R 6K7 613-241-0030

email@chorley.com

LANDSCAPE ARCHITECT James B. Lennox & Associates 3332 Carling Avenue Ottawa, Ontario K2H 5A8 613-722-5168

CIVIL ENGINEER address address phone

email

CIVIL ENGINEERS McIntosh Perry 115 Walgreen Road Carp, Ontario 613-836-2184 info@mcintoshperry.com

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PROJECT

BLOCK 3 REDEVELOPMENT

1360 OGILVIE ROAD GLOUCESTER, ON K1J 9M6

EXTERIOR ELEVATIONS

PROJECT NO: 2022-2040 DRAWN: DF APPROVED: PM As indicated

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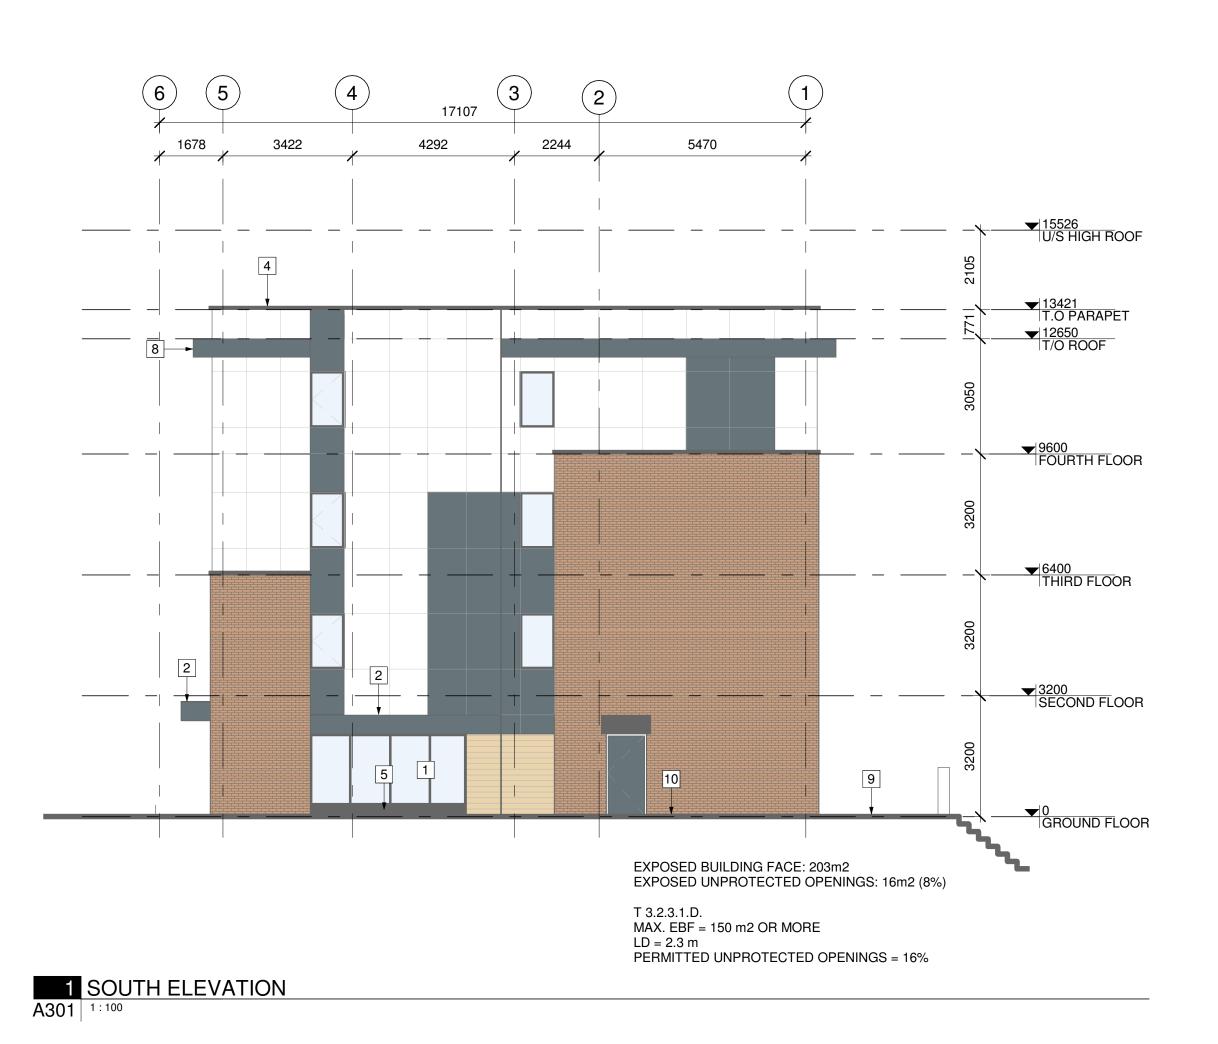
A300

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2 EAST ELEVATION



ELEVATION NOTES:

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613.564.8118 190 O'Connor Street, Suite 100 www.csv.ca Ottawa, Ontario,K2P 2R3

STRUCTURAL ENGINEER
Cunliffe & Associates
200, 1550 Carling Avenue
Ottawa, Ontario K1Z 8S8
613-729-7242

cunliffe@cunliffe.ca

MECHANICAL AND ELECTRICAL
ENGINEER
Chorley + Bisset Consulting Engineers
250 City Centre Avenue
Ottawa, Ontario K1R 6K7

email@chorley.com

LANDSCAPE ARCHITECT

James B. Lennox & Associates

3332 Carling Avenue

Ottawa, Ontario K2H 5A8

613-722-5168

CIVIL ENGINEER name address address phone

email

613-241-0030

CIVIL ENGINEERS
McIntosh Perry
115 Walgreen Road
Carp, Ontario
613-836-2184
info@mcintoshperry.com

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