

	Igreen Rd. Carp, ON KOA 1L0 513-836-2184 Fax: 613-836-3742 www.McIntoshPerry.com	
	Stamp: Stamp:	
	VERNESS HOMES AURIGA DRIVE, SUITE 200 OTTAWA, ON K2E8A5	
Project:		
	D USE DEVELOPMENT	
Drawing Title:		
SITE GRAD	ING AND DRAINAGE PLAN	)167
Scale: 1:250	Project Number:	0-
Drawn By: R.R.R.	CP-19-0608	07-12-20-01
Checked By: A.J.G.	Drawing Number:	7-1
Designed By: R.R.R.	C101	<u>0</u>
	#18309	-

	R	OOF DRAIN	I (B2A)				
ONTROL D	EVICE	WATTS DRAIN	AGE RD-100	-A-ADJ (FUL	LY EXPOSED)		
F ROOF D	RAINS		1				
		2-YEAR	5-YE	EAR	100-YR		
OFTOP STC AVAILABL	-	2.95	2.9	95	2.95		
"H OF FLO	W (m)	0.015	0.0	20	0.040		
DOF DRAI	N (L/s)	0.19	0.2	25	0.50		
TOTAL	FLOW	0.19	0.2	25	0.50		
	R	OOF DRAIN	I (B2B)				
ONTROL D	EVICE	WATTS DRAIN	AGE RD-100	-A-ADJ (FUL	LY EXPOSED)	_	
F ROOF D	RAINS		1				
		2-YEAR	5-YE	EAR	100-YR		
OFTOP STC AVAILABL	E (m³)	15.79	15.	79	15.79		
"H OF FLO	W (m)	0.025	0.0	35	0.060		
DOF DRAII	N (L/s)	0.32	0.4	14	0.76		
TOTAL	FLOW	0.32	0.4	14	0.76		
	R	OOF DRAIN	I (B2C)				
ONTROL DEVICE WATTS DRAINAGE RD-100-A-ADJ (FULLY EXPOSED)							
F ROOF D	RAINS						
		2-YEAR	5-YE	EAR	100-YR		
OFTOP STC AVAILABL		10.78	10.	78	10.78		
H OF FLO	W (m)	0.025	0.0	35	0.060		
DOF DRAIN (L/s)		0.32	0.4	0.44 0.76			
TOTAL	FLOW	0.32	0.4	14	0.76		
		ICD TAB	LE				
		2-YEAR	2-YEAR	5-YEAR	5-YEAR	100-YEAR	100-YEAR

R	OOF DRAIN (	B2A)	
ROL DEVICE	WATTS DRAINAG	GE RD-100-A-ADJ (FI	JLLY EXPOSED)
OOF DRAINS		1	
	2-YEAR	5-YEAR	100-YR
OP STORAGE AILABLE (m <sup>3</sup> )	2.95	2.95	2.95
OF FLOW (m)	0.015	0.020	0.040
DRAIN (L/s)	0.19	0.25	0.50
OTAL FLOW	0.19	0.25	0.50
R	OOF DRAIN (	B2B)	
ROL DEVICE	WATTS DRAINAG	GE RD-100-A-ADJ (FI	JLLY EXPOSED)
OOF DRAINS		1	
	2-YEAR	5-YEAR	100-YR
OP STORAGE AILABLE (m³)	15.79	15.79	15.79
)F FLOW (m)	0.025	0.035	0.060
DRAIN (L/s)	0.32	0.44	0.76
OTAL FLOW	0.32	0.44	0.76
R	OOF DRAIN (	B2C)	
ROL DEVICE	WATTS DRAINAG	GE RD-100-A-ADJ (F	JLLY EXPOSED)
OOF DRAINS		1	
	2-YEAR	1 5-YEAR	100-YR
DP STORAGE AILABLE (m <sup>3</sup> )	2-YEAR 10.78	-	100-YR 10.78
DP STORAGE		5-YEAR	
DP STORAGE AILABLE (m <sup>3</sup> )	10.78	5-YEAR 10.78	10.78

AREA ID DESIGN DESIGN DESIGN DESIGN DESIGN DESIGN

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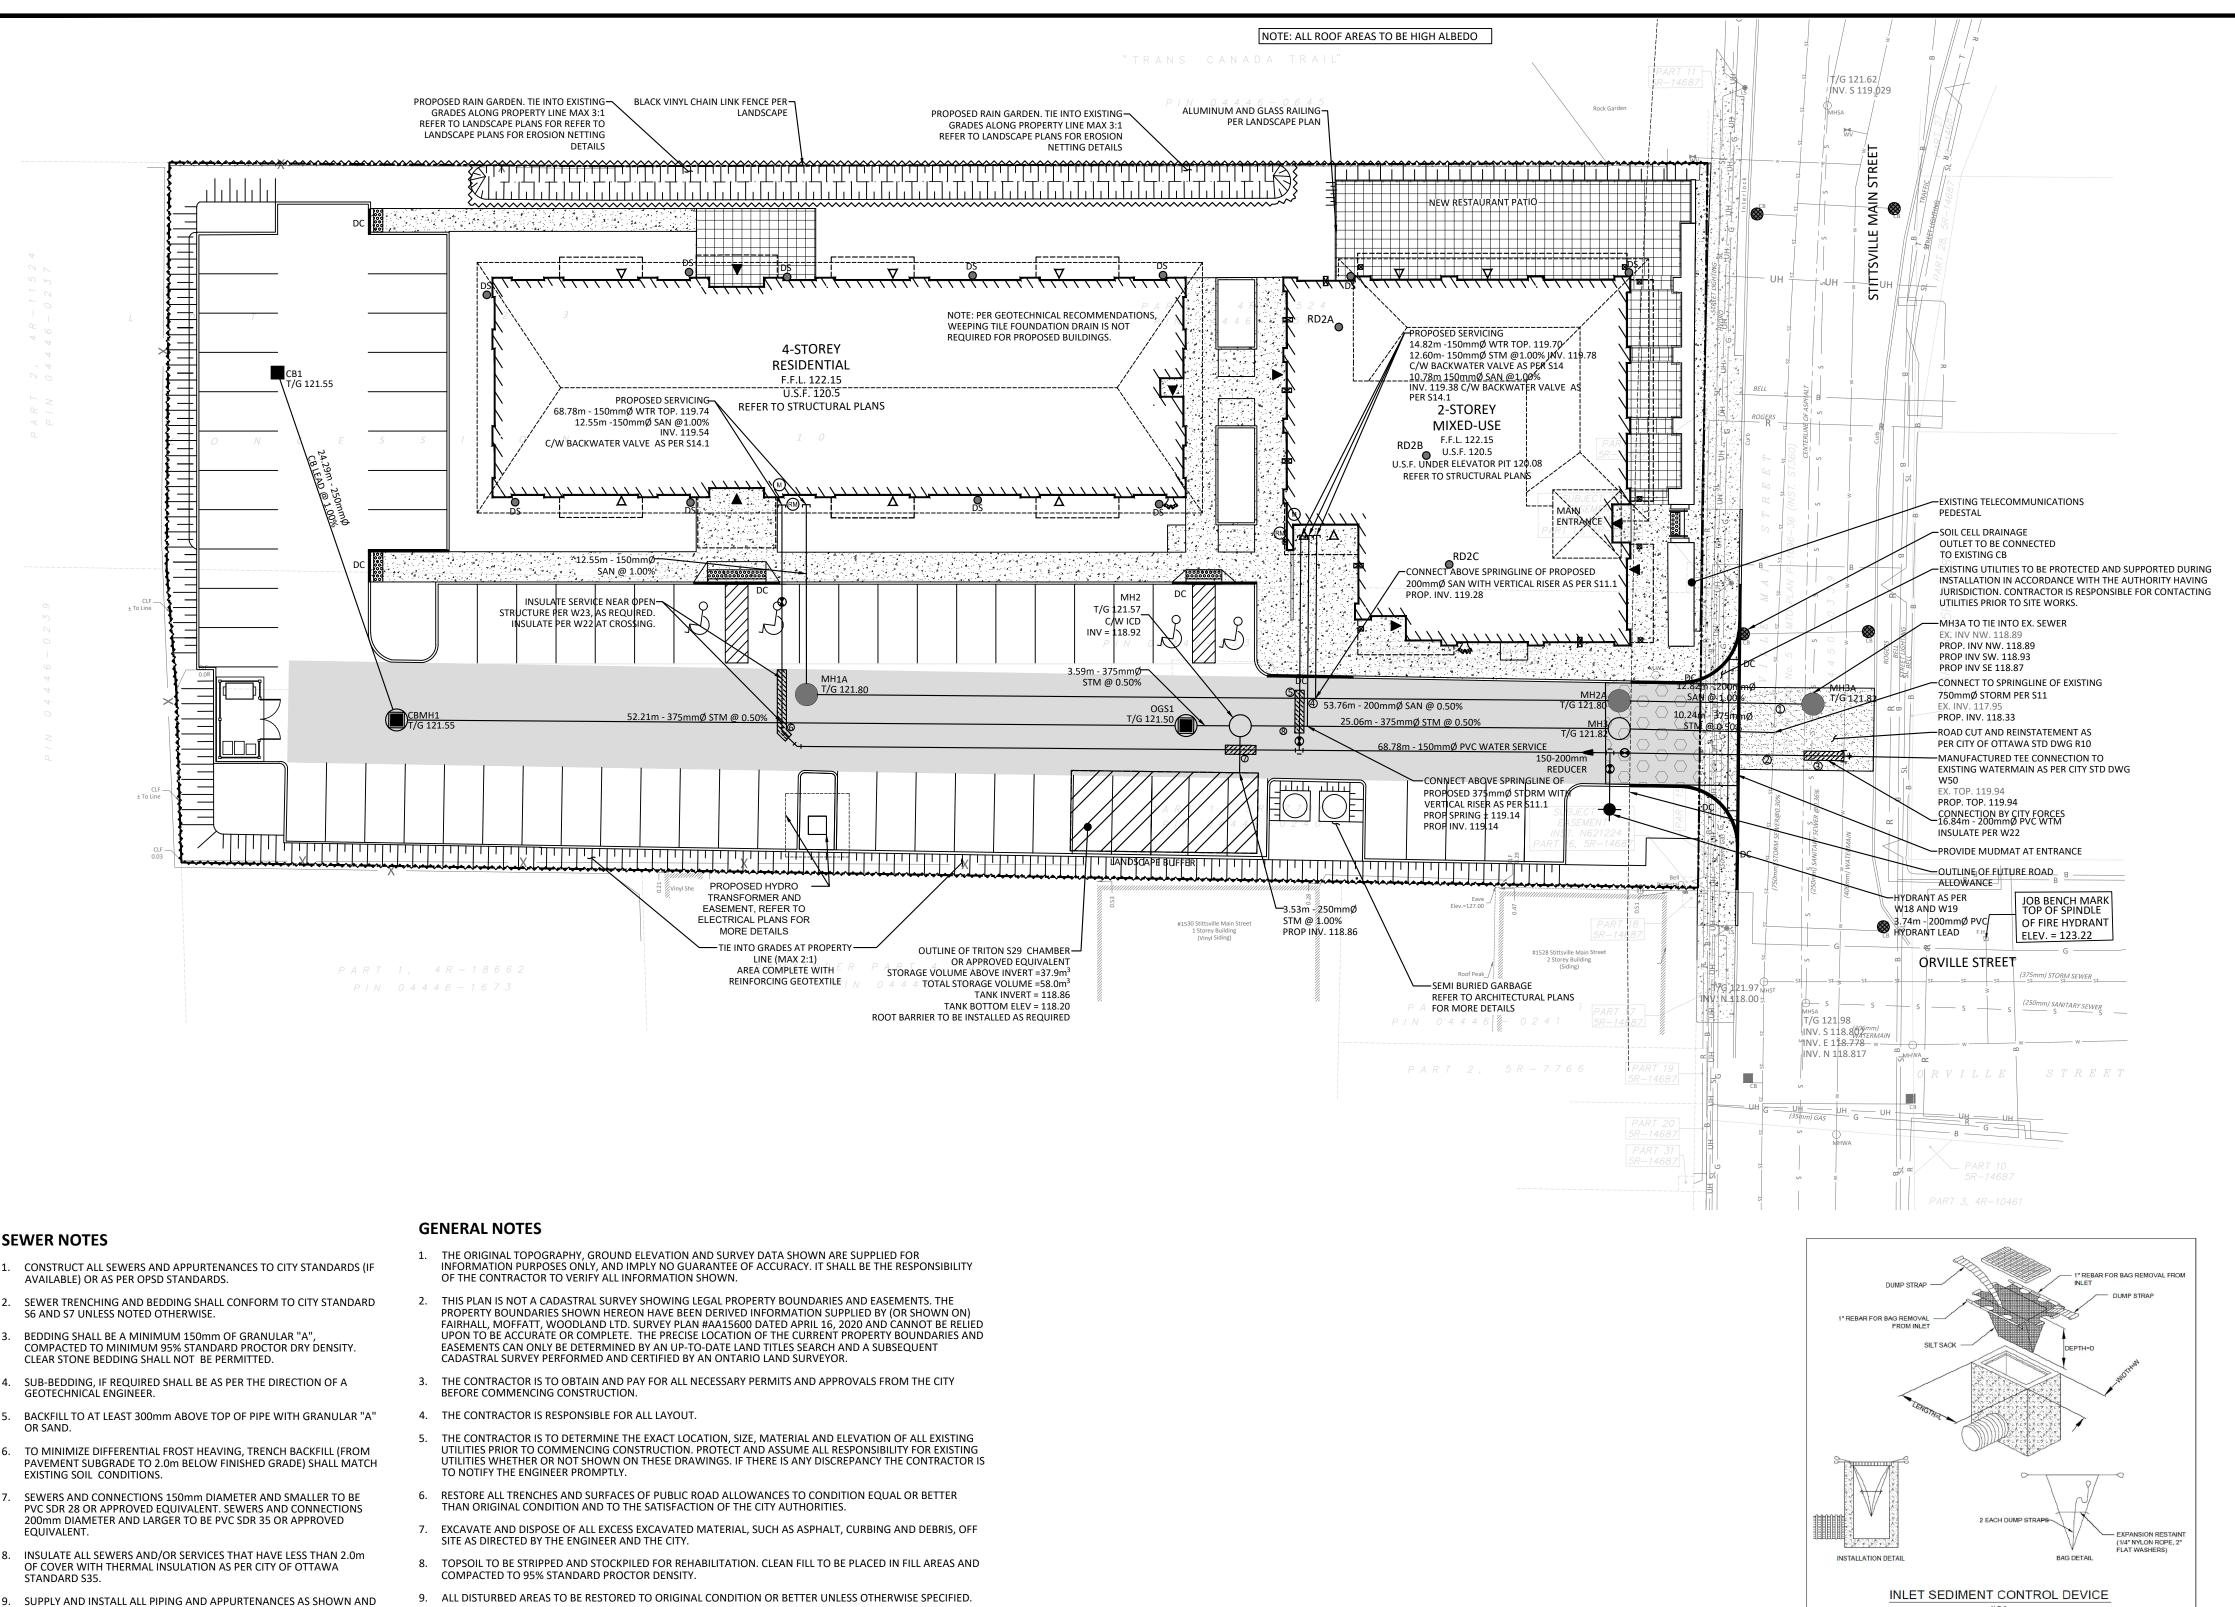
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ECP		OR DITCH INLET		EMERGEN FLOW ROU SILT FENC	
ECB	MH CANUTADY MA		<u>0/H</u>	(AS PER O	PSD 219.130) ENTRANCE
	PERFORATED			OVERHEA	
	WATER VALV		© ()	WATER M	
-	FIRE HYDRAN	т	$\bigotimes$	SEDIMENT	CONTROL DEVIC
	CROSSING CCLOCATION	ONFLICT			/ LINE OUT C/W SPLASH
l			DS	PAD	JUT C/ W SPLASH
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8	ISSUED FOR REVIE	W			MAY 22, 202
7	ISSUED FOR REVIE	W			FEB. 16, 202
6	REVISED WATER S	SERVICING	_		FEB. 28, 202
5	ISSUED FOR PERM	1IT			FEB. 04, 202
4	REVISED PER CITY	COMMENTS			NOV 24, 202
3	REVISED PER CITY	COMMENTS			JULY 30, 202
2	REVISED PER CITY	COMMENTS			APR. 22, 202
1	ISSUED FOR REVIE	W			NOV. 13, 202
No.	1	Revisions	6		Date
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<u><u></u></u>	R.R.R.			CP	-19-0608
Check	ed By: A.J.G.	Drawing Nur	nber:	<u>ر</u> ۲	-19-0006



# **SEWER NOTES**

- SEWER TRENCHING AND BEDDING SHALL CONFORM TO CITY STANDARD
- BEDDING SHALL BE A MINIMUM 150mm OF GRANULAR "A",
- CLEAR STONE BEDDING SHALL NOT BE PERMITTED.
- GEOTECHNICAL ENGINEER.
- OR SAND.
- EXISTING SOIL CONDITIONS.
- 200mm DIAMETER AND LARGER TO BE PVC SDR 35 OR APPROVED EQUIVALENT.
- STANDARD S35.
- DETAILED TO WITHIN 1.0m OF BUILDING. ALL ENDS OF SERVICES TO BE PROPERLY CAPPED AND LOCATED WITH 2"x4"x8' LONG MARKER.
- 10. CONTRACTOR TO TELEVISE (CCTV) ALL PROPOSED SEWERS ONSITE, OUTLET CONNECTION TO THE MAIN AND PIPES 150mmØ OR GREATER PRIOR TO BASE COURSE ASPHALT, UPON COMPLETION OF CONTRACT, THE CONTRACTOR IS RESPONSIBLE TO FLUSH AND CLEAN ALL SEWERS & APPURTENANCES.
- 11. DYE TESTING IS TO BE COMPLETED ON SANITARY SERVICE TO CONFIRM PROPER CONNECTION TO THE SANITARY SEWER MAIN.
- 12. ALL SANITARY MANHOLES TO BE BENCHED PER OPSD 701.021.
- 13. PROPOSED SEWER CROSSING EXISTING UTILITIES TO BE PER CITY STANDARD S10

# WATERMAIN NOTES

- CONSTRUCT ALL WATERMAINS AND APPURTENANCES IN ACCORDANCE WITH CITY STANDARDS (IF AVAILABLE) OR AS PER OPSD STANDARDS.
- 2. ALL WATERMAIN TO BE CLASS 150 DR-18 OR APPROVED EQUIVALENT.
- WATERMAINS AND/OR WATER SERVICES ARE TO HAVE A MINIMUM COVER OF 2.4m. OTHERWISE THERMAL INSULATION IS REQUIRED AS PER CITY STANDARD W22
- THERMAL INSULATION OF WATERMAINS AT OPEN STRUCTURES AS PER CITY DETAIL W23. IF THE WATERMAIN MUST BE DEFLECTED TO MEET ALIGNMENT, ENSURE
- THAT THE AMOUNT OF DEFLECTION USED IS EQUAL TO OR LESS THAN THAT WHICH IS RECOMMENDED BY THE MANUFACTURER. USE APPROVED SADDLE CONNECTION WITH MAIN (CORPORATION) STOP
- AS PER CITY OF OTTAWA STANDARD DRAWING 'W26'.
- CONNECTION TO EXISTING BY CITY FORCES. EXCAVATION, BACKFILLING AND REINSTATEMENT IS TO BE COMPLETED BY THE CONTRACTOR.
- SWABING, CHLORINATION AND CONTINUITY TESTING FOR PROPOSED WATER SERVICES IS TO FOLLOW CITY OF OTTAWA SPECIAL PROVISIONS #SP-4491 & SP-4494.
- PROPOSED WATERMAIN CROSSING EXISTING UTILITIES TO BE PER CITY STANDARD S10

• TELEVISION SERVICE - ROGERS.

- 9. ALL DISTURBED AREAS TO BE RESTORED TO ORIGINAL CONDITION OR BETTER UNLESS OTHERWISE SPECIFIED. 10. THE CONTRACTOR SHALL BE RESPONSIBLE FOR ALL TRAFFIC CONTROL AND SAFETY MEASURES DURING THE CONSTRUCTION PERIOD, INCLUDING THE SUPPLY, INSTALLATION, AND REMOVAL OF ALL NECESSARY SIGNAGE,
- DELINEATORS, MARKERS AND BARRIERS.
- 11. DO NOT ALTER GRADING OF THE SITE WITHOUT PRIOR APPROVAL OF THE CITY. 12. ALL ROADWAY, PARKING LOT, AND GRADING WORKS TO BE UNDERTAKEN IN ACCORDANCE WITH CITY
- STANDARDS AND SPECIFICATIONS. THE CONTRACTOR IS TO PROVIDE POSITIVE DRAINAGE AWAY FROM THE BUILDING
- 13. CONTACT THE CITY FOR INSPECTION OF ROUGH GRADING OF PARKING LOTS, ROADWAYS AND LANDSCAPED AREAS PRIOR TO PLACEMENT OF ASPHALT AND TOPSOIL. ALL DEFICIENCIES NOTED SHALL BE RECTIFIED TO THE CITY SATISFACTION PRIOR TO PLACEMENT OF ANY ASPHALT, TOPSOIL, SEED & MULCH AND/OR SOD.
- 14. ALL DIMENSIONS AND INVERTS MUST BE VERIFIED PRIOR TO CONSTRUCTION, IF THERE IS ANY DISCREPANCY THE CONTRACTOR IS TO NOTIFY THE ENGINEER PROMPTLY.
- 15. ELECTRICAL, GAS, TELEPHONE AND TELEVISION SERVICE LOCATIONS ARE SUBJECT TO THE INDIVIDUAL AGENCY: ELECTRICAL SERVICE - HYDRO OTTAWA, • GAS SERVICE - ENBRIDGE, • TELEPHONE SERVICE - BELL CANADA,
- 17. INSTALLATION TO BE IN ACCORDANCE WITH CURRENT CODES AND STANDARDS OF APPROVAL AGENCIES HYDRO OTTAWA, BELL AND THE CITY.
- 18. ALL PROPOSED CURB SHALL BE CONCRETE BARRIER CURB AS PER CITY STANDARD DRAWING SC1.1 UNLESS OTHERWISE SPECIFIED. SIDEWALK PER CITY STANDARD DRAWING SC1.4 UNLESS OTHERWISE SPECIFIED.
- 19. ALL EXISTING REDUNDANT PRIVATE APPROACHES FRONTING THIS DEVELOPMENT MUST BE REMOVED TO THE SATISFACTION OF THE CITY.
- 20. NO EXCESS DRAINAGE, EITHER DURING OR AFTER CONSTRUCTION, IS TO BE DIRECTED TOWARDS NEIGHBORING PROPERTIES.
- 21. NO ALTERATION OF EXISTING GRADES AND DRAINAGE PATTERNS ON PROPERTY BOUNDARIES.

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				ABLE			$\rightarrow$			$\mathbf{X}$		
4	LOCAT	-	STATION	GRADE PIPE 121.82 119.94	COVER 1.88		/	R51			5	
CI	ROSSING #3	PER W25.2 PER W25.2	0+102.17	121.85 119.65 121.84 119.44	2.20 2.40	,	MANCHEST			ORVILLE		
	VAL 200 x 20		+	121.85119.45121.84119.44	2.40 2.40		MA	X		$\bigwedge$		
	150-200 R 150 X 15	50 TEE	0+136.02	121.83119.43121.65119.25	2.40 2.40		$\succ$	$\langle \rangle$	$\lambda$	$\langle \ \setminus$		\ \
CF	45° BE		0+169.23	121.60119.75121.83119.43	1.85 2.40		T ST W	/ <u> </u>	$\mathbb{N}$	$\backslash$		$\backslash$
CF		PER W25.2	0+171.24	121.83119.75121.82119.90121.07110.57	2.08 1.92		ABBOTTSTW		NA MAR			
	VAL BLDG (RESI			121.97119.57122.14119.74	2.40 2.40		TION PLAI		JECT SITE	2 Stiller		
	200 x 20 VAL			121.84 119.44 121.87 119.47	2.40	LEGE	_	N				
	HYDR/			121.87 119.47   122.07 119.67	2.40		BARI	RIER CURB				NE OF SWALE
	150 X 15			121.64 119.24	2.40			B DEPRESION			SLOPING	AT 3:1
-		PER W25.2	0+301.59	121.63119.23121.65119.68121.72110.80			CON	CRETE SIDEWALK	 ×	9 <b>5.94</b> 93.20		DELEVATION ELEVATION
	BLDG (COM	PER W25.2 MERCIAL)		121.73119.80122.13119.70	1.93 2.43			ING STONE		95.94 (5)	SWALE EL	
		CROSSING	CONFLICT	TABLE			ято	RM MANHOLE	×	r/w100.50 s/w90.50		ALL ELEVATION OF WALL ELEVATION
LOCA	TION	DI	ESCRIPTION	SEP	PARATION	СВ	DI CATO	CHBASIN OR DITCH	INLET		EMERGEN FLOW RO	ICY OVERLAND UTE
1		750mmØ ST	N SERVICE INV 1 M SEWER OBV 1	L18.69	0.27	ECB	<sup>™CB</sup> LANI	DSCAPE CATCHBASI	N _^			E BARRIER PSD 219.130)
2	2	750mmØ ST	TR SERVICE INV 1 M SEWER OBV1 SING PER W25.2	.18.71	0.53		MH SAN	ITARY MANHOLE	•	▼ <sup>0/н</sup>	BUILDING OVERHEA	ENTRANCE D DOOR
3	;	200mmØ W1 250mmØ SA	TR SERVICE INV 1 N SEWER OBV 1	119.45 19.14	0.25		PERF	ORATED PIPE		RM	REMOTE	WATER METER
4		<u>CROSS</u> 150mmØ STI	SING PER W25.2 M SERVICE INV 1 N SEWER OBV 1	119.66	0.29		e wat	FER VALVE/CHAMB	∃R	$\bigotimes$		
		150mmØ W1	TR SERVICE INV 1	119.65						<b>\</b>	SEDIMEN	T CONTROL DEVICE
5	,	CROSS	N SEWER OBV 1 SING PER W25.2		0.26			SSING CONFLICT ATION			DOWNSP	Y LINE OUT C/W SPLASH
6	;	375mmØ ST	TR SERVICE INV 1 M SEWER OBV 1 SING PER W25.2	119.50	0.25			ATION OF SCUPPER ARCHITECTURAL		DS	PAD	
7	,	150mmØ W1	TR SERVICE INV 1 M SEWER OBV 1	119.60	0.47		EXTE	ENT OF SEWER/SER	VICE			
,		CROSS	SING PER W25.2 M SEWER OBV 1					JLATION				
8		150mmØ WT CROSS	TR SERVICE INV 1 SING PER W25.2	119.53	0.26	0000	EXTE		<b></b>			
AS SEWEF UI CRO	PER CITY GUID R/UTILITY IS 0.25 NDER SEWER, T SSING UNDER S	ELINE, THE MINIMUN 5m FOR CROSSING O HE MINIMUM VERTH SEWER, ADEQUATE S	// VERTICAL CLEARANG VER THE SEWER, AS P CAL CLEARANCE IS 0.5 TRUCTURAL SUPPORT	ICE BETWEEN WATERMAI PER CITY DETAIL W25.2 FC 5m AS PER CITY DETAIL W T FOR THE SEWERS IS REC JOINTS AND AT THE POINT OF CROSSIN DSSIBLE FROM THE SEWE	IN AND OR CROSSING V25. FOR OUIRED TO		F	'OR RH	SVIF	W (	<b>NL</b>	Y
SETT	LING. THE LENG THE JOINTS	PREVENT EXCES TH OF WATER PIPE S WILL BE EQUIDISTA	SIVE DEFLECTION OF J HALL BE CENTERED A NT AND AS FAR AS PC	IOINTS AND T THE POINT OF CROSSIN DSSIBLE FROM THE SEWE	NG SO THAT ER.	_		NOT FOR				
		STORM S	STRUCTURE	TABLE								
NAME	RIM ELEV.	INVERT IN	INVERT OUT	DESCRIF	PTION	9	ISSUED FO	R REVIEW				AUG 08, 2024
CB1	121.55		SE120.050	STRUC. OPSI COVER CI		8	ISSUED FO	R REVIEW				MAY 22, 2024
				COVER CITY	STD S28.1	7	ISSUED FO					FEB. 16, 2024
CBMH1	121.55	NW119.807	NE119.254	FRAME CITY STRUC. OPS								
				COVER CITY FRAME CITY	Y STD S25	6		ATER SERVICIN	-G			FEB. 28, 2022
MH2	121.57	SW118.952	NE118.920 SE118.900	STRUC. OPSI NE. OUTLET C/	/W TEMPEST	5	ISSUED FO	R PERMIT				FEB. 04, 2022
			SE118.900	LMF OR APPR WATERTIGH	R. EQV.	4	REVISED P	ER CITY COMME	ENTS			NOV. 24, 2021
				OPSD 40	01.030	3	REVISED P	ER CITY COMME	ENTS			JULY 30, 2021
МНЗ	121.82	SW118.795	NE118.381	COVER CITY FRAME CITY STRUC. OPSI	Y STD S25	2	REVISED P	ER CITY COMME	ENTS			APR. 22, 2021
				WATERTIGH OPSD 40	HT LID PER	1	ISSUED FO	R REVIEW				NOV. 13, 2020
OGS1	121.50	SW118.995	NE118.970	STORMCEP OR APPR		No.		Rev	visions			Date
S-29	121.58	NW118.865		TRITON S	5-29 OR	Check	and verify a	all dimensions			Do no	t scale drawings
				APPR.	EQV	before		with the work			Donio	
						_	SCALE	1 : 250				
		SAN ST	RUCTURE T	ΓABLE			0	5 10		15	20	25 Metres
			INVERT OUT						~ ~			
NAME	RIM ELEV.	INVERT IN		DESCRIF	PTION		$\sim$		ЭSН	ΡΕ	RRY	
	ELEV.			COVER CITY	Y STD S24		$\sim$		OSH	PE	· ·	
NAME MH1A		INVERT IN NW119.410	NE119.349	COVER CITY FRAME CITY STRUC. OPSI	Y STD S24 Y STD S25 D 701.010					æ		
	ELEV.			COVER CITY FRAME CITY STRUC. OPSI COVER CITY FRAME CITY	Y STD S24 Y STD S25 D 701.010 Y STD S24 Y STD S25	-		115 Walgreen Tel: 613-836-	Rd. Car 2184 Fax:	р, ОN К 613-836-3	egis GROUP	
MH1A	ELEV. 121.80	NW119.410 SW119.080	NE119.349	COVER CITY FRAME CITY STRUC. OPSI COVER CITY	Y STD S24 Y STD S25 D 701.010 Y STD S24 Y STD S25 D 701.010			115 Walgreen Tel: 613-836-	Rd. Car 2184 Fax: McIntoshPe	p, ON K 613-836-33 rry.com	COA 1L0	
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