# 254 ARGYLE

254 Argyle Avenue, Ottawa, Ontario

ISSUED FOR SPC AND REZONING COMMENT RESPONSE 02: 2025.06.17

#### ARCHITECTURAL

A000 **COVER PAGE** DEMOLITION SITE PLAN D100 A100 SITE PLAN A200 LEVEL -2 PLAN A201 LEVEL -1 AND GROUND FLOOR PLANS A202 LEVEL 1B AND LEVEL 1C PLANS A203 LEVEL 2-9 FLOOR PLANS A204 ROOFS & PENTHOUSE PLANS A300 NORTH & SOUTH ELEVATIONS A301 EAST ELEVATION A302 WEST ELEVATION

LONGITUDINAL SECTION

<u>CIVIL</u>


A400


123062-GP GENERAL PLAN OF SERVICES

**GRADING PLAN** 123062-GR

### <u>LANDSCAPE</u>

123062-TCR1 TREE CONSERVATION PLAN 1 123062-TCR2 TREE CONSERVATION PLAN 2 123062-L LANDSCAPE PLAN 123062-L2 ROOFTOP - LANDSCAPE PLAN

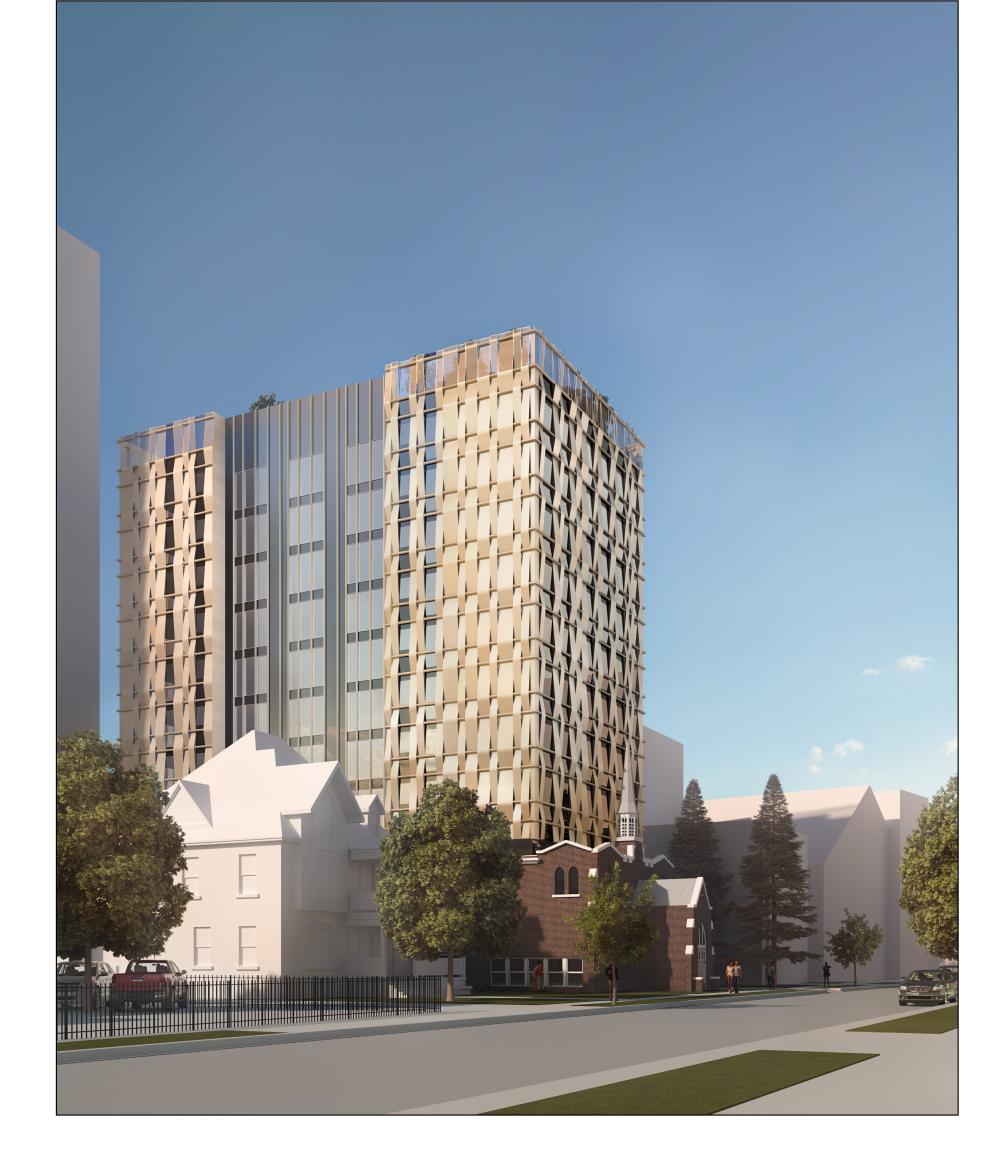

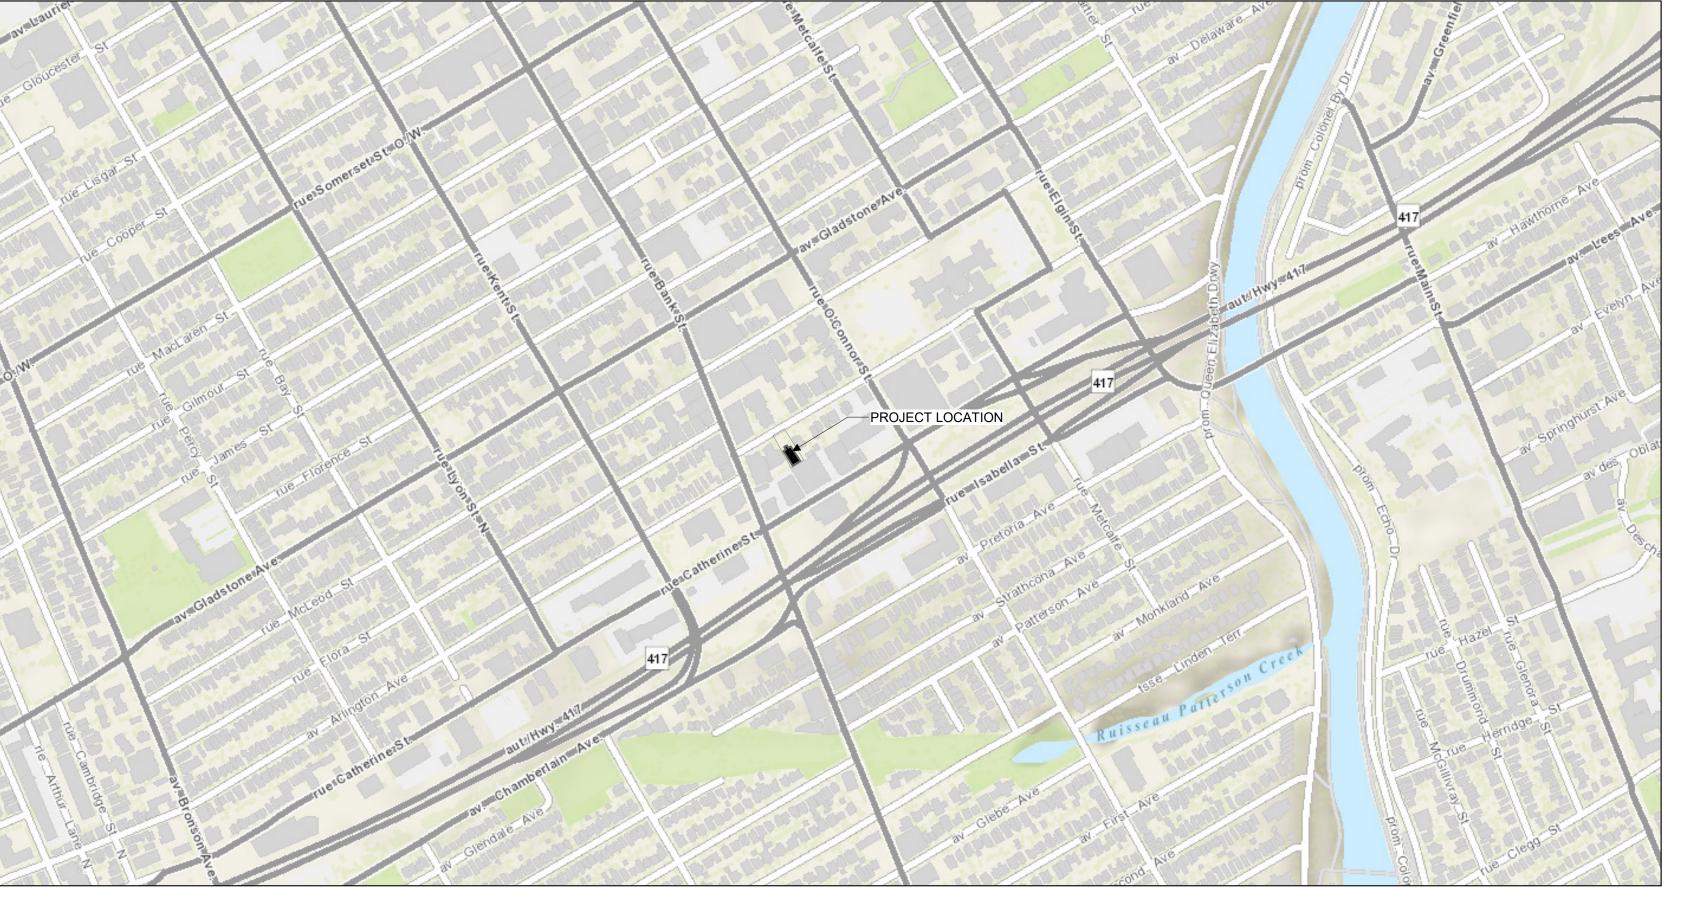

PROJECT LOCATION PLAN

ARCHITECT OF RECORD

# **CSV** ARCHITECTS

sustainable design · conception écologique

190 O'Connor Street, Suite 100 613.564.8118 Ottawa, Ontario,K2P 2R3 www.csv.ca

DESIGN CONCEPT ARCHITECT

SPICE Design Level 4, 22 Bishopsgate London, England EC2N 4BQ www.spice.design

STRUCTURAL ENGINEER GOODEVE STRUCTURAL INC. Suite 18, 77 Auriga Drive Ottawa, Ontario, Canada K2E 7Z7 (613) 226-4558 www.goodevestructural.ca

MECHANICAL + ELECTRICAL ENGINEER QUASAR CONSULTING GROUP Suite 400, 150 Isabella Street Ottawa, Ontario, Canada K1S 5H3 (613) 518-8344 www.quasarcg.com

CIVIL ENGINEER NOVATECH

Engineers, Planners & Landscape Architects Suite 200, 240 Michael Cowpland Drive Ottawa, Ontario, Canada K2M 1P6 (613) 254-9643 www.novatech-eng.com

LANDSCAPE ARCHITECT

NOVATECH Engineers, Planners & Landscape Architects Suite 200, 240 Michael Cowpland Drive Ottawa, Ontario, Canada K2M 1P6 (613) 254-9643 www.novatech-eng.com



STAMP

5 2025.06.17 ISSUED FOR SPC AND REZONING

COMMENT RESPONSE 02 2 2024.08.29 ISSUED FOR SPC AND REZONING 1 2024.05.08 ISSUED FOR PHASE 2 PRECONSULT

REV DATE ISSUE

### NOTES

1. OWNERSHIP OF THE COPYRIGHT OF THE DESIGN AND THE WORKS EXECUTED FROM THE DESIGN REMAINS WITH CSV ARCHITECTS, AND MAY NOT BE REPRODUCED IN ANY FORM WITHOUT THE WRITTEN CONSENT OF CSV ARCHITECTS. 2. THE DRAWINGS, PRESENTATIONS AND SPECIFICATIONS AS INSTRUMENTS OF SERVICE ARE AND SHALL REMAIN THE PROPERTY OF CSV ARCHITECTS. THEY ARE NOT TO BE USED BY THE CLIENT ON OTHER PROJECTS OR ON EXTENSIONS TO THIS PROJECT WITHOUT THE WRITTEN CONSENT OF CSV ARCHITECTS.

3. THIS DRAWING IS TO BE READ IN CONJUNCTION WITH ALL OTHER PROJECT DRAWINGS AND SPECIFICATIONS. 4. DO NOT SCALE DRAWINGS. CONTRACTOR SHALL BE RESPONSIBLE TO VERIFY DIMENSIONS ON SITE.

5. ALL WORK SHALL BE IN ACCORDANCE WITH THE ONTARIO BUILDING CODE AND ALL SUPPLEMENTS

AND APPLICABLE MUNICIPAL REGULATIONS. CLIENT



OTTAWA ONTARIO, CANADA

PROJECT

254 ARGYLE

254 Argyle Avenue, Ottawa, Ontario

**COVER PAGE** 

PROJECT NO: 2023-0250 DRAWN: APPROVED: DH

As indicated DATE PRINTED: 2025-05-26 1:37:12 PM

DRAWING NO. 🕇

### **DEMOLITION SITE PLAN KEYNOTES:**

- 1 EXISTING SIDEWALK TO REMAIN
- 2 EXISTING ASPALT PAVING TO REMAIN
- 3 EXISTING CURB TO REMAIN
- 4 EXISTING SIGN TO REMAIN
- 5 EXISTING LANDSCAPING TO REMAIN.
- 21 REMOVE AND PRESERVE CHURCH WALLS AND STEEPLE BRICK BY BRICK. REFER TO 254 ARGYLE AVENUE CHURCH RELOCATION OPTIONS ANALYSIS OPTION 3, PREPARED BY REMISZ, DATED MARCH 28, 2024. DEMOLISH REMAINDER OF BUILDING.
- 22 REMOVE EXISTING LANDSCAPING AT AREA OF WORK
- 23 REMOVE EXISTING SIDEWALK
- 24 REMOVE EXISTING ASPHALT DRIVEWAY
- 25 REMOVE EXISTING CURB
- 26 REMOVE AND REINSTATE EXISTING ROAD ASSEMBLY AS REQUIRED FOR TRENCHING AND UTILITY SERVICE CONSTRUCTION. CUT PAVING IN STRAIGH LINES. MATCH EXISTING PAVING ASSEMBLY AND ELEVATIONS.
- 27 TRENCH AS REQUIRED FOR UTILITY SERVICE REMOVAL AND NEW CONSTRUCTION. FILL TRENCHES PER GEOTECHNICAL. MATCH ADJACENT SITE LEVELS AND CONDITIONS
- 28 REMOVE AND RELOCATE EXISTING FIRE HYDRANT PER CIVIL

# **DEMOLITION SITE PLAN GENERAL NOTES:**

- FROM EXISTING PLANS AND SURVEYS 2. DO NOT SCALE THIS DRAWING
- NO RESPONSIBILITY IS BORN BY THE CONSULTANT FOR UNKNOWN SUBSURFACE CONDITIONS
- 4. CONTRACTOR TO CHECK AND VERIFY ALL DIMENSIONS ON SITE AND REPORT ANY ERRORS AND/OR OMISSIONS TO THE CONSULTANT
- REINSTATE ALL AREAS AND ITEMS DAMAGED AS A RESULT OF CONSTRUCTION ACTIVITIES TO THE SATISFACTION OF THE CONSULTANT
- TO APPROVAL OF CONSULTANT PRIOR TO ANY JOB **EXCAVATION**
- THE ACCURACY OF THE POSITION OF UTILITIES IS NOT GUARANTEED - CONTRACTOR TO VERIFY PRIOR TO **EXCAVATION**
- INDIVIDUAL UTILITY COMPANY MUST BE CONTACTED FOR
- ALL DISTURBED AREAS TO BE RESTORED TO ORIGINAL

**EXISTING BUILDING & SITE ELEMENTS DEMOLISHED BUILDING & SITE ELEMENTS** 

- -wtr-d- - -wtr-d - WATER MAIN TO REMOVE

-- -SAN-D- -- -SAN-D- SANITARY SEWAGE TO REMOVE

—E-OHW——E-OHW— EXISTING ELECTRICAL OVERHEAD SERVICE TO REMAIN

——E-B———E-B—— EXISTING BELL LINE TO REMAIN

——E-R——E-R—— EXISTING ROGER LINE TO REMAIN

EXISITING FIRE HYDRANT

EXISTING MAINTENANCE HOLE

**EXISTING UTILITY POLE** 

EXISTING VALVE AND VALVE BOX TO REMAIN

EXISTING TREE TO REMAIN

REMOVE EXITING TREE

**PROJECT** 254 ARGYLE

ONTARIO, CANADA

ARCHITECT OF RECORD

DESIGN CONCEPT ARCHITECT

Level 4, 22 Bishopsgate

www.spice.design

(613) 226-4558

(613) 518-8344

www.quasarcg.com

CIVIL ENGINEER NOVATECH

(613) 254-9643

NOVATECH

(613) 254-9643

STAMP

NOTES

www.novatech-eng.com

www.novatech-eng.com

REV DATE ISSUE

CONSENT OF CSV ARCHITECTS.

CONSENT OF CSV ARCHITECTS.

SPECIFICATIONS.

CLIENT

OTTAWA

2. THE DRAWINGS, PRESENTATIONS AND

TO THIS PROJECT WITHOUT THE WRITTEN

LANDSCAPE ARCHITECT

Ottawa, Ontario, Canada K2M 1P6

London, England EC2N 4BQ

STRUCTURAL ENGINEER

Suite 18, 77 Auriga Drive

www.goodevestructural.ca

GOODEVE STRUCTURAL INC.

Ottawa, Ontario, Canada K2E 7Z7

QUASAR CONSULTING GROUP Suite 400, 150 Isabella Street

Ottawa, Ontario, Canada K1S 5H3

MECHANICAL + ELECTRICAL ENGINEER

Engineers, Planners & Landscape Architects

Engineers, Planners & Landscape Architects Suite 200, 240 Michael Cowpland Drive

ASSOC

LICENCE

5 2025.06.17 ISSUED FOR SPC AND REZONING

2024.08.29 ISSUED FOR SPC AND REZONING 2024.05.08 ISSUED FOR PHASE 2 PRECONSULT

1. OWNERSHIP OF THE COPYRIGHT OF THE DESIGN AND THE WORKS EXECUTED FROM THE DESIGN REMAINS WITH CSV ARCHITECTS, AND MAY NOT BE

REPRODUCED IN ANY FORM WITHOUT THE WRITTEN

SPECIFICATIONS AS INSTRUMENTS OF SERVICE ARE AND SHALL REMAIN THE PROPERTY OF CSV ARCHITECTS. THEY ARE NOT TO BE USED BY THE CLIENT ON OTHER PROJECTS OR ON EXTENSIONS

3. THIS DRAWING IS TO BE READ IN CONJUNCTION WITH ALL OTHER PROJECT DRAWINGS AND

4. DO NOT SCALE DRAWINGS. CONTRACTOR SHALL BE RESPONSIBLE TO VERIFY DIMENSIONS ON SITE. 5. ALL WORK SHALL BE IN ACCORDANCE WITH THE

ONTARIO BUILDING CODE AND ALL SUPPLEMENTS AND APPLICABLE MUNICIPAL REGULATIONS.

URBAN DEVELOPMENTS

COMMENT RESPONSE 02

Suite 200, 240 Michael Cowpland Drive Ottawa, Ontario, Canada K2M 1P6

613.564.8118

www.csv.ca

**CSV** ARCHITECTS

sustainable design · conception écologique

190 O'Connor Street, Suite 100

Ottawa, Ontario,K2P 2R3

254 Argyle Avenue, Ottawa, Ontario

TITLE **DEMOLITION SITE** 


**PLAN** 

PROJECT NO: 2023-0250 DRAWN: EF / IK APPROVED: DH As indicated

REV DRAWING NO. 3

DATE PRINTED: 2025-05-26 1:37:14 PM



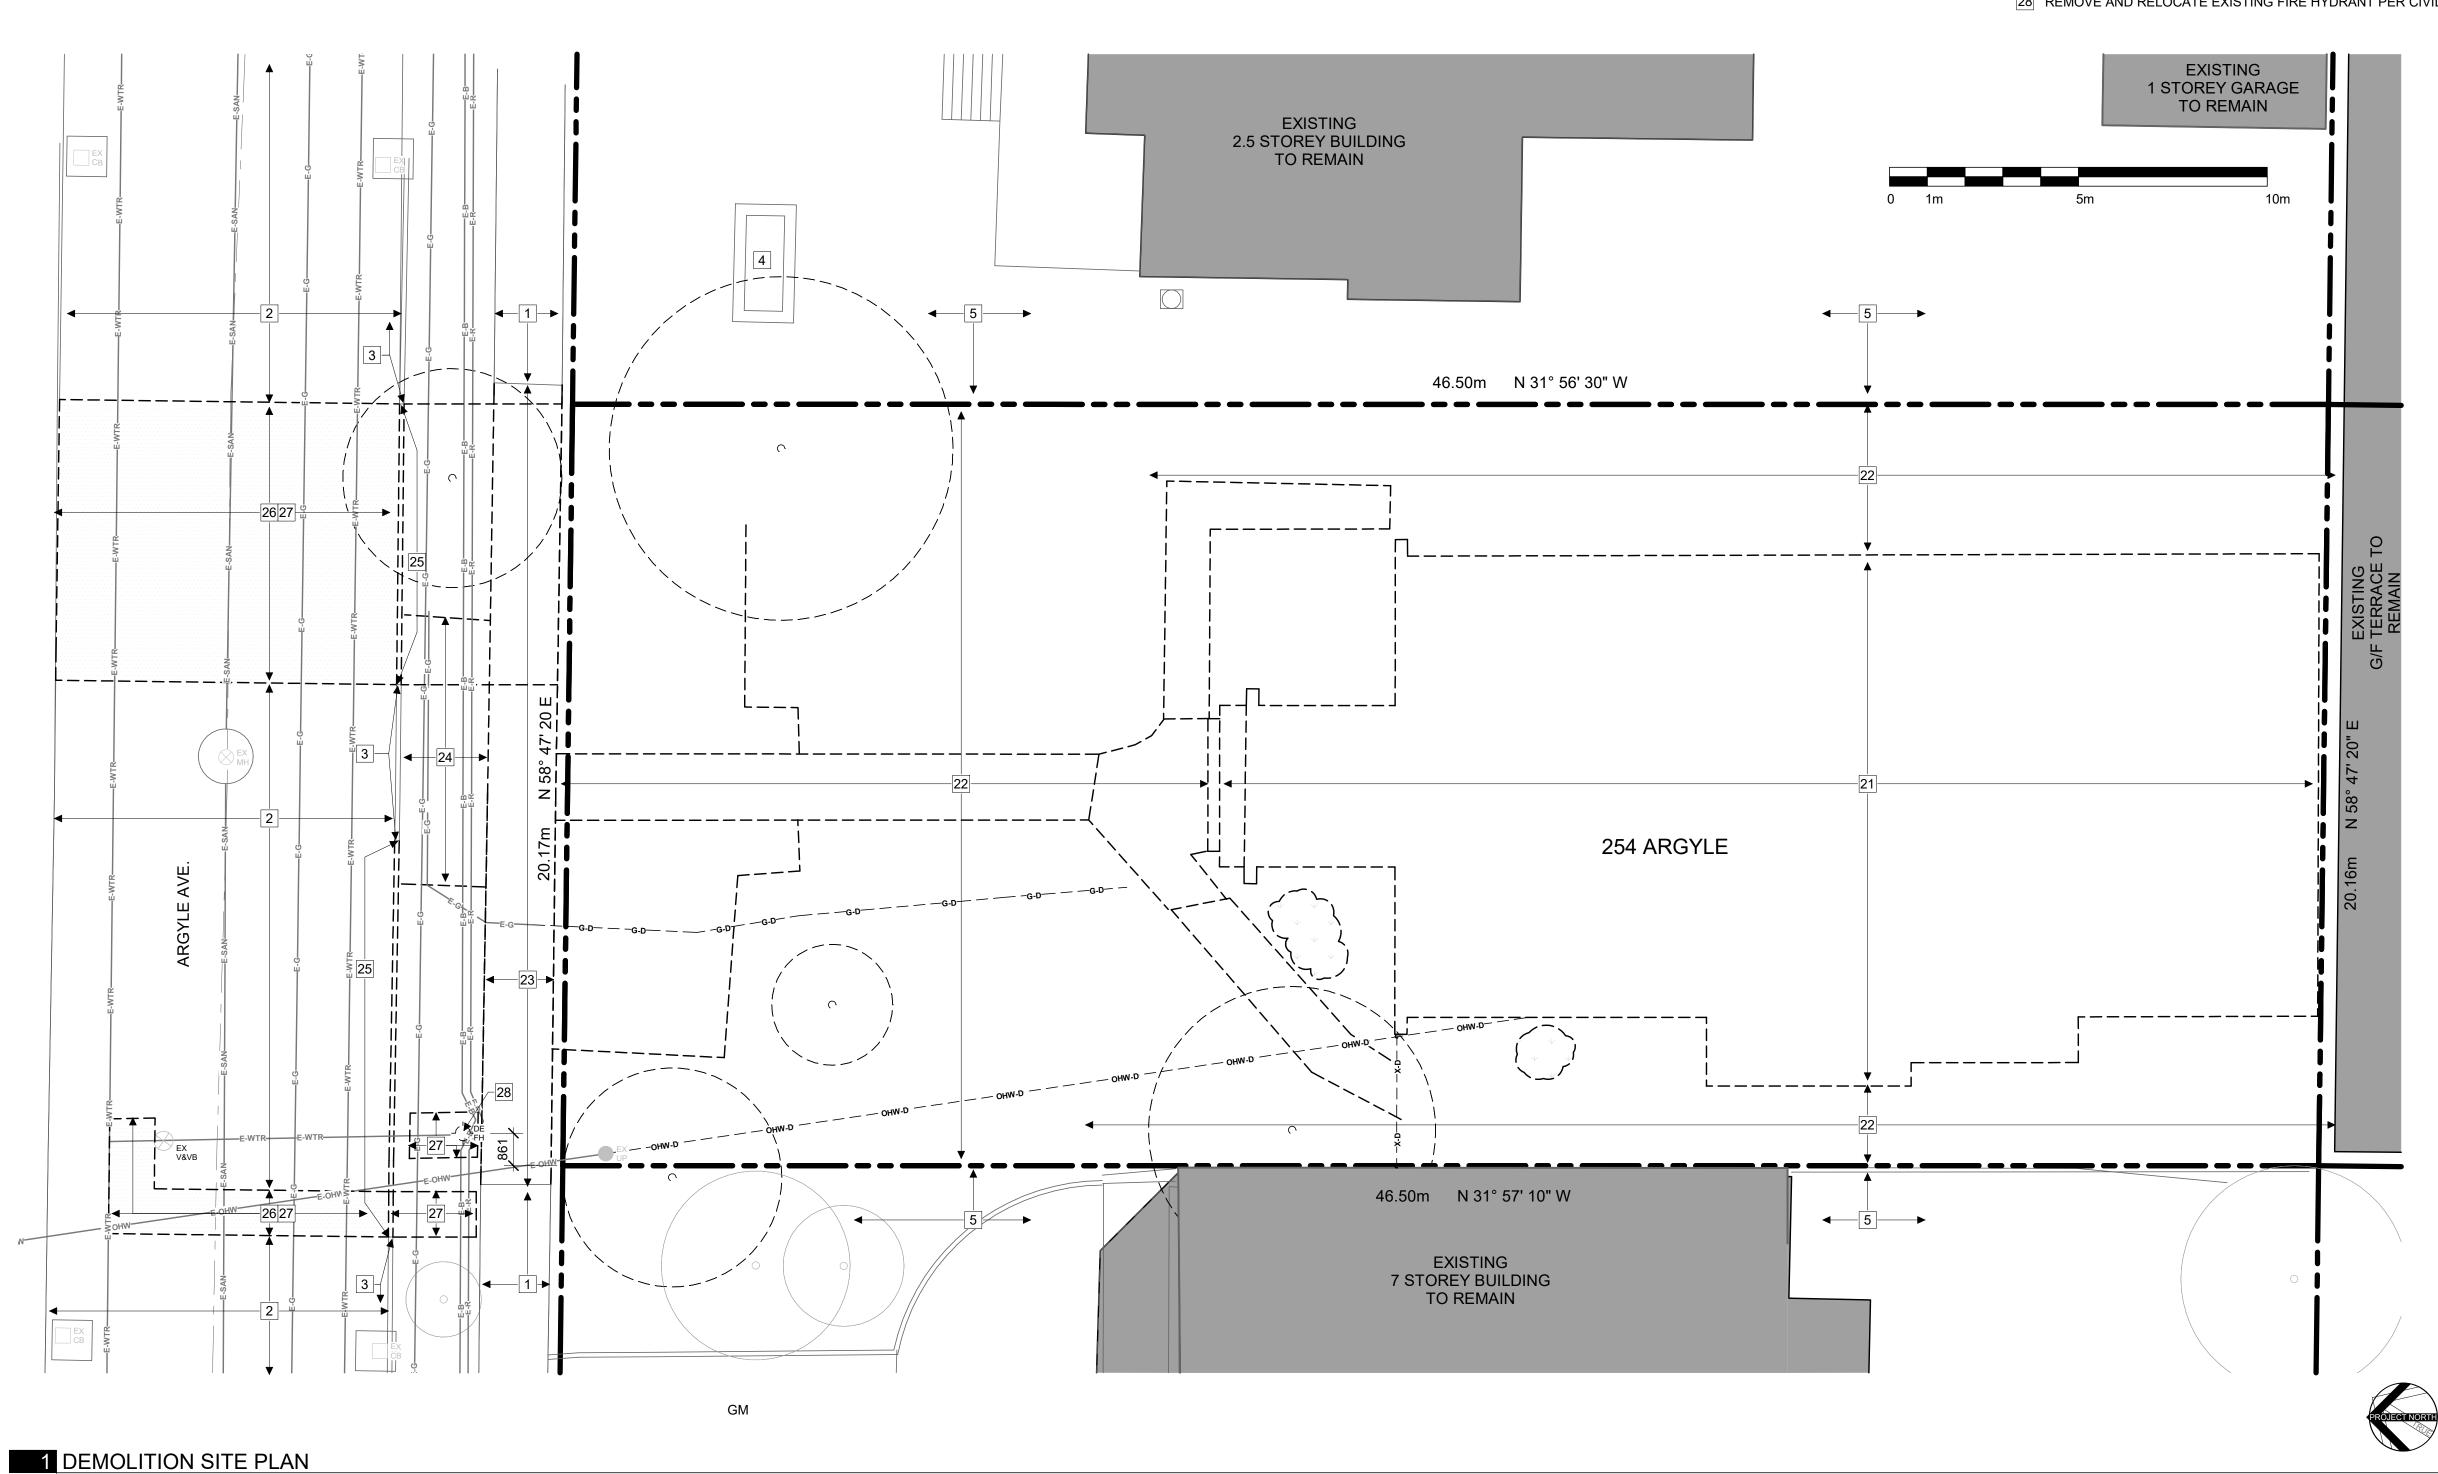

SITE AREA

GROSS LAND AREA

GROSS FLOOR AREA

**BUILDING AREA** 

**BUILDING HEIGHT** 

ZONE:

SCHEDULE 1

SCHEDULE 1A:

LEGAL DESCRIPTION

REGISTERED PLAN 30

REFERENCE SURVEY

**REGISTERED PLAN 30** 

MUNICIPAL ADDRESS

254 ARGYLE AVE. OTTAWA, ON

CITY OF OTTAWA

VOLLEBEKK LTD.

CITY OF OTTAWA

LOT 16 (SOUTH ARGYLE AVENUE)

LOT 16 (SOUTH ARGYLE AVENUE)

DRAFT OF TOPOGRAPHIC PLAN OF SURVEY OF

PREPARED BY SURVEYED BY ANNIS, O'SULLIVAN,

937.6m<sup>2</sup>

937.6m<sup>2</sup>

633.56m<sup>2</sup>

3,810.12m<sup>2</sup>

R5B H(19)

AREA B

AREA X

35m 9 STOREYS

**ZONING PROVISION** 

MIN. FRONT YARD SETBACK

MIN. REAR YARD SETBACK

MIN. INTERIOR YARD SETBACK

MIN. LOT WIDTH

MIN. LOT AREA

MAX. HEIGHT

**AMENITY AREA** 

LANDSCAPED AREA

<u>PROVIDED</u>

20.17m

937.05m<sup>2</sup>

1.42m

1.5m

34.5m

582.5m<sup>2</sup>

270.94m<sup>2</sup>

RESIDENTIAL SPACES

ACCESSIBLE PARKING

VISITOR SPACES

BICYCLE PARKING

42

42 (.5/UNIT)

**REQUIRED** 

22.5m

1.5m (6m past 21m)

504m<sup>2</sup> (6m<sup>2</sup>/unit)

281.12m<sup>2</sup>

- 1. ALL GENERAL SITE INFORMATION AND CONDITIONS COMPILED
- REPORT ANY DISCREPANCIES PRIOR TO COMMENCING WORK.
- 6. CONTRACTOR TO LAYOUT PLANTING BEDS, PATHWAYS ETC.
- CONFIRMATION OF UTILITY EXISTENCE AND LOCATION PRIOR TO DIGGING
- CONDITION OR BETTER UNLESS OTHERWISE NOTED

### **DEMOLITION SITE PLAN LEGEND:**

PROPERTY LINE

——E-X———E-X—— EXISTING FENCE TO REMAIN

—E-WTR—E-WTR— EXISTING WATER MAIN TO REMAIN

—E-SAN—E-SAN— EXISTING SANITARY SEWAGE TO REMAIN

——E-ST———E-ST— EXISTING STORM SEWAGE TO REMAIN

--st-d--st-d-- STORM SEWAGE TO REMOVE

 $_{-}$  -онw-d-  $_{-}$  -онw-d  $_{-}$  ELECTRICAL OVERHEAD SERVICE TO REMOVE

——E-G——E-G—— EXISTING GAS LINE TO REMAIN \_ \_G-D\_ \_ \_ \_G-D\_ \_ GAS LINE TO REMOVE

EXISTING CATCH BASIN EXISTING LIGHT STANDARD

FIRE HYDRANT TO REMOVE

GFA BREAKDOWN

RESIDENTIAL

WINE BAR

TOTAL

**EXISTING UNITS** 

STUDIO

1 BEDROOM

2 BEDROOM

3 BEDROOM

**TOTAL** 

**PROVIDED** 

3718.81m<sup>2</sup>

91.31m<sup>2</sup>

3810.12m<sup>2</sup>

### **SITE PLAN KEYNOTES:**

- 1 EXISTING SIDEWALK TO REMAIN
- 2 EXISTING ASPHALT PAVING TO REMAIN
- 3 EXISTING CURB TO REMAIN

9123

<sup>+</sup>5428 <sup>+</sup>

3957

SITE AREA

**GROSS LAND AREA** 

GROSS FLOOR AREA

**BUILDING HEIGHT** 

SCHEDULE 1:

SCHEDULE 1A:

ZONE:

**BUILDING AREA** 

SUBJECT TO DEVELOPMENT

9432

R5B H(19)

AREA B

AREA X

937.6m<sup>2</sup>

937.6m<sup>2</sup>

633.56m<sup>2</sup>

3,810.12m<sup>2</sup>

35m 9 STOREYS

6062

1 NEW SITE PLAN

LOT 16 (SOUTH ARGYLE AVENUE)

LOT 16 (SOUTH ARGYLE AVENUE)

254 ARGYLE AVE. OTTAWA, ON

DRAFT OF TOPOGRAPHIC PLAN OF SURVEY OF

PREPARED BY SURVEYED BY ANNIS, O'SULLIVAN,

LEGAL DESCRIPTION

REGISTERED PLAN 30

REFERENCE SURVEY

REGISTERED PLAN 30

MUNICIPAL ADDRESS

CITY OF OTTAWA

VOLLEBEKK LTD.

CITY OF OTTAWA

19238

- 4 EXISTING SIGN TO REMAIN
- 5 EXISTING LANDSCAPING TO REMAIN.

EXISTING

2.5 STOREY BUILDING

TO REMAIN

41047

NEW BUILDING

84 UNITS

254 ARGYLE AVE.

46.50m N 31° 57' 10" W

EXISTING

7 STOREY BUILDING

TO REMAIN

37090

RESIDENTIAL SPACES

ACCESSIBLE PARKING

42 (.5/UNIT)

VISITOR SPACES

**BICYCLE PARKING** 

**PROVIDED** 

20.17m

937.05m<sup>2</sup>

1.42m

3.759m

1.5m

34.5m

582.5m<sup>2</sup>

270.94m<sup>2</sup>

42732

REQUIRED

22.5m

7.5m

1.5m (6m past 21m)

504m<sup>2</sup> (6m<sup>2</sup>/unit)

281.12m<sup>2</sup>

ZONING PROVISION

MIN. FRONT YARD SETBACK

MIN. REAR YARD SETBACK

MIN. INTERIOR YARD SETBACK

MIN. LOT WIDTH

MIN. LOT AREA

MAX. HEIGHT

AMENITY AREA

LANDSCAPED AREA

- 21 RELOCATE EXISTING CHURCH FACADE TO NEW LOCATION
- 22 VENTED CISTERN LID
- 23 NEW CONCRETE SIDEWALK PER CIVIL
- 24 REINSTATE TOP SOIL AND GRASS IN BETWEEN ROAD AND SIDEWALK AT AREAS EFFECTED BY CONSTRUCTION
- 25 NEW CURB PER CIVIL
- 26 REINSTATE EXISTING ROAD ASSEMBLY PER CIVIL AT AREAS EFFECTED BY DEMOLITION AND CONSTRUCTIONS. PROVIDE SMOOTH TRANSITION TO EXISTING PAVING.

33

- 27 BACKFILL TRENCHES AS REQUIRED PER CIVIL AND GEOTECHNICAL.
- 28 RELOCATE EXISTING FIRE HYDRANT PER CIVIL
- 29 NEW DRIVEWAY PER CIVIL
- 30 NEW CURB WALL PER CIVIL

13070

46.50m N 31° 56' 30" W

31 OVERHEAD DOOR TO UNDERGROUND PARKING

- 32 WOOD PRIVACY FENCE PER LANDSCAPING
- 33 TERMINATE WOOD PRIVACY FENCE FLUSH TO THE RETAINING WALL PER LANDSCAPING
- 34 PEDESTRIAN GATE
- 35 WALKWAY PER LANDSCAPING
- 36 PATIO PER LANDSCAPING
- 37 PLANTS PER LANDSCAPING
- 38 VAULT
- 39 RAISED PLANTER WALL PER LANDSCAPING
- 40 STEPBACK AT LEVELS 2 TO ROOF
- 41 SETBACK AT LEVEL 1B

14132

- 42 SETBACK AT LEVELS 1C TO ROOF
- DEPRESSED CURB ACROSS ACCESS LANE TO BE COMPLETED AS PER CITY DETAIL SC7.1

EXISTING 1 STOREY GARAGE

TO REMAIN

5759

4017

30 39

3759

<u>PROVIDED</u>

**EXISTING UNITS** 

STUDIO

1 BEDROOM

2 BEDROOM

3 BEDROOM

TOTAL

**GFA BREAKDOWN** 

RESIDENTIAL

WINE BAR

TOTAL

**PROVIDED** 

3718.81m<sup>2</sup>

91.31m<sup>2</sup>

3810.12m<sup>2</sup>

- 1. ALL GENERAL SITE INFORMATION AND CONDITIONS COMPILED FROM EXISTING PLANS AND SURVEYS
- 3. REPORT ANY DISCREPANCIES PRIOR TO COMMENCING WORK.
- NO RESPONSIBILITY IS BORN BY THE CONSULTANT FOR UNKNOWN SUBSURFACE CONDITIONS 4. CONTRACTOR TO CHECK AND VERIFY ALL DIMENSIONS ON
- CONSULTANT 5. REINSTATE ALL AREAS AND ITEMS DAMAGED AS A RESULT OF CONSTRUCTION ACTIVITIES TO THE SATISFACTION OF THE
- CONSULTANT 6. CONTRACTOR TO LAYOUT PLANTING BEDS, PATHWAYS ETC.
- TO APPROVAL OF CONSULTANT PRIOR TO ANY JOB **EXCAVATION** 7. THE ACCURACY OF THE POSITION OF UTILITIES IS NOT GUARANTEED - CONTRACTOR TO VERIFY PRIOR TO
- 8. INDIVIDUAL UTILITY COMPANY MUST BE CONTACTED FOR

SHRUB: EXISTING TO REMAIN / NEW PER

ARCHITECT OF RECORD

Level 4, 22 Bishopsgate

www.spice.design

(613) 226-4558

(613) 518-8344

www.quasarcg.com

CIVIL ENGINEER NOVATECH

(613) 254-9643

NOVATECH

(613) 254-9643

STAMP

NOTES

www.novatech-eng.com

www.novatech-eng.com

LANDSCAPE ARCHITECT

London, England EČ2N 4BQ

STRUCTURAL ENGINEER

Suite 18, 77 Auriga Drive

www.goodevestructural.ca

GOODEVE STRUCTURAL INC.

Ottawa, Ontario, Canada K2E 7Z7

QUASAR CONSULTING GROUP

Ottawa, Ontario, Canada K1S 5H3

Ottawa, Ontario, Canada K2M 1P6

Suite 400, 150 Isabella Street

MECHANICAL + ELECTRICAL ENGINEER

Engineers, Planners & Landscape Architects Suite 200, 240 Michael Cowpland Drive

Engineers, Planners & Landscape Architects

ASSOC

DARRYL J. HOOD LICENCE

5 2025.06.17 ISSUED FOR SPC AND REZONING

4 2024.12.20 ISSUED FOR SPC AND REZONING

2 2024.08.29 ISSUED FOR SPC AND REZONING

1. OWNERSHIP OF THE COPYRIGHT OF THE DESIGN AND THE WORKS EXECUTED FROM THE DESIGN REMAINS WITH CSV ARCHITECTS, AND MAY NOT BE

REPRODUCED IN ANY FORM WITHOUT THE WRITTEN

SPECIFICATIONS AS INSTRUMENTS OF SERVICE ARE AND SHALL REMAIN THE PROPERTY OF CSV ARCHITECTS. THEY ARE NOT TO BE USED BY THE

CLIENT ON OTHER PROJECTS OR ON EXTENSIONS TO THIS PROJECT WITHOUT THE WRITTEN

3. THIS DRAWING IS TO BE READ IN CONJUNCTION WITH ALL OTHER PROJECT DRAWINGS AND

4. DO NOT SCALE DRAWINGS. CONTRACTOR SHALL BE RESPONSIBLE TO VERIFY DIMENSIONS ON SITE. 5. ALL WORK SHALL BE IN ACCORDANCE WITH THE

ONTARIO BUILDING CODE AND ALL SUPPLEMENTS AND APPLICABLE MUNICIPAL REGULATIONS.

URBAN DEVELOPMENTS

254 Argyle Avenue, Ottawa, Ontario

EF / IK

As indicated

DH

DATE PRINTED: 2025-06-17 7:48:08 AM

REV DATE ISSUE

CONSENT OF CSV ARCHITECTS.

CONSENT OF CSV ARCHITECTS.

SPECIFICATIONS.

CLIENT

OTTAWA

PROJECT

TITLE

DRAWN:

REV

APPROVED:

ONTARIO, CANADA

254 ARGYLE

**SITE PLAN** 

PROJECT NO: 2023-0250

2. THE DRAWINGS, PRESENTATIONS AND

COMMENT RESPONSE 02

2024.10.25 REISSUED FOR SPC AND REZONING

Suite 200, 240 Michael Cowpland Drive

Ottawa, Ontario, Canada K2M 1P6

613.564.8118

# **CSV** ARCHITECTS


sustainable design · conception écologique

190 O'Connor Street, Suite 100

Ottawa, Ontario,K2P 2R3

DRAWING NO. 5 A100 å

#19175

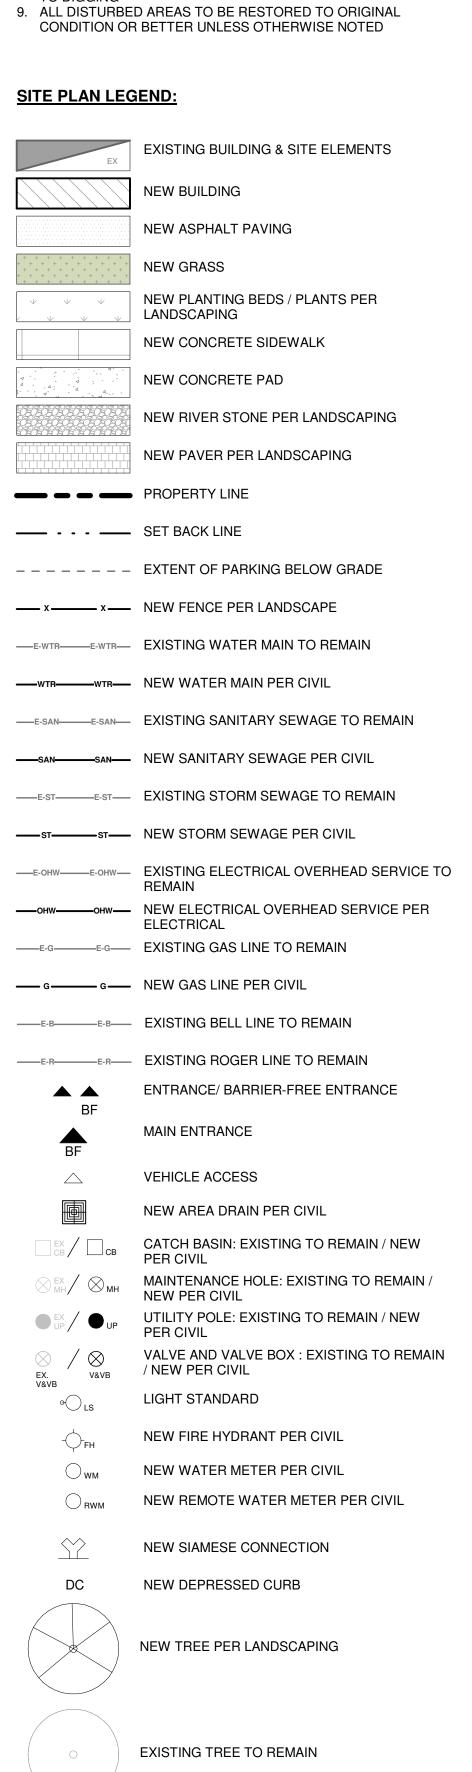


**SITE PLAN GENERAL NOTES:** 

2. DO NOT SCALE THIS DRAWING

www.csv.ca SITE AND REPORT ANY ERRORS AND/OR OMISSIONS TO THE DESIGN CONCEPT ARCHITECT

**EXCAVATION** CONFIRMATION OF UTILITY EXISTENCE AND LOCATION PRIOR

TO DIGGING

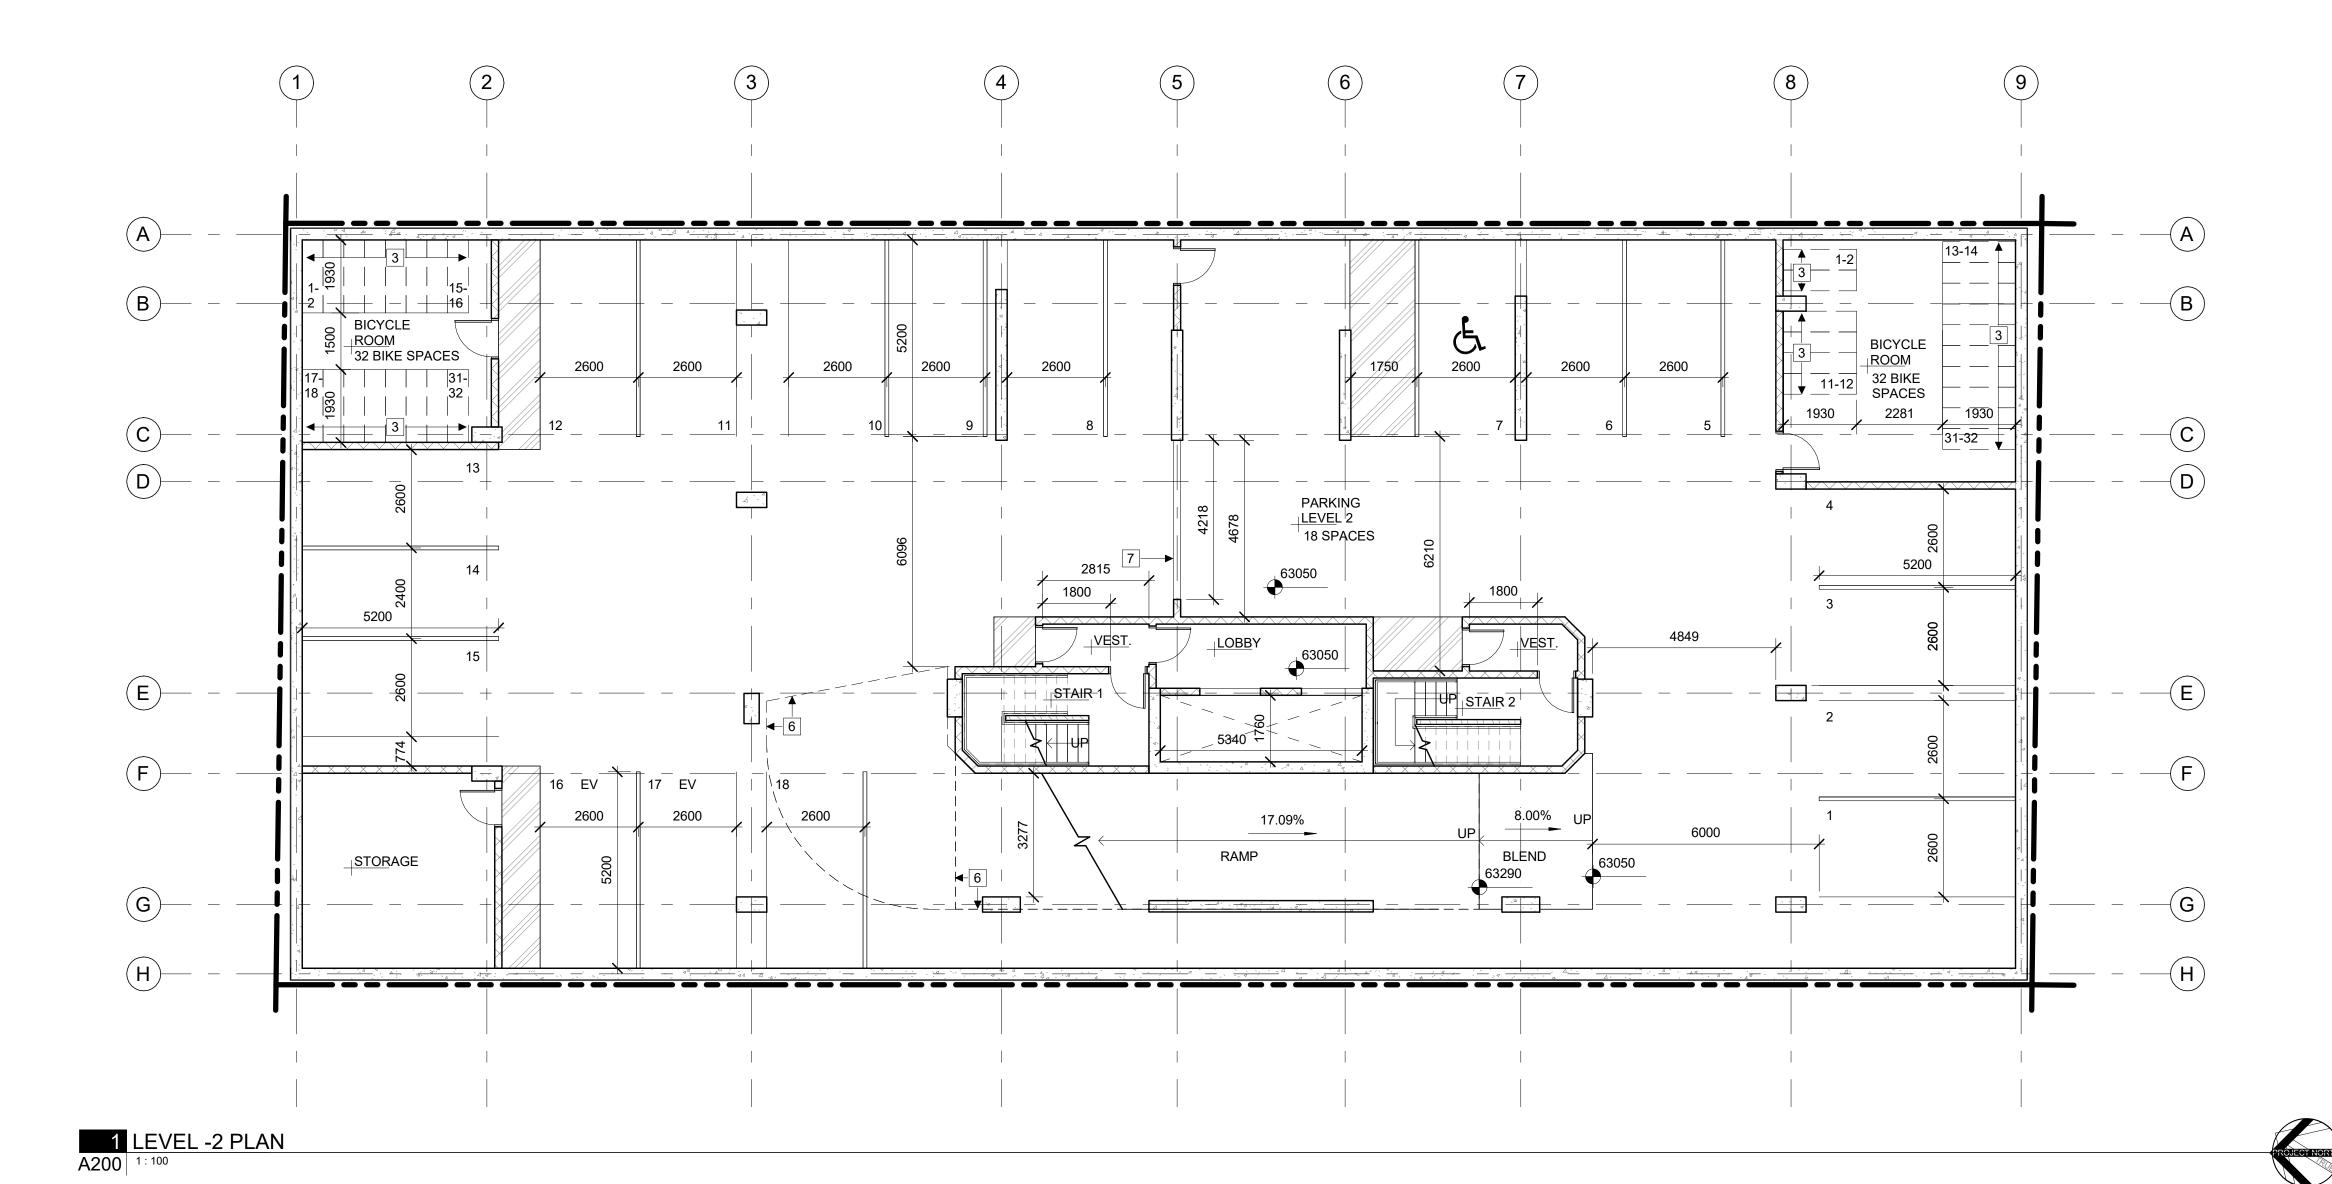

# **GENERAL REFERENCE PLAN NOTES:**

- A. DO NOT SCALE DRAWINGS. B. DIMENSIONS ARE FOR LOCATION ONLY. REFER TO FOUNDATION WALL SIZES.
- C. REFER TO MECHANICAL + ELECTRICAL DRAWINGS FOR DETAILS OF UNDERGROUND SERVICES.
- E. ALL INTERIOR FOUNDATION WALLS + FOOTINGS ARE DIMENSIONED FROM GRIDLINE TO FACE UNLESS OTHERWISE
- G. ALL DOORS ARE DIMENSIONED TO CENTERLINE OF DOOR OPENING, INCLUDING SIDELIGHT FRAMING, UNLESS
- I. ALL INTERIOR DIMENSIONS ARE DIMENSIONED FROM OTHERWISE NOTED.
- J. ALL INTERIOR WALLS ARE DIMENSIONED TO CENTERLINE OF PARTITION, UNLESS OTHERWISE NOTED. CONSIDER OFFSET FROM PARTITION CENTERLINE TO STUD FRAMING CENTER BASED ON WALL ASSEMBLY.
- CONCRETE STRUCTURAL COLUMNS AND WALLS.

- 2 EXTENT OF DROPPED SLAB ABOVE
- 4 EXIT ONLY
- 6 EXTENT OF RAMP ABOVE

NOT IN CONTRACT

5 2025.06.17 ISSUED FOR SPC AND REZONING

ARCHITECT OF RECORD

DESIGN CONCEPT ARCHITECT

613.564.8118

SPICE Design

www.spice.design

(613) 226-4558

(613) 518-8344 www.quasarcg.com

CIVIL ENGINEER NOVATECH

(613) 254-9643

NOVATECH

(613) 254-9643

www.novatech-eng.com

www.novatech-eng.com

LANDSCAPE ARCHITECT

Level 4, 22 Bishopsgate

London, England EC2N 4BQ

STRUCTURAL ENGINEER

Suite 18, 77 Auriga Drive

www.goodevestructural.ca

GOODEVE STRUCTURAL INC.

Ottawa, Ontario, Canada K2E 7Z7

QUASAR CONSULTING GROUP Suite 400, 150 Isabella Street Ottawa, Ontario, Canada K1S 5H3

MECHANICAL + ELECTRICAL ENGINEER

Engineers, Planners & Landscape Architects

Engineers, Planners & Landscape Architects

ON ASSOC

LICENCE

Suite 200, 240 Michael Cowpland Drive Ottawa, Ontario, Canada K2M 1P6

Suite 200, 240 Michael Cowpland Drive Ottawa, Ontario, Canada K2M 1P6

www.csv.ca

**CSV** ARCHITECTS

sustainable design · conception écologique

190 O'Connor Street, Suite 100

Ottawa, Ontario,K2P 2R3

3 2024.10.25 REISSUED FOR SPC AND REZONING 2 2024.08.29 ISSUED FOR SPC AND REZONING REV DATE ISSUE

## NOTES

STAMP

1. OWNERSHIP OF THE COPYRIGHT OF THE DESIGN AND THE WORKS EXECUTED FROM THE DESIGN REMAINS WITH CSV ARCHITECTS, AND MAY NOT BE REPRODUCED IN ANY FORM WITHOUT THE WRITTEN CONSENT OF CSV ARCHITECTS. 2. THE DRAWINGS, PRESENTATIONS AND SPECIFICATIONS AS INSTRUMENTS OF SERVICE ARE AND SHALL REMAIN THE PROPERTY OF CSV ARCHITECTS. THEY ARE NOT TO BE USED BY THE CLIENT ON OTHER PROJECTS OR ON EXTENSIONS TO THIS PROJECT WITHOUT THE WRITTEN CONSENT OF CSV ARCHITECTS.

3. THIS DRAWING IS TO BE READ IN CONJUNCTION WITH ALL OTHER PROJECT DRAWINGS AND SPECIFICATIONS. 4. DO NOT SCALE DRAWINGS. CONTRACTOR SHALL BE RESPONSIBLE TO VERIFY DIMENSIONS ON SITE.

AND APPLICABLE MUNICIPAL REGULATIONS. CLIENT



5. ALL WORK SHALL BE IN ACCORDANCE WITH THE

ONTARIO BUILDING CODE AND ALL SUPPLEMENTS

OTTAWA ONTARIO, CANADA

PROJECT

### 254 ARGYLE

254 Argyle Avenue, Ottawa, Ontario

TITLE

### **LEVEL -2 PLAN**

PROJECT NO: 2023-0250 DRAWN: IK / EF / RK APPROVED: DH

1:100 DATE PRINTED: 2025-05-26 1:37:16 PM

DRAWING NO. 5

A200


- STRUCTURAL DRAWINGS FOR FOOTINGS, COLUMNS AND
- D. ALL EXTERIOR FOUNDATION WALLS ARE DIMENSIONED TO
- EXTERIOR FACE OF ASSEMBLY UNLESS OTHERWISE NOTED.
- NOTED.
- F. ALL WINDOWS ARE DIMENSIONED TO CENTERLINE OF WINDOW OPENING, UNLESS OTHERWISE NOTED.
- OTHERWISE NOTED H. ALL EXTERIOR WALLS ARE DIMENSIONED TO THE EXTERIOR
- FINISHED FACE, UNLESS NOTED OTHERWISE.
- INTERIOR FINISHED FACES OF EXTERIOR WALLS, UNLESS
- K. ENSURE 25mm MINIMUM THICKNESS OF CONCRETE COVER OVER VERTICAL STEEL REINFORCEMENT TO ALL REINFORCED

#### REFERENCE PLAN KEYNOTES:

- 1 CISTERN OVERFLOW AND HATCH / VENTED CISTERN LID
- 3 DOUBLE TEAR BICYCLE STORAGE SPACES
- 5 EXTENT OF FOUNDATION WALL BELOW
- 7 DROP-DOWN FIRE DOOR

#### REFERENCE PLAN LEGEND:

PAINTED PARKING ISLAND

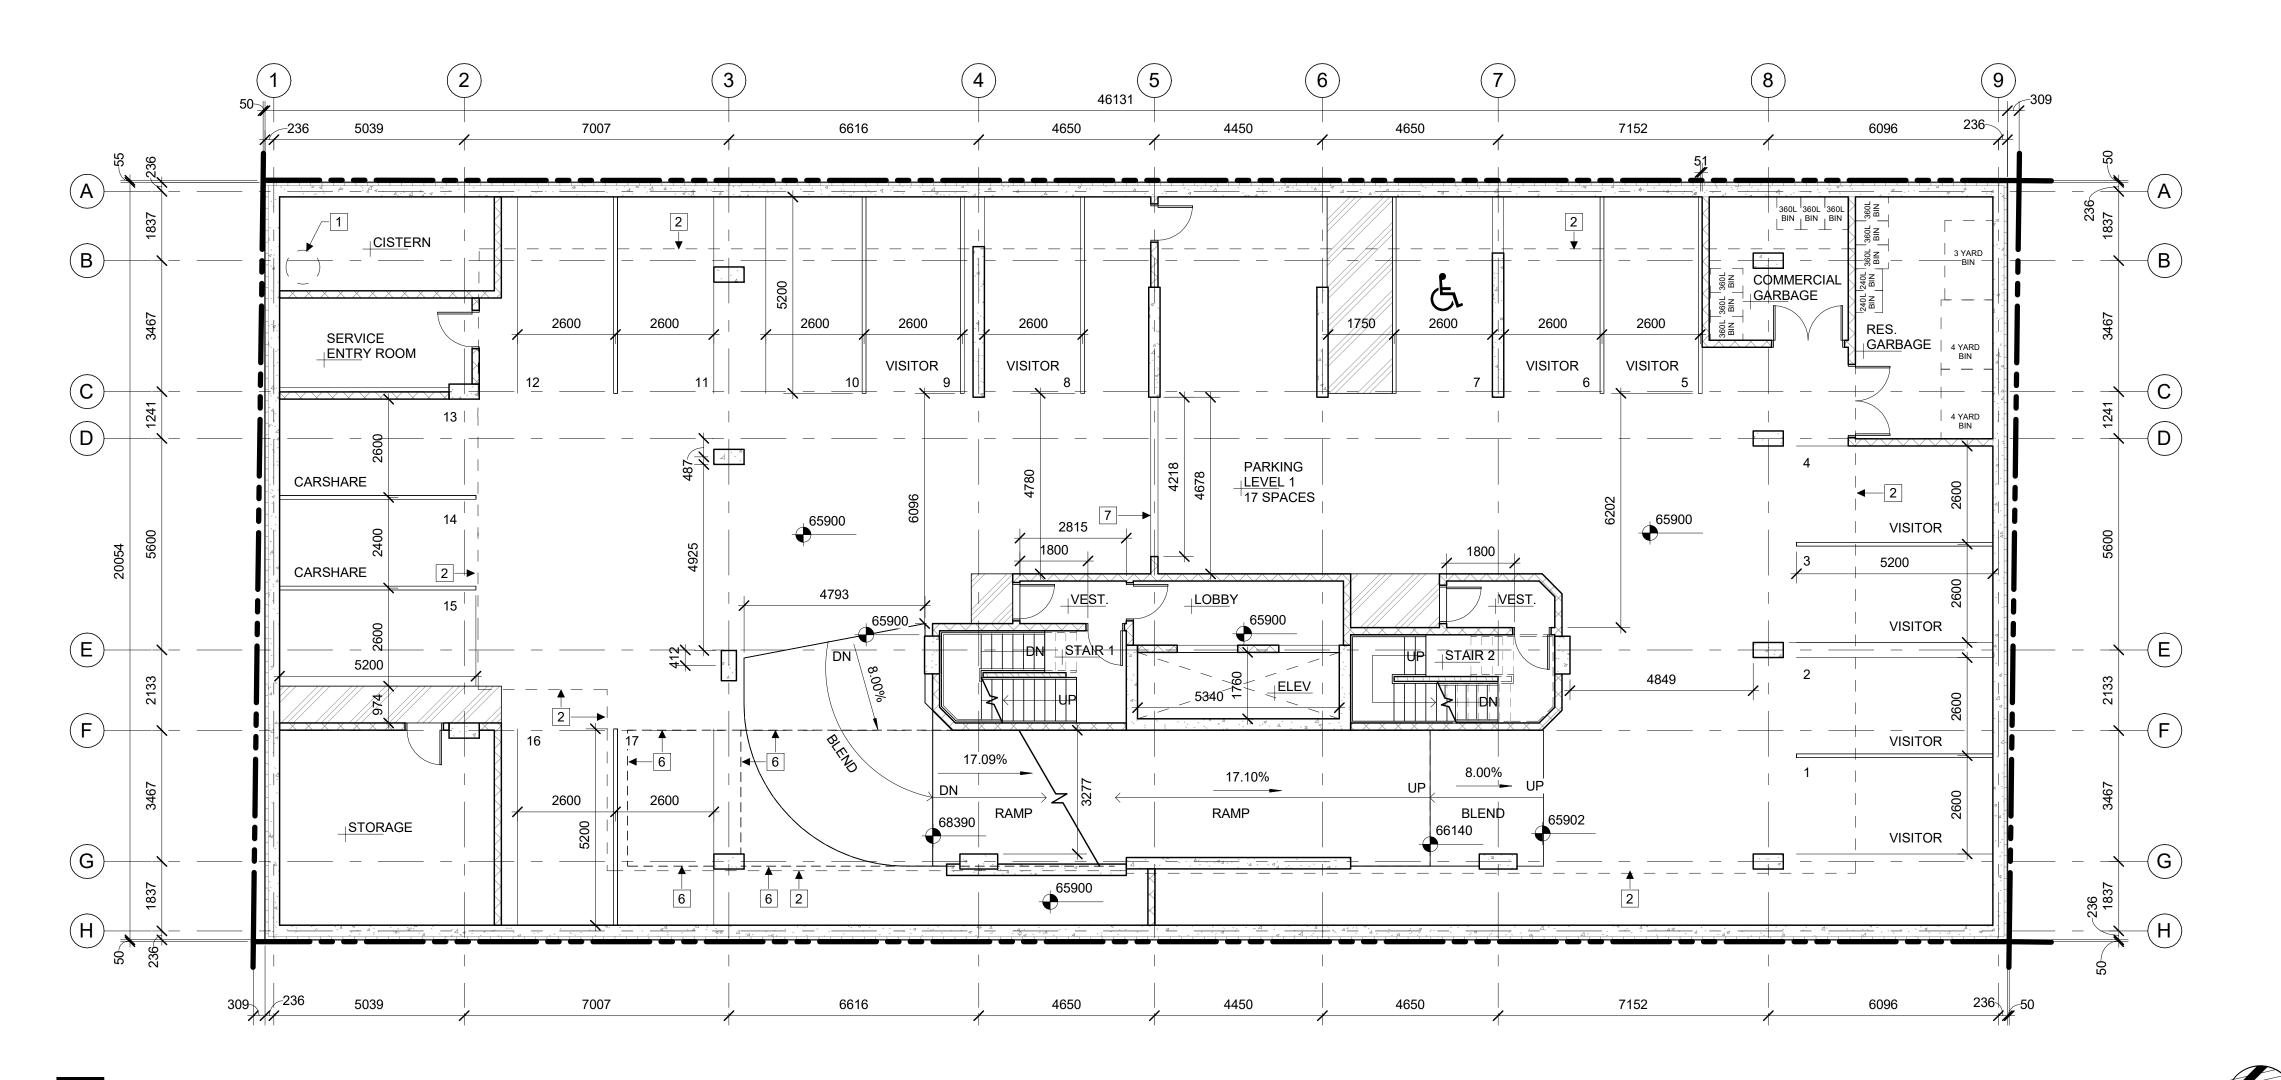

1 LEVEL -1 PLAN A201 1:100 3989 37059 3473 (B)STUDIO/ 1 BEDROOM  $\bigcirc$ D 1241 3 BEDROOMS |VESTIBULE LOUNGE/ WINE BAR CO-WORKING 69400 UNIT B 2 BEDROOMS 22 (L1) + 56(L2) = 78 m2LELEV 5340 69400 3 BEDROOMS 28(L1) + 51(L2) = 79 m2BIKE PARK/ 、BIKE \_<u>WOR</u>KSPACE 17.10% 8.00% 1930 + 8 69400 20 BIKE BLEND RAMP SPACES  $\overline{\mathsf{G}}$ 3790 33300 3473

7152

6096

2 GROUND FLOOR REFERENCE PLAN A201 1:100

5039

7007

6616

#### **GENERAL REFERENCE PLAN NOTES:**


- A. DO NOT SCALE DRAWINGS. B. DIMENSIONS ARE FOR LOCATION ONLY. REFER TO STRUCTURAL DRAWINGS FOR FOOTINGS, COLUMNS AND FOUNDATION WALL SIZES.
- C. REFER TO MECHANICAL + ELECTRICAL DRAWINGS FOR DETAILS OF UNDERGROUND SERVICES. D. ALL EXTERIOR FOUNDATION WALLS ARE DIMENSIONED TO
- EXTERIOR FACE OF ASSEMBLY UNLESS OTHERWISE NOTED. E. ALL INTERIOR FOUNDATION WALLS + FOOTINGS ARE
- DIMENSIONED FROM GRIDLINE TO FACE UNLESS OTHERWISE F. ALL WINDOWS ARE DIMENSIONED TO CENTERLINE OF
- WINDOW OPENING, UNLESS OTHERWISE NOTED. G. ALL DOORS ARE DIMENSIONED TO CENTERLINE OF DOOR
- OPENING, INCLUDING SIDELIGHT FRAMING, UNLESS OTHERWISE NOTED H. ALL EXTERIOR WALLS ARE DIMENSIONED TO THE EXTERIOR
- FINISHED FACE, UNLESS NOTED OTHERWISE.
- ALL INTERIOR DIMENSIONS ARE DIMENSIONED FROM INTERIOR FINISHED FACES OF EXTERIOR WALLS, UNLESS OTHERWISE NOTED. J. ALL INTERIOR WALLS ARE DIMENSIONED TO CENTERLINE OF
- PARTITION, UNLESS OTHERWISE NOTED. CONSIDER OFFSET FROM PARTITION CENTERLINE TO STUD FRAMING CENTER BASED ON WALL ASSEMBLY. K. ENSURE 25mm MINIMUM THICKNESS OF CONCRETE COVER OVER VERTICAL STEEL REINFORCEMENT TO ALL REINFORCED

CONCRETE STRUCTURAL COLUMNS AND WALLS.

#### **REFERENCE PLAN KEYNOTES:**

- 1 CISTERN OVERFLOW AND HATCH / VENTED CISTERN LID
- 2 EXTENT OF DROPPED SLAB ABOVE
- 3 DOUBLE TEAR BICYCLE STORAGE SPACES
- 4 EXIT ONLY
- 5 EXTENT OF FOUNDATION WALL BELOW
- 6 EXTENT OF RAMP ABOVE
- 7 DROP-DOWN FIRE DOOR

#### REFERENCE PLAN LEGEND:

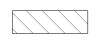

NOT IN CONTRACT



PAINTED PARKING ISLAND

ARCHITECT OF RECORD

# **CSV** ARCHITECTS

sustainable design · conception écologique

190 O'Connor Street, Suite 100 Ottawa, Ontario,K2P 2R3 www.csv.ca

DESIGN CONCEPT ARCHITECT

SPICE Design Level 4, 22 Bishopsgate London, England EC2N 4BQ www.spice.design

STRUCTURAL ENGINEER GOODEVE STRUCTURAL INC. Suite 18, 77 Auriga Drive Ottawa, Ontario, Canada K2E 7Z7 (613) 226-4558 www.goodevestructural.ca


MECHANICAL + ELECTRICAL ENGINEER QUASAR CONSULTING GROUP Suite 400, 150 Isabella Street Ottawa, Ontario, Canada K1S 5H3 (613) 518-8344 www.quasarcg.com

CIVIL ENGINEER NOVATECH

Engineers, Planners & Landscape Architects Suite 200, 240 Michael Cowpland Drive Ottawa, Ontario, Canada K2M 1P6 (613) 254-9643 www.novatech-eng.com

LANDSCAPE ARCHITECT NOVATECH Engineers, Planners & Landscape Architects Suite 200, 240 Michael Cowpland Drive

Ottawa, Ontario, Canada K2M 1P6 (613) 254-9643 www.novatech-eng.com

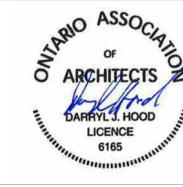

STAMP

- 5 2025.06.17 ISSUED FOR SPC AND REZONING COMMENT RESPONSE 02 4 2024.12.20 ISSUED FOR SPC AND REZONING
- 3 2024.10.25 REISSUED FOR SPC AND REZONING 2 2024.08.29 ISSUED FOR SPC AND REZONING REV DATE ISSUE

NOTES

1. OWNERSHIP OF THE COPYRIGHT OF THE DESIGN AND THE WORKS EXECUTED FROM THE DESIGN REMAINS WITH CSV ARCHITECTS, AND MAY NOT BE REPRODUCED IN ANY FORM WITHOUT THE WRITTEN CONSENT OF CSV ARCHITECTS. 2. THE DRAWINGS, PRESENTATIONS AND SPECIFICATIONS AS INSTRUMENTS OF SERVICE ARE AND SHALL REMAIN THE PROPERTY OF CSV ARCHITECTS. THEY ARE NOT TO BE USED BY THE CLIENT ON OTHER PROJECTS OR ON EXTENSIONS
TO THIS PROJECT WITHOUT THE WRITTEN CONSENT OF CSV ARCHITECTS. 3. THIS DRAWING IS TO BE READ IN CONJUNCTION WITH ALL OTHER PROJECT DRAWINGS AND SPECIFICATIONS. 4. DO NOT SCALE DRAWINGS. CONTRACTOR SHALL BE RESPONSIBLE TO VERIFY DIMENSIONS ON SITE.

5. ALL WORK SHALL BE IN ACCORDANCE WITH THE ONTARIO BUILDING CODE AND ALL SUPPLEMENTS

AND APPLICABLE MUNICIPAL REGULATIONS. CLIENT



OTTAWA ONTARIO, CANADA

PROJECT

254 ARGYLE

254 Argyle Avenue, Ottawa, Ontario

TITLE


# **LEVEL -1 AND GROUND FLOOR**

**PLANS** PROJECT NO: 2023-0250 DRAWN: APPROVED:

IK / EF DH 1:100 DATE PRINTED: 2025-05-26 1:37:16 PM

DRAWING NO. 3

A201

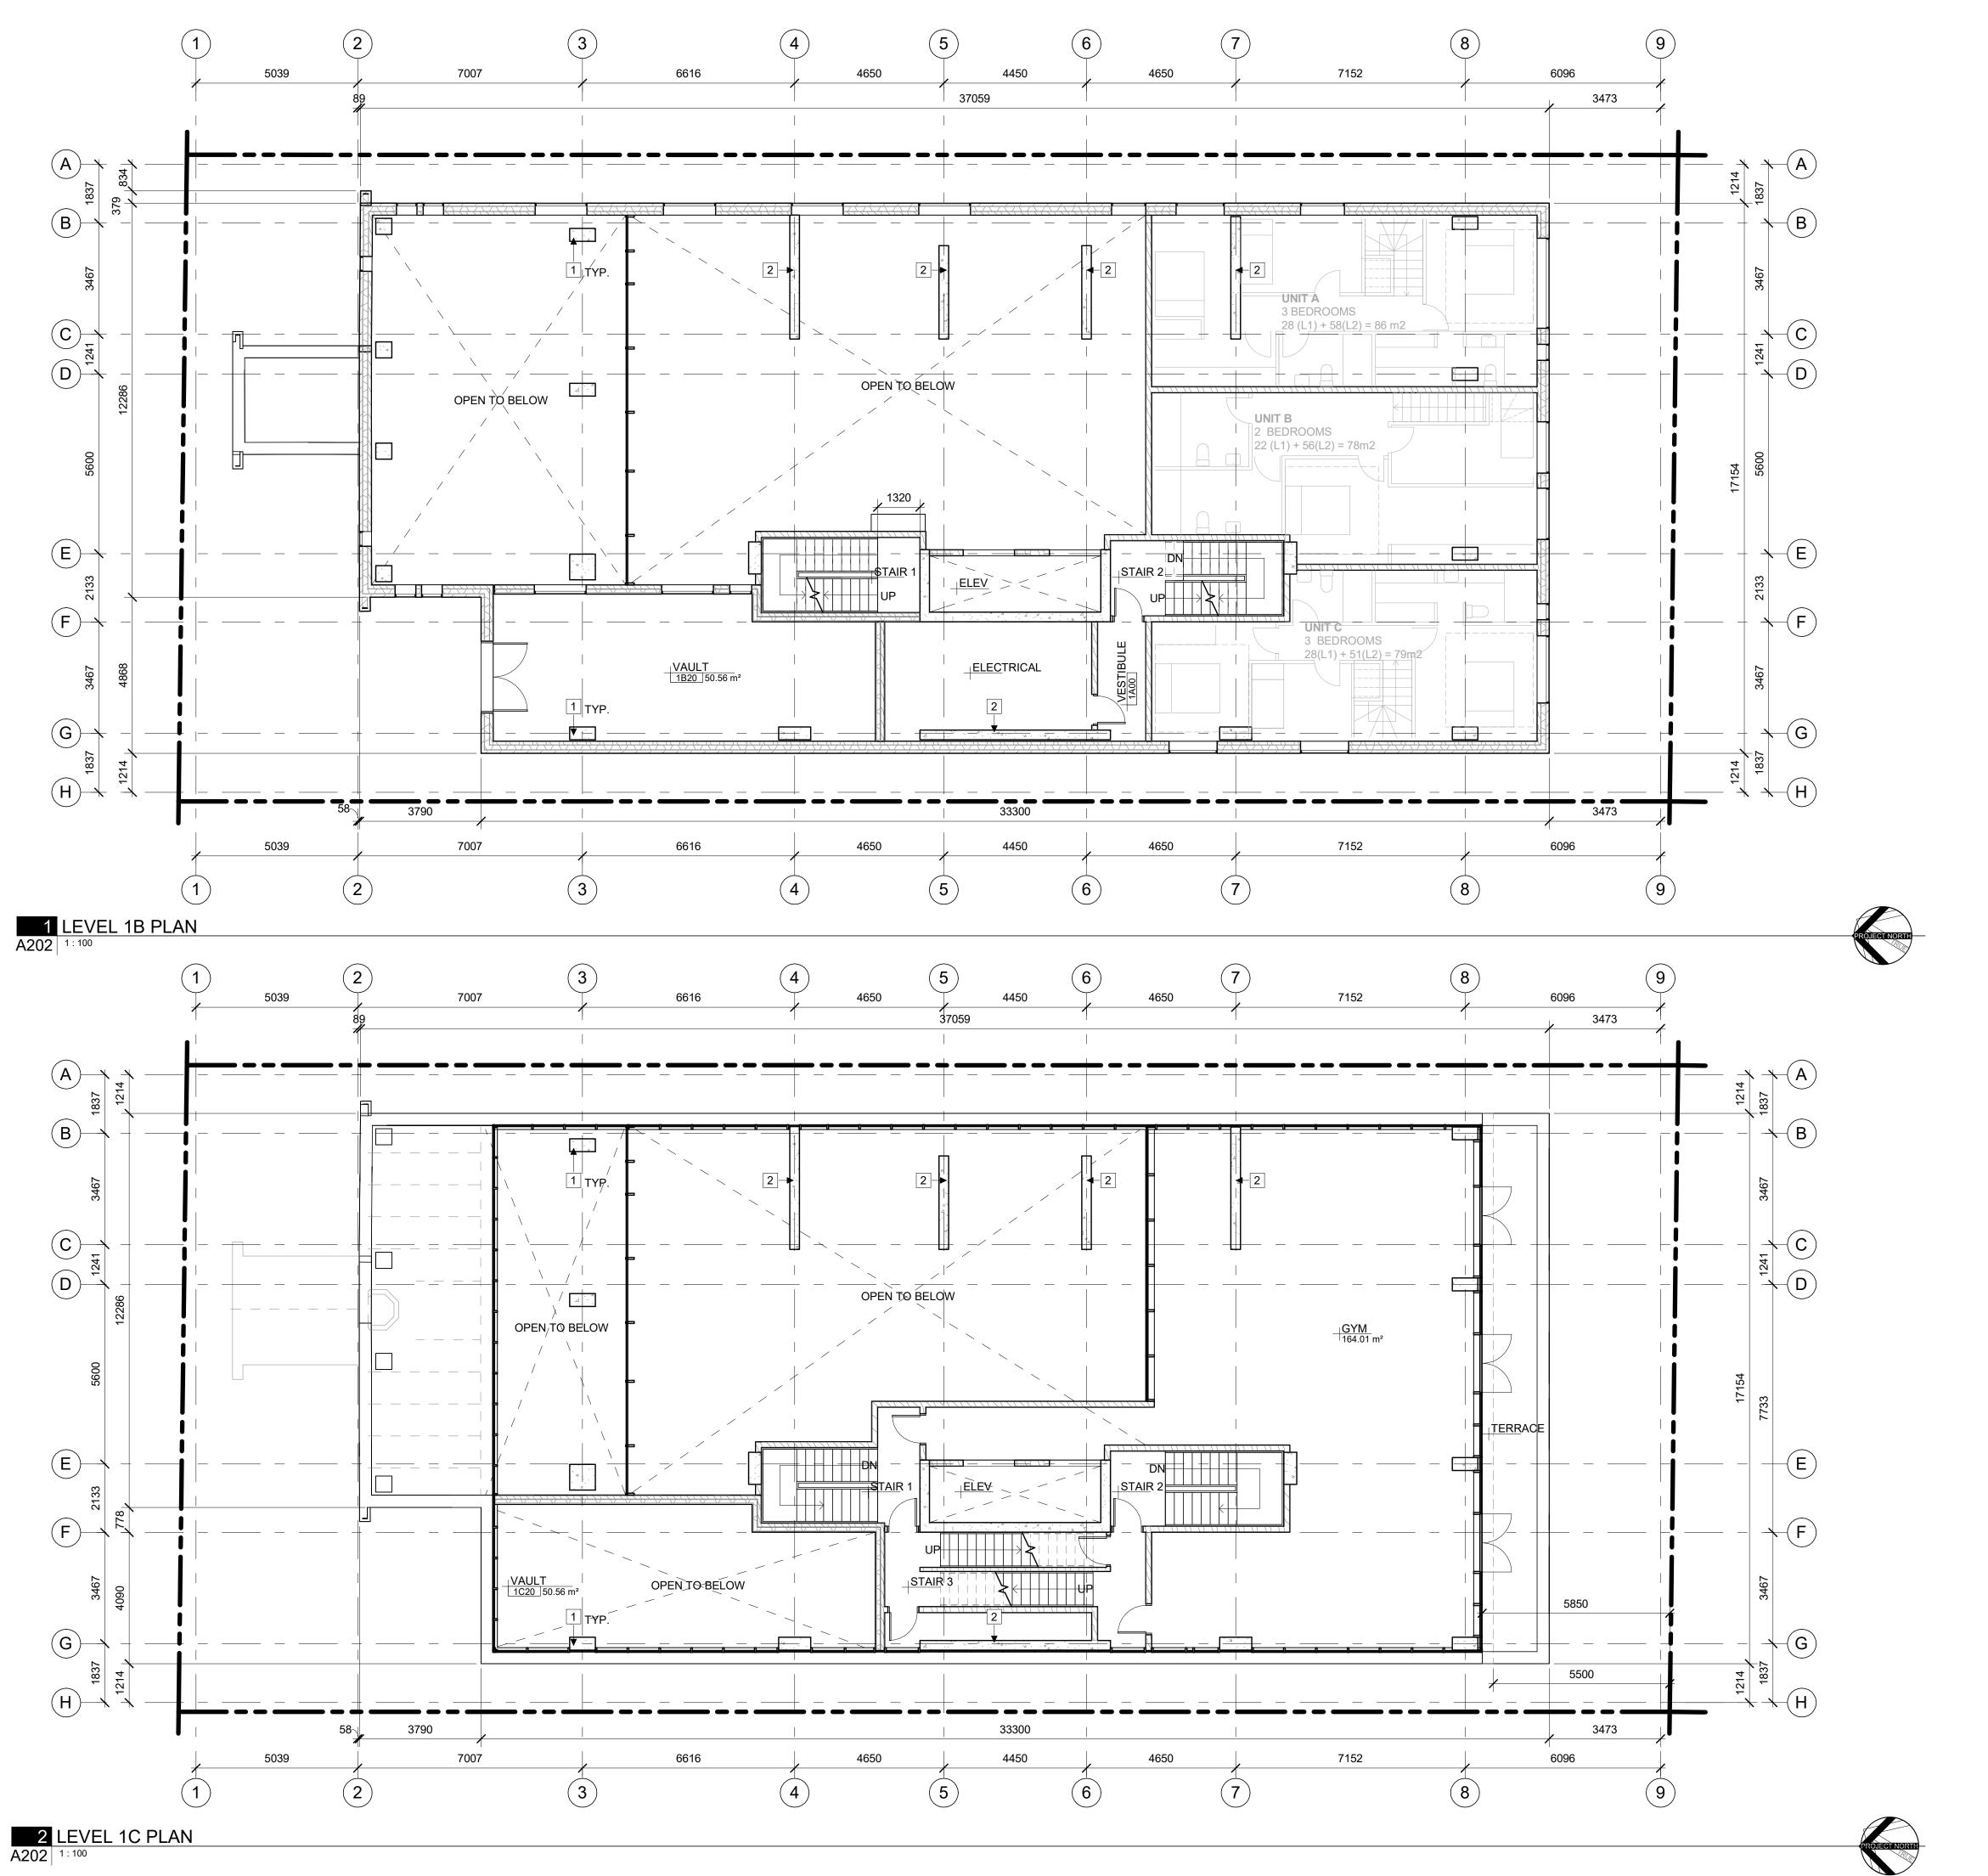

#### **GENERAL REFERENCE PLAN NOTES:**

- A. DO NOT SCALE DRAWINGS. B. DIMENSIONS ARE FOR LOCATION ONLY. REFER TO STRUCTURAL DRAWINGS FOR FOOTINGS, COLUMNS AND
- FOUNDATION WALL SIZES. C. REFER TO MECHANICAL + ELECTRICAL DRAWINGS FOR DETAILS OF UNDERGROUND SERVICES.
- D. ALL WINDOWS ARE DIMENSIONED TO CENTERLINE OF WINDOW OPENING, UNLESS OTHERWISE NOTED. E. ALL DOORS ARE DIMENSIONED TO CENTERLINE OF DOOR
- OTHERWISE NOTED F. ALL EXTERIOR WALLS ARE DIMENSIONED TO THE EXTERIOR

OPENING, INCLUDING SIDELIGHT FRAMING, UNLESS

- FINISHED FACE, UNLESS NOTED OTHERWISE. G. ALL INTERIOR DIMENSIONS ARE DIMENSIONED FROM
- INTERIOR FINISHED FACES OF EXTERIOR WALLS, UNLESS OTHERWISE NOTED. H. ALL INTERIOR WALLS ARE DIMENSIONED TO CENTERLINE OF
- PARTITION, UNLESS OTHERWISE NOTED. CONSIDER OFFSET FROM PARTITION CENTERLINE TO STUD FRAMING CENTER BASED ON WALL ASSEMBLY. ENSURE 25mm MINIMUM THICKNESS OF CONCRETE COVER OVER VERTICAL STEEL REINFORCEMENT TO ALL REINFORCED

CONCRETE STRUCTURAL COLUMNS AND WALLS.

#### **REFERENCE PLAN KEYNOTES:**

- 1 COLUMN PER STRUCTURAL
- 2 WALL PER STRUCTURAL

### REFERENCE PLAN LEGEND:

NOT IN CONTRACT

ARCHITECT OF RECORD

# **CSV** ARCHITECTS

sustainable design · conception écologique

613.564.8118 190 O'Connor Street, Suite 100 Ottawa, Ontario,K2P 2R3 www.csv.ca

DESIGN CONCEPT ARCHITECT

SPICE Design Level 4, 22 Bishopsgate London, England EC2N 4BQ www.spice.design

STRUCTURAL ENGINEER GOODEVE STRUCTURAL INC. Suite 18, 77 Auriga Drive Ottawa, Ontario, Canada K2E 7Z7 (613) 226-4558 www.goodevestructural.ca


MECHANICAL + ELECTRICAL ENGINEER QUASAR CONSULTING GROUP Suite 400, 150 Isabella Street Ottawa, Ontario, Canada K1S 5H3 (613) 518-8344 www.quasarcg.com

CIVIL ENGINEER NOVATECH

www.novatech-eng.com

Engineers, Planners & Landscape Architects Suite 200, 240 Michael Cowpland Drive Ottawa, Ontario, Canada K2M 1P6 (613) 254-9643 www.novatech-eng.com

LANDSCAPE ARCHITECT NOVATECH Engineers, Planners & Landscape Architects Suite 200, 240 Michael Cowpland Drive Ottawa, Ontario, Canada K2M 1P6 (613) 254-9643

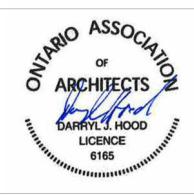

STAMP

5 2025.06.17 ISSUED FOR SPC AND REZONING COMMENT RESPONSE 02

2 2024.08.29 ISSUED FOR SPC AND REZONING 1 2024.05.08 ISSUED FOR PHASE 2 PRECONSULT

REV DATE ISSUE

NOTES

1. OWNERSHIP OF THE COPYRIGHT OF THE DESIGN AND THE WORKS EXECUTED FROM THE DESIGN REMAINS WITH CSV ARCHITECTS, AND MAY NOT BE REPRODUCED IN ANY FORM WITHOUT THE WRITTEN CONSENT OF CSV ARCHITECTS. 2. THE DRAWINGS, PRESENTATIONS AND SPECIFICATIONS AS INSTRUMENTS OF SERVICE ARE AND SHALL REMAIN THE PROPERTY OF CSV ARCHITECTS. THEY ARE NOT TO BE USED BY THE CLIENT ON OTHER PROJECTS OR ON EXTENSIONS TO THIS PROJECT WITHOUT THE WRITTEN CONSENT OF CSV ARCHITECTS.

3. THIS DRAWING IS TO BE READ IN CONJUNCTION WITH ALL OTHER PROJECT DRAWINGS AND SPECIFICATIONS. 4. DO NOT SCALE DRAWINGS. CONTRACTOR SHALL BE RESPONSIBLE TO VERIFY DIMENSIONS ON SITE.

5. ALL WORK SHALL BE IN ACCORDANCE WITH THE ONTARIO BUILDING CODE AND ALL SUPPLEMENTS

AND APPLICABLE MUNICIPAL REGULATIONS. CLIENT



OTTAWA ONTARIO, CANADA

PROJECT

254 ARGYLE

254 Argyle Avenue, Ottawa, Ontario

TITLE


# **LEVEL 1B AND LEVEL** 1C PLANS

PROJECT NO: 2023-0250 DRAWN: IK / EF / RK APPROVED: DH 1:100

DATE PRINTED: 2025-05-26 1:37:17 PM

A202

DRAWING NO. 3

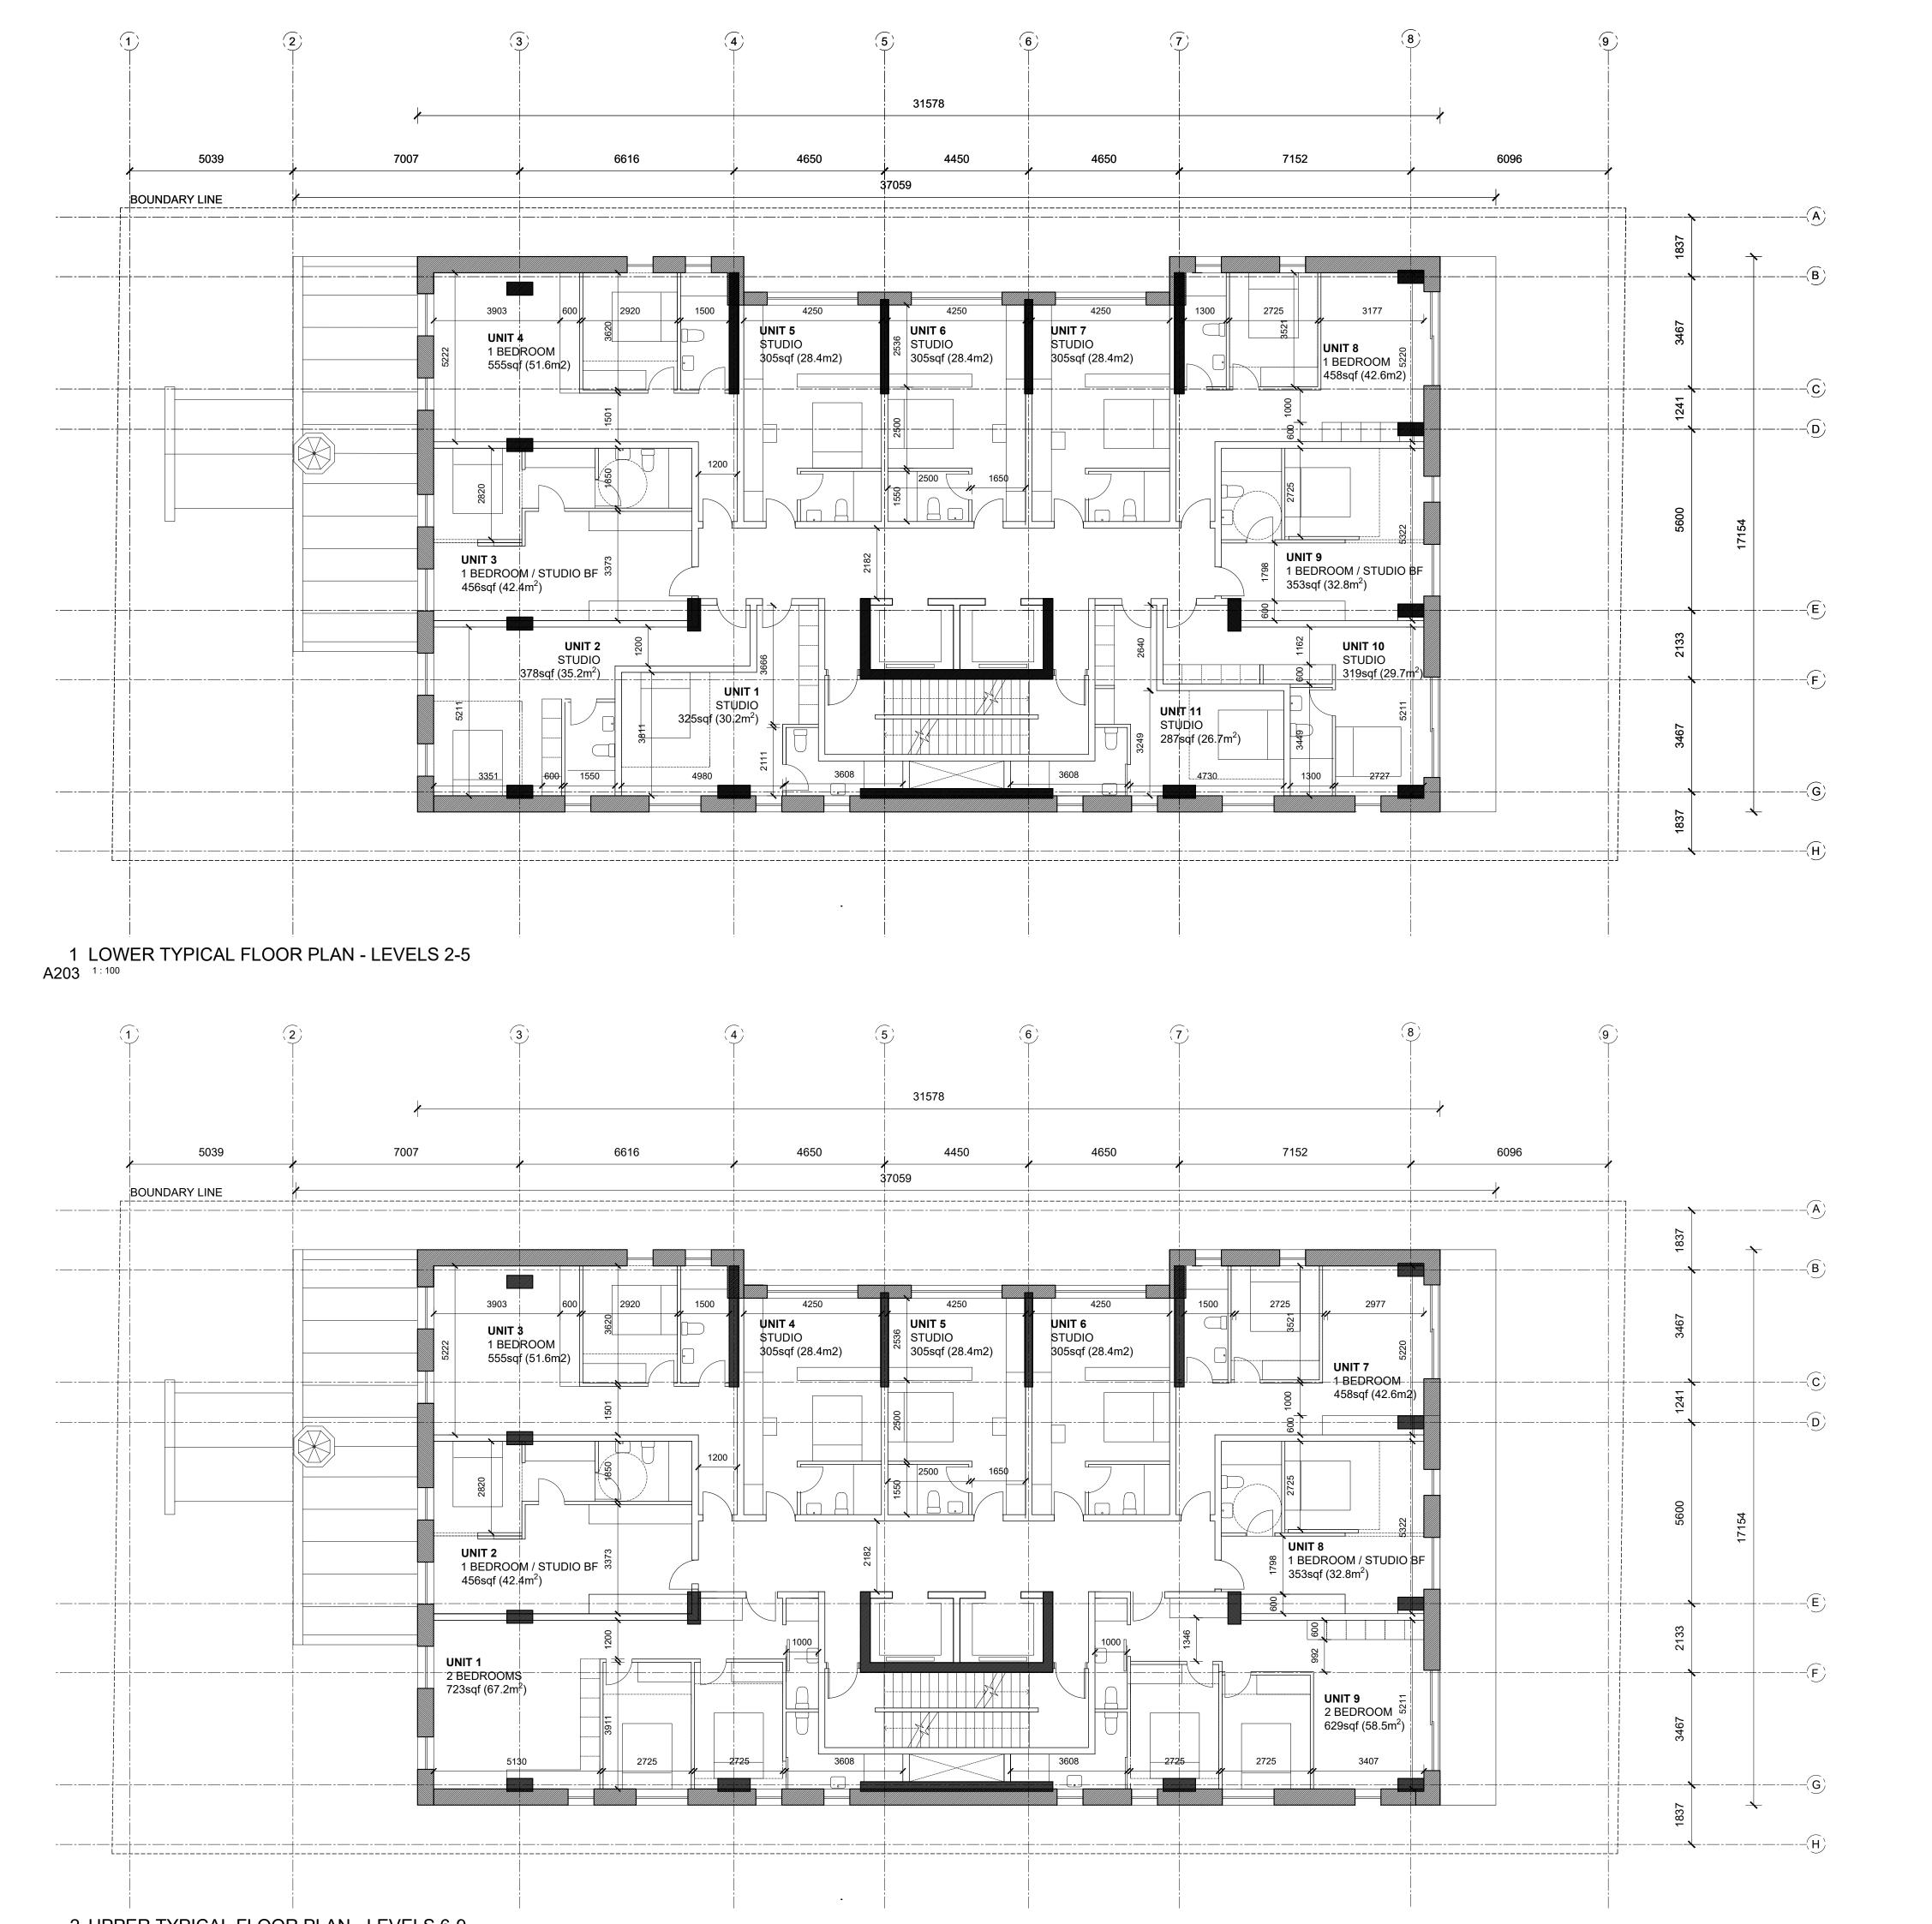

ARCHITECT OF RECORD

# **CSV** ARCHITECTS

sustainable design · conception écologique

613.564.8118 190 O'Connor Street, Suite 100 www.csv.ca Ottawa, Ontario, K2P 2R3

DESIGN CONCEPT ARCHITECT



SPICE Design Level 4, 22 Bishopsgate London, England EC2N 4BQ www.spice.design

> STRUCTURAL ENGINEER GOODEVE STRUCTURAL INC. Suite 18, 77 Auriga Drive Ottawa, Ontario, Canada K2E 7Z7 (613) 226-4558 www.goodevestructural.ca

MECHANICAL + ELECTRICAL ENGINEER QUASAR CONSULTING GROUP Suite 400, 150 Isabella Street Ottawa, Ontario, Canada K1S 5H3 (613) 518-8344 www.quasarcg.com

CIVIL ENGINEER NOVATECH Engineers, Planners & Landscape Architects Suite 200, 240 Michael Cowpland Drive Ottawa, Ontario, Canada K2M 1P6 (613) 254-9643 www.novatech-eng.com

LANDSCAPE ARCHITECT NOVATECH Engineers, Planners & Landscape Architects Suite 200, 240 Michael Cowpland Drive Ottawa, Ontario, Canada K2M 1P6 (613) 254-9643 www.novatech-eng.com

#### STAMP

5 2025.06.17 ISSUED FOR SPC AND REZONING COMMENT RESPONSE 02 3 2024.10.25 REISSUED FOR SPC AND REZONING 2 2024.08.29 ISSUED FOR SPC AND REZONING 1 2024.04.29 ISSUED FOR PHASE 2 PRECONSULT REV DATE ISSUE

# NOTES

1. OWNERSHIP OF THE COPYRIGHT OF THE DESIGN 1. OWNERSHIP OF THE COPYRIGHT OF THE DESIGN AND THE WORKS EXECUTED FROM THE DESIGN REMAINS WITH CSV ARCHITECTS, AND MAY NOT BE REPRODUCED IN ANY FORM WITHOUT THE WRITTEN CONSENT OF CSV ARCHITECTS.

2. THE DRAWINGS, PRESENTATIONS AND SPECIFICATIONS AS INSTRUMENTS OF SERVICE ARE AND SHALL REMAIN THE PROBERTY OF CSV. ARE AND SHALL REMAIN THE PROPERTY OF CSV ARCHITECTS. THEY ARE NOT TO BE USED BY THE CLIENT ON OTHER PROJECTS OR ON EXTENSIONS TO THIS PROJECT WITHOUT THE WRITTEN CONSENT OF CSV ARCHITECTS. 3. THIS DRAWING IS TO BE READ IN CONJUNCTION WITH ALL OTHER PROJECT DRAWINGS AND SPECIFICATIONS. 4. DO NOT SCALE DRAWINGS. CONTRACTOR SHALL BE RESPONSIBLE TO VERIFY DIMENSIONS ON SITE.

5. ALL WORK SHALL BE IN ACCORDANCE WITH THE ONTARIO BUILDING CODE AND ALL SUPPLEMENTS AND APPLICABLE MUNICIPAL REGULATIONS.

CLIENT



OTTAWA ONTARIO, CANADA

PROJECT

### **254 ARGYLE**

254 Argyle, Ottawa, Ontario


TITLE

## LEVELS 2-9 **FLOOR PLANS**

PROJECT NO: 2023-0250 DRAWN: SPICE APPROVED: SPICE SCALE: 1:100

DRAWING NO. 🕏

A203 8

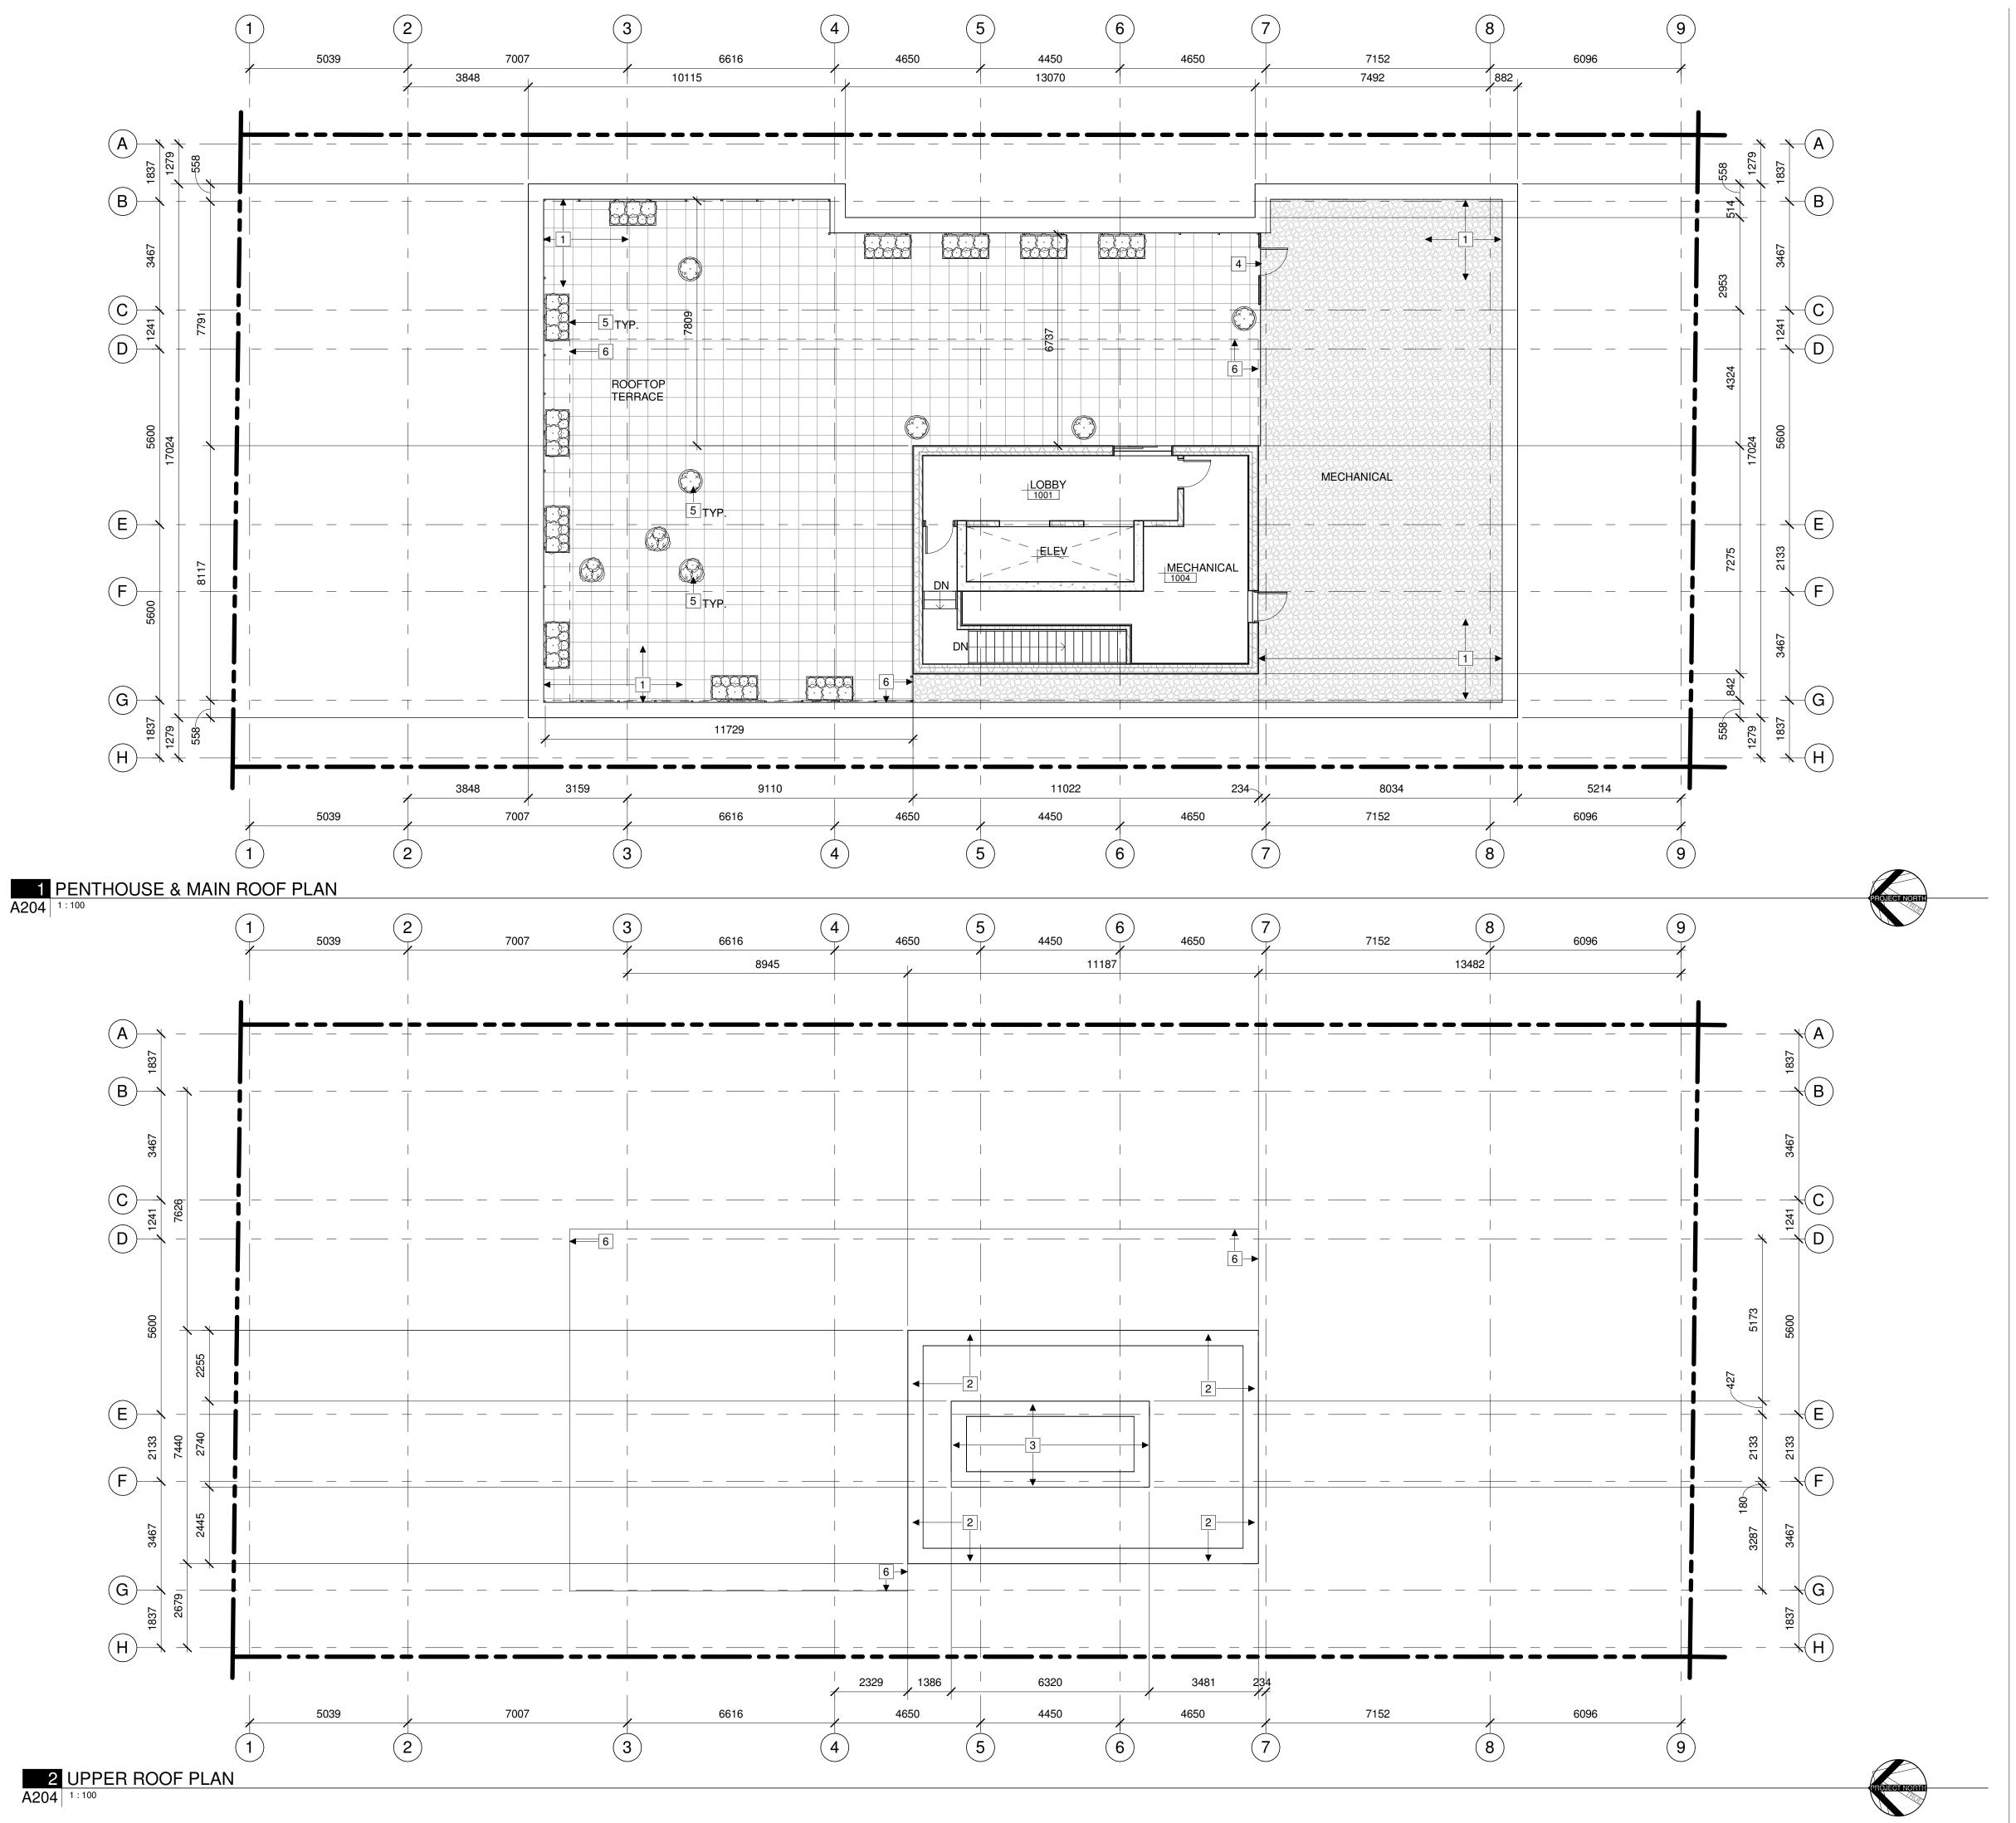

#### **GENERAL REFERENCE PLAN NOTES:**

- A. DO NOT SCALE DRAWINGS. B. DIMENSIONS ARE FOR LOCATION ONLY. REFER TO STRUCTURAL DRAWINGS FOR FOOTINGS, COLUMNS AND FOUNDATION WALL SIZES.
- C. REFER TO MECHANICAL + ELECTRICAL DRAWINGS FOR DETAILS OF UNDERGROUND SERVICES.
- D. ALL WINDOWS ARE DIMENSIONED TO CENTERLINE OF WINDOW OPENING, UNLESS OTHERWISE NOTED. E. ALL DOORS ARE DIMENSIONED TO CENTERLINE OF DOOR
- OPENING, INCLUDING SIDELIGHT FRAMING, UNLESS OTHERWISE NOTED F. ALL EXTERIOR WALLS ARE DIMENSIONED TO THE EXTERIOR
- FINISHED FACE, UNLESS NOTED OTHERWISE. G. ALL INTERIOR DIMENSIONS ARE DIMENSIONED FROM
- INTERIOR FINISHED FACES OF EXTERIOR WALLS, UNLESS OTHERWISE NOTED.
- H. ALL INTERIOR WALLS ARE DIMENSIONED TO CENTERLINE OF PARTITION, UNLESS OTHERWISE NOTED. CONSIDER OFFSET FROM PARTITION CENTERLINE TO STUD FRAMING CENTER BASED ON WALL ASSEMBLY.
- ENSURE 25mm MINIMUM THICKNESS OF CONCRETE COVER OVER VERTICAL STEEL REINFORCEMENT TO ALL REINFORCED CONCRETE STRUCTURAL COLUMNS AND WALLS.

### **REFERENCE PLAN KEYNOTES:**

- 1 LOWER LEVEL ROOF
- 2 UPPER ROOF
- 3 ELEVATOR SHAFT ROOF
- 4 ROOF SCREEN AND GATE
- 5 PLANTS IN PLANTER, PER LANDSCAPE 6 EXTENT OF PERGOLA

### REFERENCE PLAN LEGEND:



NOT IN CONTRACT

ARCHITECT OF RECORD

# **CSV** ARCHITECTS

sustainable design · conception écologique

190 O'Connor Street, Suite 100 613.564.8118 Ottawa, Ontario,K2P 2R3 www.csv.ca

DESIGN CONCEPT ARCHITECT

SPICE Design Level 4, 22 Bishopsgate London, England EC2N 4BQ www.spice.design

STRUCTURAL ENGINEER GOODEVE STRUCTURAL INC. Suite 18, 77 Auriga Drive Ottawa, Ontario, Canada K2E 7Z7 (613) 226-4558 www.goodevestructural.ca

MECHANICAL + ELECTRICAL ENGINEER QUASAR CONSULTING GROUP Suite 400, 150 Isabella Street Ottawa, Ontario, Canada K1S 5H3 (613) 518-8344 www.quasarcg.com

CIVIL ENGINEER NOVATECH

Engineers, Planners & Landscape Architects Suite 200, 240 Michael Cowpland Drive Ottawa, Ontario, Canada K2M 1P6 (613) 254-9643 www.novatech-eng.com

LANDSCAPE ARCHITECT NOVATECH

Engineers, Planners & Landscape Architects Suite 200, 240 Michael Cowpland Drive Ottawa, Ontario, Canada K2M 1P6 (613) 254-9643 www.novatech-eng.com



STAMP

- 5 2025.06.17 ISSUED FOR SPC AND REZONING COMMENT RESPONSE 02 4 2024.12.20 ISSUED FOR SPC AND REZONING
- 3 2024.10.25 REISSUED FOR SPC AND REZONING
- 2 2024.08.29 ISSUED FOR SPC AND REZONING REV DATE ISSUE

NOTES

1. OWNERSHIP OF THE COPYRIGHT OF THE DESIGN AND THE WORKS EXECUTED FROM THE DESIGN REMAINS WITH CSV ARCHITECTS, AND MAY NOT BE REPRODUCED IN ANY FORM WITHOUT THE WRITTEN CONSENT OF CSV ARCHITECTS. 2. THE DRAWINGS, PRESENTATIONS AND SPECIFICATIONS AS INSTRUMENTS OF SERVICE ARE AND SHALL REMAIN THE PROPERTY OF CSV ARCHITECTS. THEY ARE NOT TO BE USED BY THE CLIENT ON OTHER PROJECTS OR ON EXTENSIONS TO THIS PROJECT WITHOUT THE WRITTEN CONSENT OF CSV ARCHITECTS. 3. THIS DRAWING IS TO BE READ IN CONJUNCTION WITH ALL OTHER PROJECT DRAWINGS AND SPECIFICATIONS. 4. DO NOT SCALE DRAWINGS. CONTRACTOR SHALL BE RESPONSIBLE TO VERIFY DIMENSIONS ON SITE. 5. ALL WORK SHALL BE IN ACCORDANCE WITH THE

ONTARIO BUILDING CODE AND ALL SUPPLEMENTS

AND APPLICABLE MUNICIPAL REGULATIONS. CLIENT



OTTAWA ONTARIO, CANADA

PROJECT

254 ARGYLE

254 Argyle Avenue, Ottawa, Ontario

TITLE


# **ROOFS & PENTHOUSE PLANS**

PROJECT NO: 2023-0250 DRAWN: IK / EF / RK APPROVED: DH

1:100 DATE PRINTED: 2025-05-26 2:59:47 PM

DRAWING NO. 3

A204

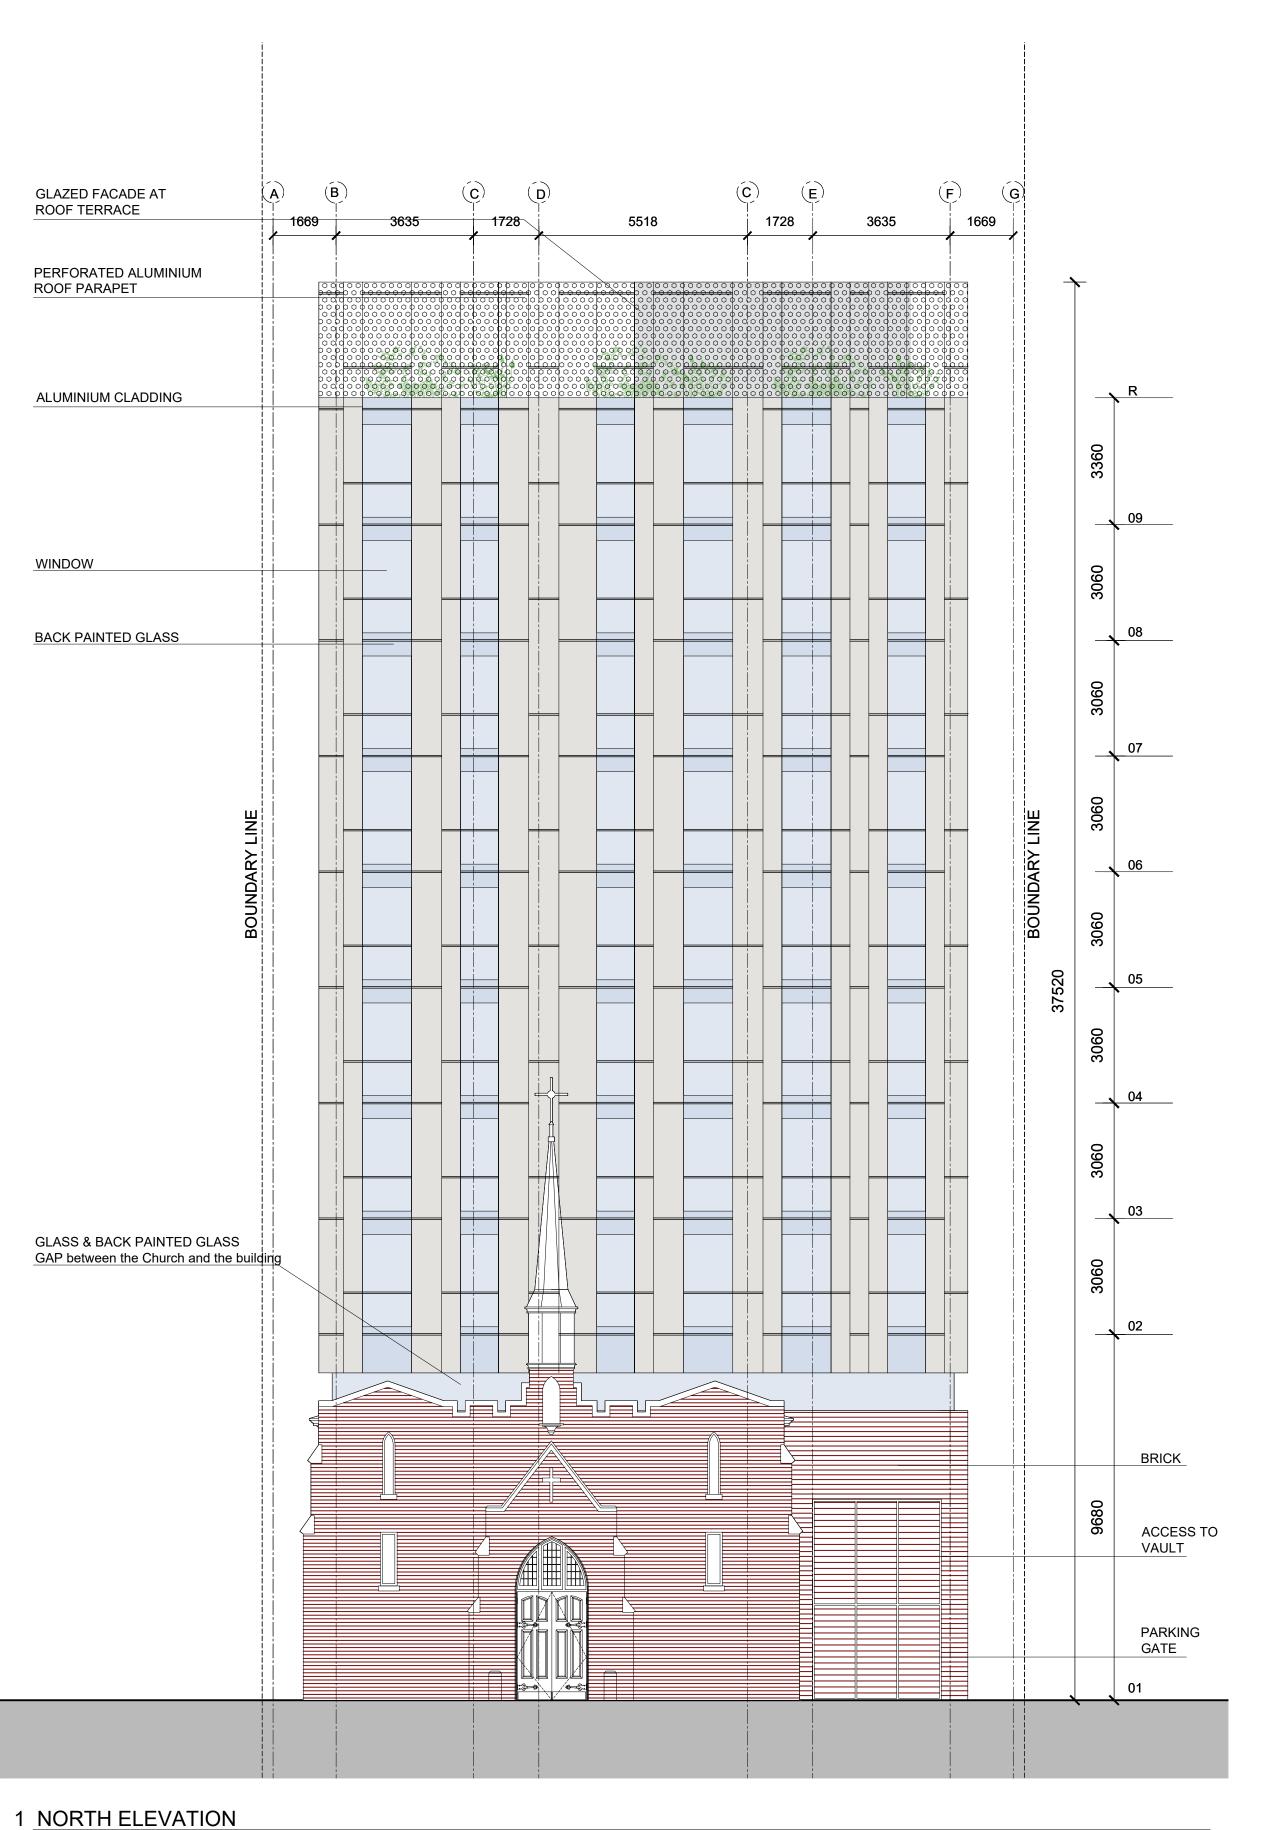

A300 1:100

GLAZED FACADE AT ROOF TERRACE 1669 1728 5518 1728 3635 1669 PERFORATED ALUMINIUM **ROOF PARAPET** ALUMINIUM CLADDING WINDOWS BACK PAINTED GLASS 05 03 GLASS & BACK PAINTED GLASS GAP between the Church and the building BRICK

1 SOUTH ELEVATION

A300 1:100

ARCHITECT OF RECORD

# **CSV** ARCHITECTS

sustainable design · conception écologique

613.564.8118 190 O'Connor Street, Suite 100 www.csv.ca

Ottawa, Ontario, K2P 2R3



SPICE Design Level 4, 22 Bishopsgate London, England EC2N 4BQ www.spice.design

STRUCTURAL ENGINEER GOODEVE STRUCTURAL INC. Suite 18, 77 Auriga Drive Ottawa, Ontario, Canada K2E 7Z7 (613) 226-4558 www.goodevestructural.ca

MECHANICAL + ELECTRICAL ENGINEER QUASAR CONSULTING GROUP Suite 400, 150 Isabella Street Ottawa, Ontario, Canada K1S 5H3 (613) 518-8344 www.quasarcg.com

CIVIL ENGINEER NOVATECH Engineers, Planners & Landscape Architects Suite 200, 240 Michael Cowpland Drive Ottawa, Ontario, Canada K2M 1P6 (613) 254-9643 www.novatech-eng.com

LANDSCAPE ARCHITECT NOVATECH Engineers, Planners & Landscape Architects Suite 200, 240 Michael Cowpland Drive Ottawa, Ontario, Canada K2M 1P6 (613) 254-9643 www.novatech-eng.com

STAMP

5 2025.06.17 ISSUED FOR SPC AND REZONING COMMENT RESPONSE 02 3 2024.10.25 REISSUED FOR SPC AND REZONING 2 2024.08.29 ISSUED FOR SPC AND REZONING 1 2024.04.29 ISSUED FOR PHASE 2 PRECONSULT

NOTES

REV DATE ISSUE

1. OWNERSHIP OF THE COPYRIGHT OF THE DESIGN AND THE WORKS EXECUTED FROM THE DESIGN REMAINS WITH CSV ARCHITECTS, AND MAY NOT BE REPRODUCED IN ANY FORM WITHOUT THE WRITTEN CONSENT OF CSV ARCHITECTS.

2. THE DRAWINGS, PRESENTATIONS AND SPECIFICATIONS AS INSTRUMENTS OF SERVICE ARE AND SHALL REMAIN THE PROPERTY OF CSV ARCHITECTS. THEY ARE NOT TO BE USED BY THE CLIENT ON OTHER PROJECTS OR ON EXTENSIONS TO THIS PROJECT WITHOUT THE WRITTEN CONSENT OF CSV ARCHITECTS. 3. THIS DRAWING IS TO BE READ IN CONJUNCTION WITH ALL OTHER PROJECT DRAWINGS AND SPECIFICATIONS. 4. DO NOT SCALE DRAWINGS. CONTRACTOR SHALL BE RESPONSIBLE TO VERIFY DIMENSIONS ON SITE.
5. ALL WORK SHALL BE IN ACCORDANCE WITH THE ONTARIO BUILDING CODE AND ALL SUPPLEMENTS AND APPLICABLE MUNICIPAL REGULATIONS.

1. OWNERSHIP OF THE COPYRIGHT OF THE DESIGN

CLIENT



OTTAWA ONTARIO, CANADA

PROJECT

## 254 ARGYLE


254 Argyle, Ottawa, Ontario

# **NORTH & SOUTH ELEVATIONS**

PROJECT NO: 2023-0250 DRAWN: SPICE APPROVED: SPICE SCALE: 1:100

REV DRAWING NO. 🕇

A300 g

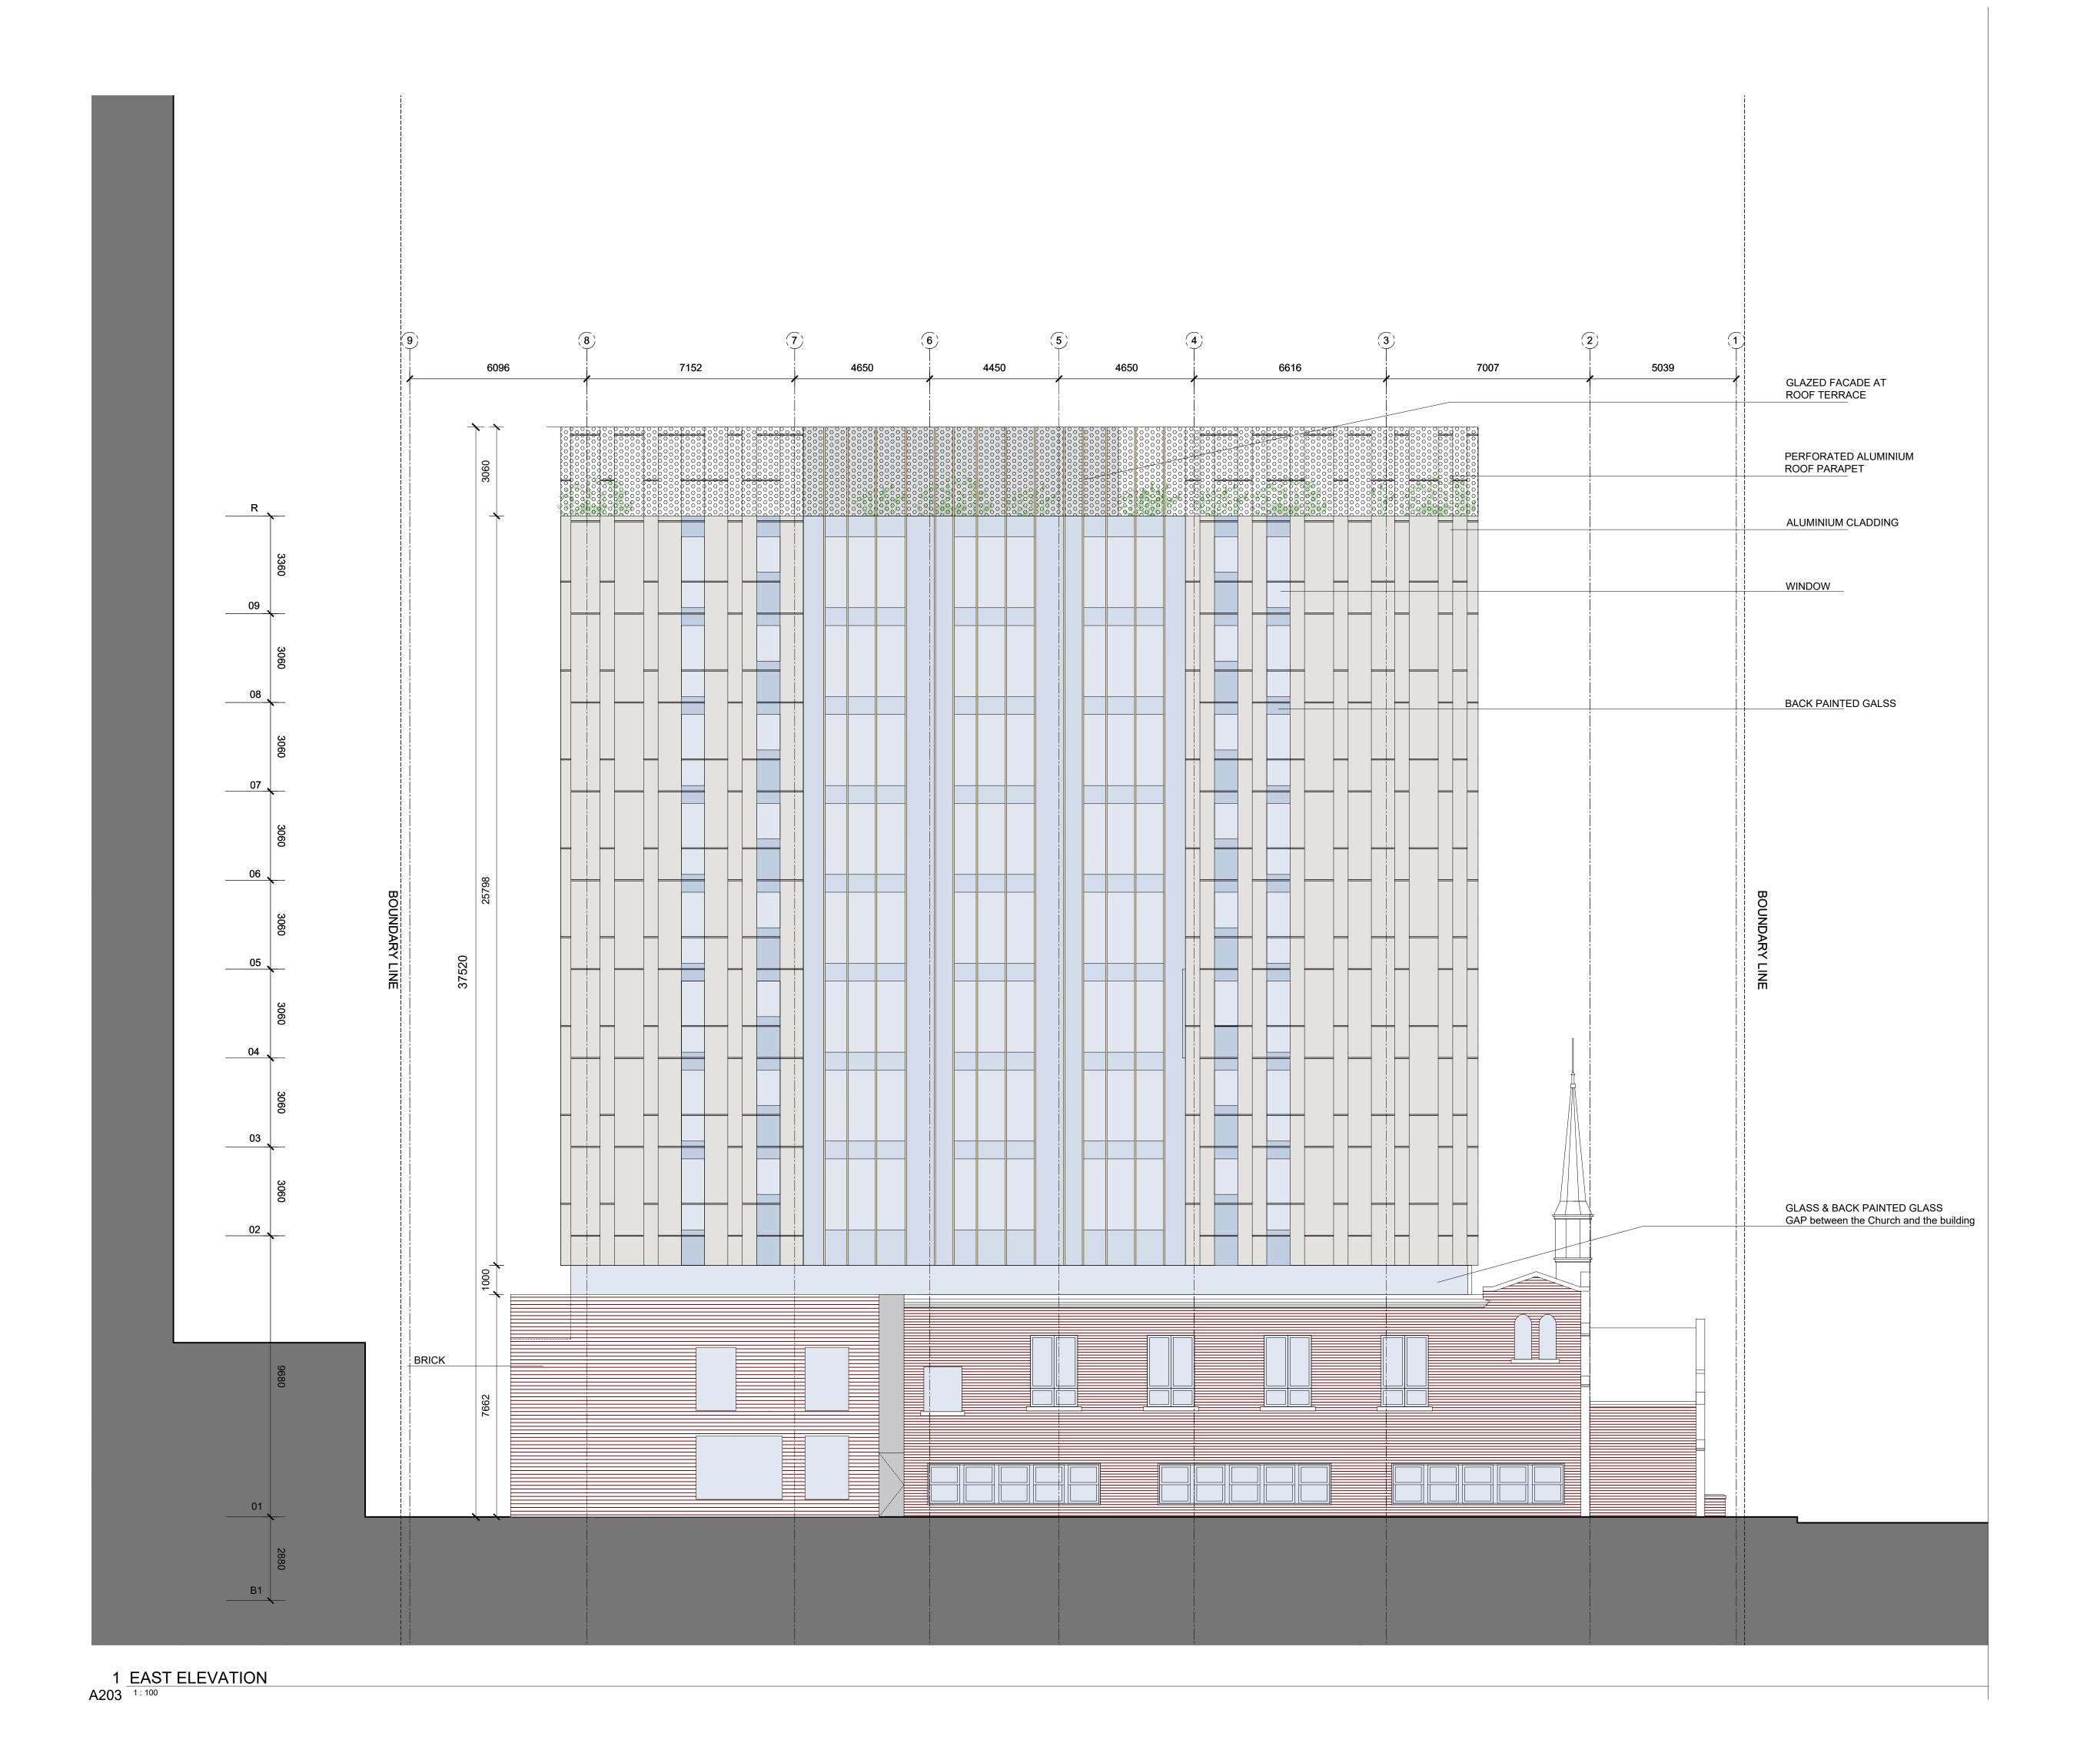

ARCHITECT OF RECORD

# **CSV** ARCHITECTS

sustainable design · conception écologique

190 O'Connor Street, Suite 100 613.564.8118 Ottawa, Ontario, K2P 2R3 www.csv.ca

DESIGN CONCEPT ARCHITECT



SPICE Design Level 4, 22 Bishopsgate London, England EC2N 4BQ www.spice.design

STRUCTURAL ENGINEER GOODEVE STRUCTURAL INC. Suite 18, 77 Auriga Drive Ottawa, Ontario, Canada K2E 7Z7 (613) 226-4558 www.goodevestructural.ca

MECHANICAL + ELECTRICAL ENGINEER QUASAR CONSULTING GROUP Suite 400, 150 Isabella Street Ottawa, Ontario, Canada K1S 5H3 (613) 518-8344 www.quasarcg.com

CIVIL ENGINEER NOVATECH Engineers, Planners & Landscape Architects Suite 200, 240 Michael Cowpland Drive Ottawa, Ontario, Canada K2M 1P6 (613) 254-9643 www.novatech-eng.com

LANDSCAPE ARCHITECT NOVATECH Engineers, Planners & Landscape Architects Suite 200, 240 Michael Cowpland Drive Ottawa, Ontario, Canada K2M 1P6 (613) 254-9643 www.novatech-eng.com

STAMP

5 2025.06.17 ISSUED FOR SPC AND REZONING COMMENT RESPONSE 02 3 2024.10.25 REISSUED FOR SPC AND REZONING 2 2024.08.29 ISSUED FOR SPC AND REZONING 1 2024.04.29 ISSUED FOR PHASE 2 PRECONSULT REV DATE ISSUE

NOTES

1. OWNERSHIP OF THE COPYRIGHT OF THE DESIGN AND THE WORKS EXECUTED FROM THE DESIGN REMAINS WITH CSV ARCHITECTS, AND MAY NOT BE REPRODUCED IN ANY FORM WITHOUT THE WRITTEN CONSENT OF CSV ARCHITECTS.

2. THE DRAWINGS, PRESENTATIONS AND SPECIFICATIONS AS INSTRUMENTS OF SERVICE ARE AND SHALL REMAIN THE PROBERTY OF CSV. ARE AND SHALL REMAIN THE PROPERTY OF CSV ARCHITECTS. THEY ARE NOT TO BE USED BY THE CLIENT ON OTHER PROJECTS OR ON EXTENSIONS TO THIS PROJECT WITHOUT THE WRITTEN CONSENT OF CSV ARCHITECTS. 3. THIS DRAWING IS TO BE READ IN CONJUNCTION WITH ALL OTHER PROJECT DRAWINGS AND SPECIFICATIONS. 4. DO NOT SCALE DRAWINGS. CONTRACTOR SHALL BE RESPONSIBLE TO VERIFY DIMENSIONS ON SITE.
5. ALL WORK SHALL BE IN ACCORDANCE WITH THE ONTARIO BUILDING CODE AND ALL SUPPLEMENTS AND APPLICABLE MUNICIPAL REGULATIONS.

1. OWNERSHIP OF THE COPYRIGHT OF THE DESIGN

CLIENT



OTTAWA ONTARIO, CANADA

PROJECT

## 254 ARGYLE


254 Argyle, Ottawa, Ontario

# **EAST ELEVATION**

PROJECT NO: 2023-0250 SPICE DRAWN: APPROVED: SPICE SCALE: 1:100

DRAWING NO. 🕏

A301 8

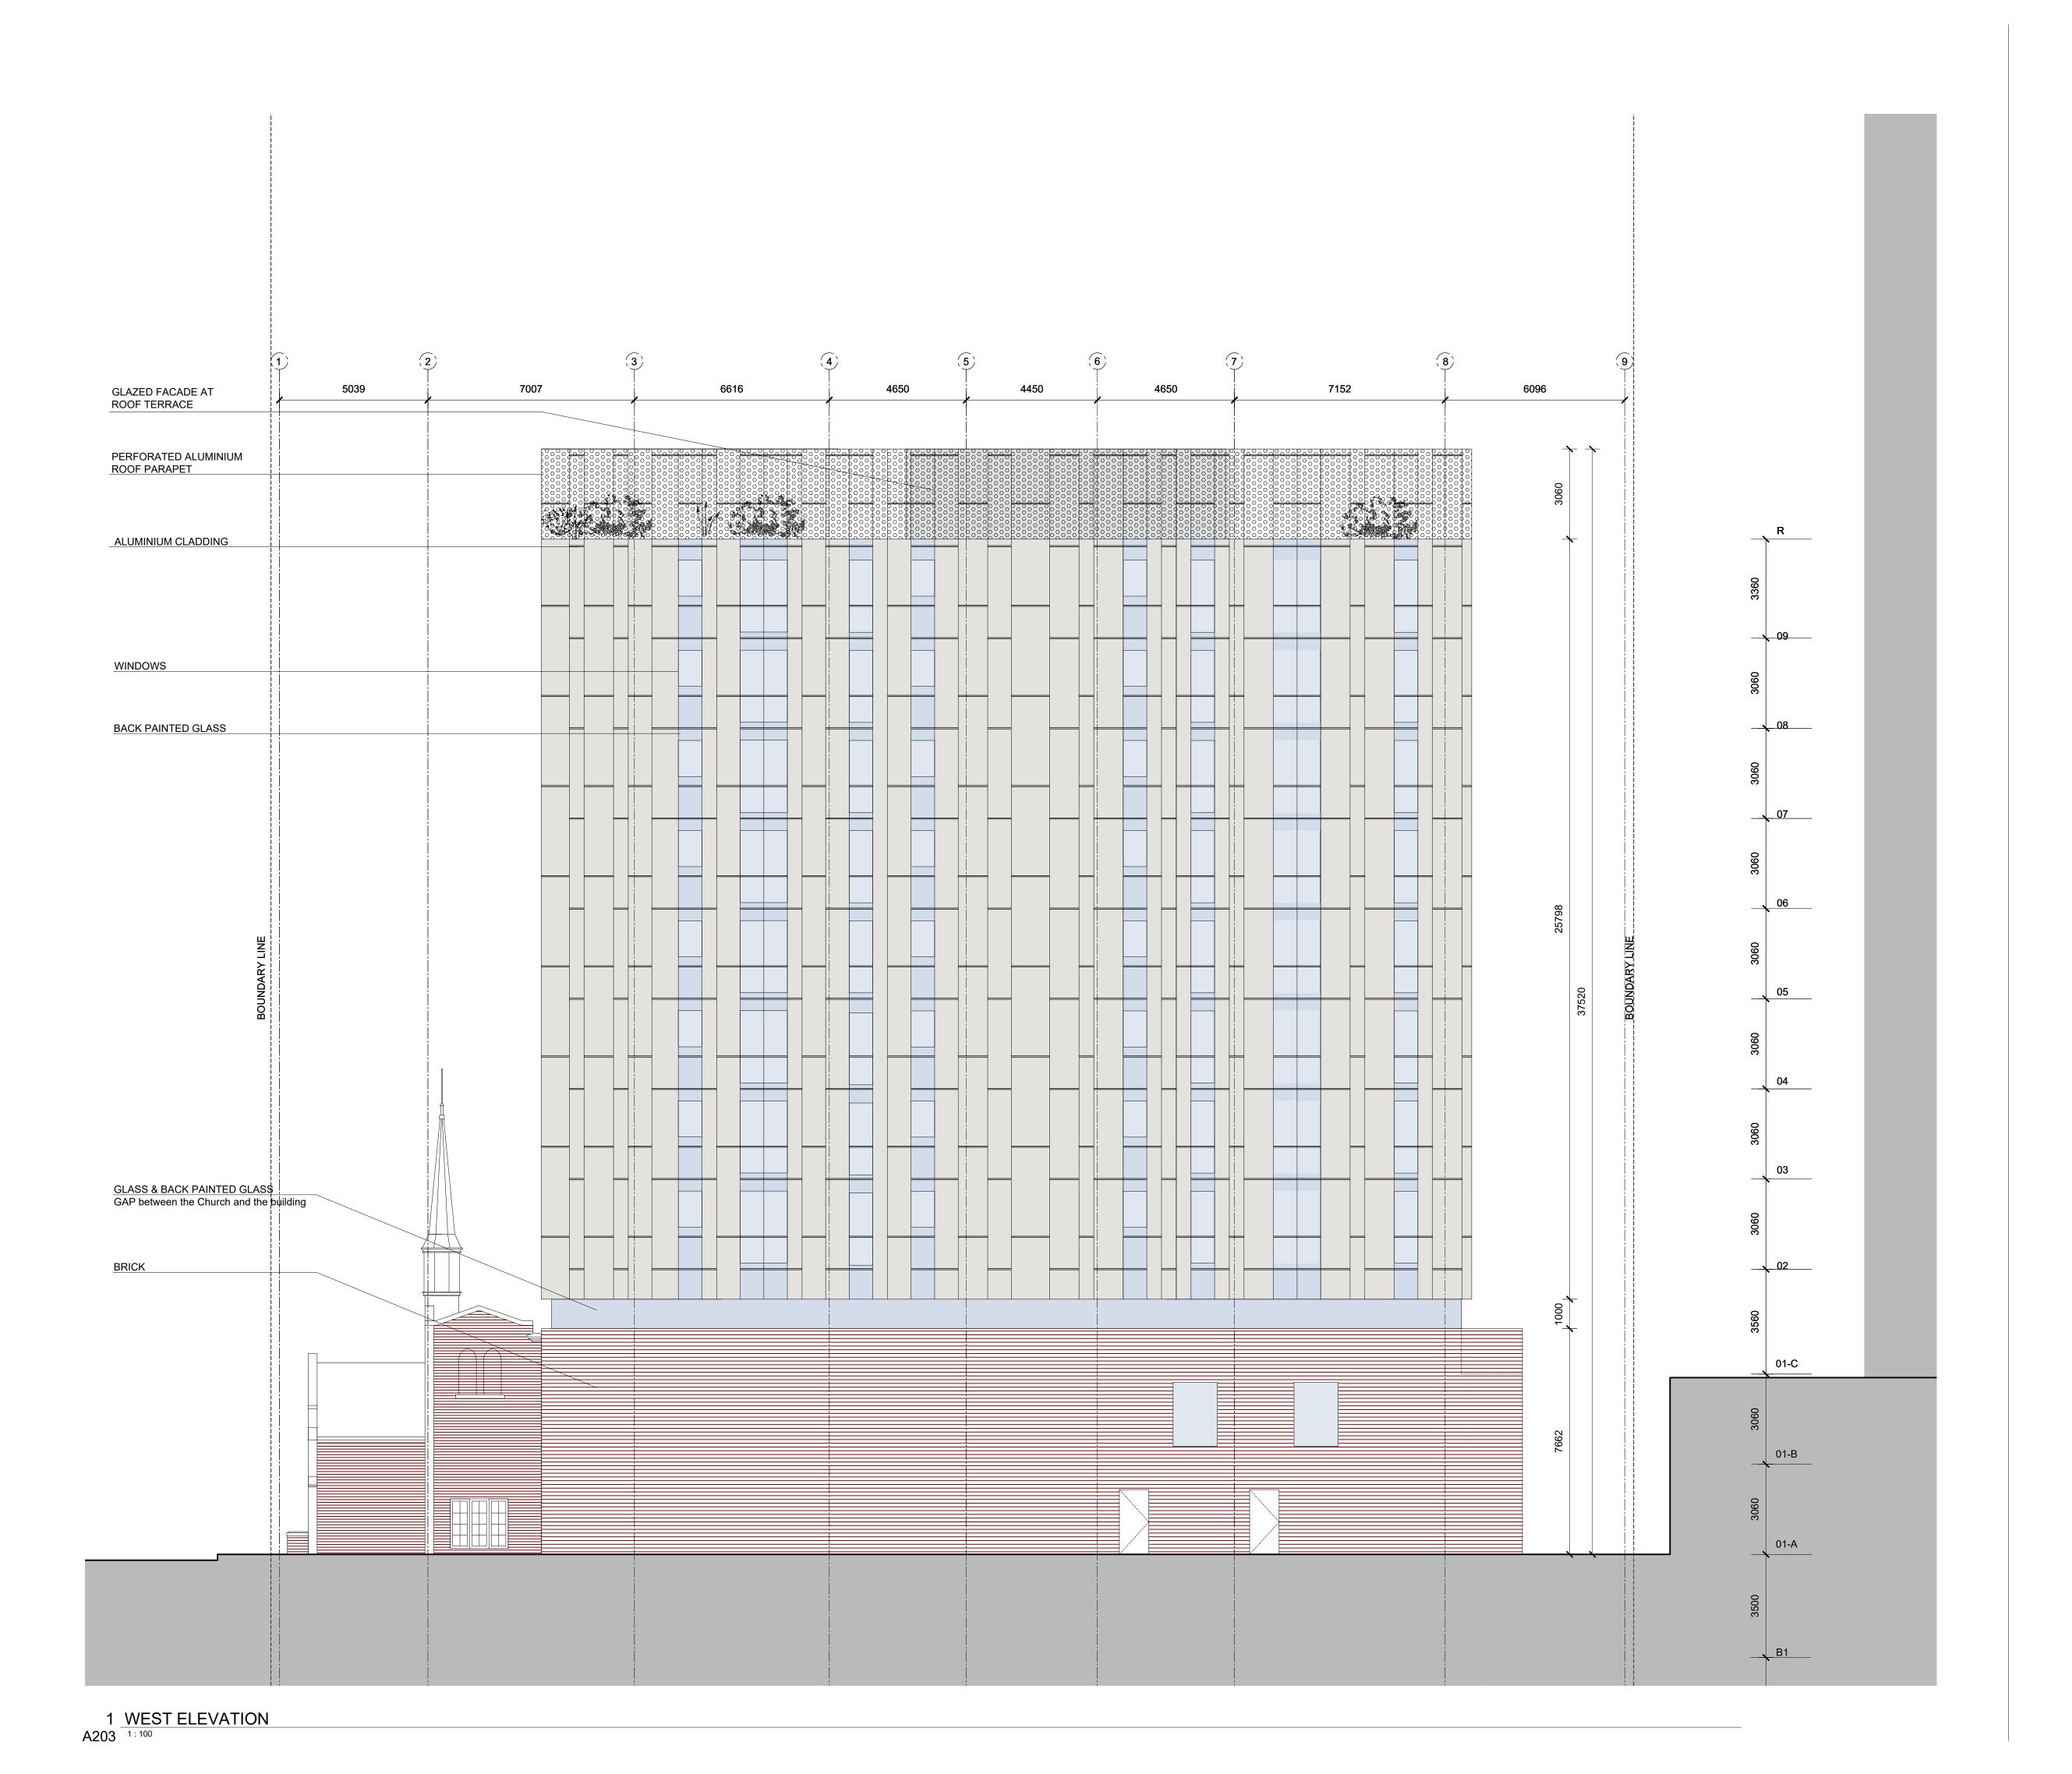

ARCHITECT OF RECORD

# **CSV** ARCHITECTS

sustainable design · conception écologique

613.564.8118 190 O'Connor Street, Suite 100 www.csv.ca

Ottawa, Ontario,K2P 2R3 DESIGN CONCEPT ARCHITECT



SPICE Design Level 4, 22 Bishopsgate London, England EC2N 4BQ www.spice.design

STRUCTURAL ENGINEER
GOODEVE STRUCTURAL INC.
Suite 18, 77 Auriga Drive
Ottawa, Ontario, Canada K2E 7Z7 (613) 226-4558 www.goodevestructural.ca

MECHANICAL + ELECTRICAL ENGINEER QUASAR CONSULTING GROUP Suite 400, 150 Isabella Street Ottawa, Ontario, Canada K1S 5H3 (613) 518-8344 www.quasarcg.com

CIVIL ENGINEER NOVATECH Engineers, Planners & Landscape Architects Suite 200, 240 Michael Cowpland Drive Ottawa, Ontario, Canada K2M 1P6 (613) 254-9643 www.novatech-eng.com

LANDSCAPE ARCHITECT NOVATECH Engineers, Planners & Landscape Architects Suite 200, 240 Michael Cowpland Drive Ottawa, Ontario, Canada K2M 1P6 (613) 254-9643 www.novatech-eng.com

STAMP

5 2025.06.17 ISSUED FOR SPC AND REZONING COMMENT RESPONSE 02 3 2024.10.25 REISSUED FOR SPC AND REZONING 2 2024.08.29 ISSUED FOR SPC AND REZONING 1 2024.04.29 ISSUED FOR PHASE 2 PRECONSULT

NOTES

REV DATE ISSUE

1. OWNERSHIP OF THE COPYRIGHT OF THE DESIGN AND THE WORKS EXECUTED FROM THE DESIGN REMAINS WITH CSV ARCHITECTS, AND MAY NOT BE REPRODUCED IN ANY FORM WITHOUT THE WRITTEN CONSENT OF CSV ARCHITECTS.

2. THE DRAWINGS, PRESENTATIONS AND SPECIFICATIONS AS INSTRUMENTS OF SERVICE ARE AND SHALL REMAIN THE PROPERTY OF CSV ARCHITECTS. THEY ARE NOT TO BE USED BY THE CLIENT ON OTHER PROJECTS OR ON EXTENSIONS. CLIENT ON OTHER PROJECTS OR ON EXTENSIONS TO THIS PROJECT WITHOUT THE WRITTEN CONSENT OF CSV ARCHITECTS. 3. THIS DRAWING IS TO BE READ IN CONJUNCTION WITH ALL OTHER PROJECT DRAWINGS AND SPECIFICATIONS. 4. DO NOT SCALE DRAWINGS. CONTRACTOR SHALL BE RESPONSIBLE TO VERIFY DIMENSIONS ON SITE.
5. ALL WORK SHALL BE IN ACCORDANCE WITH THE ONTARIO BUILDING CODE AND ALL SUPPLEMENTS AND APPLICABLE MUNICIPAL REGULATIONS.

1. OWNERSHIP OF THE COPYRIGHT OF THE DESIGN

CLIENT



OTTAWA ONTARIO, CANADA

PROJECT

254 ARGYLE

254 Argyle, Ottawa, Ontario

**WEST ELEVATION** 

PROJECT NO: 2023-0250 DRAWN: SPICE APPROVED: SPICE SCALE: 1:100

DRAWING NO. 🕏

A302 §

5039 7007 7152 6096 6616 4650 4450 4650 PERGOLA ROOFTOP TERRACE **MECHANICAL** \_\_\_\_09\_\_\_\_ \_\_\_\_07 \_\_\_\_\_06 GYM 01-C LOBBY ARGYLE AVENUE BIKE WORKSHOP 69.40 69.40 01-A PARKING PARKING 1 LONGITUDINAL SECTION

ARCHITECT OF RECORD

# **CSV** ARCHITECTS

sustainable design · conception écologique

613.564.8118 190 O'Connor Street, Suite 100 www.csv.ca

Ottawa, Ontario, K2P 2R3



SPICE Design Level 4, 22 Bishopsgate London, England EC2N 4BQ www.spice.design

STRUCTURAL ENGINEER GOODEVE STRUCTURAL INC. Suite 18, 77 Auriga Drive Ottawa, Ontario, Canada K2E 7Z7 (613) 226-4558 www.goodevestructural.ca

MECHANICAL + ELECTRICAL ENGINEER QUASAR CONSULTING GROUP Suite 400, 150 Isabella Street Ottawa, Ontario, Canada K1S 5H3 (613) 518-8344 www.quasarcg.com

CIVIL ENGINEER NOVATECH Engineers, Planners & Landscape Architects Suite 200, 240 Michael Cowpland Drive Ottawa, Ontario, Canada K2M 1P6 (613) 254-9643 www.novatech-eng.com

LANDSCAPE ARCHITECT NOVATECH Engineers, Planners & Landscape Architects Suite 200, 240 Michael Cowpland Drive Ottawa, Ontario, Canada K2M 1P6 (613) 254-9643 www.novatech-eng.com

STAMP

5 2025.06.17 ISSUED FOR SPC AND REZONING COMMENT RESPONSE 02 3 2024.10.25 REISSUED FOR SPC AND REZONING 2 2024.08.29 ISSUED FOR SPC AND REZONING 1 2024.04.29 ISSUED FOR PHASE 2 PRECONSULT REV DATE ISSUE

NOTES

1. OWNERSHIP OF THE COPYRIGHT OF THE DESIGN AND THE WORKS EXECUTED FROM THE DESIGN REMAINS WITH CSV ARCHITECTS, AND MAY NOT BE REPRODUCED IN ANY FORM WITHOUT THE WRITTEN CONSENT OF CSV ARCHITECTS.

2. THE DRAWINGS, PRESENTATIONS AND SPECIFICATIONS AS INSTRUMENTS OF SERVICE ARE AND SHALL REMAIN THE PROPERTY OF CSV ARCHITECTS. THEY ARE NOT TO BE USED BY THE CLIENT ON OTHER PROJECTS OR ON EXTENSIONS TO THIS PROJECT WITHOUT THE WRITTEN CONSENT OF CSV ARCHITECTS.

3. THIS DRAWING IS TO BE READ IN CONJUNCTION 3. THIS DRAWING IS TO BE READ IN CONJUNCTION WITH ALL OTHER PROJECT DRAWINGS AND WITH ALL OTHER PROJECT DRAWINGS AND SPECIFICATIONS.

4. DO NOT SCALE DRAWINGS. CONTRACTOR SHALL BE RESPONSIBLE TO VERIFY DIMENSIONS ON SITE.

5. ALL WORK SHALL BE IN ACCORDANCE WITH THE ONTARIO BUILDING CODE AND ALL SUPPLEMENTS AND APPLICABLE MUNICIPAL REGULATIONS.

CLIENT



OTTAWA ONTARIO, CANADA

PROJECT

## 254 ARGYLE

254 Argyle, Ottawa, Ontario

# LONGITUDINAL **SECTION**

PROJECT NO: 2023-0250 DRAWN: SPICE APPROVED: SPICE SCALE: 1:100

DRAWING NO. 🕇

A400 g