SITE PLAN KEYNOTES:

- 1 EXISTING SIDEWALK TO REMAIN
- 2 EXISTING ASPHALT PAVING TO REMAIN
- 3 EXISTING CURB TO REMAIN

9123

⁺5428 ⁺

6062

19238

- 4 EXISTING SIGN TO REMAIN
- 5 EXISTING LANDSCAPING TO REMAIN.

EXISTING

2.5 STOREY BUILDING

TO REMAIN

41047

NEW BUILDING

84 UNITS

13070

46.50m N 31° 56' 30" W

- 21 RELOCATE EXISTING CHURCH FACADE TO NEW LOCATION
- 22 VENTED CISTERN LID
- 23 NEW CONCRETE SIDEWALK PER CIVIL
- 24 REINSTATE TOP SOIL AND GRASS IN BETWEEN ROAD AND SIDEWALK AT AREAS EFFECTED BY CONSTRUCTION
- 25 NEW CURB PER CIVIL
- 26 REINSTATE EXISTING ROAD ASSEMBLY PER CIVIL AT AREAS EFFECTED BY DEMOLITION AND CONSTRUCTIONS. PROVIDE SMOOTH TRANSITION TO EXISTING PAVING.
- 27 BACKFILL TRENCHES AS REQUIRED PER CIVIL AND GEOTECHNICAL.
- 28 RELOCATE EXISTING FIRE HYDRANT PER CIVIL
- 29 NEW DRIVEWAY PER CIVIL
- 30 NEW CURB WALL PER CIVIL
- 31 OVERHEAD DOOR TO UNDERGROUND PARKING

33

- 32 WOOD PRIVACY FENCE PER LANDSCAPING
- 33 TERMINATE WOOD PRIVACY FENCE FLUSH TO THE RETAINING WALL PER LANDSCAPING
- 34 PEDESTRIAN GATE
- 35 WALKWAY PER LANDSCAPING
- 36 PATIO PER LANDSCAPING
- 37 PLANTS PER LANDSCAPING
- 38 VAULT
- 40 STEPBACK AT LEVELS 2 TO ROOF

39 RAISED PLANTER WALL PER LANDSCAPING

EXISTING 1 STOREY GARAGE

TO REMAIN

5759

4017

30 39

41 SETBACK AT LEVEL 1B

14132

42

42 SETBACK AT LEVELS 1C TO ROOF

SITE PLAN LEGEND:

SITE PLAN GENERAL NOTES:

2. DO NOT SCALE THIS DRAWING

CONSULTANT

CONSULTANT

EXCAVATION

EXCAVATION

TO DIGGING

FROM EXISTING PLANS AND SURVEYS

UNKNOWN SUBSURFACE CONDITIONS

3. REPORT ANY DISCREPANCIES PRIOR TO COMMENCING WORK.

SITE AND REPORT ANY ERRORS AND/OR OMISSIONS TO THE

5. REINSTATE ALL AREAS AND ITEMS DAMAGED AS A RESULT OF CONSTRUCTION ACTIVITIES TO THE SATISFACTION OF THE

6. CONTRACTOR TO LAYOUT PLANTING BEDS, PATHWAYS ETC.

TO APPROVAL OF CONSULTANT PRIOR TO ANY JOB

7. THE ACCURACY OF THE POSITION OF UTILITIES IS NOT

GUARANTEED - CONTRACTOR TO VERIFY PRIOR TO

9. ALL DISTURBED AREAS TO BE RESTORED TO ORIGINAL

CONDITION OR BETTER UNLESS OTHERWISE NOTED

8. INDIVIDUAL UTILITY COMPANY MUST BE CONTACTED FOR

CONFIRMATION OF UTILITY EXISTENCE AND LOCATION PRIOR

NO RESPONSIBILITY IS BORN BY THE CONSULTANT FOR

4. CONTRACTOR TO CHECK AND VERIFY ALL DIMENSIONS ON

EXISTING BUILDING & SITE ELEMENTS **NEW BUILDING** NEW ASPHALT PAVING **NEW GRASS** NEW PLANTING BEDS / PLANTS PER LANDSCAPING

NEW CONCRETE SIDEWALK NEW CONCRETE PAD NEW RIVER STONE PER LANDSCAPING

NEW PAVER PER LANDSCAPING

— - - - SET BACK LINE

PROPERTY LINE

--- x ---- x --- NEW FENCE PER LANDSCAPE

---- EXTENT OF PARKING BELOW GRADE

—wtr—wtr— NEW WATER MAIN PER CIVIL

—E-WTR—E-WTR— EXISTING WATER MAIN TO REMAIN

—E-SAN—E-SAN— EXISTING SANITARY SEWAGE TO REMAIN

——E-ST——E-ST— EXISTING STORM SEWAGE TO REMAIN

—E-OHW——E-OHW— EXISTING ELECTRICAL OVERHEAD SERVICE TO —онw— oнw— NEW ELECTRICAL OVERHEAD SERVICE PER ELECTRICAL

——E-G——E-G—— EXISTING GAS LINE TO REMAIN

——E-B———E-B—— EXISTING BELL LINE TO REMAIN

ENTRANCE/ BARRIER-FREE ENTRANCE

 \triangle NEW AREA DRAIN PER CIVIL

> CATCH BASIN: EXISTING TO REMAIN / NEW MAINTENANCE HOLE: EXISTING TO REMAIN /

UTILITY POLE: EXISTING TO REMAIN / NEW

EX. V&VB LIGHT STANDARD ⊕ LS

-O_{FH}

EXISTING TREE TO REMAIN

ARCHITECT OF RECORD

CSV ARCHITECTS 1. ALL GENERAL SITE INFORMATION AND CONDITIONS COMPILED

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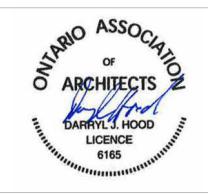
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COMMENT RESPONSE 01 2024.08.29 ISSUED FOR SPC AND REZONING 2024.05.08 ISSUED FOR PHASE 2 PRECONSULT

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URBAN DEVELOPMENTS

254 Argyle Avenue, Ottawa, Ontario

REV DATE ISSUE

CONSENT OF CSV ARCHITECTS.

SPECIFICATIONS.

CLIENT

OTTAWA

PROJECT

TITLE

ONTARIO, CANADA

254 ARGYLE

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— G — NEW GAS LINE PER CIVIL

——E-R——E-R—— EXISTING ROGER LINE TO REMAIN

MAIN ENTRANCE

VEHICLE ACCESS

NEW PER CIVIL

VALVE AND VALVE BOX : EXISTING TO REMAIN

NEW PER CIVIL V&VB NEW FIRE HYDRANT PER CIVIL

NEW WATER METER PER CIVIL NEW REMOTE WATER METER PER CIVIL

DC

NEW SIAMESE CONNECTION NEW DROPPED CURB

NEW TREE PER LANDSCAPING

SITE PLAN

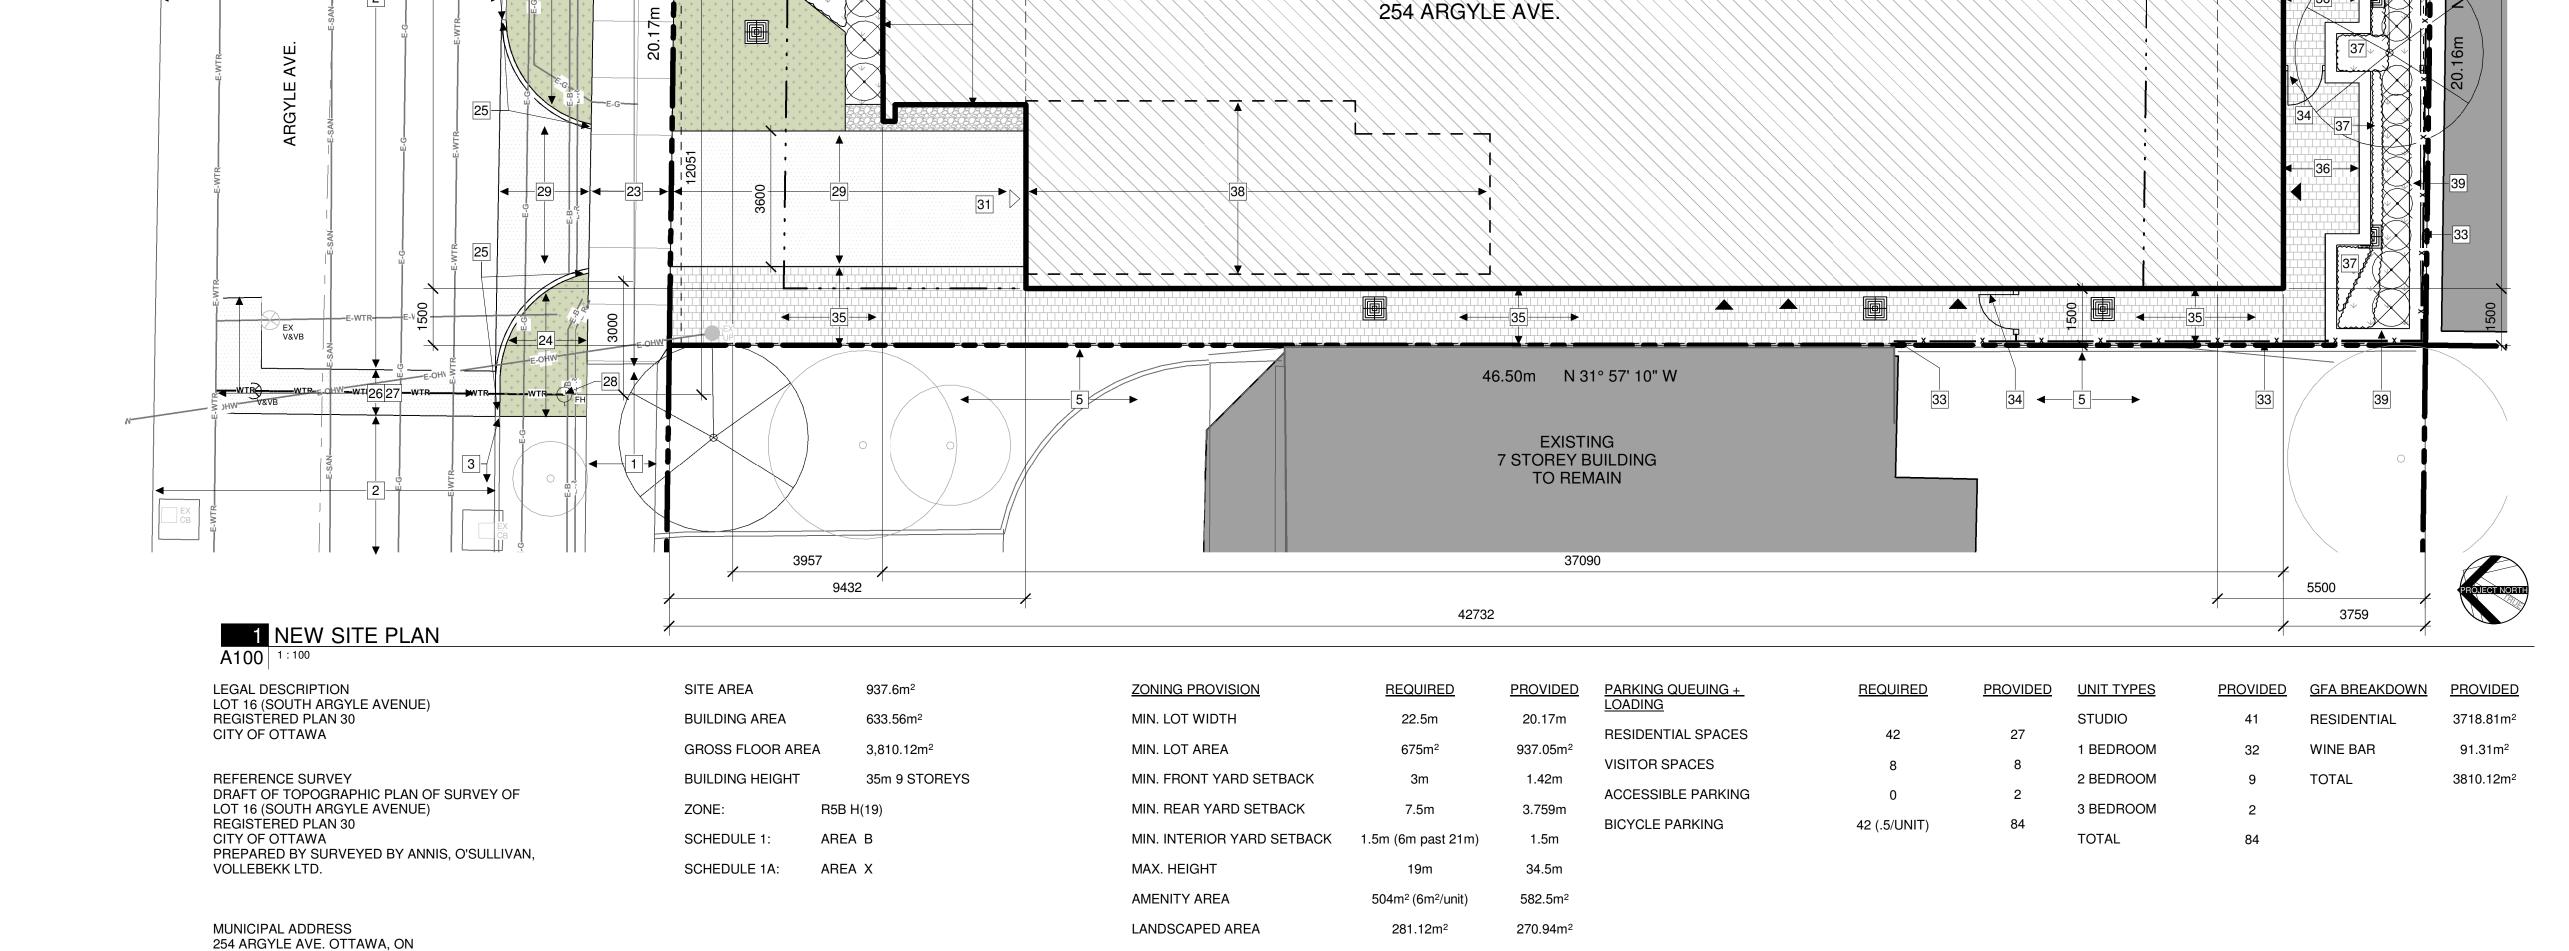
PROJECT NO: 2023-0250 EF / IK DRAWN: APPROVED: DH SCALE: As indicated

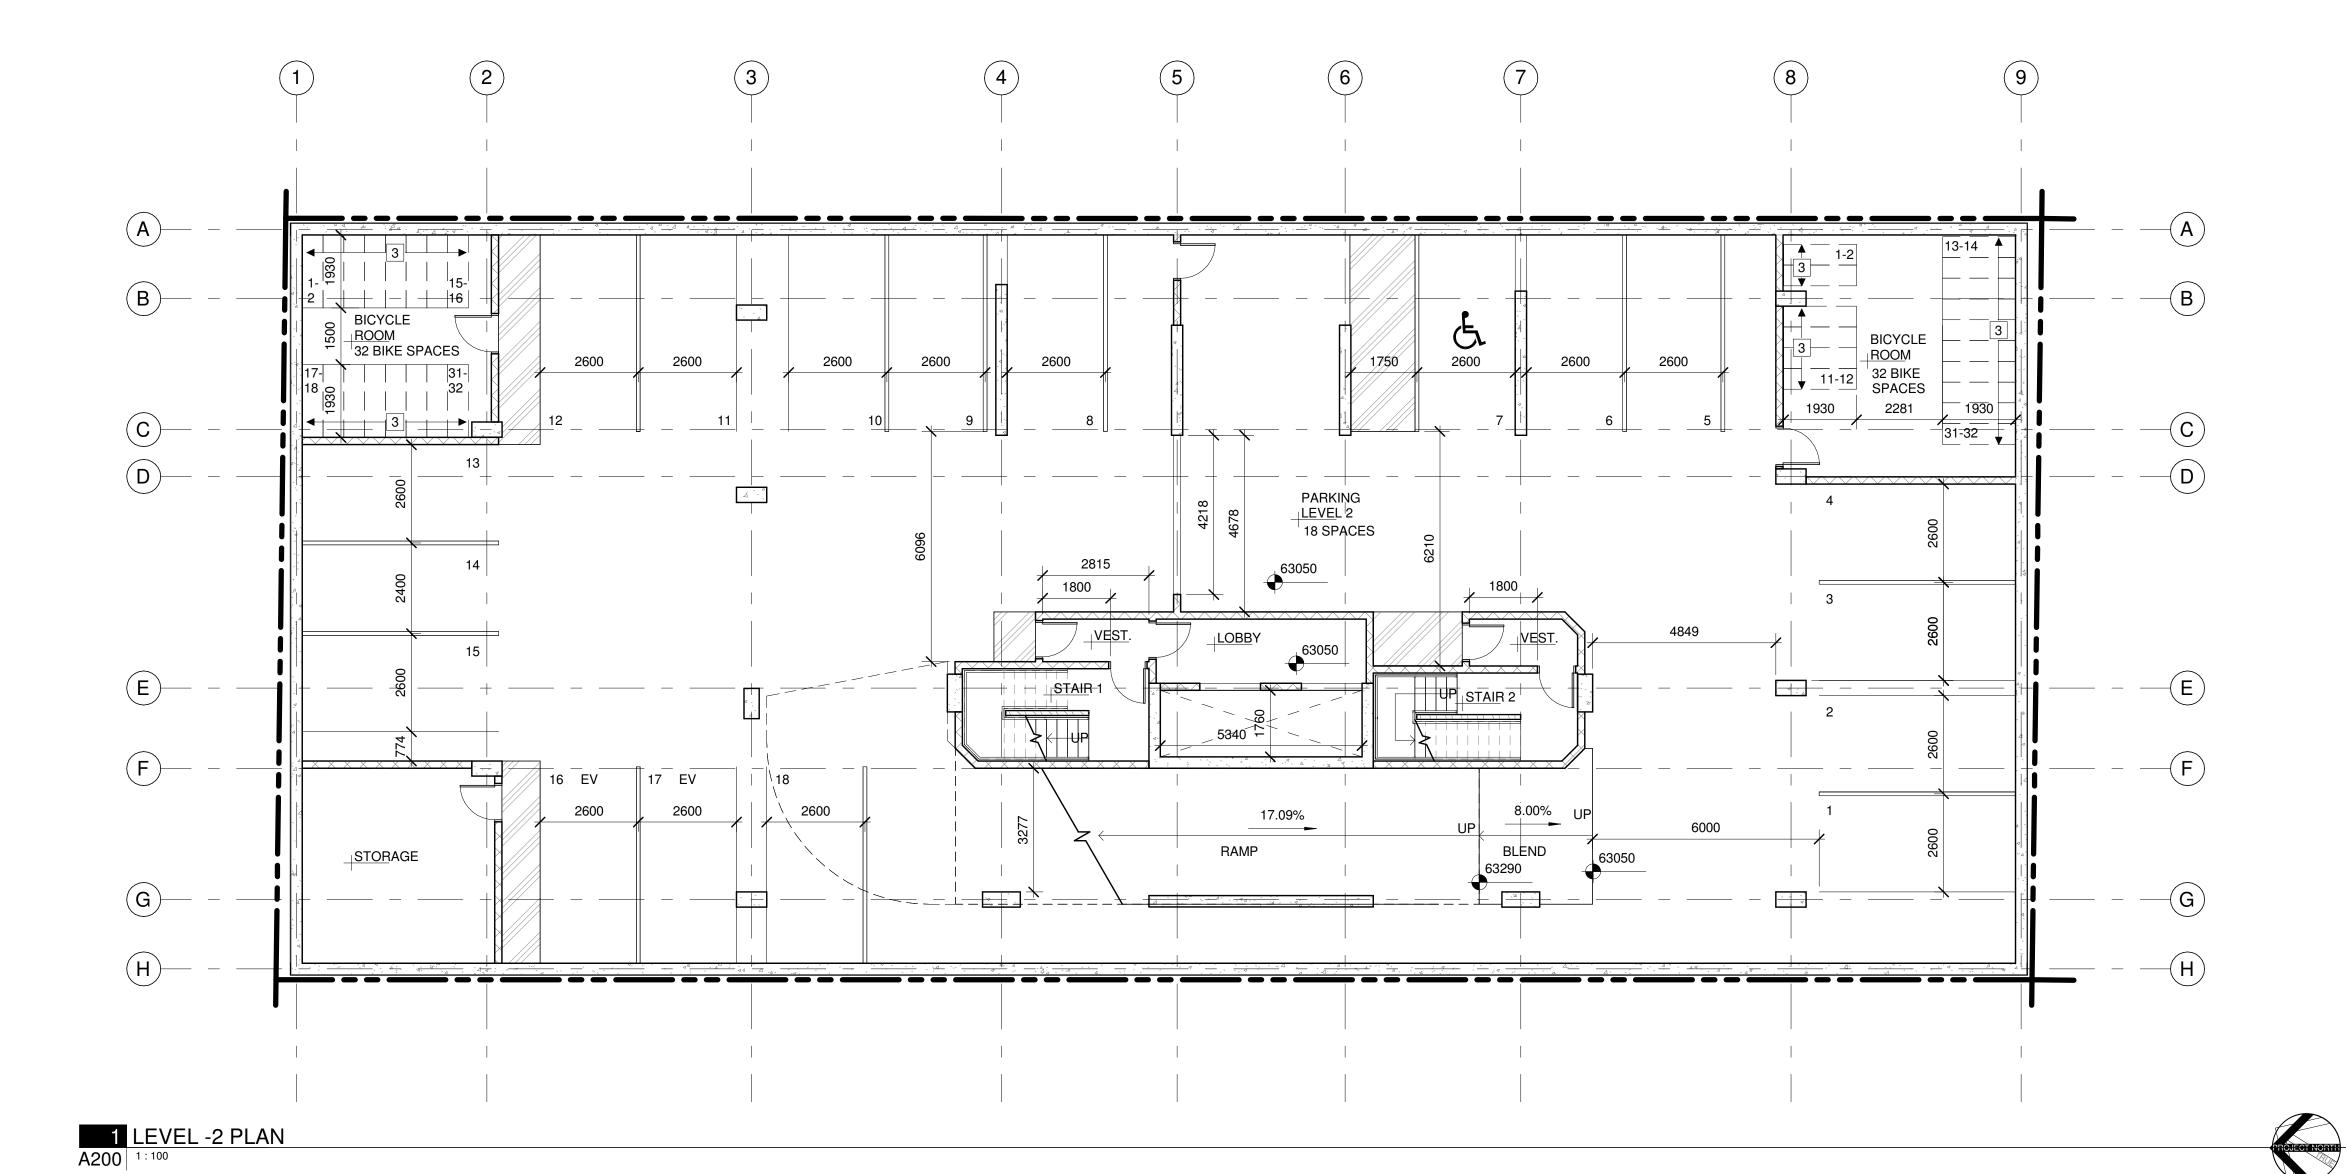
REV DRAWING NO.

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A100

SHRUB: EXISTING TO REMAIN / NEW PER





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- C. REFER TO MECHANICAL + ELECTRICAL DRAWINGS FOR DETAILS OF UNDERGROUND SERVICES. D. ALL EXTERIOR FOUNDATION WALLS ARE DIMENSIONED TO
- EXTERIOR FACE OF ASSEMBLY UNLESS OTHERWISE NOTED. E. ALL INTERIOR FOUNDATION WALLS + FOOTINGS ARE DIMENSIONED FROM GRIDLINE TO FACE UNLESS OTHERWISE
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- BASED ON WALL ASSEMBLY. K. ENSURE 25mm MINIMUM THICKNESS OF CONCRETE COVER OVER VERTICAL STEEL REINFORCEMENT TO ALL REINFORCED CONCRETE STRUCTURAL COLUMNS AND WALLS.

REFERENCE PLAN KEYNOTES:

- 1 CISTERN OVERFLOW AND HATCH / VENTED CISTERN LID
- 2 EXTENT OF DROPPED SLAB ABOVE
- 3 DOUBLE TEAR BICYCLE STORAGE SPACES
- 4 EXIT ONLY
- 5 EXTENT OF FOUNDATION WALL BELOW

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ARCHITECT OF RECORD

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REFERENCE PLAN LEGEND:

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OTTAWA ONTARIO, CANADA

PROJECT

254 ARGYLE

254 Argyle Avenue, Ottawa, Ontario

TITLE

REV

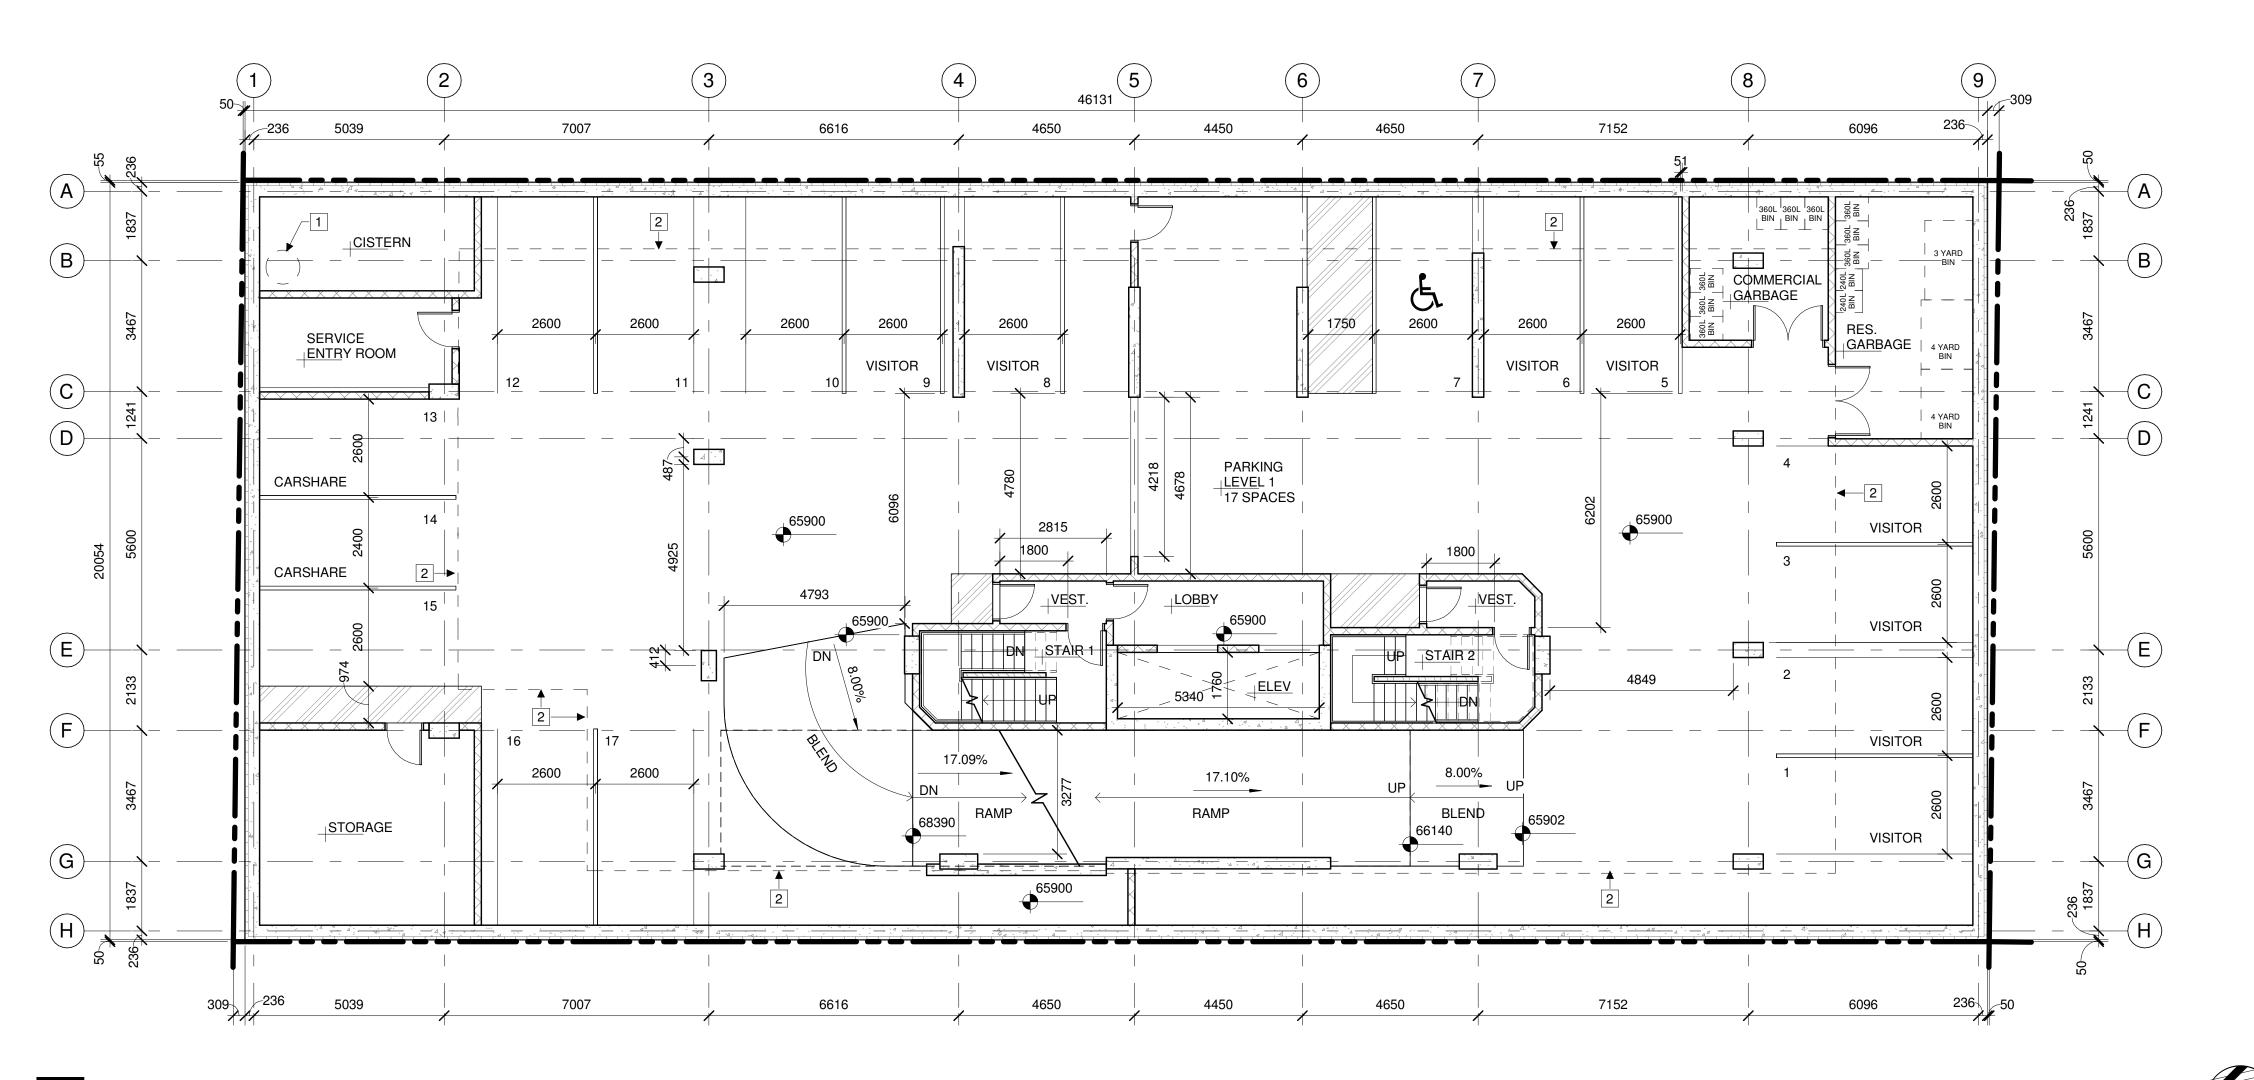
LEVEL -2 PLAN

PROJECT NO: 2023-0250 DRAWN: Author APPROVED: Approver 1:100

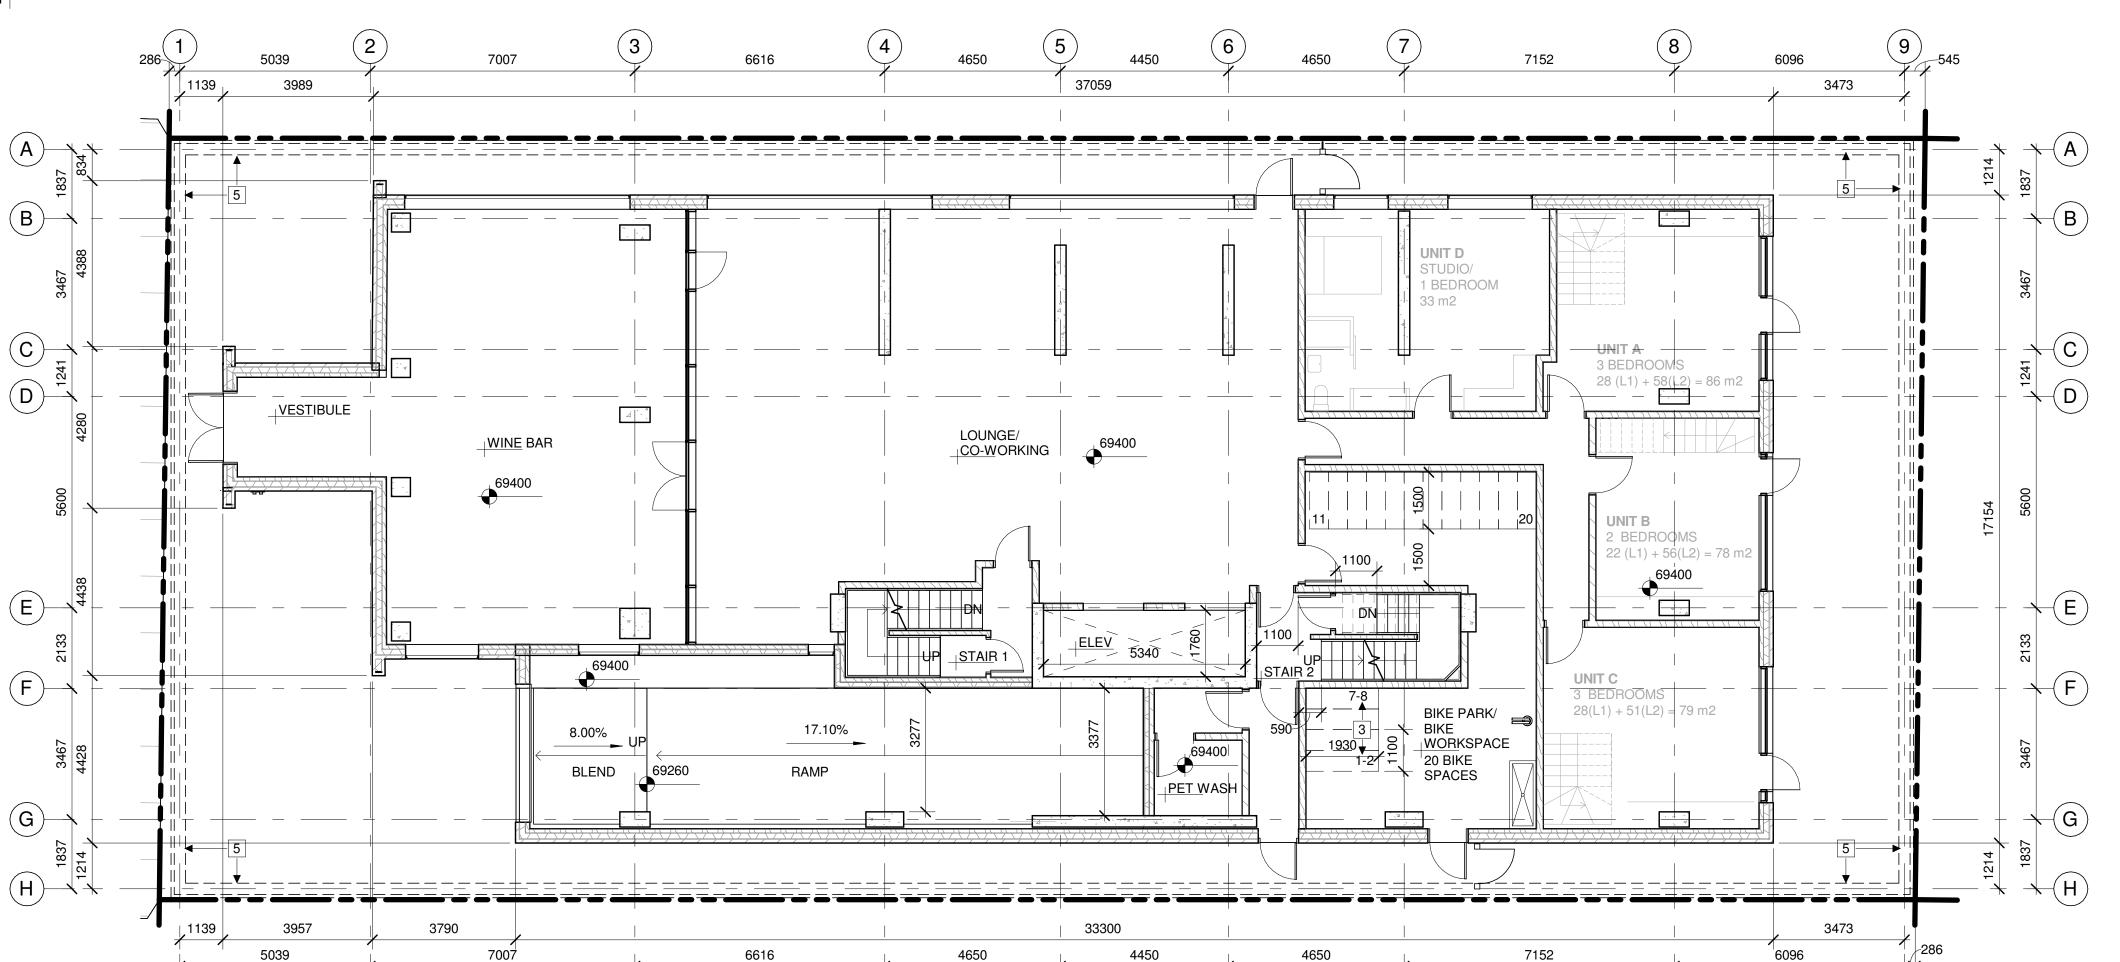
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A200



1 LEVEL -1 PLAN A201 1:100



2 GROUND FLOOR REFERENCE PLAN

A201 1:100

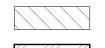
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- 4 EXIT ONLY
- 5 EXTENT OF FOUNDATION WALL BELOW

REFERENCE PLAN LEGEND:



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5. ALL WORK SHALL BE IN ACCORDANCE WITH THE ONTARIO BUILDING CODE AND ALL SUPPLEMENTS

OTTAWA ONTARIO, CANADA

PROJECT

254 ARGYLE

254 Argyle Avenue, Ottawa, Ontario

TITLE

REV

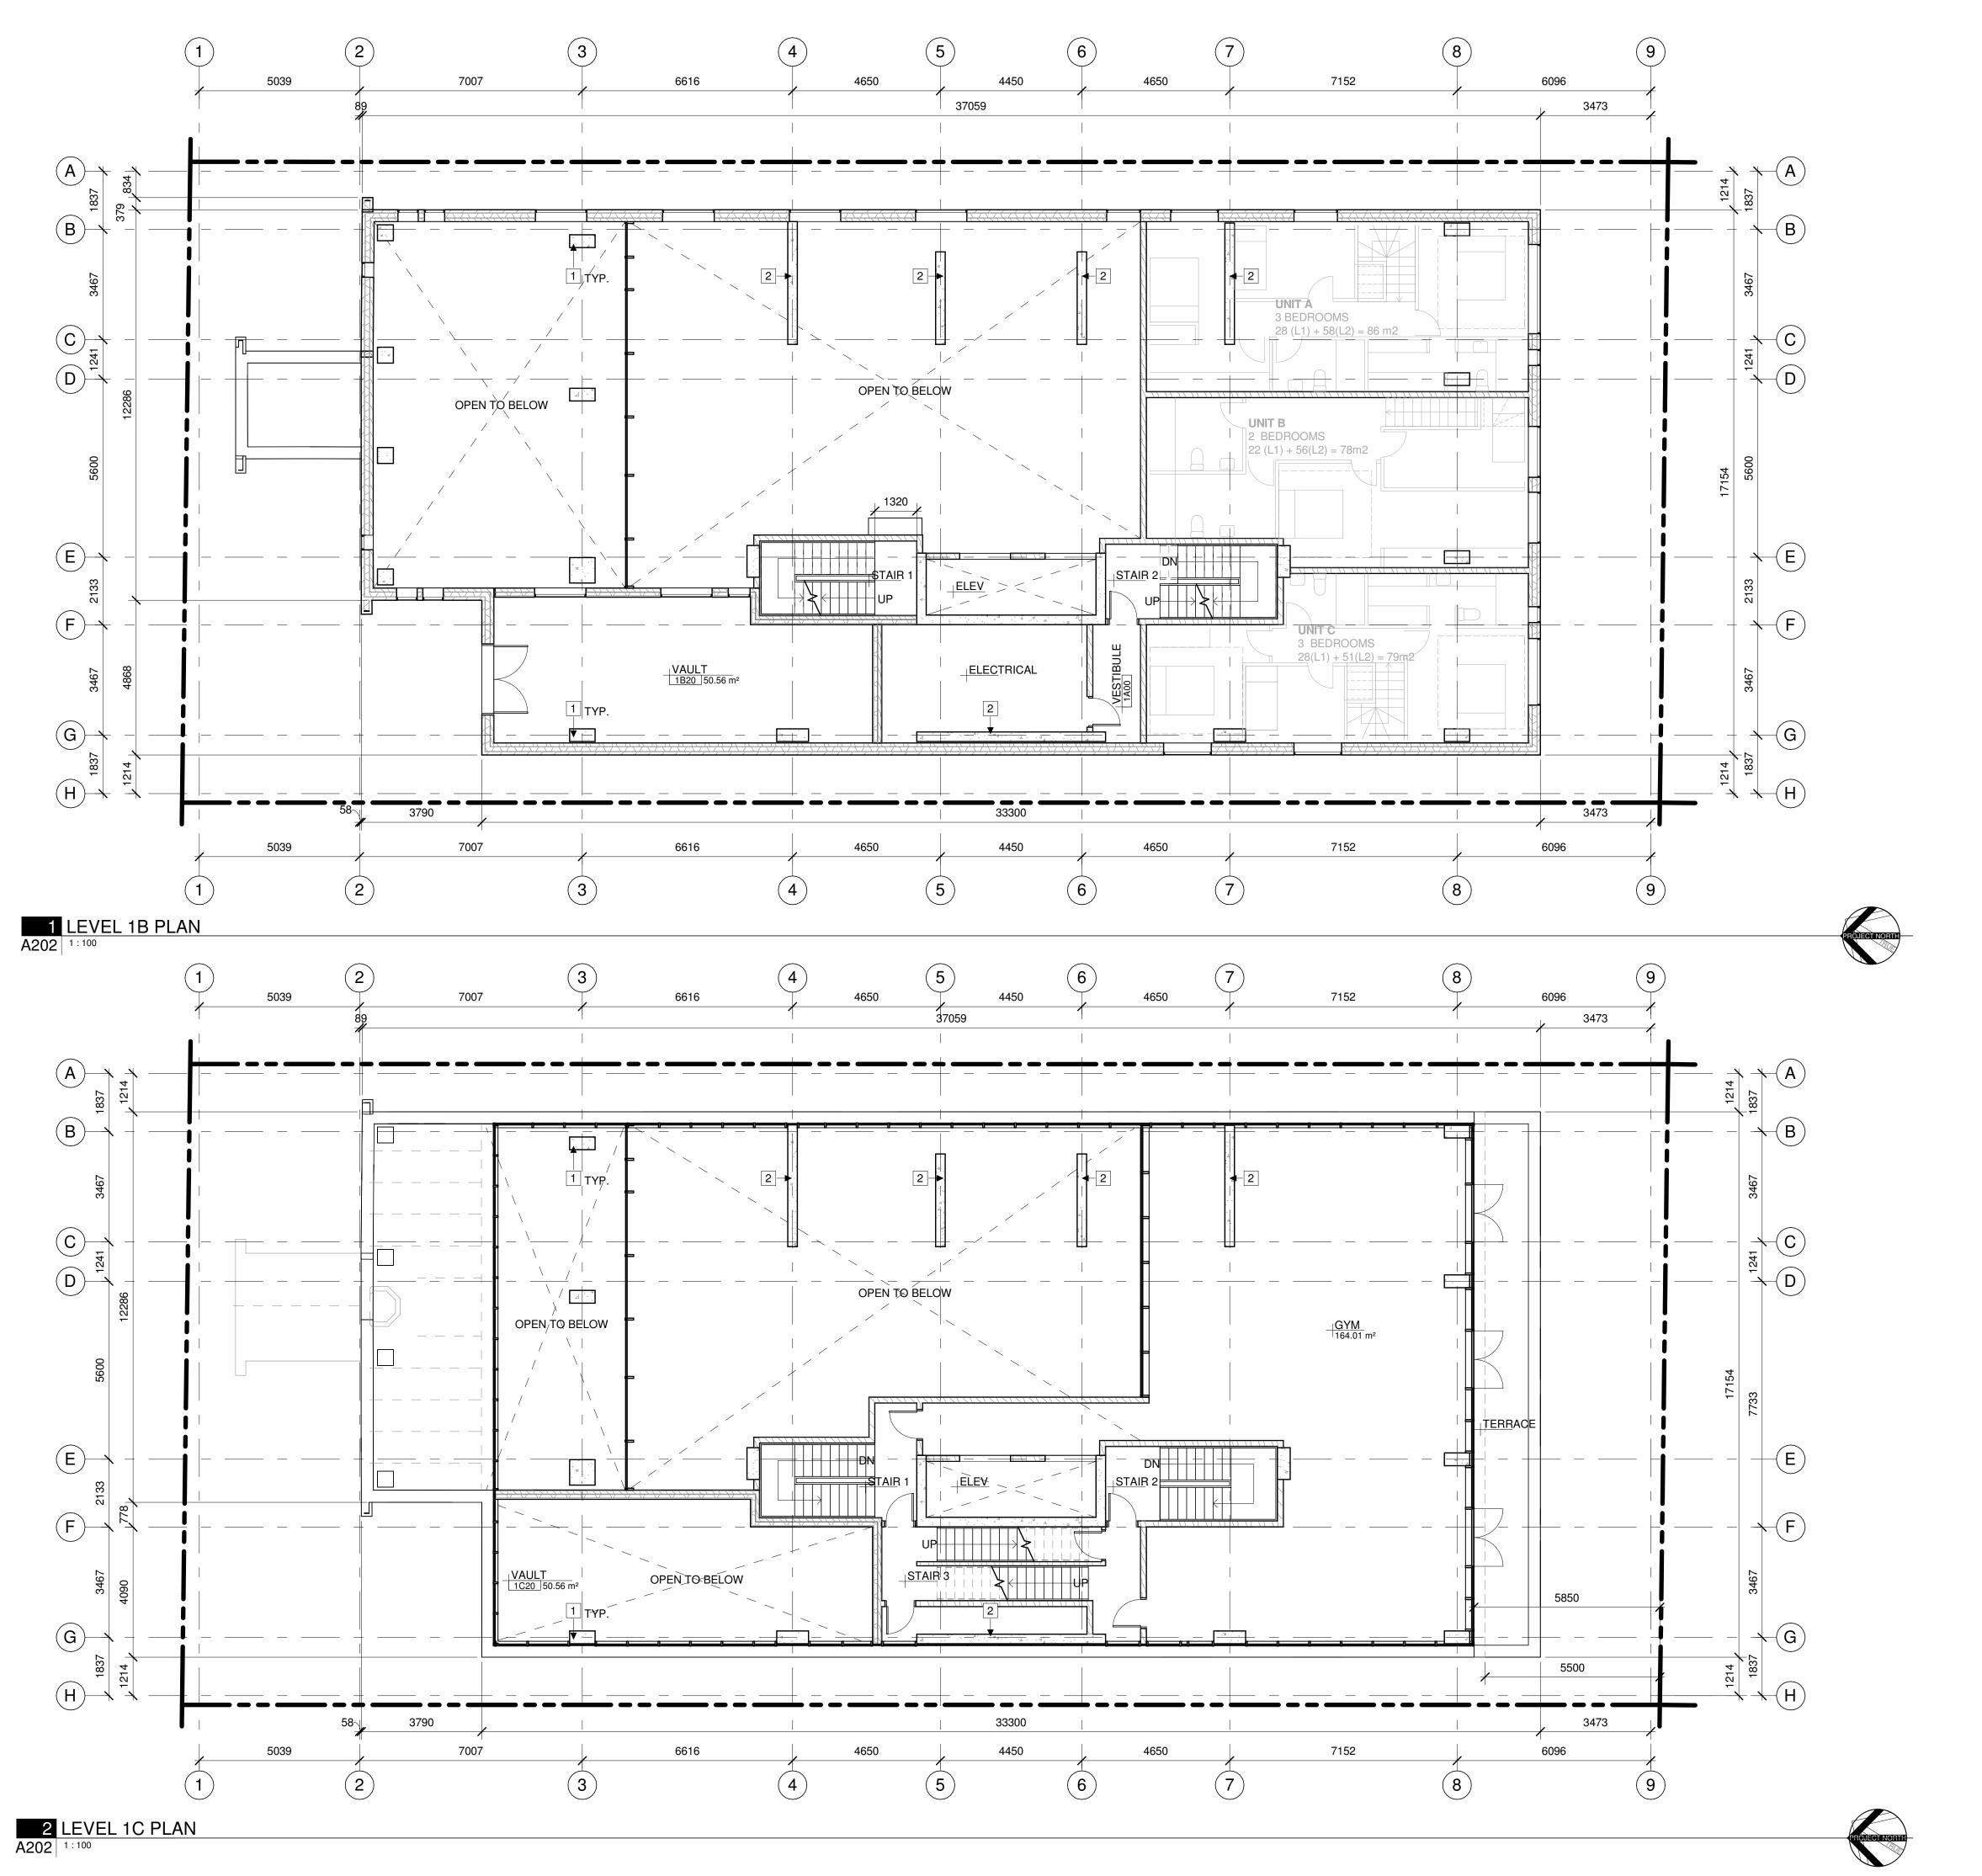
LEVEL -1 AND GROUND FLOOR PLANS

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A201

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- ENSURE 25mm MINIMUM THICKNESS OF CONCRETE COVER OVER VERTICAL STEEL REINFORCEMENT TO ALL REINFORCED CONCRETE STRUCTURAL COLUMNS AND WALLS.

REFERENCE PLAN KEYNOTES:

- 1 COLUMN PER STRUCTURAL
- 2 WALL PER STRUCTURAL

REFERENCE PLAN LEGEND:

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DESIGN CONCEPT ARCHITECT

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CLIENT



OTTAWA ONTARIO, CANADA

PROJECT

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254 Argyle Avenue, Ottawa, Ontario

TITLE

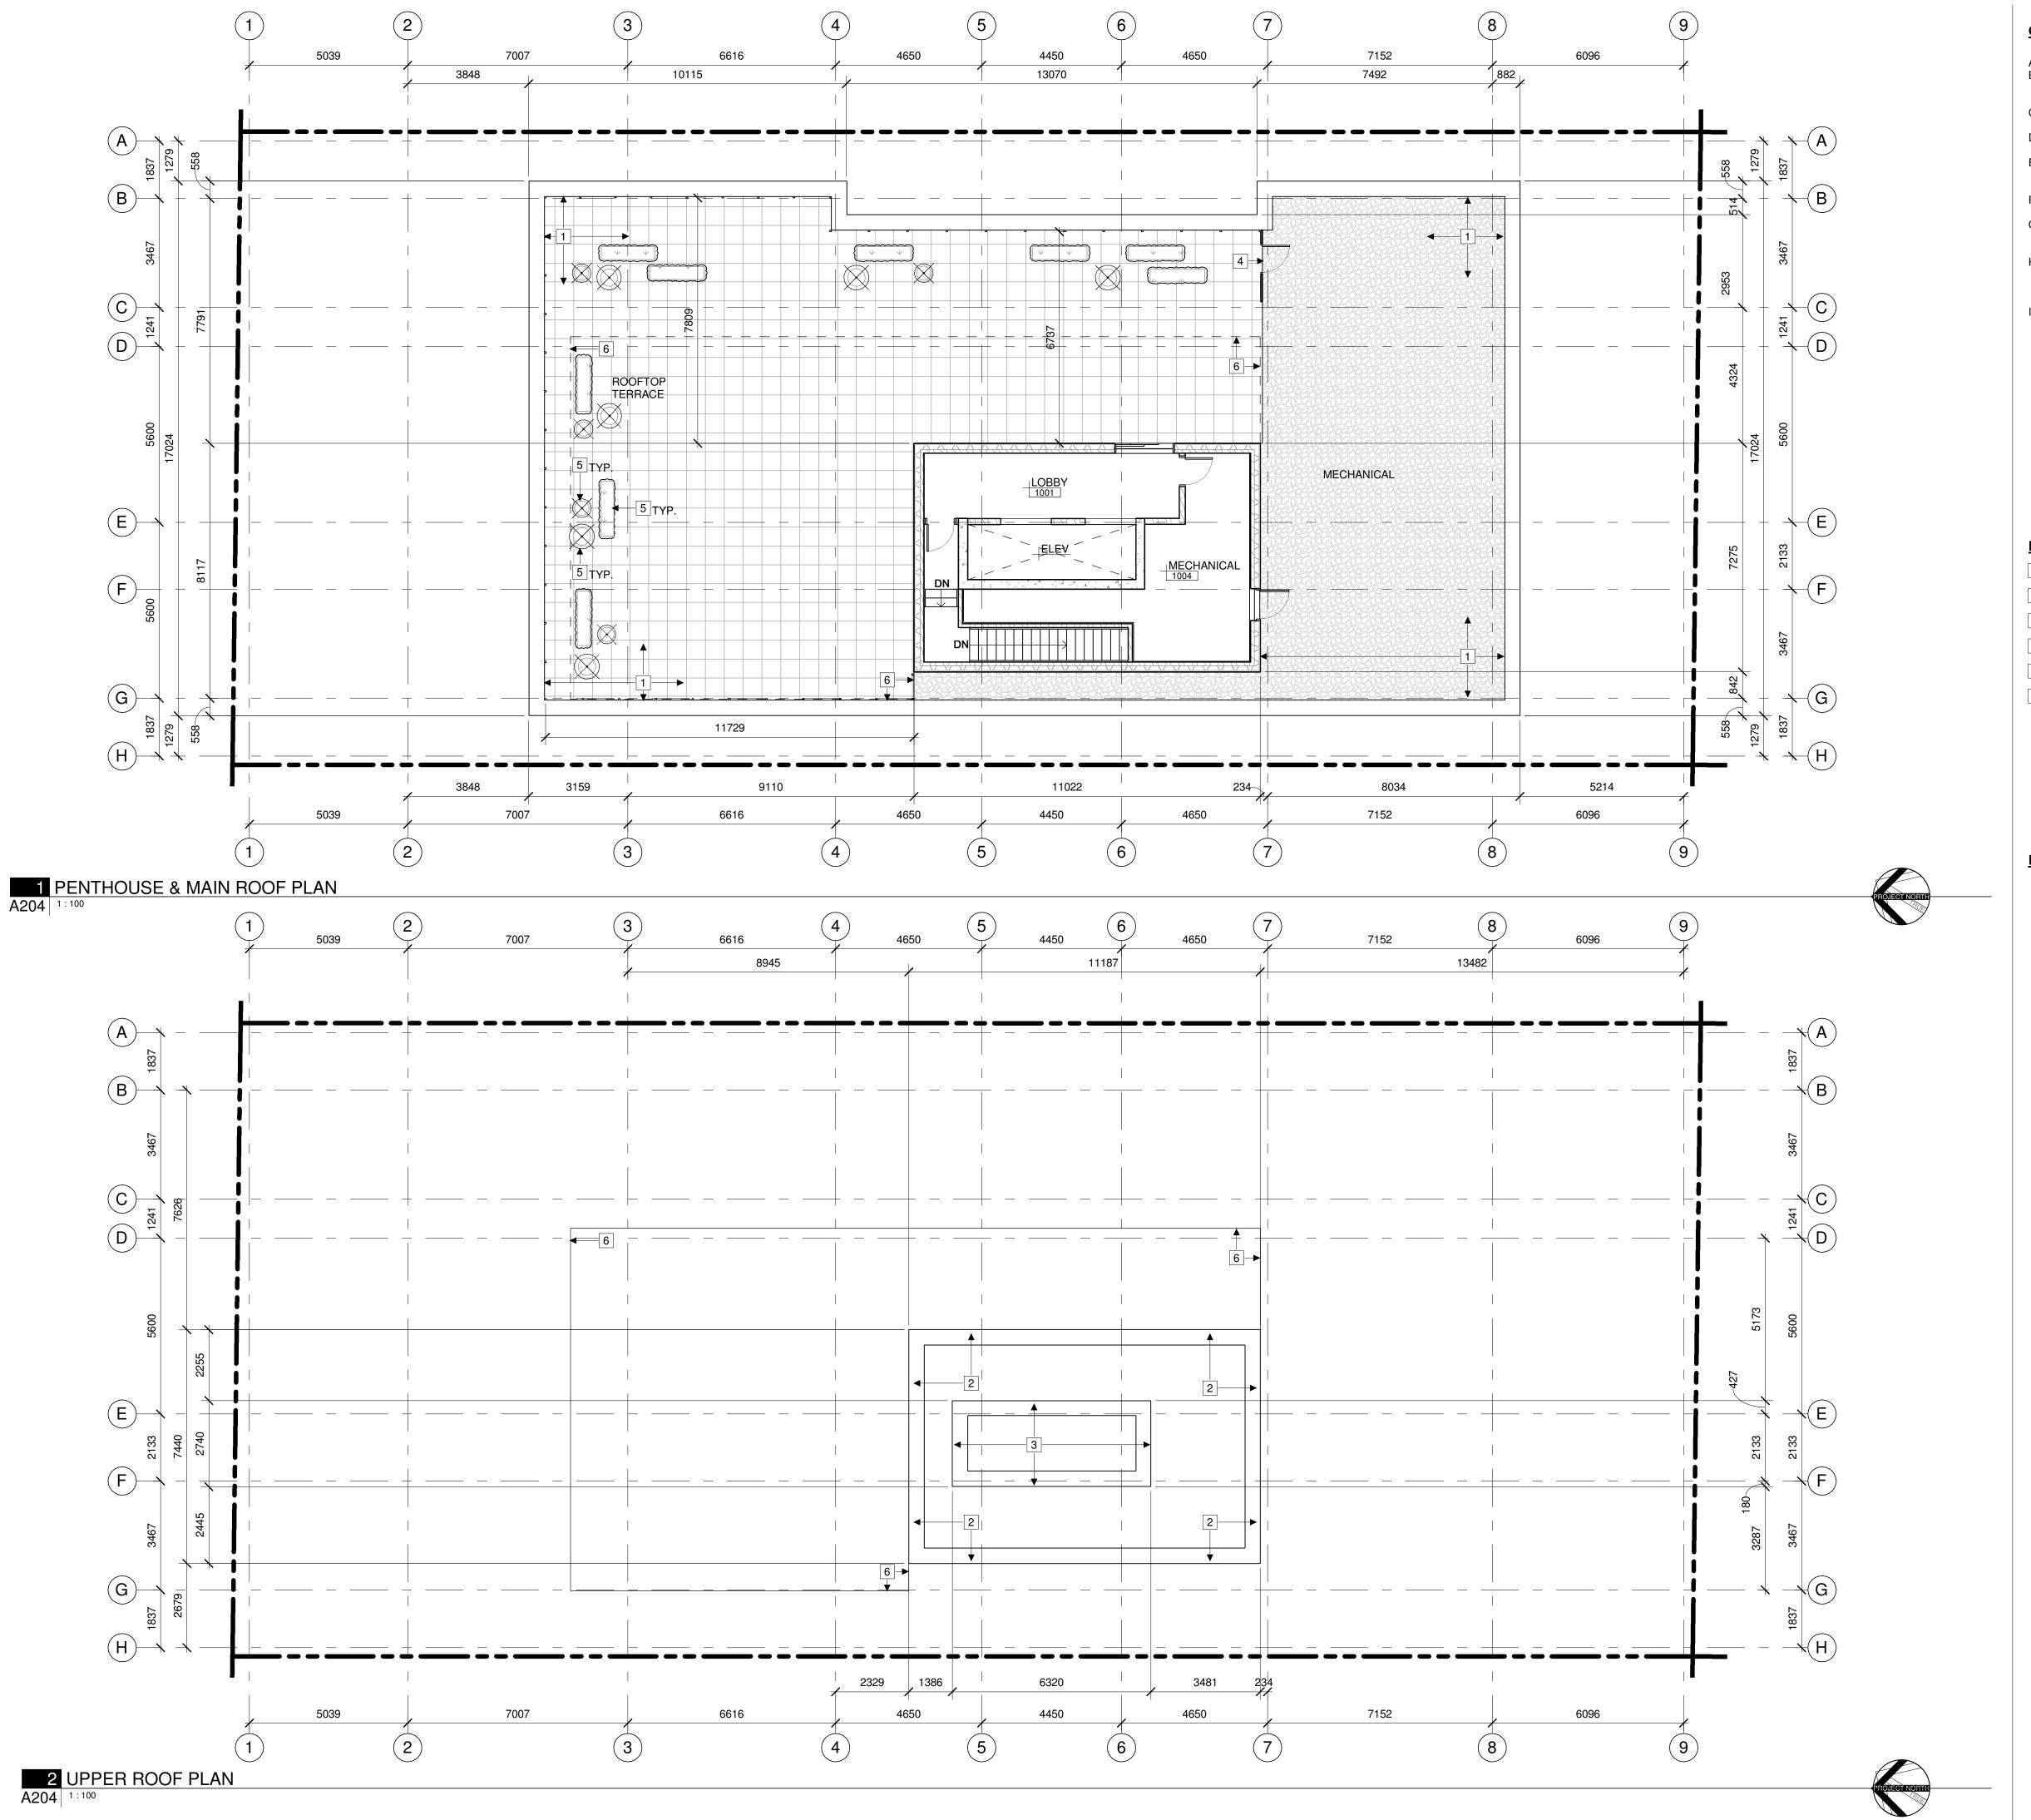
LEVEL 1B AND LEVEL 1C PLANS

PROJECT NO: 2023-0250 DRAWN: IK / EF / RK APPROVED: DH 1:100

REV DRAWING NO.

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CONCRETE STRUCTURAL COLUMNS AND WALLS.

REFERENCE PLAN KEYNOTES:

- 1 LOWER LEVEL ROOF
- 2 UPPER ROOF
- 3 ELVATOR SHAFT ROOF
- 4 ROOF SCREEN AND GATE
- 5 SHRUBS IN PLANTER
- 6 EXTENT OF PERGOLA

REFERENCE PLAN LEGEND:



NOT IN CONTRACT

ARCHITECT OF RECORD

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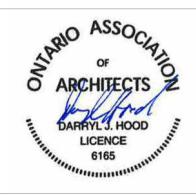
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OTTAWA ONTARIO, CANADA

PROJECT

254 ARGYLE

254 Argyle Avenue, Ottawa, Ontario

TITLE

ROOFS & PENTHOUSE PLANS

PROJECT NO: 2023-0250 DRAWN: IK / EF / RK APPROVED: DH 1:100

DRAWING NO.

DATE PRINTED: 12/13/2024 2:09:08 PM

A204