ELEVATION	UNPROTECTED OPENINGS	EXPOSED BUILDING FACE	RATIO	SETBACK	MAX EBO 9.10.14.4(1)(a)	MAX EBO 9.10.14.4(1)(c)	MAX RATIO 9.10.14.4(1)(c)	CONSTRUCTION
FRONT	48.83 m ²	123.42 m ²	39.56%	14.22 m	67.88 m²	202.21 m²	55%	COMBUSTABLE CONSTRUCTION & CLADDING PERMITTED, 45 MIN FRR MIN
LEFT	11.38 m ²	214.47 m ²	5.30%	1.20 m	15.01 m ²	1.44 m ²	7%	NON-COMBUSTABLE CONSTRUCTION & CLADDING REQ'D, 1 HR FRR
REAR	52.95 m²	123.42 m ²	42.90%	7.50 m	23.45 m ²	56.25 m²	19%	COMBUSTABLE CONSTRUCTION PERMITTED, NON-COMBUSTABLE CLADDING REQ'D, 1 HR FRR MIN
RIGHT	15.61 m²	214.47 m ²	7.28%	1.20 m	15.01 m ²	1.44 m ²	7%	NON-COMBUSTABLE CONSTRUCTION & CLADDING REQ'D, 1 HR FRR

 TOTAL
 128.76 m²
 675.78 m²
 19.05%

NOTE: • FOR REAR ELEVATION REFER TO A2.3 FOR LIMITING DISTANCE CALC WITH

 ACCESSORY BUILDING (UNIT 002/102) VS REMAINING EBO
 FOR RIGHT ELEVATION REFER TO A2.4 FOR LIMITING DISTANCE CALC BY FIRE COMPARTMENT AS PER 9.10.14.2.1.(ii)




	MATERIALS					
BV	BRICK VANEER					
CP	CONCRETE PARDGING					
CMP	HARDIEPLANK SIDING BY JAMES HARDIE					
GZG	42" GLASS GAURD					
MBM	METAL FRAMED BALCONY C/W WIRE SUPPORT @ 2ND AND 3RD FLOOR					
MF+MS	METAL FLASHING/EAVESTROUGH, & METAL SOFFIT					
MLR	METAL ROOFING					
MTL	METAL SIDING					
OSG	60" HIGH OPAQUE SCREEN GUARD					

j. guy monette architecture and urban design

arcfillecture and urban design308a fairmont ave.ottawa, on, K1Y 1Y8613.859.6483guymonette@rogers.com

ANDREW MCCREIGHT MANAGER, DEVELOPMENT REVIEW CENTRAL PLANNING, DEVELOPMENT & BUILDING SERVICES DEVELOPMENT DEPARTMENT, CITY OF OTTAWA

> **APPROVED** By Andrew McCreight at 12:17 pm, Mar 18, 2025

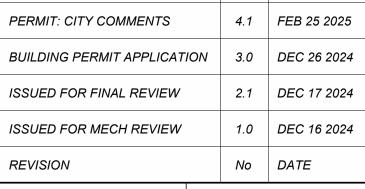



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Do not scale drawings.

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370 ATHLONE AVE OTTAWA, ON PROPOSED 16 UNIT APARTMENT

EAST ELEVATION

DESIGNED:	JASON GRANT-HENLEY	
DRAWN:	CHLOE CREW	ΛΟ 1
APPROVED	GUY MONETTE	AZ.I
SCALE:	3/8" = 1'-0"	

FOR SITE PLAN CONTROL


FILE NUMBER: D07-12-24-0114 PLAN NUMBER: #19203

ELEVATION	UNPROTECTED OPENINGS	EXPOSED BUILDING FACE	RATIO	SETBACK	MAX EBO 9.10.14.4(1)(a)	MAX EBO 9.10.14.4(1)(c)	MAX RATIO 9.10.14.4(1)(c)	CONSTRUCTION
FRONT	48.83 m²	123.42 m²	39.56%	14.22 m	67.88 m²	202.21 m ²	55%	COMBUSTABLE CONSTRUCTION & CLADDING PERMITTED, 45 MIN FRR MIN
LEFT	11.38 m²	214.47 m ²	5.30%	1.20 m	15.01 m ²	1.44 m²	7%	NON-COMBUSTABLE CONSTRUCTION & CLADDING REQ'D, 1 HR FRR
REAR	52.95 m²	123.42 m ²	42.90%	7.50 m	23.45 m ²	56.25 m ²	19%	COMBUSTABLE CONSTRUCTION PERMITTED, NON-COMBUSTABLE CLADDING REQ'D, 1 HR FRR MIN
RIGHT	15.61 m²	214.47 m ²	7.28%	1.20 m	15.01 m ²	1.44 m ²	7%	NON-COMBUSTABLE CONSTRUCTION & CLADDING REQ'D, 1 HR FRR

128.76 m² 675.78 m² 19.05% TOTAL

NOTE: • FOR REAR ELEVATION REFER TO A2.3 FOR LIMITING DISTANCE CALC WITH

ACCESSORY BUILDING (UNIT 002/102) VS REMAINING EBO • FOR RIGHT ELEVATION REFER TO A2.4 FOR LIMITING DISTANCE CALC BY FIRE COMPARTMENT AS PER 9.10.14.2.1.(ii)

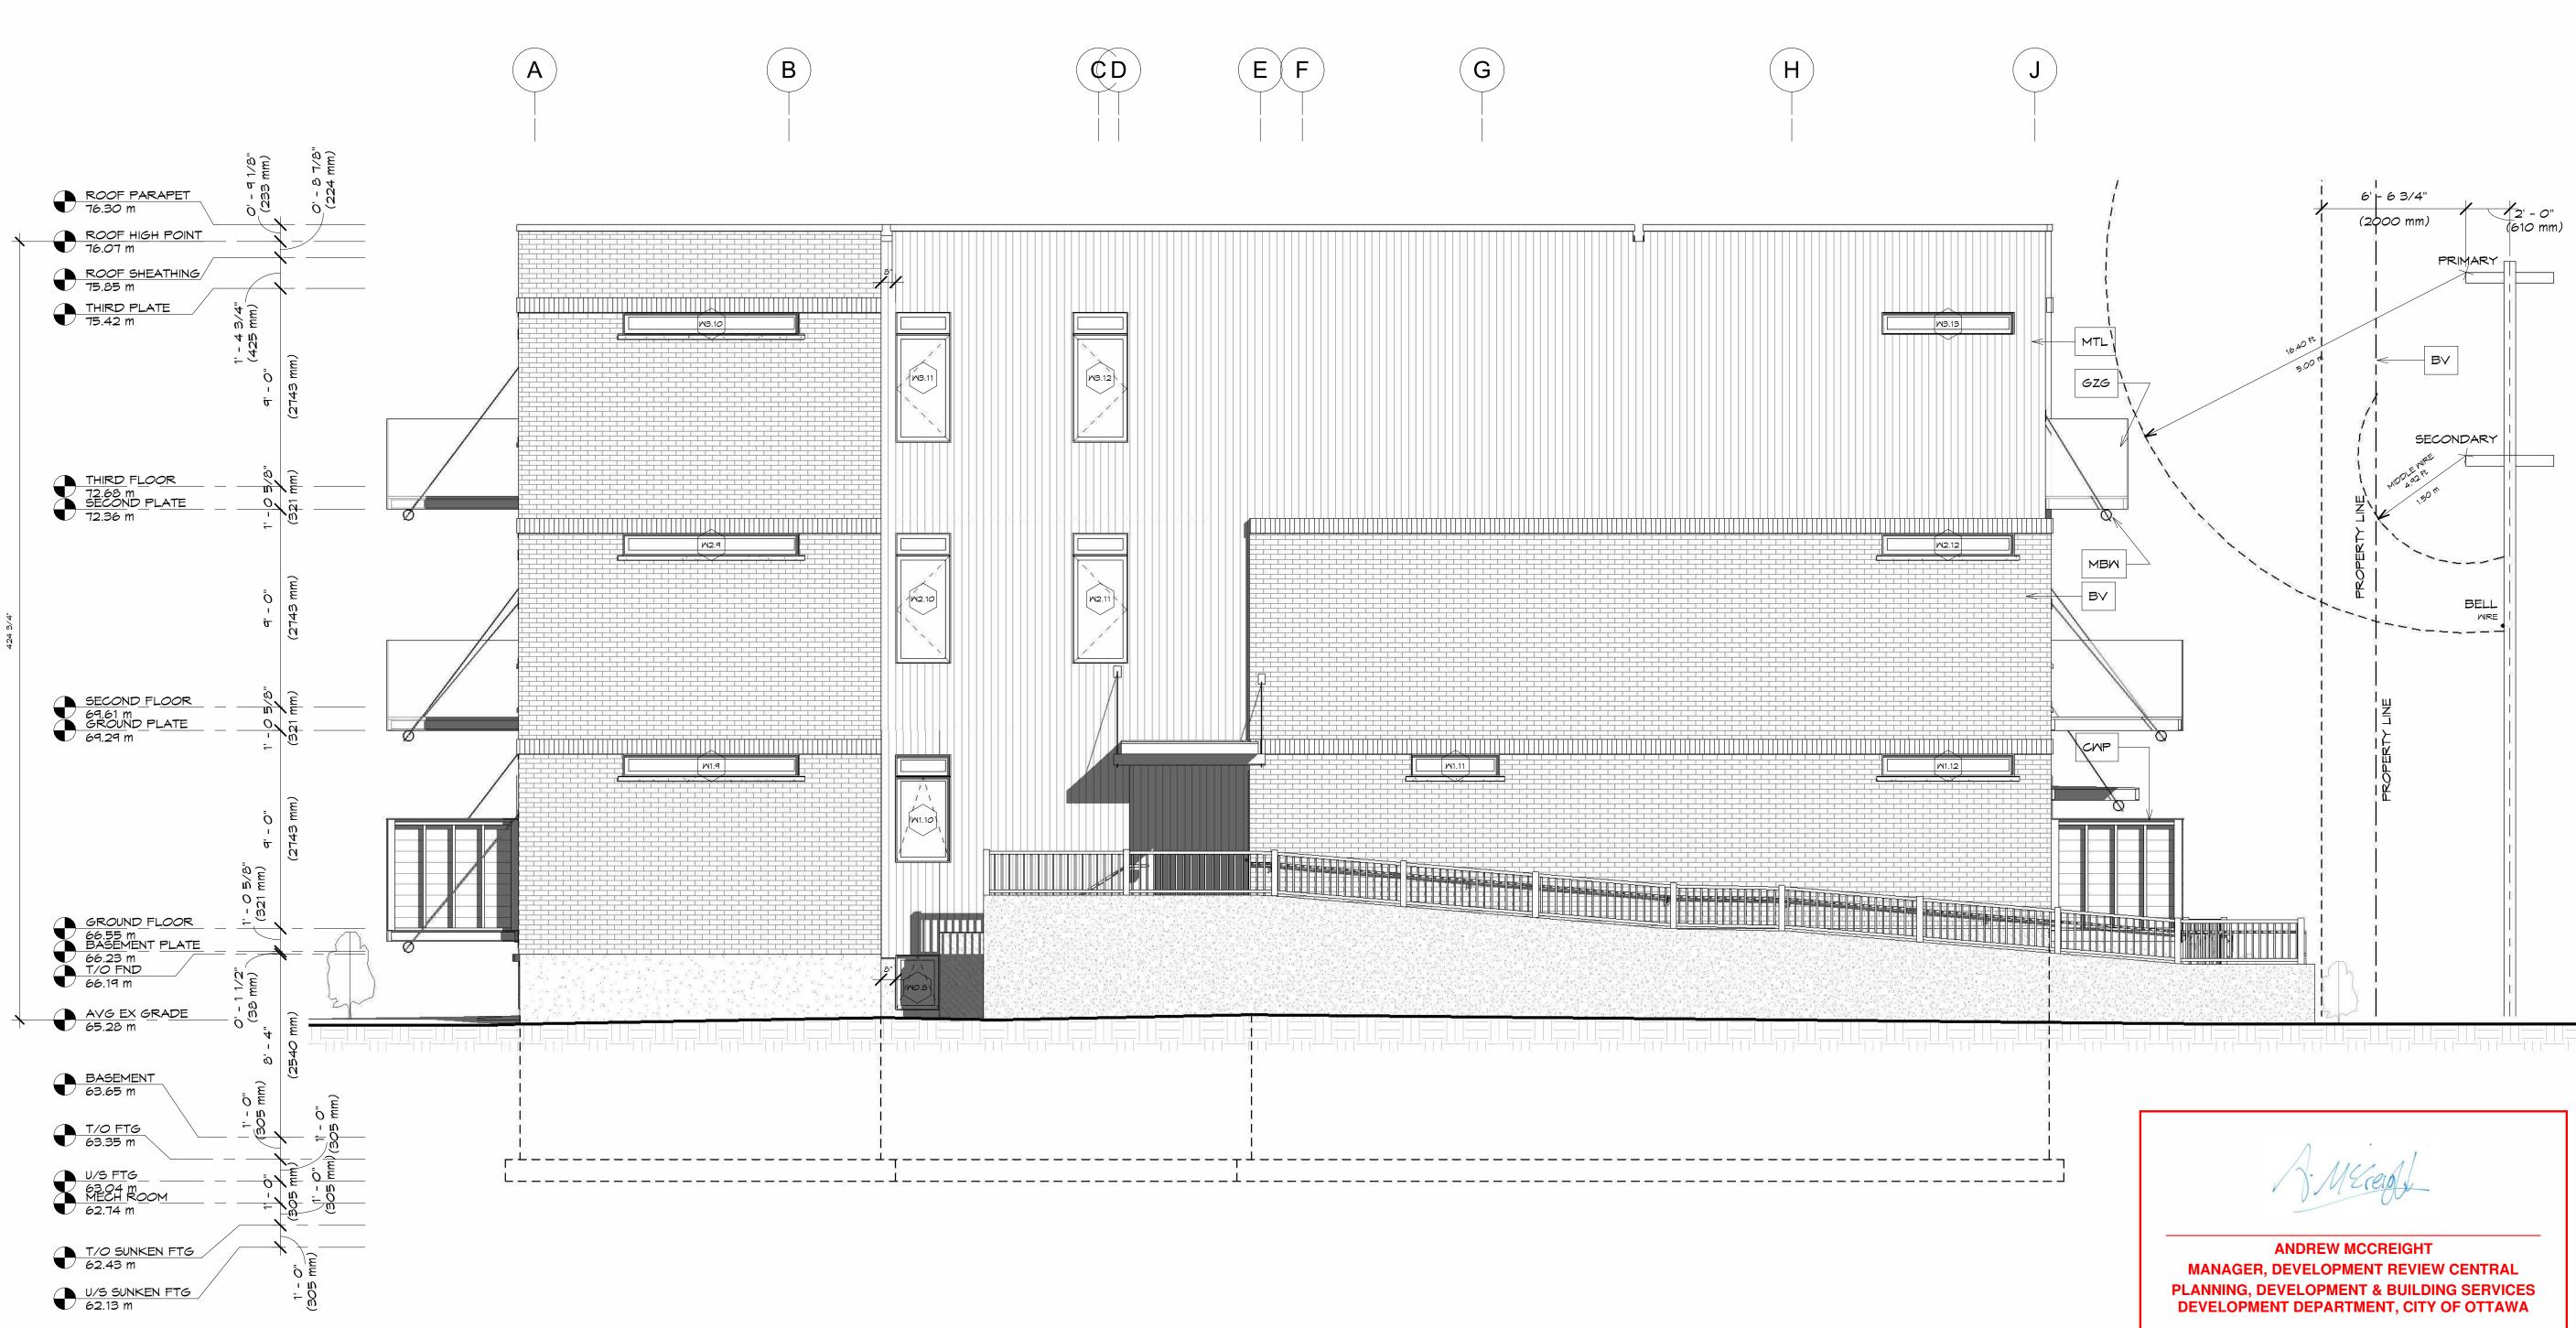

	MATERIALS					
BV	BRICK VANEER					
CP	CONCRETE PARDGING					
CMP	HARDIEPLANK SIDING BY JAMES HARDIE					
GZG	42" GLASS GAURD					
MBM	METAL FRAMED BALCONY C/W WIRE SUPPORT @ 2ND AND 3RD FLOOR					
MF+MS	METAL FLASHING/EAVESTROUGH, & METAL SOFFIT					
MLR	METAL ROOFING					
MTL	METAL SIDING					
OSG	60" HIGH OPAQUE SCREEN GUARD					

j. guy monette architecture and urban design

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APPROVED By Andrew McCreight at 12:17 pm, Mar 18, 2025

> FILE NUMBER: D07-12-24-0114 PLAN NUMBER: #19203

PERMIT: CITY COMMENTS	4.1	FEB 25 2025
BUILDING PERMIT APPLICATION	3.0	DEC 26 2024
ISSUED FOR FINAL REVIEW	2.1	DEC 17 2024
ISSUED FOR MECH REVIEW	1.0	DEC 16 2024
REVISION	No	DATE



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370 ATHLONE AVE OTTAWA, ON PROPOSED 16 UNIT APARTMENT

SOUTH ELEVATION

_		
_	DESIGNED: JASON GRANT-HENLEY	
	DRAWN: CHLOE CREW	ΛΟΟ
_	APPROVED: GUY MONETTE	AZ.Z
_	<i>SCALE:</i> 1/4" = 1'-0"	
-	FOR SITE PLAN CONTROL	

ELEVATION	UNPROTECTED OPENINGS	EXPOSED BUILDING FACE	RATIO	SETBACK	MAX EBO 9.10.14.4(1)(a)	MAX EBO 9.10.14.4(1)(c)	MAX RATIO 9.10.14.4(1)(c)	CONSTRUCTION
FRONT	48.83 m ²	123.42 m ²	39.56%	14.22 m	67.88 m²	202.21 m ²	55%	COMBUSTABLE CONSTRUCTION & CLADDING PERMITTED, 45 MIN FRR MIN
LEFT	11.38 m ²	214.47 m ²	5.30%	1.20 m	15.01 m ²	1.44 m²	7%	NON-COMBUSTABLE CONSTRUCTION & CLADDING REQ'D, 1 HR FRR
REAR	52.95 m²	123.42 m ²	42.90%	7.50 m	23.45 m ²	56.25 m ²	19%	COMBUSTABLE CONSTRUCTION PERMITTED, NON-COMBUSTABLE CLADDING REQ'D, 1 HR FRR MIN
RIGHT	15.61 m²	214.47 m ²	7.28%	1.20 m	15.01 m ²	1.44 m²	7%	NON-COMBUSTABLE CONSTRUCTION & CLADDING REQ'D, 1 HR FRR

675.78 m² 19.05% 128.76 m² TOTAL

NOTE: • FOR REAR ELEVATION REFER TO A2.3 FOR LIMITING DISTANCE CALC WITH

REMAINING LIMITING DISTANCE CALCULATION BY TOAL AREA / 9.10.14.2.(b)(i) OVERALL EBO: 123.42m² EBO: 98.47m²


EBO: 96.47m² SETBACK: 7.50m MAX OPENING AS PER 9.10.14.4.1.(a): 19% (18.70m²) MAX OPENING AS PER 9.10.14.4.1.(c): <u>56.25m²</u> PROVIDED: 40.43m²

UNIT 002 LIMITING DISTANCE CALCULATION BY FIRE COMPARTMENT / 9.10.14.2.(b)(ii) (OVERLAP WITH ACCESSORY BUILDING) EBO: 16.14m² SETBACK: 3.05m MAX OPENING AS PER 9.10.14.4.1.(a): 30% (4.84m²) MAX OPENING AS PER 9.10.14.4.1.(c): <u>9.30m²</u> PROVIDED: 8.02m²

UNIT 002 LIMITING DISTANCE CALCULATION BY FIRE COMPARTMENT / 9.10.14.2.(b)(ii) (OVERLAP WITH ACCESSORY BUILDING) EBO: 8.52m² SETBACK: 3.05m MAX OPENING AS PER 9.10.14.4.1.(a): 55% (4.68m²) MAX OPENING AS PER 9.10.14.4.1.(c): <u>9.30m²</u> PROVIDED: 4.64m²

PROVIDED: 4.64m²

ACCESSORY BUILDING (UNIT 002/102) VS REMAINING EBO • FOR RIGHT ELEVATION REFER TO A2.4 FOR LIMITING DISTANCE CALC BY FIRE COMPARTMENT AS PER 9.10.14.2.1.(ii)

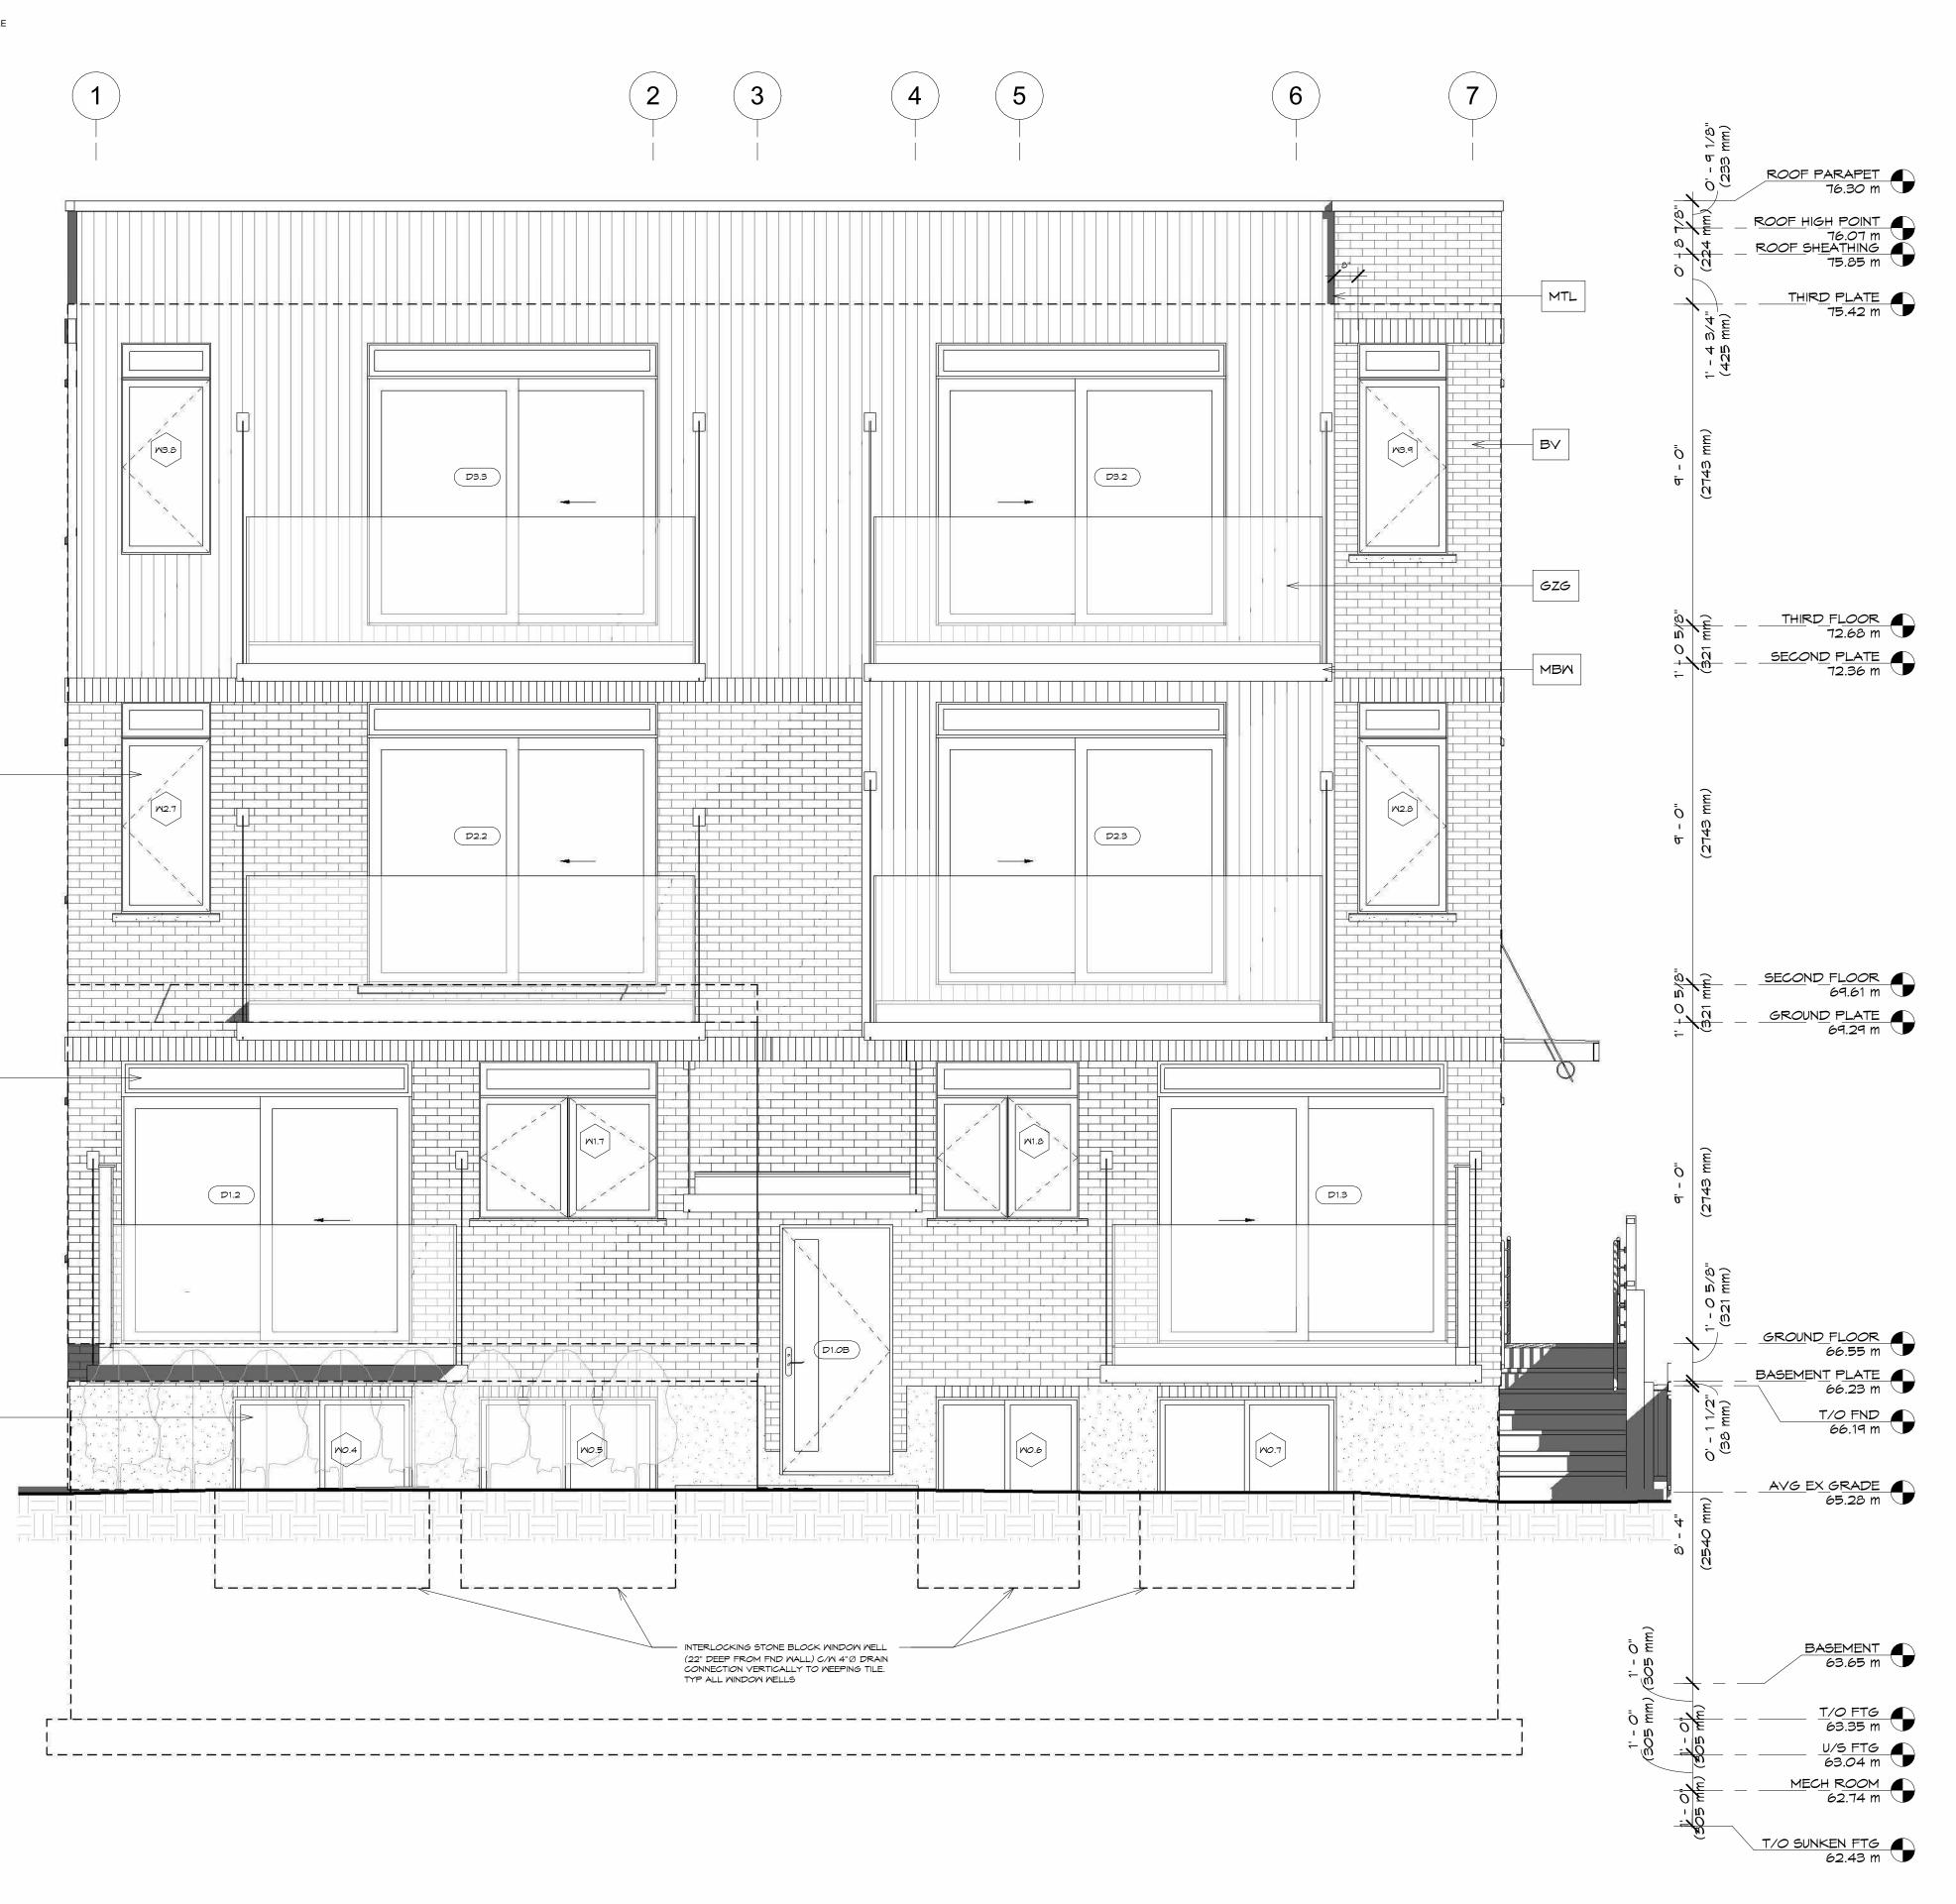

	MATERIALS				
BV	BRICK VANEER				
CP	CONCRETE PARDGING				
CMP	HARDIEPLANK SIDING BY JAMES HARDIE				
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370 ATHLONE AVE OTTAWA, ON

PROPOSED 16 UNIT APARTMENT

WEST ELEVATION

DESIGNED: JASON GRANT-HENLEY	
DRAWN: CHLOE CREW	VJ3
APPROVED: GUY MONETTE	A2.3
SCALE: 3/8" = 1'-0"	-
FOR SITE PLAN CONTROL	

ANDREW MCCREIGHT MANAGER, DEVELOPMENT REVIEW CENTRAL **PLANNING, DEVELOPMENT & BUILDING SERVICES DEVELOPMENT DEPARTMENT, CITY OF OTTAWA**

> APPROVED By Andrew McCreight at 12:17 pm, Mar 18, 2025


FILE NUMBER: D07-12-24-0114 PLAN NUMBER: #19203

ELEVATION	UNPROTECTED OPENINGS	EXPOSED BUILDING FACE	RATIO	SETBACK	MAX EBO 9.10.14.4(1)(a)	MAX EBO 9.10.14.4(1)(c)	MAX RATIO 9.10.14.4(1)(c)	CONSTRUCTION
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128.76 m² 675.78 m² 19.05% TOTAL


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ACCESSORY BUILDING (UNIT 002/102) VS REMAINING EBO • FOR RIGHT ELEVATION REFER TO A2.4 FOR LIMITING DISTANCE CALC BY FIRE COMPARTMENT AS PER 9.10.14.2.1.(ii)



G	F E I I		B	A
		MTL		D
				VB.7
C/L OF FIRE SEPARATION				

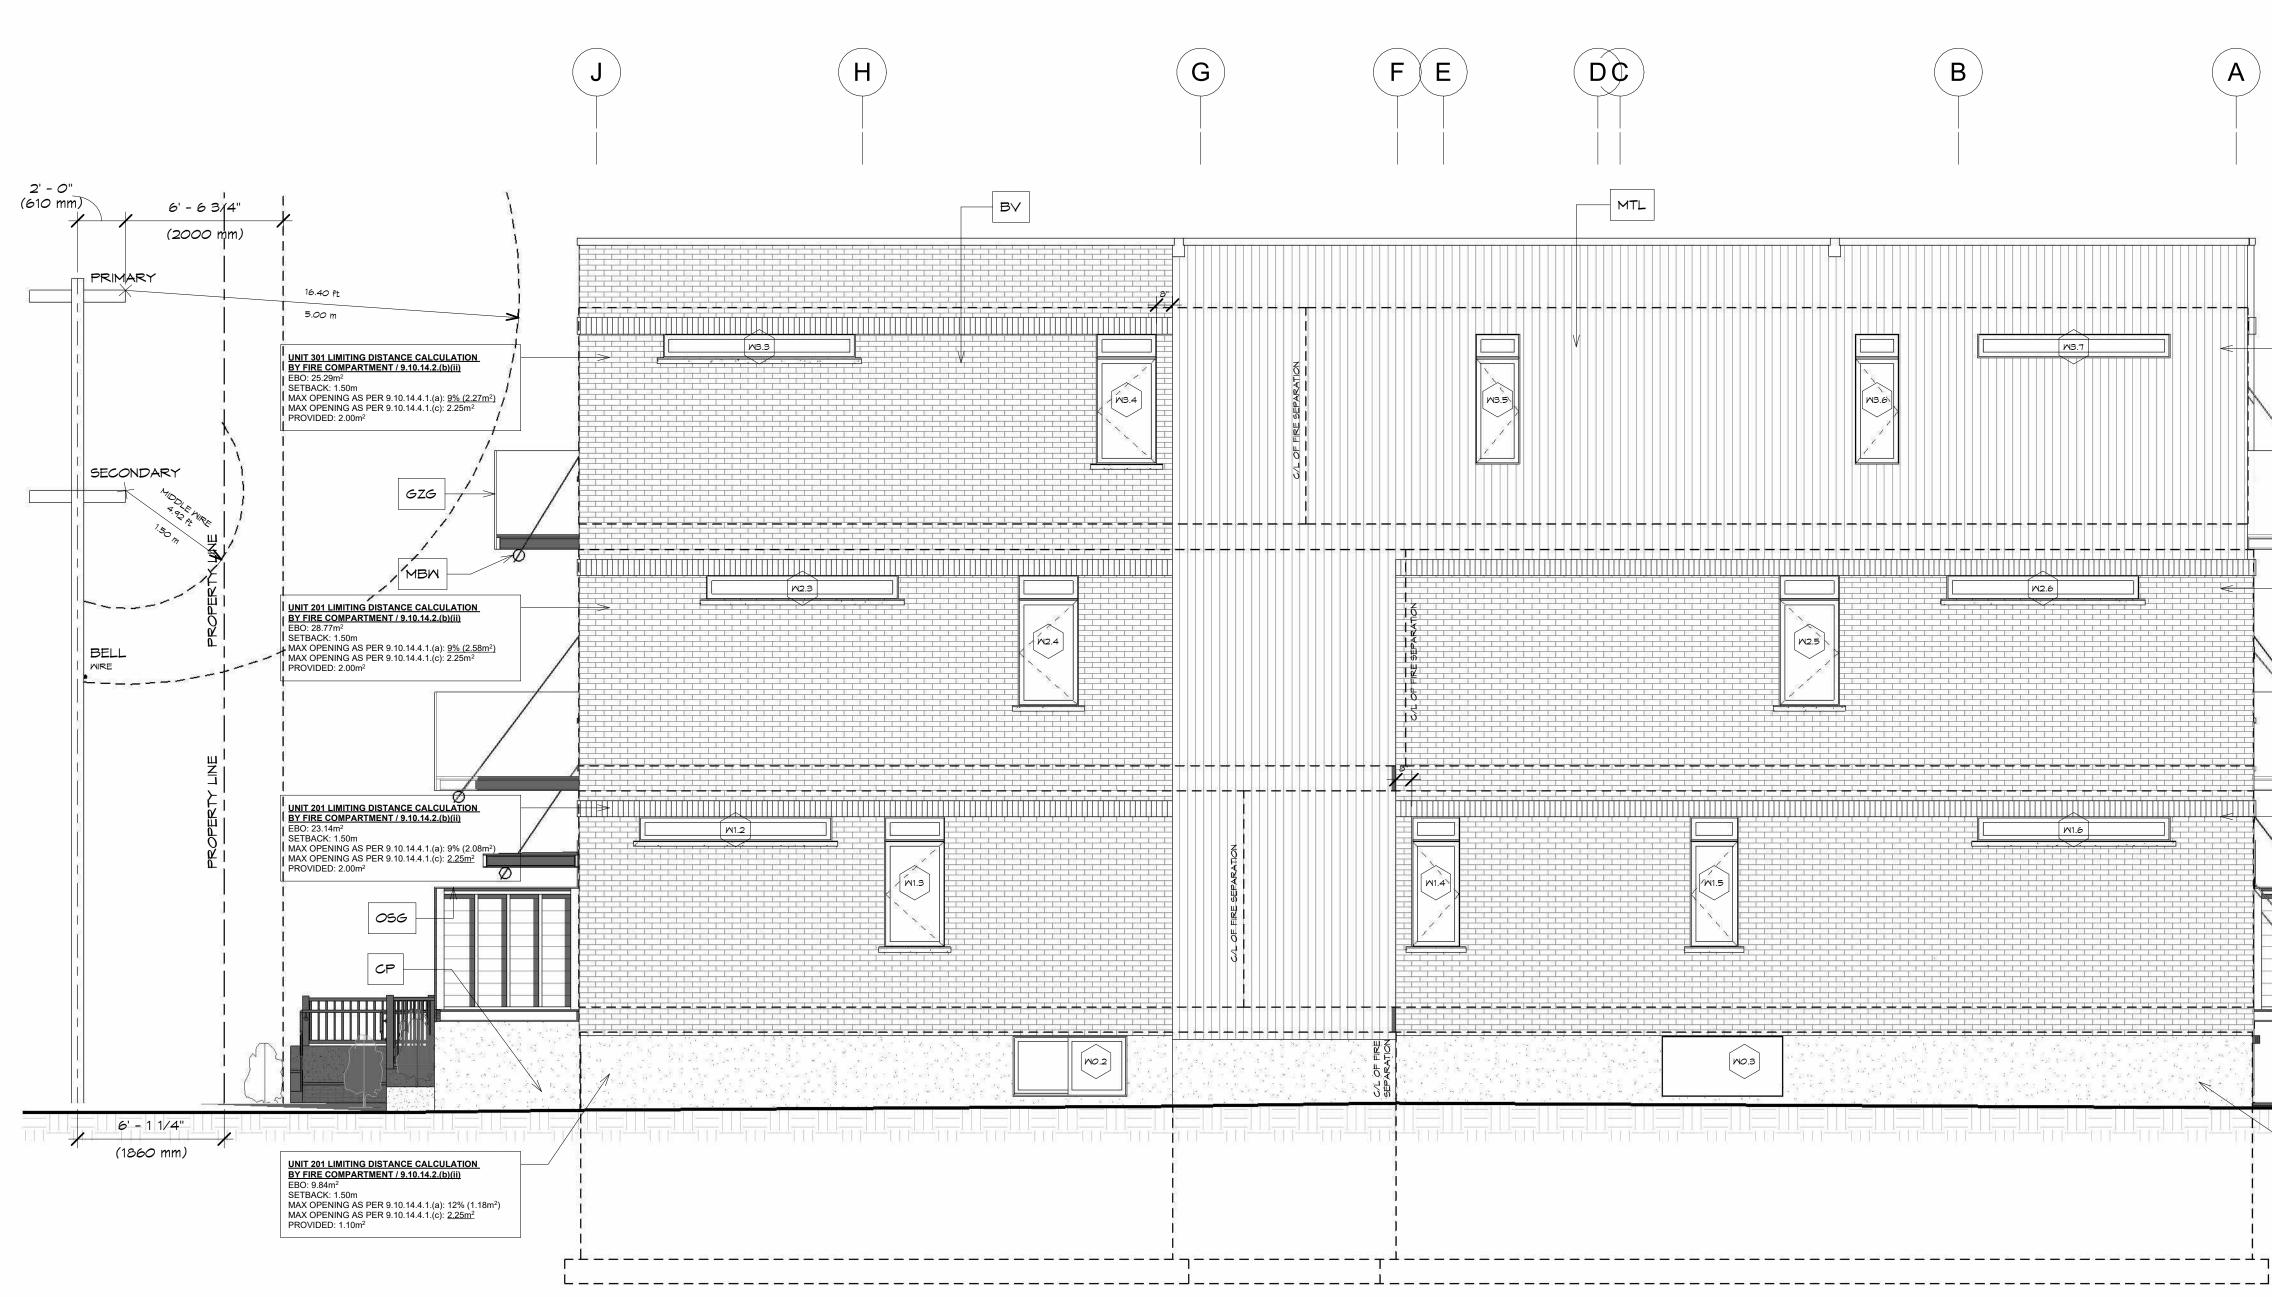ANDREW MCCREIGHT MANAGER, DEVELOPMENT REVIEW CENTRAL PLANNING, DEVELOPMENT & BUILDING SERVICES **DEVELOPMENT DEPARTMENT, CITY OF OTTAWA** APPROVED By Andrew McCreight at 12:17 pm, Mar 18, 2025

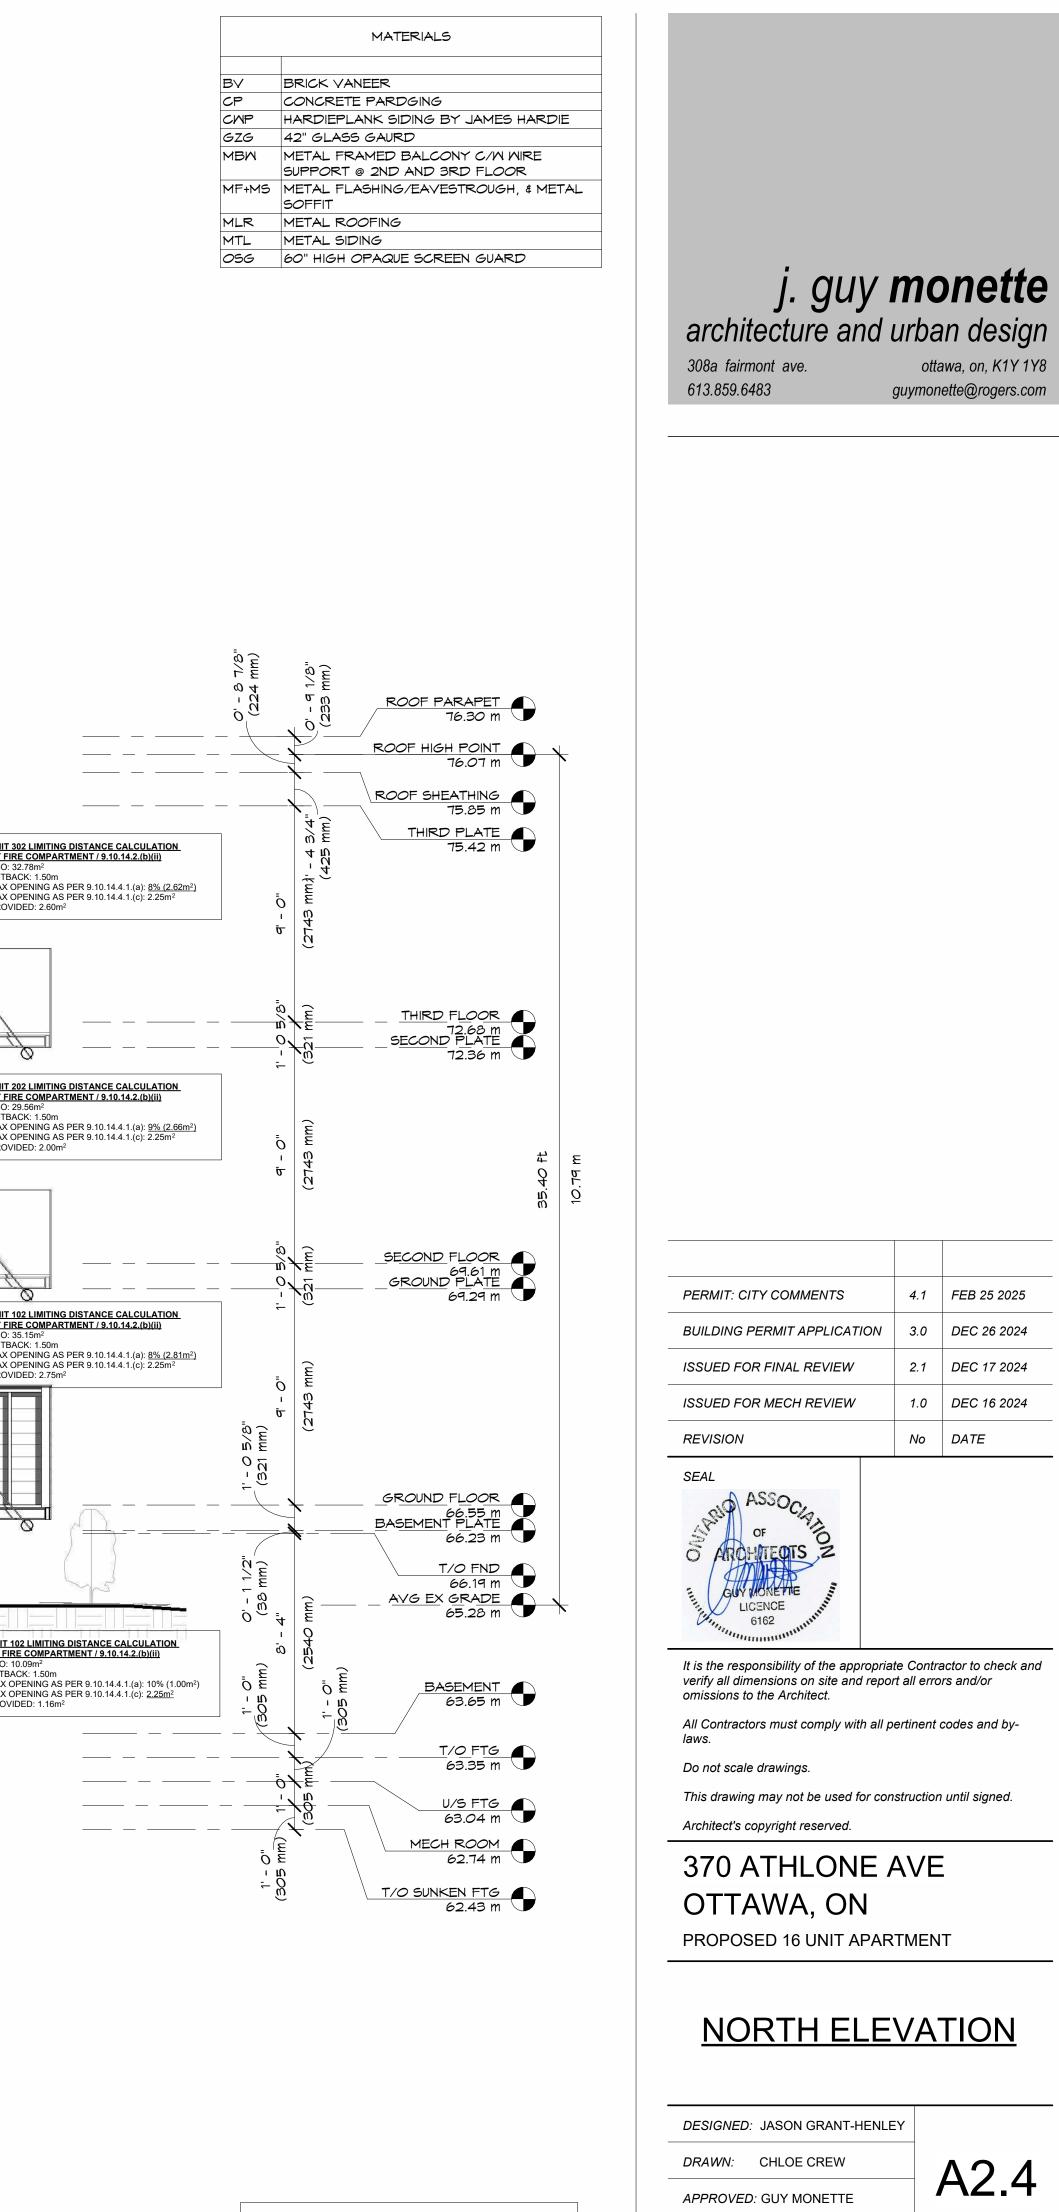

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FOR SITE PLAN CONTROL

SCALE: 1/4" = 1'-0"