



Reforestation Mix						
%	QTY	BOTANICAL NAME	COMMON NAME	SIZE	COND	SPACING
5%	24	<i>Abies balsamea</i>	Balsam Fir	0.60m H	PT	2.0m O.C.
5%	24	<i>Larix laricina</i>	Tamarack	0.60m H	PT	2.0m O.C.
5%	24	<i>Pinus strobus</i>	Jack Pine	0.60m H	PT	2.0m O.C.
5%	24	<i>Pinus strobus</i>	Eastern White Pine	0.60m H	PT	2.0m O.C.
5%	24	<i>Thuja occidentalis</i>	Eastern White Cedar	0.60m H	PT	2.0m O.C.

Dry Shrub Mix						
%	QTY	BOTANICAL NAME	COMMON NAME	SIZE	COND	SPACING
10%	21	<i>Aronia melanocarpa</i>	Black Chokeberry	0.60m H	PT	2.0m O.C.
10%	21	<i>Ceanothus americanus</i>	New Jersey Tea	0.60m H	PT	2.0m O.C.
10%	21	<i>Dierama litoricera</i>	Northern Bush Honeysuckle	0.60m H	PT	2.0m O.C.
10%	21	<i>Physocarpus opulifolius</i>	Common Ninebark	0.60m H	PT	2.0m O.C.
10%	21	<i>Rhus typhina</i>	Staghorn Sumac	0.60m H	PT	2.0m O.C.
10%	21	<i>Rhus aromatica</i>	Fragrant Sumac	0.60m H	PT	2.0m O.C.
10%	21	<i>Rosa blanda</i>	Meadow Rose	0.60m H	PT	2.0m O.C.
10%	21	<i>Rubus occidentalis</i>	Black Raspberry	0.60m H	PT	2.0m O.C.
10%	21	<i>Rubus odoratus</i>	Flowering Raspberry	0.60m H	PT	2.0m O.C.
10%	21	<i>Symporicarpos alba</i>	Snowberry	0.60m H	PT	2.0m O.C.

Wetshrub Mix						
%	QTY	BOTANICAL NAME	COMMON NAME	SIZE	COND	SPACING
10%	41	<i>Ailanthus altissima ssp. rugosissima</i>	Speckled Alder	0.60m H	PT	2.0m O.C.
10%	41	<i>Betula populifolia</i>	Gray Birch	0.60m H	PT	2.0m O.C.
10%	41	<i>Cephaelanthus occidentalis</i>	Butternut	0.60m H	PT	2.0m O.C.
5%	20	<i>Corus americana</i>	Trembling Aspen	1.20m H	PT	2.0m O.C.
10%	49	<i>Prunus serotina</i>	Black Cherry	1.20m H	PT	2.0m O.C.
5%	24	<i>Quercus rubra</i>	Red Oak	1.20m H	PT	2.0m O.C.
5%	24	<i>Tilia americana</i>	Basswood	1.20m H	PT	2.0m O.C.

KEY	QTY	BOTANICAL NAME	COMMON NAME	SIZE	COND	SPACING	NATIVE/NO-NATIVE
ABA	6	<i>Abies balsamea</i>	Balsam Fir	200cm H	WB	As Shown	Native
LL	9	<i>Larix laricina</i>	Tamarack	200cm H	WB	As Shown	Native
PM	6	<i>Picea mariana</i>	Black Spruce	200cm H	WB	As Shown	Native
PNS	8	<i>Pinus strobus</i>	Eastern White Pine	200cm H	WB	As Shown	Native
TO	9	<i>Thuja occidentalis</i>	Eastern White Cedar	200cm H	WB	As Shown	Native
TCS	1	<i>Tsuga canadensis</i>	Eastern Hemlock	200cm H	WB	As Shown	Native



LEGEND

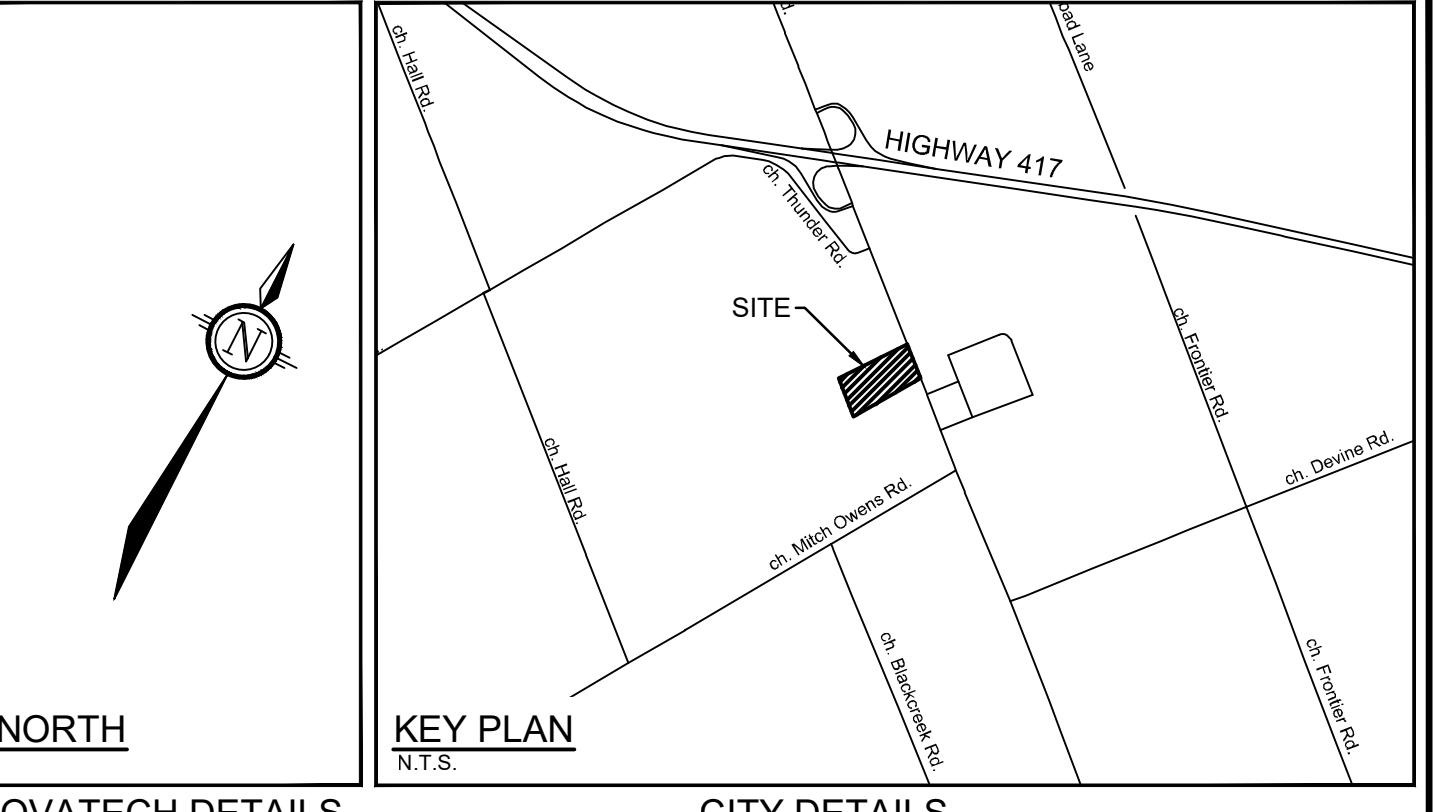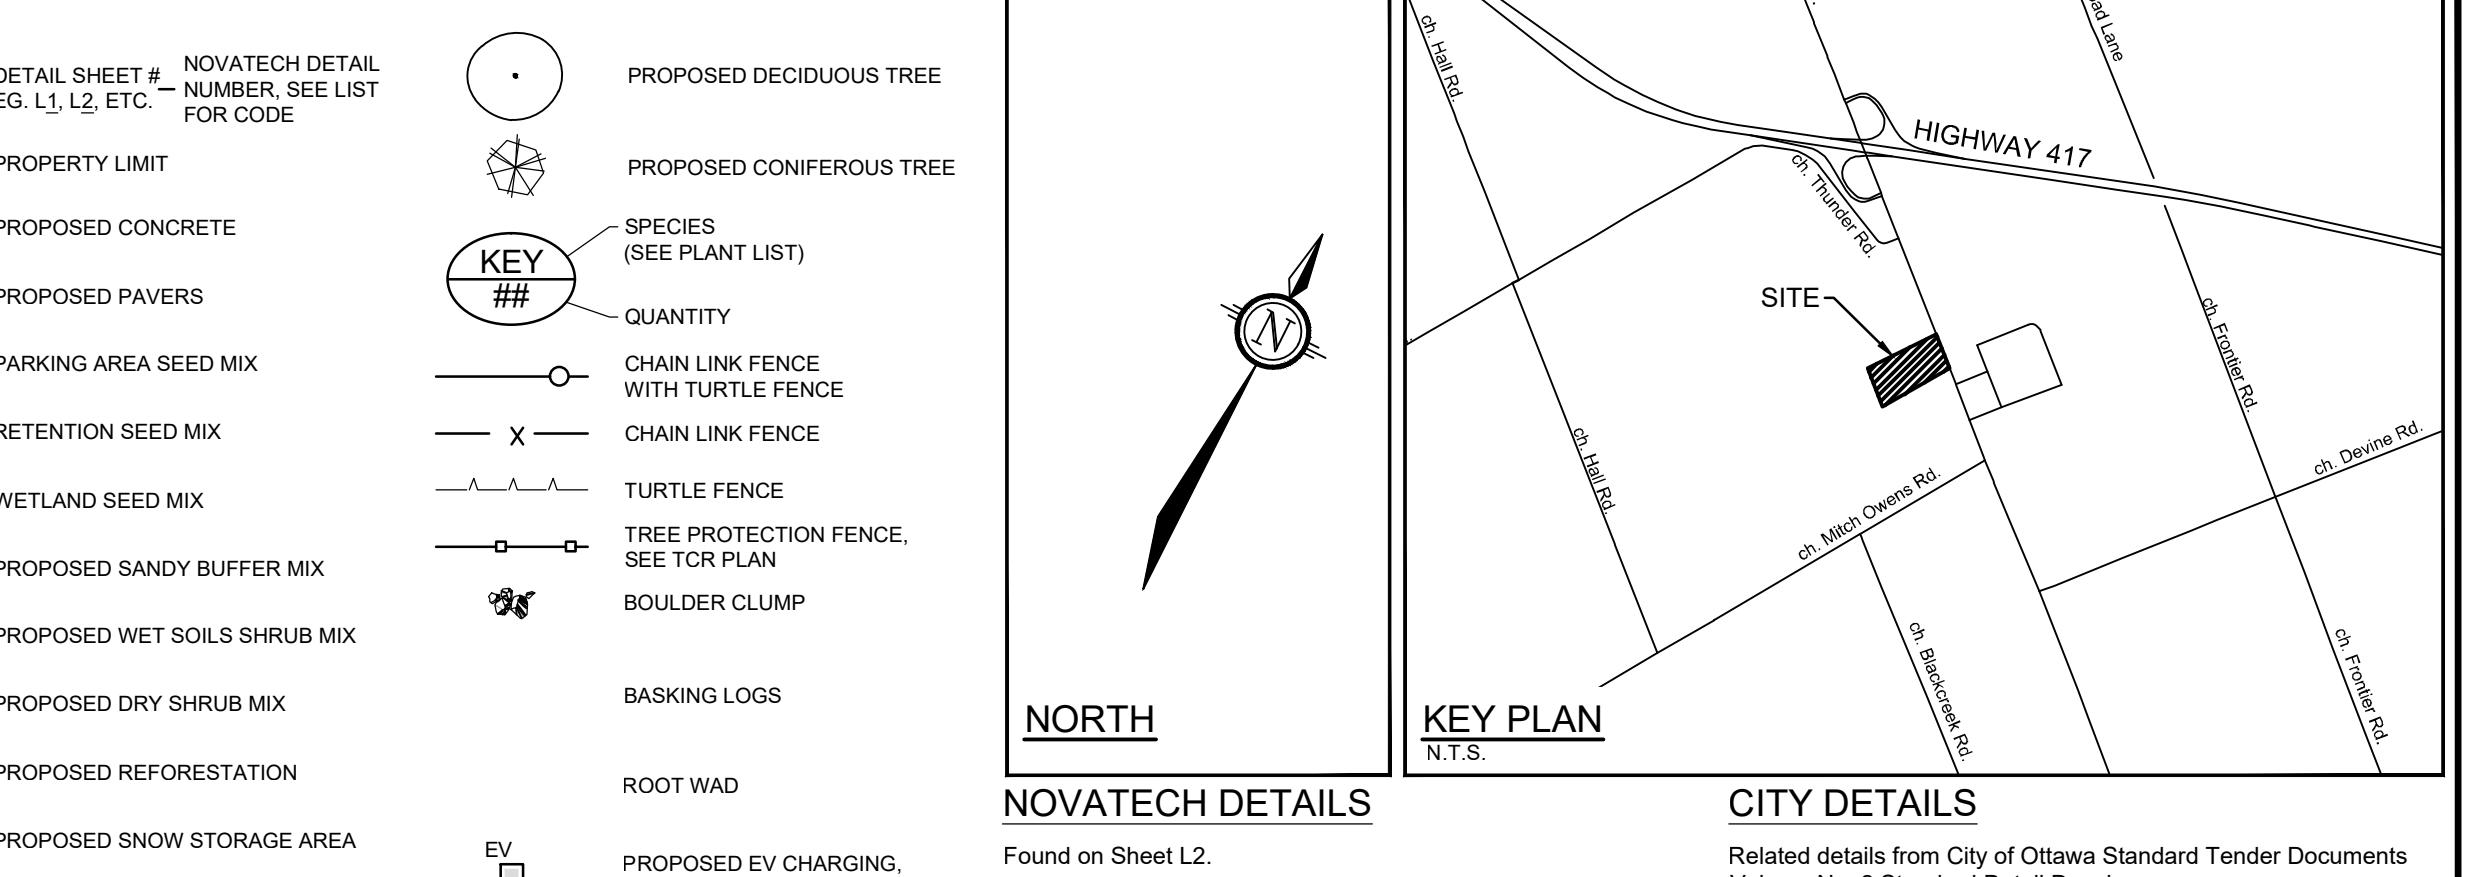

CITY DETAILS

Related details from City of Ottawa Standard Tender Documents
Volume No. 2 Standard Detailed Drawings

- F9. Chainlink Fence
SC4. Typical Concrete Sidewalk in Boulevard
SC5. Sidewalk Construction Joints

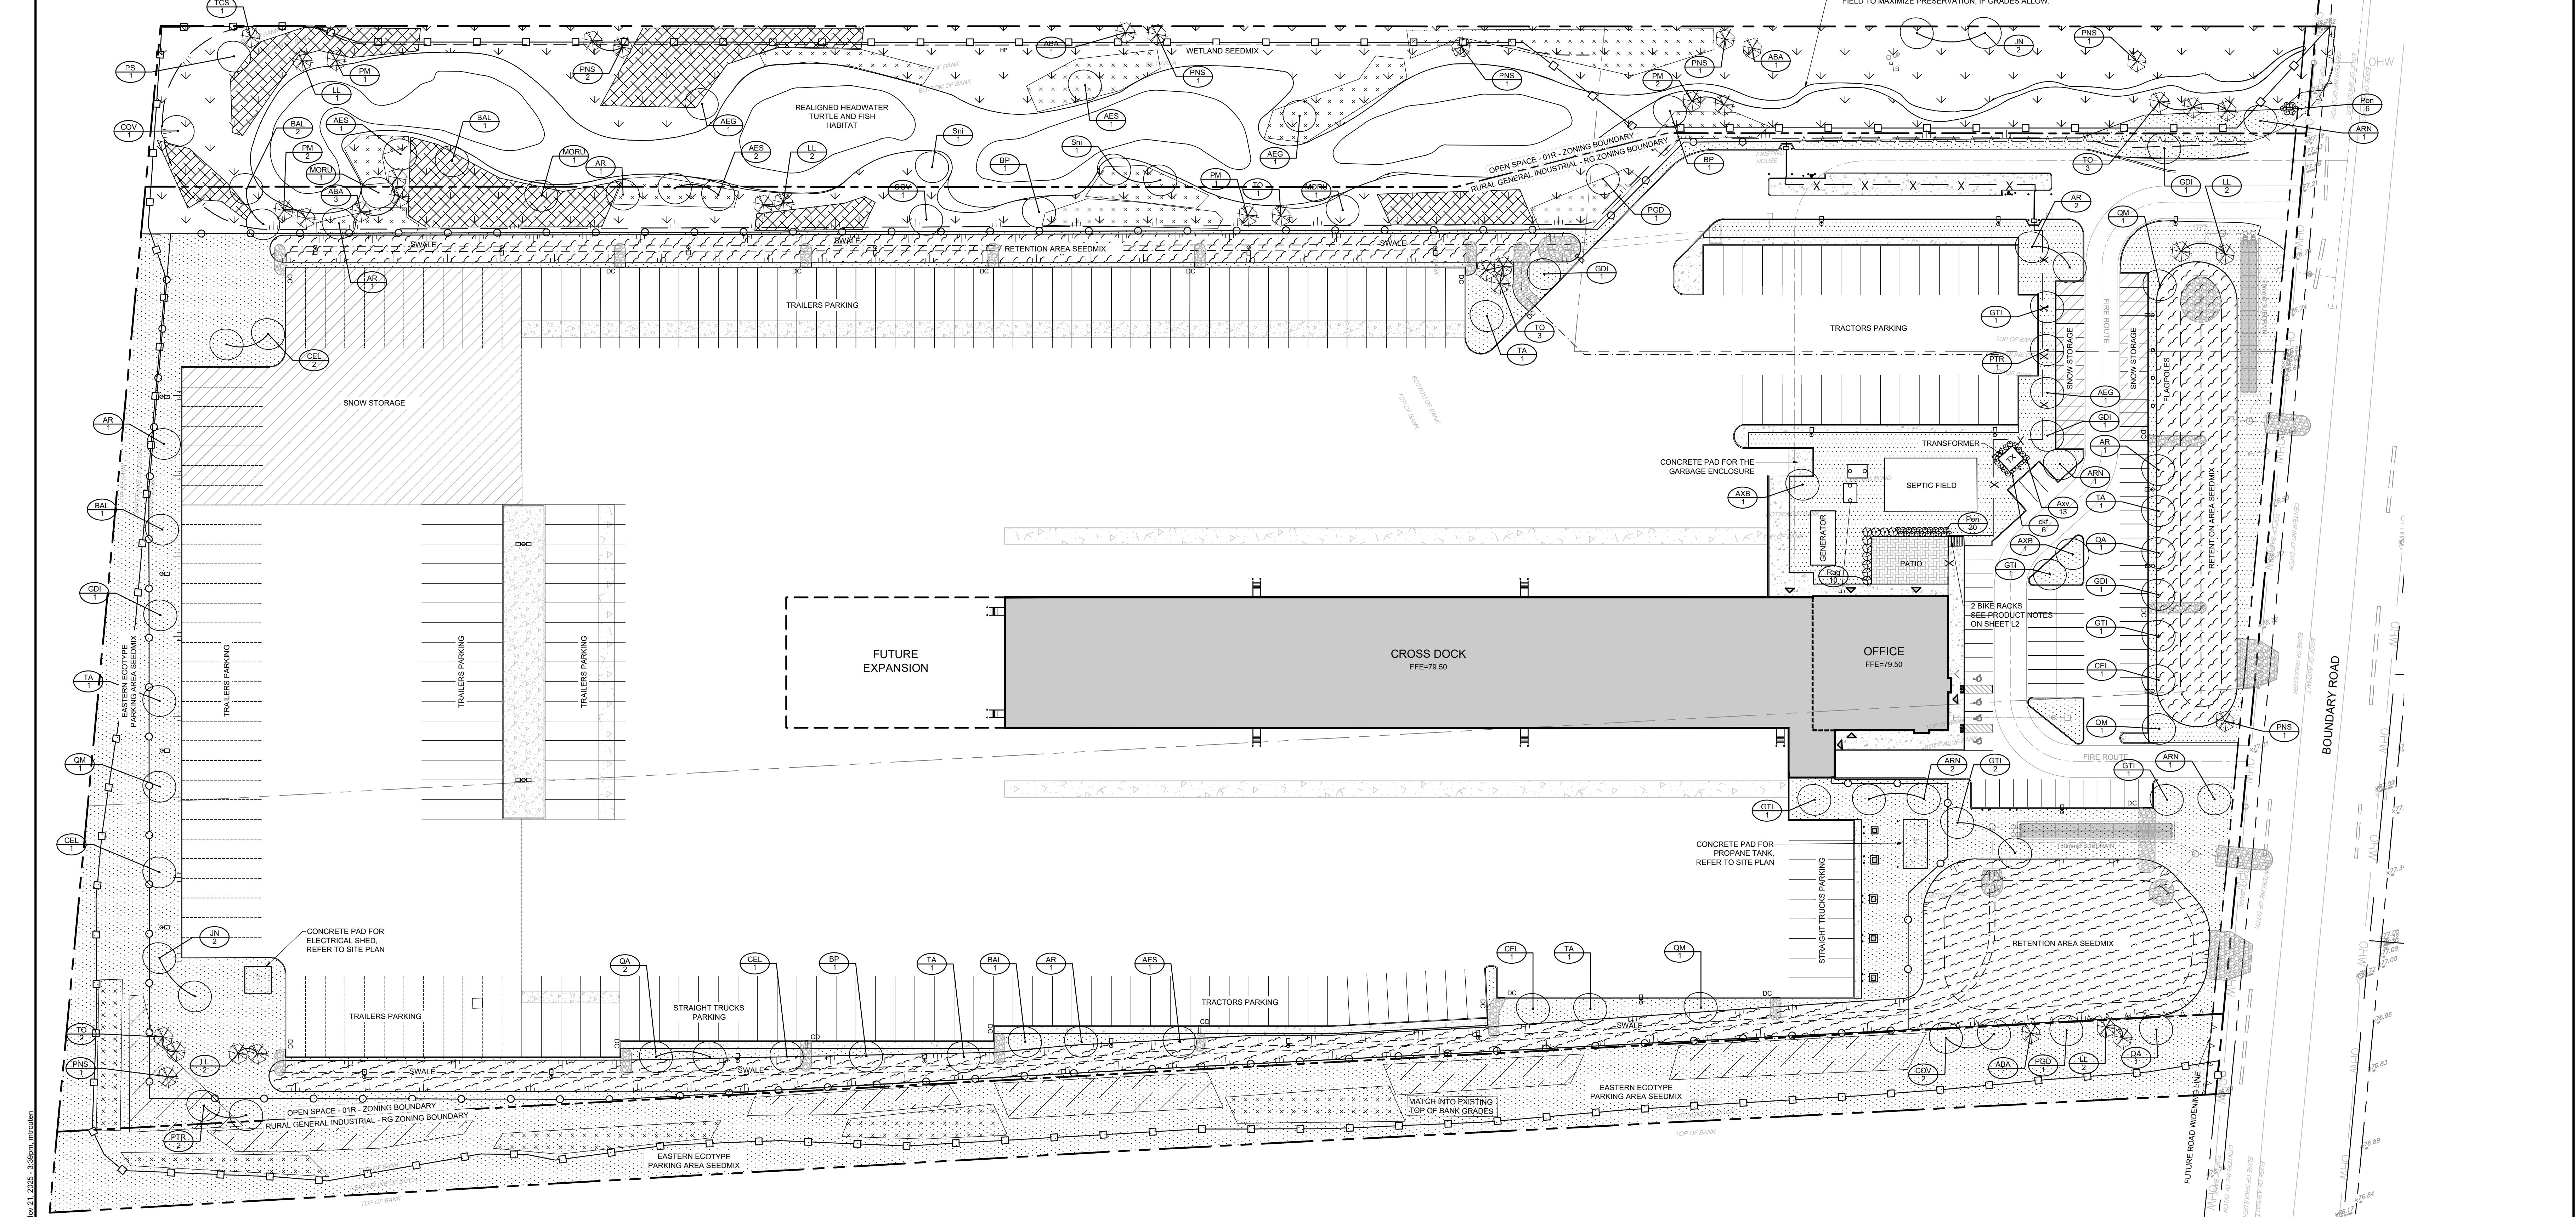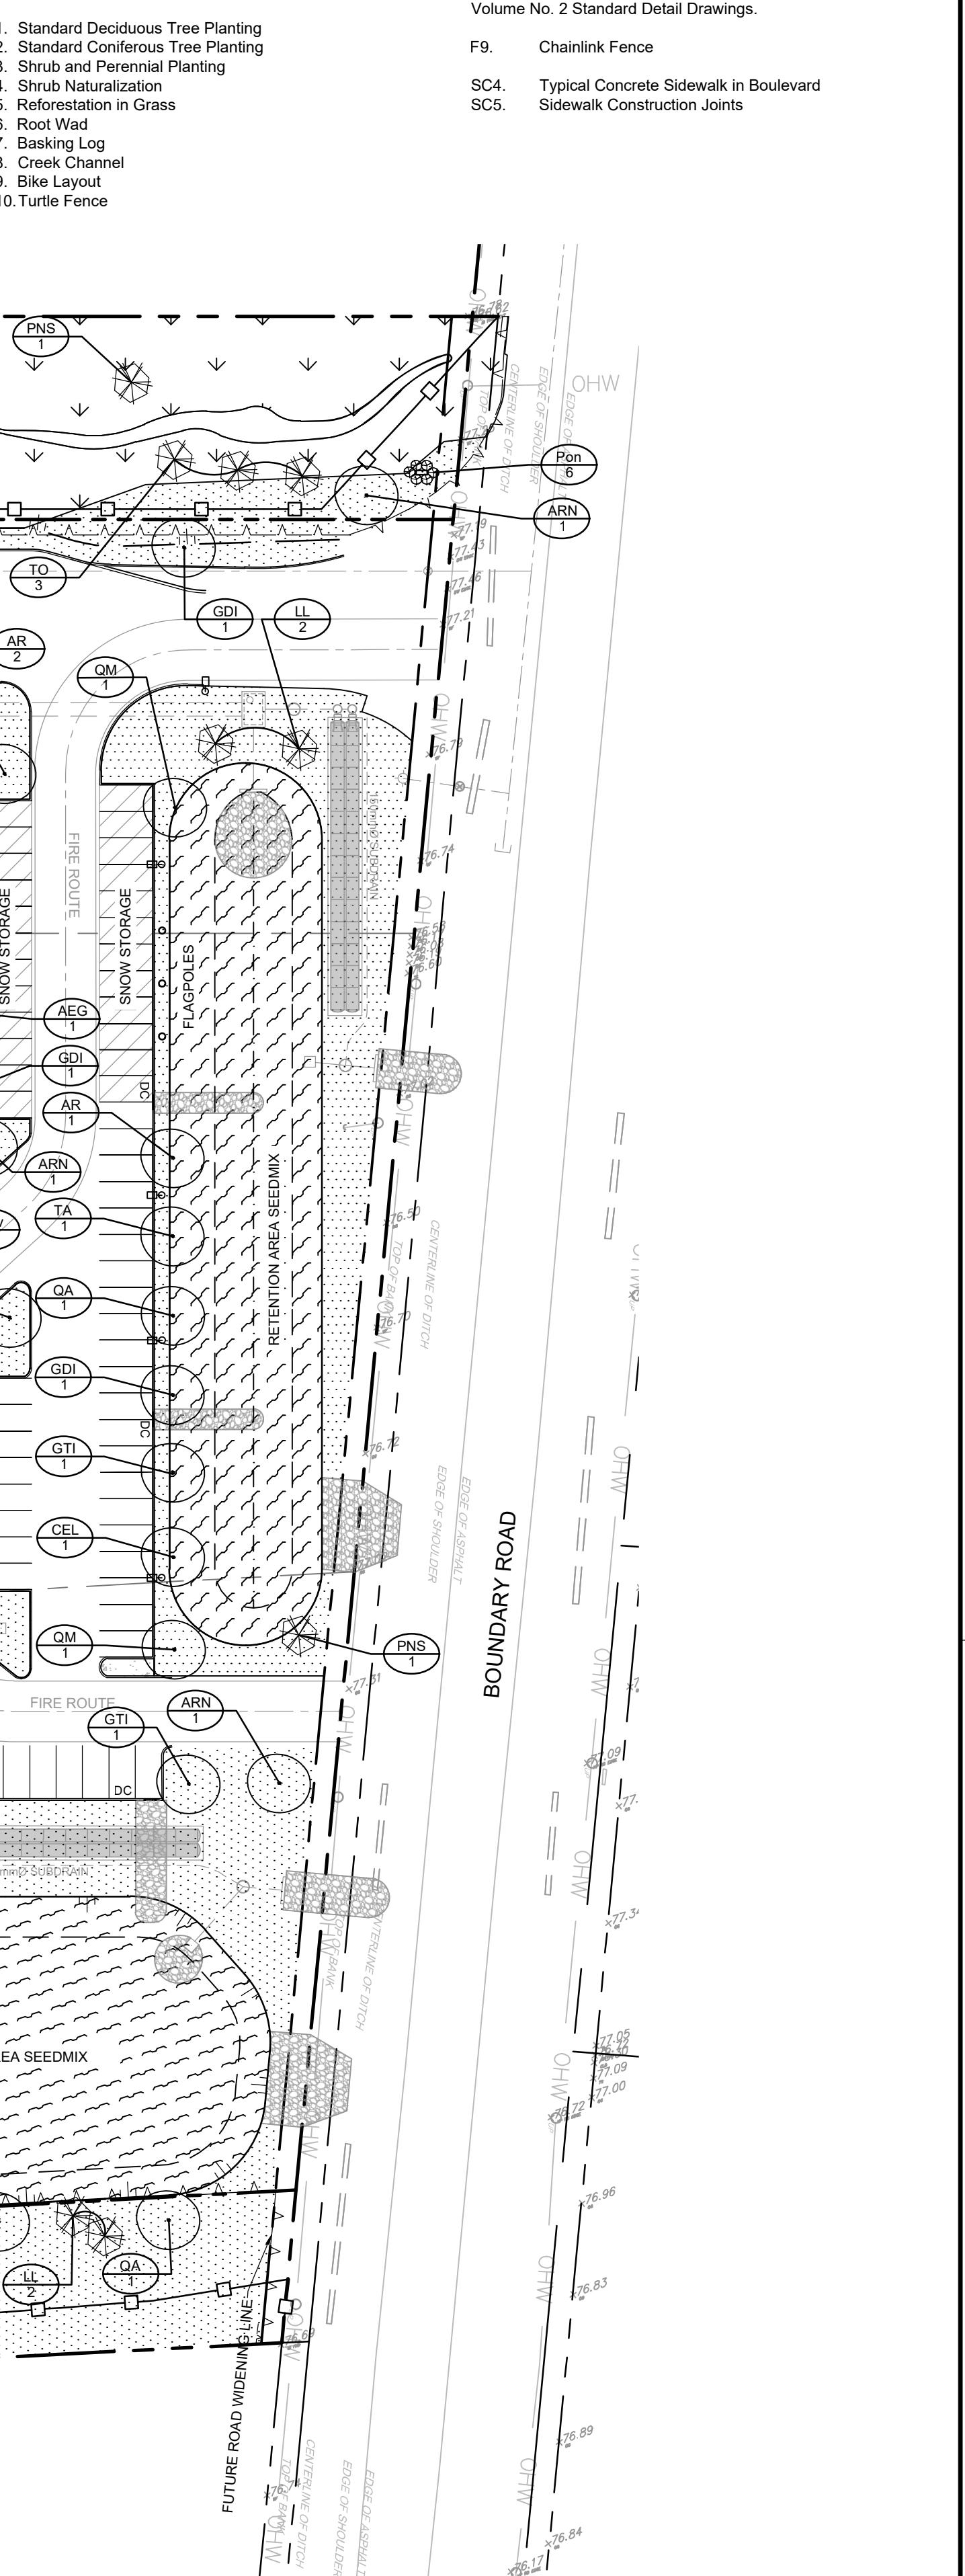

NOTE:
THE POSITION OF ALL POLE LINES, CONDUITS,
WATERMAINS, SEVERS AND OTHER
UNDERGROUND AND OVERGROUND UTILITIES AND
STRUCTURES IS NOT NECESSARILY SHOWN ON
THE CONTRACT DRAWINGS, AND WHERE SHOWN,
THE POSITION OF THE ABOVE-DESCRIBED UTILITIES
AND STRUCTURES IS NOT GUARANTEED
BEFORE STARTING WORK, DETERMINE THE EXACT
LOCATION OF ALL SUCH UTILITIES AND
STRUCTURES AND ASSUME ALL LIABILITY FOR
DAMAGE TO THEM.

Owner: DAY & ROSS INC
358 MAIN STREET
HARTLAND,
NB E7P 1C6

Surveyor: ANNE OULLIVAN,
VOLLEBEKK LTD,
14 CONCOURSE GATE,
SUITE 500, NEPEAN,
ON K2B 7G6

Architect: N45 ARCHITECTURE INC.
104 MONTAGUE PLAIN
ROAD, SUITE 200
7TH FLOOR, OTTAWA,
ON K1P 5N2

Civil Engineer: NOVATECH
240 MONTAGUE PLAIN
DRIVE, SUITE 200
OTTAWA,
ON K2M 1P6

DISCLAIMER:
The elements on this plan illustrate the design intent and
general constructability of the proposed landscape which
will support the associated development. This is to
demonstrate how the canopy cover, urban design, health,
and climate change objectives of the Official Plan will be
met through tree planting and site design. This drawing is
for City review only and is not intended for construction.
Final detailed design and construction documentation is to
be provided with certified 'Issued for Construction'
drawings and specifications prior to construction.


6. REVISED PER CITY AND SNC COMMENTS NOV 14/25 SC
5. ISSUED FOR COMPLETENESS COMMENTS FEB 27/25 SC
4. ISSUED FOR BUILDING PERMIT OCT 24/24 RGJ
3. ISSUED FOR 90% SUBMISSION OCT 4/24 RGJ
2. ISSUED FOR SITE PLAN APPLICATION OCT 2/24 RGJ
1. ISSUED FOR 60% SUBMISSION AUG 16/24 RGJ

No. REVISION DATE BY

SCALE 1:500
1:500
0 5 10 15 20

DESIGN KEW
CHECKED RGJ
DRAWN KEW/TB
CHECKED SC
APPROVED SC

FOR REVIEW ONLY

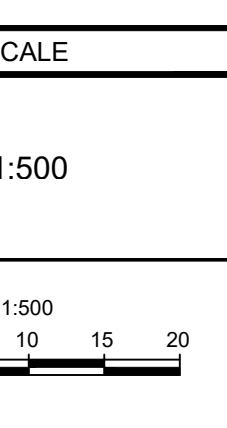

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CITY PLAN NO. 19296

DRAWING NAME LANDSCAPE PLAN

PROJECT No. 118168

REV #6

DRAWING NO. 118168-L

