

LANDSCAPE PLAN

L.1 | SCALE 1:250

40 YEAR CANOPY CALCULATION:

- -5,729 m2 site area
- -2 Large coniferous trees proposed (79m2 ea.) & 25 small trees proposed (7m2 ea)
- =333m2 canopy cover =5.8% canopy cover
- *Large coniferous tree calculated at 10m, small deciduous trees at 3m.
- Tree planting opportunities are limited on site due to the presence of Marine Clay Soil.

GENERAL NOTES:

construction activity.

1. It is the responsibility of the appropriate contractor or official to report any errors, omissions or discrepancies on this plan with actual site conditions to the Landscape Architect before proceeding with construction.

2. The contractor is to notify all utility companies and authorities prior to any excavation and ascertain locations of underground services. 3. The contractor is to reinstate all areas and items damaged as a result of

4. The contractor is to comply with all pertinent codes and by-laws. 5. The contractor is to maintain a positive surface run-off throughout the entire

construction period.

6. The Landscape Architect is not responsible for subsurface conditions. 7. The contractor is to identify all existing trees to remain on site with the Landscape Architect prior to construction.

8. The contractor is to stake the proposed location of all plant material in

- conjunction with the Landscape Architect prior to excavation.
- 9. Minimum distances for selected deciduous trees are as follows: Building Foundations 7.5m Sidewalks 1.5m
- Public Streets 2.5m Underground Infrastructure 1.5m
- 10. All trees within 1m of underground utility trenches are to be excavated by
- 11. Remove all protective wrapping from tree trunks after installation. 12. Staking of trees shall only be performed if necessary.
- 13. Ensure that mulch is pulled back a min. distance of 75mm from base of tree


| KEY | QTY. | BOTANICAL NAME | COMMON NAME | SIZE | CONDITION | REMARKS |
|--------------|------|------------------------------------|------------------------|-------------|-----------|--------------|
| PR | OPO: | SED TREES | | | | |
| | | | | | | |
| | | | | | | |
| * SB | 14 | Amelanchier canadensis | Shadblow Serviceberry | 50mm cal. | B&B | |
| * SF | 11 | Amelanchier laevis | Allegheny Serviceberry | 50mm cal. | B&B | |
| * WS | 2 | Picea glauca | White Spruce | 2.0m ht. | B&B | |
| 011 | | • | | | | |
| 5Н | RUB | • | | | | |
| * DW | 34 | Cornus sericea | Red Osier Dogwood | 600 mm ht. | Potted | 1000 mm o.c. |
| JH | 28 | Juniperus horizontalis 'Bar Harbor | | 600 mm spr. | Potted | 1000 mm o.c. |
| ★ NB | 9 | Physocarpos opulifolius | Ninebark | 600 mm ht. | Potted | 1000 mm o.c. |
| RR | 56 | Rosa rugosa | Rugosa Rose | 600 mm ht. | Potted | 1000 mm o.c. |
| | 16 | Rubus odoratus | Flowering Raspberry | 600 mm ht. | Potted | 1000 mm o.c. |
| * SS * WC | 28 | Thuja occidentalis | White Cedar | 2000 mm ht. | Potted | 1000 mm o.c. |


ORNAMENTAL GRASSES


| L | 17 | Leymus arenarius 'Blue Dune' | Blue Dune Grass | 250mm pot | Potted | 800 mm o.c | |
|---|----|-------------------------------|---------------------|-----------|--------|------------|--|
| F | 17 | Calamagrostis 'Karl Foerster' | Karl Foerster Grass | 250mm pot | Potted | 800 mm o.c | |


* NATIVE TO ONTARIO

NOTE: ALL TREES ARE PROPOSED ON PRIVATE PROPERTY WITH THE EXCEPTION OF THE EIGHT (8) TREES PROPOSED ON THE PALEO DRIVE R.O.W. AND THE FOUR (4) TREES PROPOSED ON THE ROSEDALE STREET R.O.W.

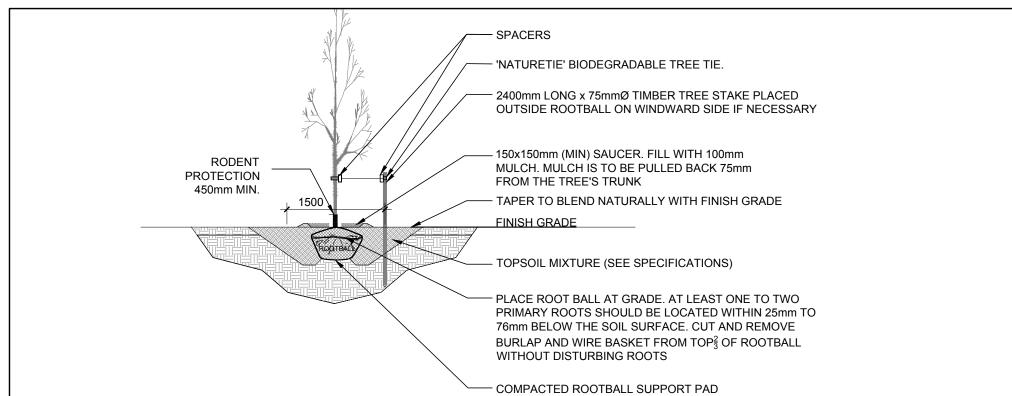


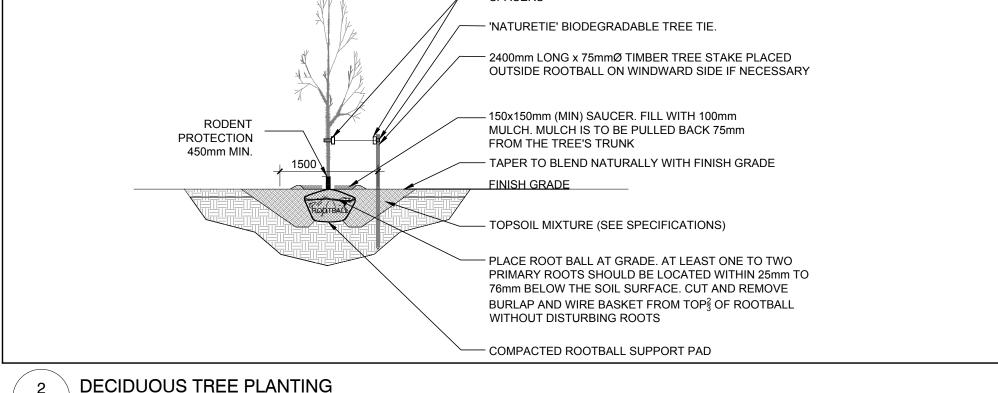

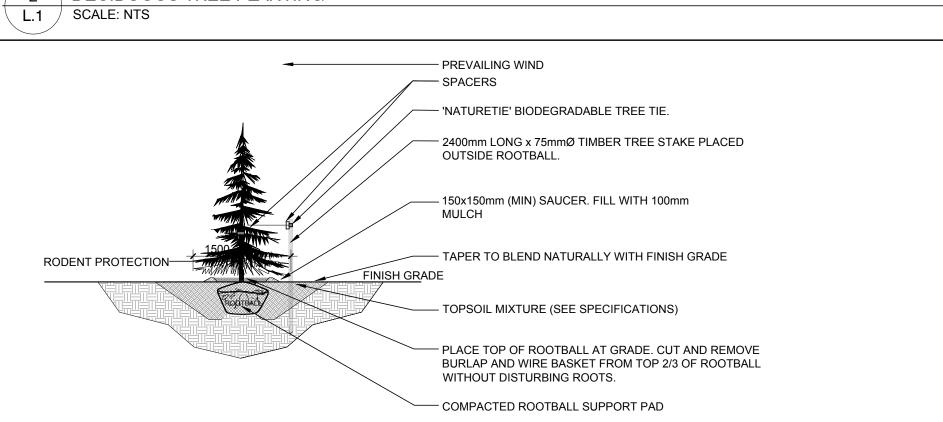

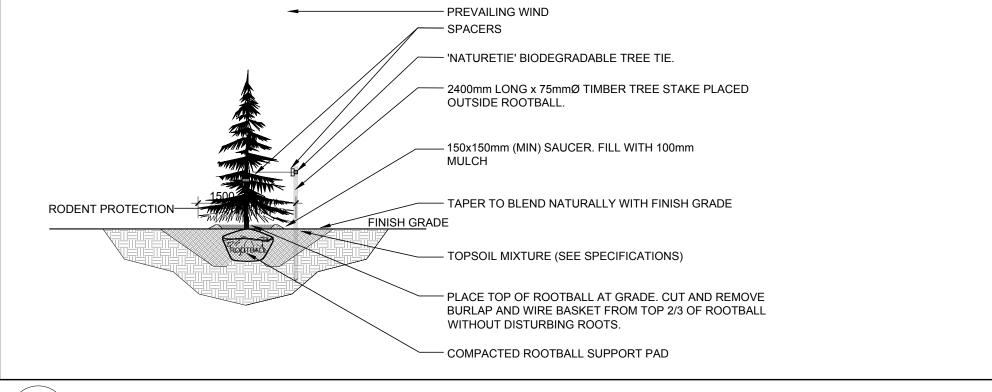

3 CONIFEROUS TREE PLANTING L.1 SCALE: NTS

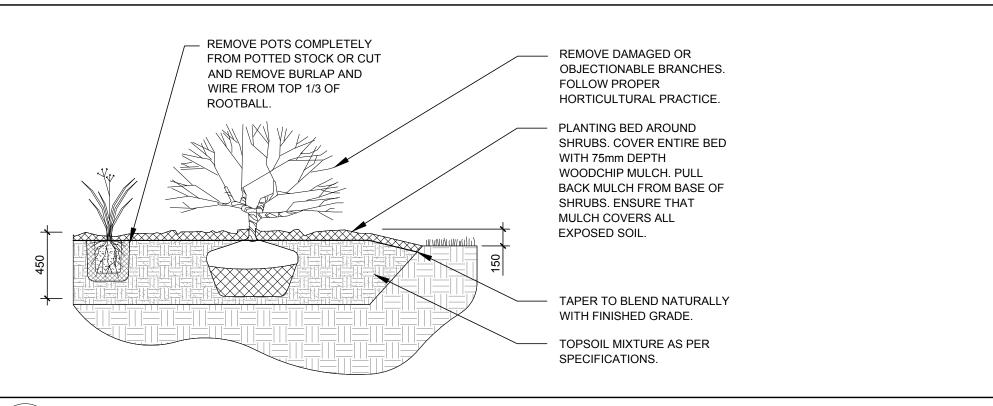

PROPOSED SHRUB / ORNAMENTAL GRASS PLANTING

L.1 / SCALE: NTS

LEGEND

CLIENT:

768, BOUL. SAINT-JOSEPH, SUITE 100 GATINEAU, QC J8Y 4B8

INFO@PMAARCHITECTES.COM

3070, CHEMIN DES QUATRE-BOURGEOIS QUÉBEC (QC) G1W 2K4

LAPALME RHEAULT

ENGINEERS / PLANNER

SURVEYOR

 40 YEAR CANOPY PROJECTION PROPOSED DECIDUOUS TREE

- REQUIRED SOIL VOLUME (25m3)

— 40 YEAR CANOPY PROJECTION

PROPOSED CONIFEROUS TREE

- REQUIRED SOIL VOLUME (30m3)

PROPOSED SHRUBS / ORNAMENTAL

J.L.Richards

ENGINEERS · ARCHITECTS · PLANNERS

1565 CARLING AVENUE, SUITE 700,

1331 CLYDE AVENUE, SUITE 400,

OTTAWA, ON K2C 3G4

OTTAWA, ON K1Z 8R1

53, BOUL. SAINT-RAYMOND,

GATINEAU, QC J8Y 1R8

ARCHITECTURAL

4.5m SETBACK _ _ _ NOTE REVISED RE: TREE PLANTING 03/04/2024 ML C 03/01/2024 ML .

PROPOSED RIVERSTONE

REVISED PER CITY COMMENTS 02/26/2024 ML 3 REVISED PER CITY COMMENTS 12/15/2023 ML ISSUED FOR SITE PLAN CONTROL Date DR Cr


PROPOSED SOD

JAMES B. LENNOX & ASSOCIATES INC. **ARCHITECTS** LANDSCAPE 3332 CARLING AVE. OTTAWA, ONTARIO K2H 5A8 Tel. (613) 722-5168 Fax. 1(866) 343-3942 PROJECT

NAVAN ROAD DEVELOPMENT- BUILDINGS "A"

NAVAN ROAD, ORLEANS ON

LANDSCAPE PLAN

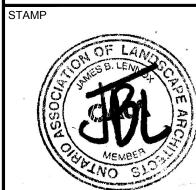


SCALE AS SHOWN TART DATE NOVEMBER 2023


PROJECT NO.

DRAWING NO.

PROJECT NORTH

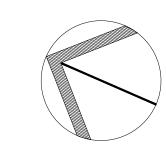

LOT SIZE ARCH-D

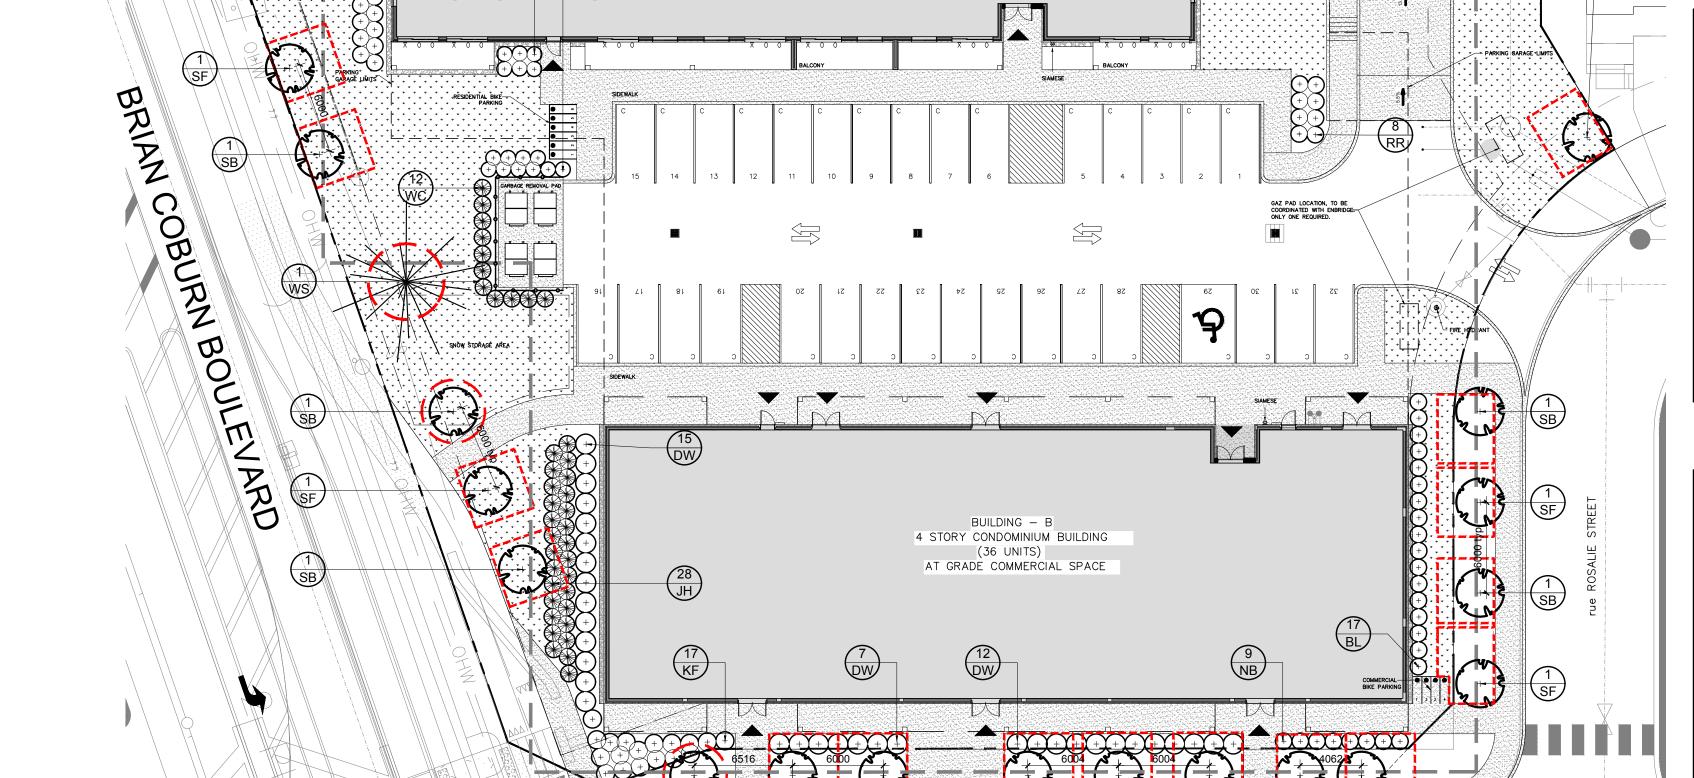

promenade PALEO DRIVE

BUILDING - A

4 STORY CONDOMINIUM BUILDING

(48 UNITS)