3636 INNES ROAD U-HAUL SITE (D07-12-20-0086) PARK 3604 INNES ROAD CARWASH (D07-12-18-0132)

THE COMMONS






LIST OF DRAWINGS:

LO1 - LANDSCAPE PLAN LO2 - LANDSCAPE DETAILS



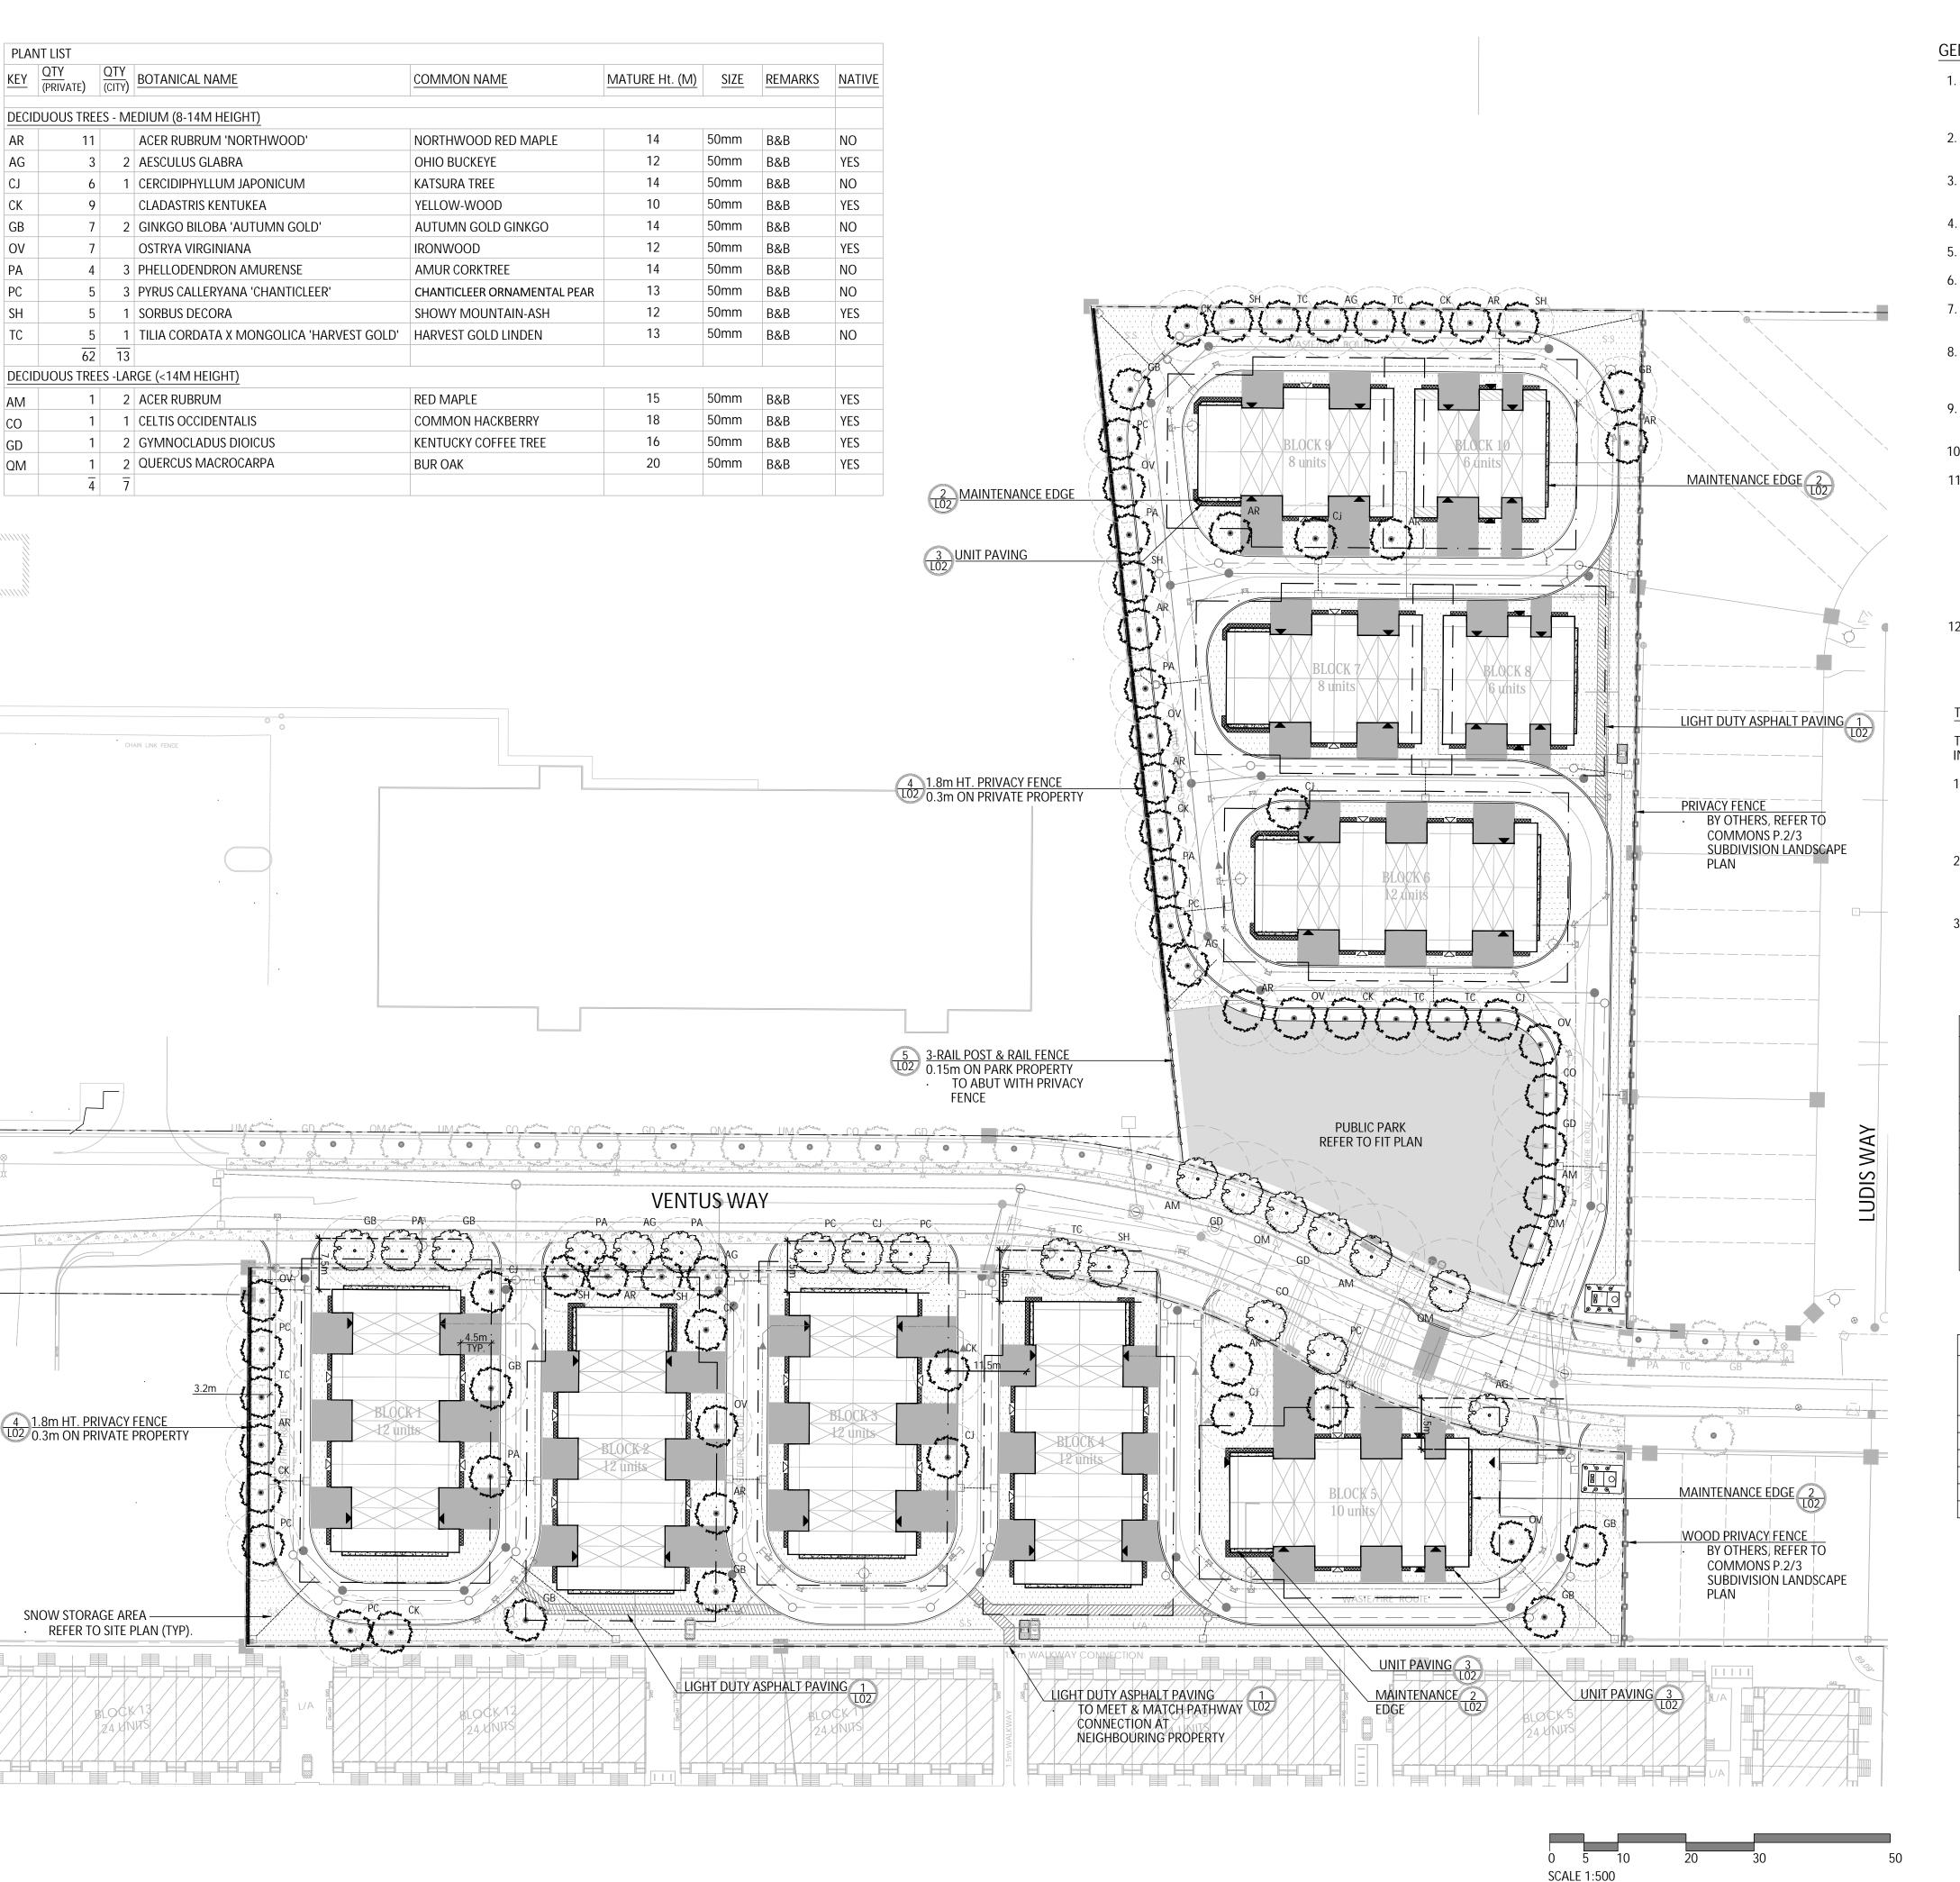

GENERAL NOTES:

- 1. THE LOCATION OF THE TREES SHOWN ON THIS PLAN IS APPROXIMATE AND SHALL NOT BE SCALED FROM THIS DRAWING. THIS PLAN MUST BE READ IN CONJUNCTION WITH THE APPROVED CUP AND CITY CROSS
- 2. CONTRACTOR SHALL ENSURE THAT ALL UTILITY LOCATIONS ARE OBTAINED PRIOR TO ANY EXCAVATION FOR LANDSCAPING.
- 3. LOCATION OF ALL PLANT MATERIALS TO BE STAKED BY THE CONTRACTOR AND VERIFIED IN THE FIELD BY LANDSCAPE ARCHITECT & CITY OF OTTAWA PRIOR TO THE EXCAVATION OF PITS.
- 4. ALL PLANT MATERIAL SHALL BE NURSERY GROWN STOCK UNLESS OTHERWISE NOTED.
- 5. TREES TO HAVE A MINIMUM 1800 CLEAR STEM ABOVE GRADE.
- 6. PLACE SOD ON A MINIMUM 150mm TOPSOIL.
- CONTRACTOR TO MAKE GOOD ALL EXISTING AREAS DAMAGED BY HIS WORK TO THE SATISFACTION OF THE CITY OF OTTAWA.
- 8. THE CITY WILL BE NOTIFIED IF ANY TREES CANNOT BE LOCATED OR PLANTED DUE TO CONFLICTS WITH UTILITIES OR DRIVEWAYS. THE REQUIRED TREES NOT PLANTED ARE SUBJECT TO TREE BANKING. THE FINAL NUMBER OF TREES TO BE BANKED WILL BE PROVIDED TO THE CITY FOLLOWING ALL PLANTINGS.
- 9. ALL PLANT MATERIAL SHALL BE WARRANTIED FOR TWO YEARS FROM THE DATE OF PERFORMANCE ACCEPTANCE AS DETERMINED BY THE CITY OF OTTAWA.
- 10. PERIODIC REVIEWS OF PLANTING SHALL BE CARRIED OUT BY THE LANDSCAPE ARCHITECT.
- 11. STREET TREE PLANTING GUIDELINE
 - NOTE: APPROVED CROSS SECTIONS SHALL TAKE PRECEDENCE
 - 4.5m STREET LIGHT (SMALL TREE <7m MATURE HT.) 2.5m - STREET LIGHT (MEDIUM/LARGE TREE >7m MATURE HT.)
 - 3.0m HYDRO TRANSFORMER
 - 1.5m PATH, DRIVEWAY, FENCE, SOUND WALL
 - 2.5m FIRE HYDRANTS
 - 1.5m WATER SERVICE / CURB STOP
 - 1.0m BELL / CABLE PEDESTALS
- TOTAL NUMBER OF TREES REQUIRED, THE COMMONS PHASE 1: NUMBER OF STREET TREES SHOWN ON PLAN, THE COMMONS PHASE 1: 105
- TOTAL NUMBER OF TREES REQUIRED, THE COMMONS PHASE 2&3: 132 NUMBER OF STREET TREES SHOWN ON PLAN, THE COMMONS PHASE 2&3: 137

TREE PLANTING IN MARINE CLAY SOILS


DIFFERENCE:

THE LANDSCAPE CONSIDERATIONS CONTAINED WITHIN SEC. 6.8 OF PATERSON GROUP'S GEOTECHNICAL INVESTIGATION, DATED JULY 8, 2024.

- 1. THIS LANDSCAPE PLAN CONFORMS WITH THE TREE-TO-FOUNDATION SETBACK, SOIL VOLUME, AND SURFACE-GRADING REQUIREMENTS OUTLINED IN THE CITY OF OTTAWA'S GUIDELINES FOR TREE PLANTING IN SENSITIVE MARINE CLAY SOILS (2017), BASED ON THE FINDINGS OUTLINED IN THE PROJECT GEOTECHNICAL REPORT BY PATERSON GROUP (REPORT PG4026-3-1 DATED JULY 8, 2024).
- 2. ADDITIONAL REQUIREMENTS OUTLINED IN THE CITY OF OTTAWA'S GUIDELINES FOR TREE PLANTING IN SENSITIVE MARINE CLAY SOILS (2017), INCLUDING USF DEPTH, FOUNDATION WALL REINFORCEMENT, AND SUBDIVISION GRADING, SHOULD BE CONFIRMED BY THE PROJECT ENGINEER(S).
- 3. THE CONTRACTOR SHOULD REPORT ANY DISCREPANCIES TO THE CONTRACT ADMINISTRATOR BEFORE PLANTING TREES.

11101	1	ANOPY PROJE	CTIONS
TREE TYPE/SIZE	CROWN AREA PER TREE STANDARD RANGE (m²)	CROWN AREA PER TREE USED FOR CALC. (m ²)	SITE CANOPY COVER
LARGE (11)	135-250*	192	CANOPY (W.
MEDIUM (79)	35-135*	85	OVERLAP):4792m ²
*RANGE OF CROWN AREAS	S IS IN ACCORDANCE WI	TH PROPOSED TREES	SITE: 19,975m ²

TREE SOIL VOLUMES				
TREE TYPE/SIZE	SINGLE TREE SOIL VOLUME	MULTIPLE TREE SOIL VOLUME (m3/TREE)		
ORNAMENTAL	15	9		
COLUMNAR	15	9		
SMALL	20	12		
MEDIUM	25	15		
LARGE	30	18		
CONIFER	25	15		

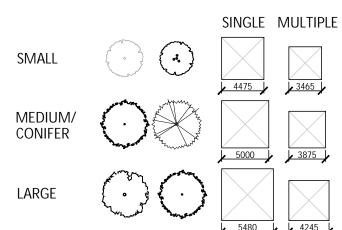

*SOIL VOLUME CALCULATION BASED ON 1.0m DEPTH

Contractor shall check all dimensions on the work and report any discrepancy to the Landscape Architect before proceeding. All drawings and specifications are the property of the Landscape Architect and must be returned at the completion of the work. This drawing is not to be used for construction until signed by the

Landscape Architect.

PROJECT CONSULTANTS

KORSIAK URBAN PLANNING

PLANNING: NOVATECH MECHANICAL & ELECTRICAL

GEOTECHNICAL & STRUCTURAL: PATERSON GROUP

CIVIL ENGINEERING: NOVATECH

LEGEND

PROPERTY LINE


— · — · 4.5m FOUNDATION SETBACK

PHASE LINE

FENCING

PRIVACY FENCE —o—o—o— POST AND RAIL FENCE

PLANTING

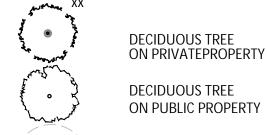

DECIDUOUS TREE ON PRIVATEPROPERTY

PROJECTED TREE CANOPY

APPROVED STREET TREES

SURFACING

ASPHALT PAVING

DRIVEWAY (BY OTHERS)

Oct.25/24

Sep.11/24

SODDING

3 Re-Issued for SPA Feb.13/25




2 Issued for SPA

No. Description

Revision

1 Issued for Coordination

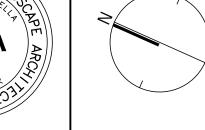



1285 WELLINGTON STREET, OTTAWA, ON K1Y 3A8 CANADA T 613.237.2345 NAKDESIGNSTRATEGIES.COM

THE COMMONS SITE PLAN Ottawa, ON


LANDSCAPE PLAN

Scale

Drawn PG Checked PG Job No. 24-219


Date Oct, 2024 1:500


L01

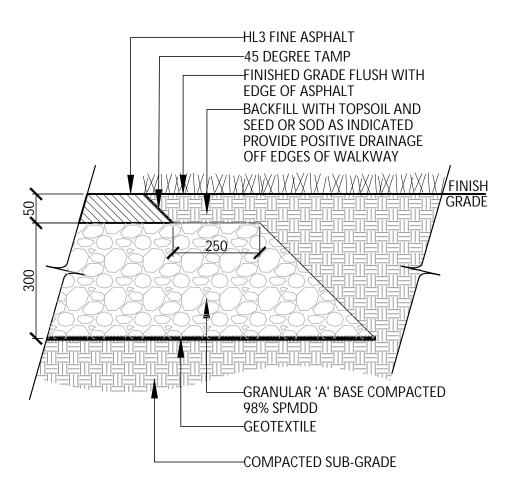


1. CROSS SLOPE PATH 1-2% IN DIRECTION OF NATURAL DRAINAGE TO PROVIDE POSITIVE DRAINAGE OF ALL WALKS.

- 2. FILTER FABRIC SHALL BE APPROVED NON-WOVEN CLASS 1 GEOTEXTILE AS PER MS-22.15 WHEN WARRANTED BY SOIL CONDITION, SUBJECT TO APPROVAL BY THE LANDSCAPE ARCHITECT.
- 3. ALL DISTURBED AREAS ALONG ASPHALT WALKWAYS SHALL BE SODDED OVER 150mm TOPSOIL
- FOR A MINIMUM DISTANCE OF 900mm. 4. GRANULAR 'A' SHALL MEET THE REQUIREMENTS OF OPSS 1010.

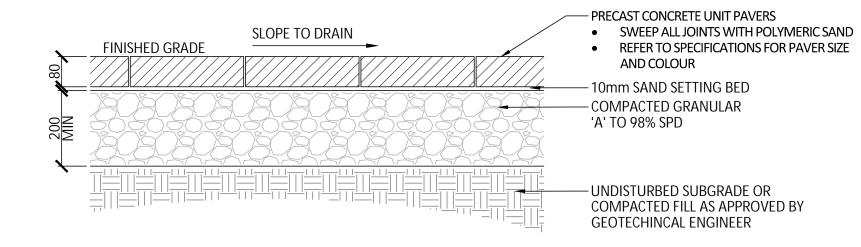

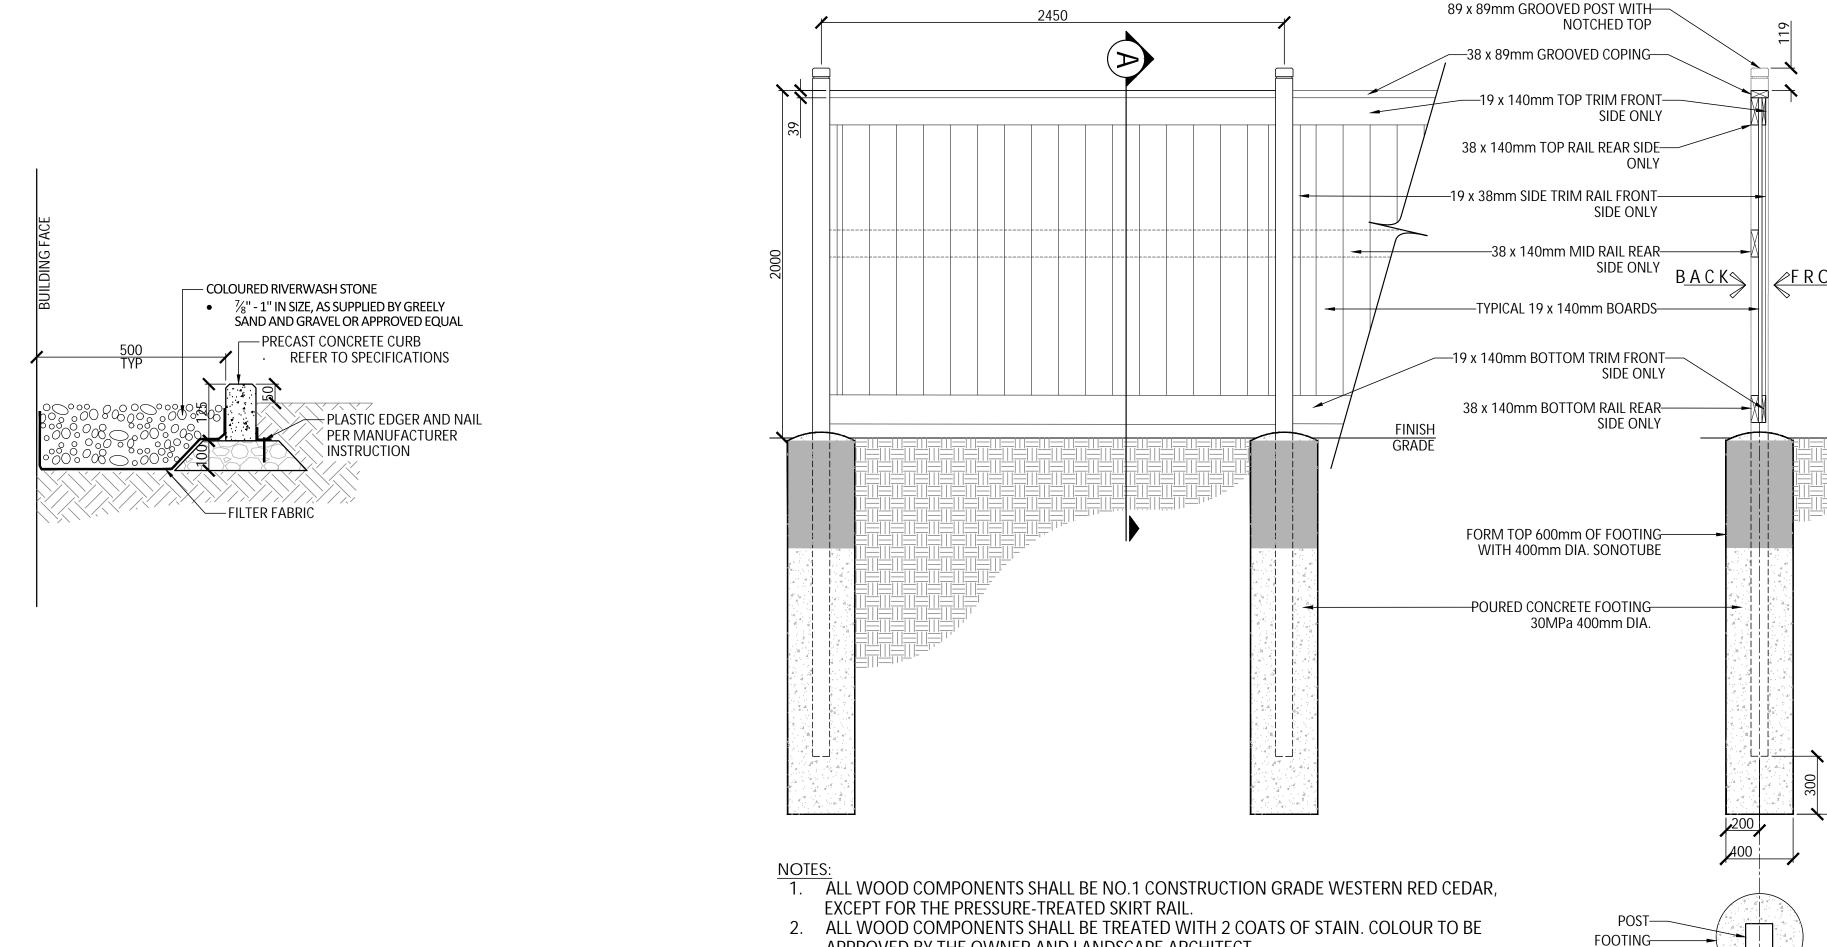

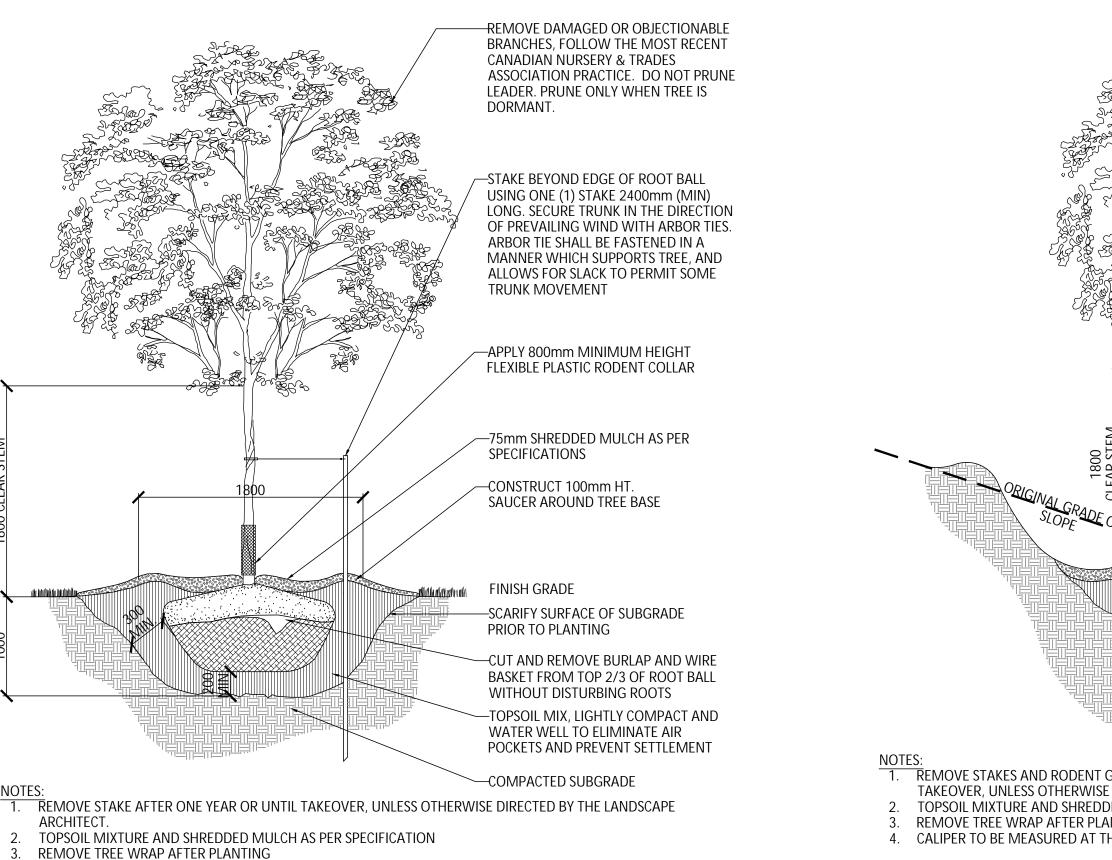

4. CALIPER TO BE MEASURED AT THE BASE OF TREE AT ROOT BALL.

Contractor shall check all dimensions on the work and report any discrepancy to the Landscape Architect before proceeding. All drawings and specifications are the property of the Landscape Architect and must be returned at the completion of the work. This drawing is not to be used for construction until signed by the Landscape Architect.

PROJECT CONSULTANTS

SITE PLAN DESIGN: KORSIAK URBAN PLANNING


PLANNING: NOVATECH MECHANICAL & ELECTRICAL:

GEOTECHNICAL & STRUCTURAL: PATERSON GROUP

TRANSPORTATION: NOVATECH

CIVIL ENGINEERING: NOVATECH

3 Re-Issued for SPA Feb.13/25 2 Issued for SPA Oct.25/24 1 Issued for Coordination Sep.11/24 No. Description Revision

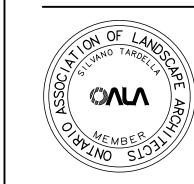

design strategies


1285 WELLINGTON STREET, OTTAWA, ON K1Y 3A8 CANADA T 613.237.2345 NAKDESIGNSTRATEGIES.COM

THE COMMONS Ottawa, ON

LANDSCAPE DETAILS


Date Oct, 2024 Scale AS SHOWN Drawn PG

Checked PG Job No. 24-219

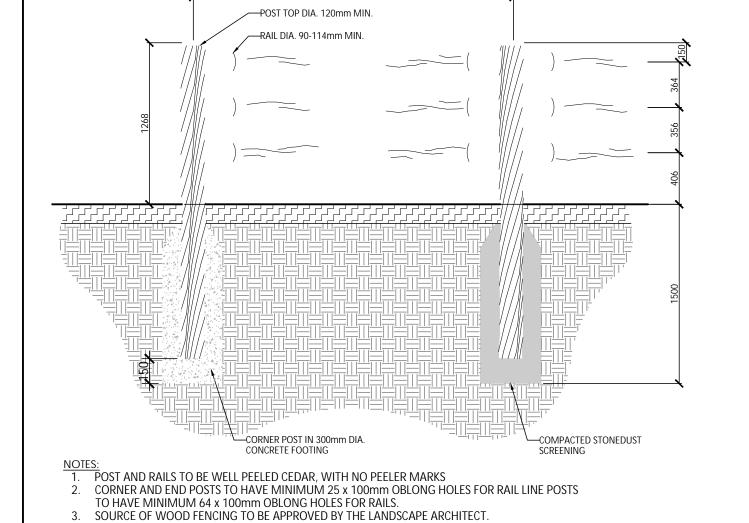

4. CONCRETE FOOTING SHALL BE CSA 30MPa CLASS F-1

—INSERT, OVERLAP AND SECURE RAILS WITH GALVANIZED SPIRAL NAILS

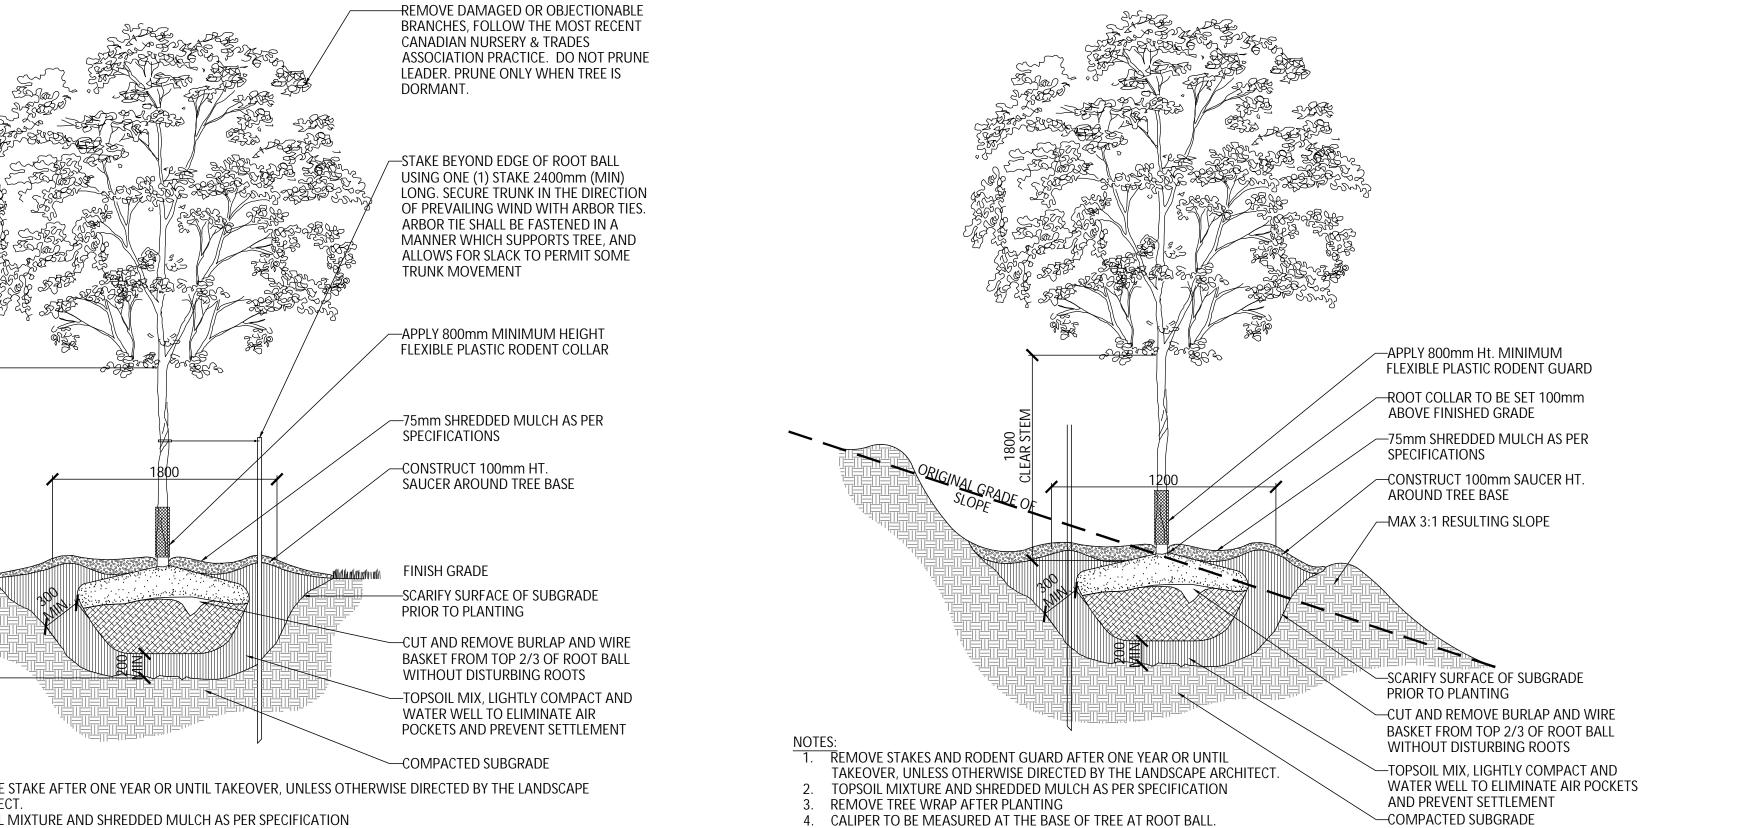

APPROVED BY THE OWNER AND LANDSCAPE ARCHITECT.

3. USE GALVANIZED FASTENERS AND HARDWARE THROUGHOUT.