


THE COMMONS





LIST OF DRAWINGS:

LO1 - LANDSCAPE PLAN LO2 - LANDSCAPE DETAILS

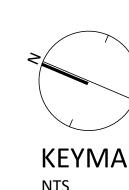


PARK

3636 INNES ROAD U-HAUL SITE (D07-12-20-0086)

3604 INNES ROAD CARWASH (D07-12-18-0132)

INNINNES/ROAD

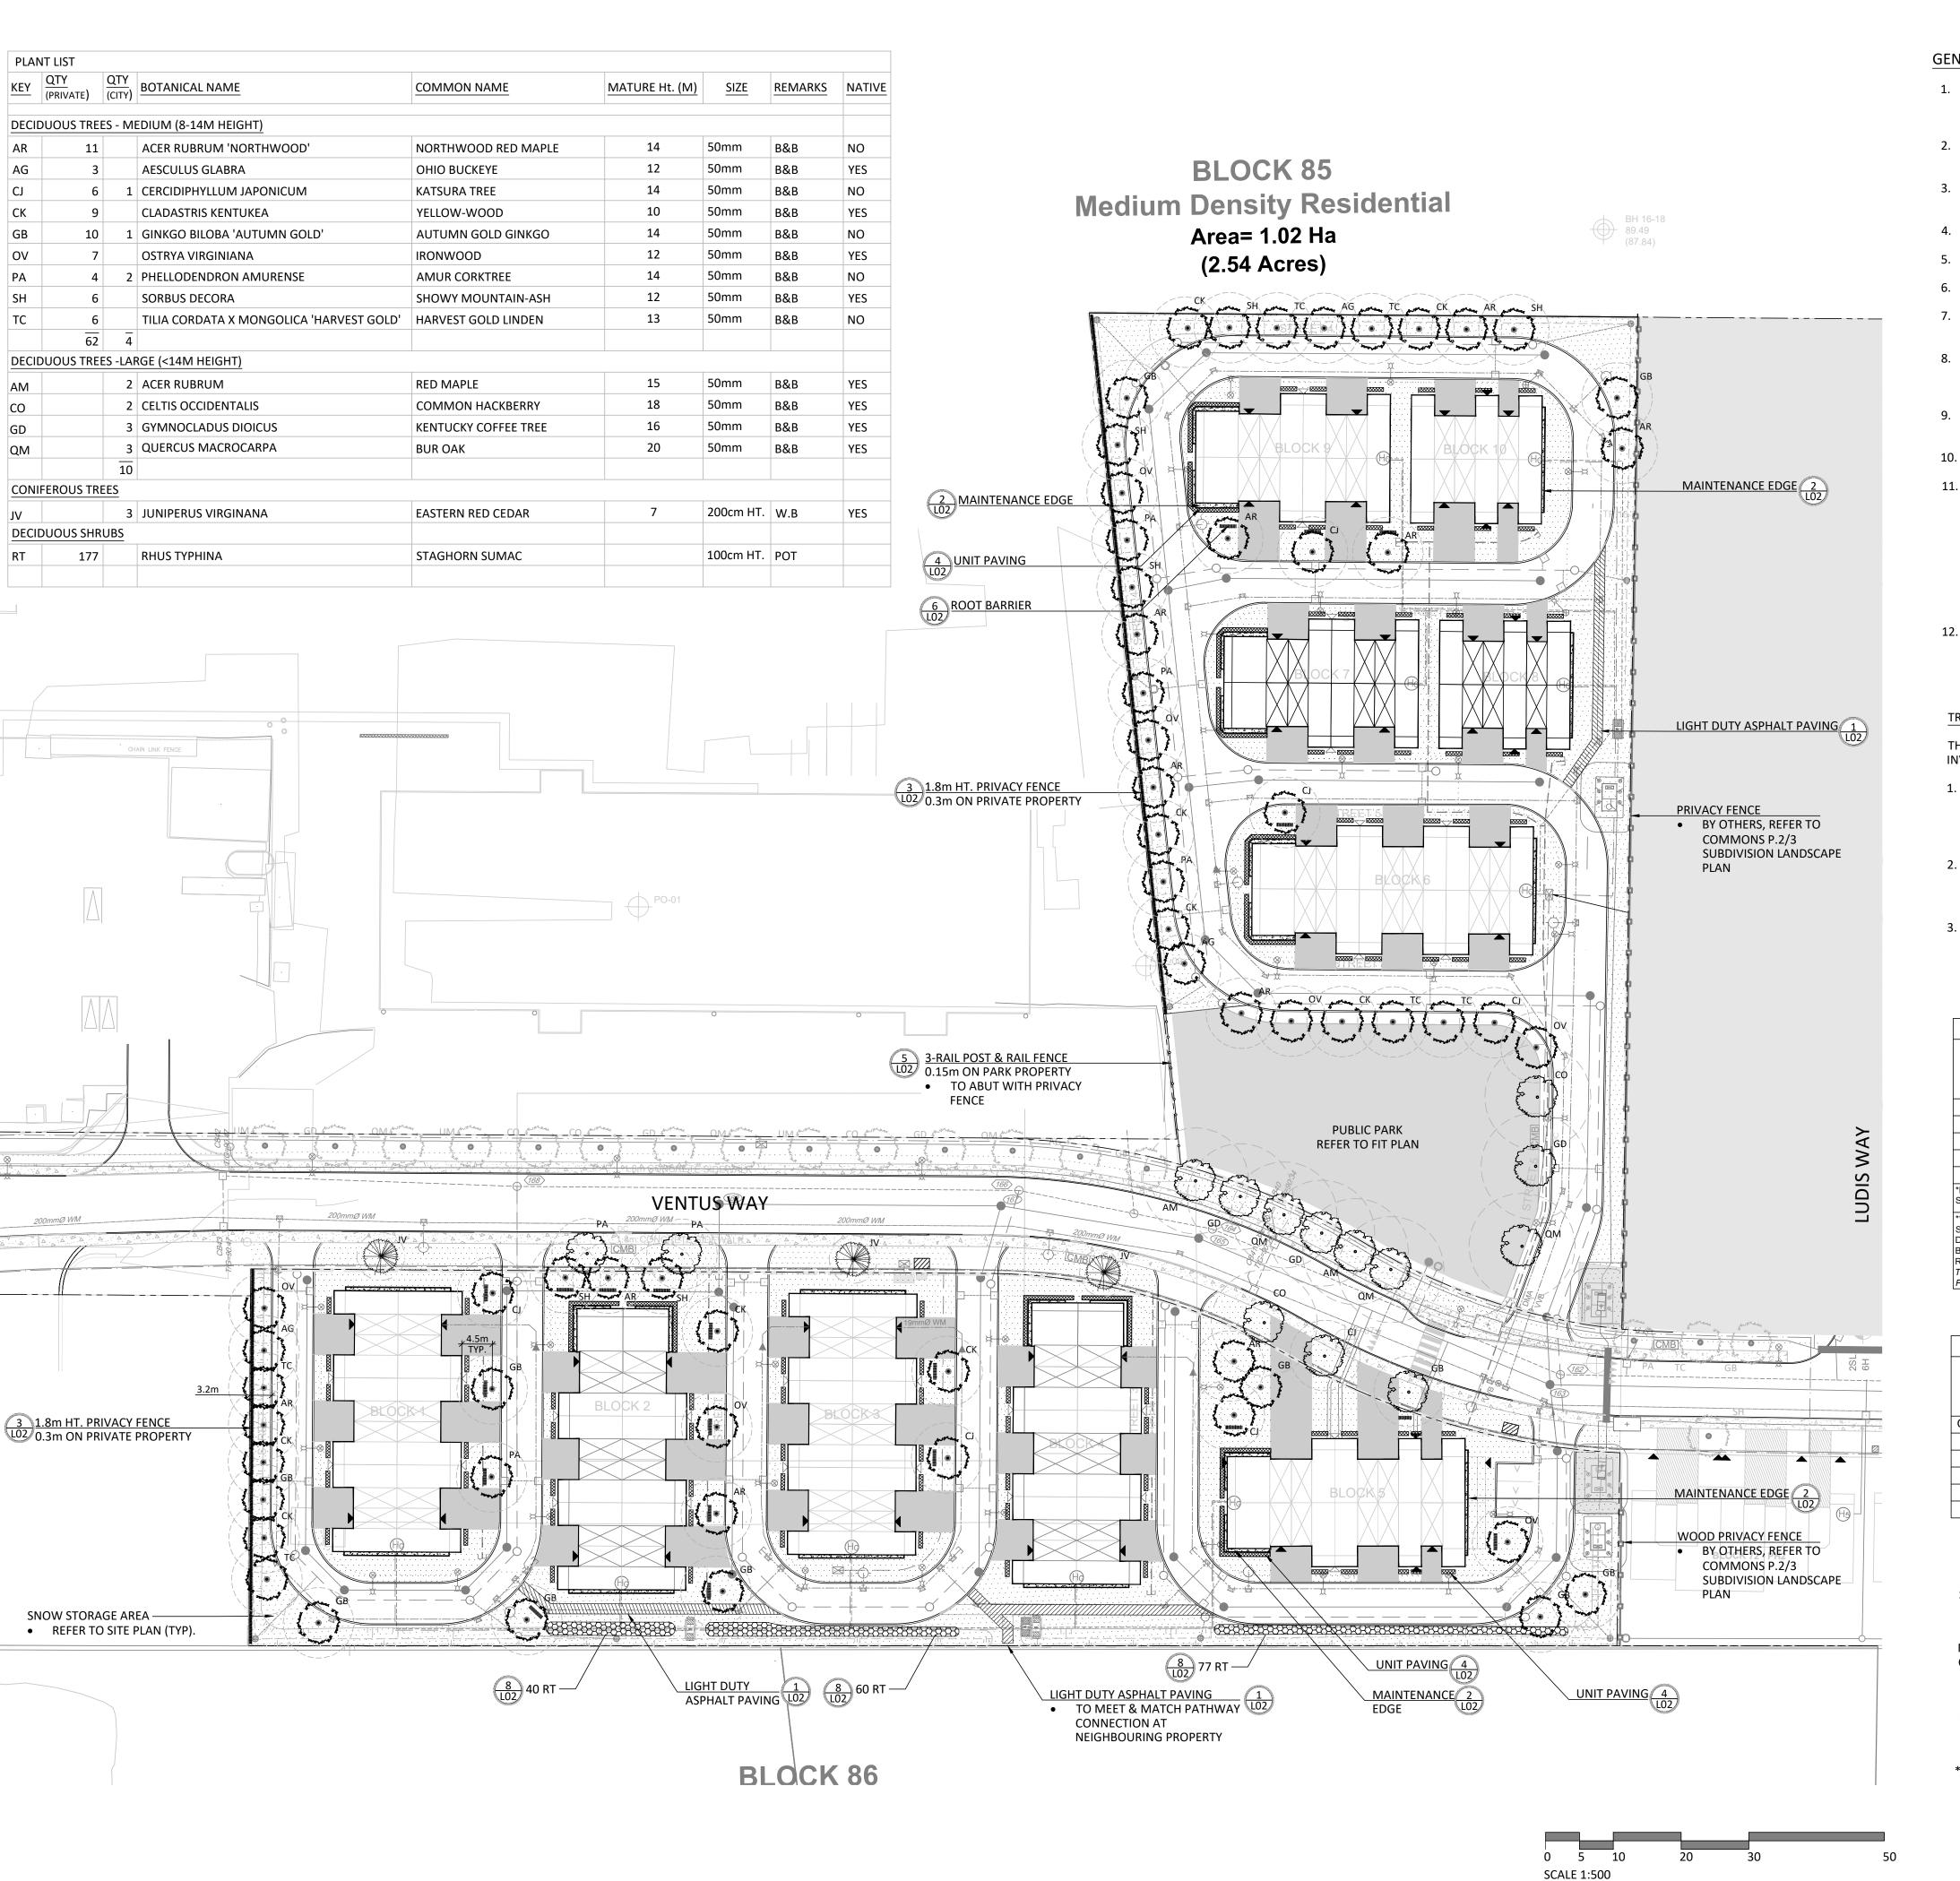

GENERAL NOTES:

- 1. THE LOCATION OF THE TREES SHOWN ON THIS PLAN IS APPROXIMATE AND SHALL NOT BE SCALED FROM THIS DRAWING. THIS PLAN MUST BE READ IN CONJUNCTION WITH THE APPROVED CUP AND CITY CROSS
- 2. CONTRACTOR SHALL ENSURE THAT ALL UTILITY LOCATIONS ARE OBTAINED PRIOR TO ANY EXCAVATION FOR
- 3. LOCATION OF ALL PLANT MATERIALS TO BE STAKED BY THE CONTRACTOR AND VERIFIED IN THE FIELD BY LANDSCAPE ARCHITECT & CITY OF OTTAWA PRIOR TO THE EXCAVATION OF PITS.
- 4. ALL PLANT MATERIAL SHALL BE NURSERY GROWN STOCK UNLESS OTHERWISE NOTED.
- 5. TREES TO HAVE A MINIMUM 1800 CLEAR STEM ABOVE GRADE.
- 6. PLACE SOD ON A MINIMUM 150mm TOPSOIL.
- 7. CONTRACTOR TO MAKE GOOD ALL EXISTING AREAS DAMAGED BY HIS WORK TO THE SATISFACTION OF THE CITY OF OTTAWA.
- 8. THE CITY WILL BE NOTIFIED IF ANY TREES CANNOT BE LOCATED OR PLANTED DUE TO CONFLICTS WITH UTILITIES OR DRIVEWAYS. THE REQUIRED TREES NOT PLANTED ARE SUBJECT TO TREE BANKING. THE FINAL NUMBER OF TREES TO BE BANKED WILL BE PROVIDED TO THE CITY FOLLOWING ALL PLANTINGS.
- 9. ALL PLANT MATERIAL SHALL BE WARRANTIED FOR TWO YEARS FROM THE DATE OF PERFORMANCE ACCEPTANCE AS DETERMINED BY THE CITY OF OTTAWA.
- 10. PERIODIC REVIEWS OF PLANTING SHALL BE CARRIED OUT BY THE LANDSCAPE ARCHITECT.
- 11. STREET TREE PLANTING GUIDELINE
 - NOTE: APPROVED CROSS SECTIONS SHALL TAKE PRECEDENCE 4.5m - STREET LIGHT (SMALL TREE <7m MATURE HT.)
 - 2.5m STREET LIGHT (MEDIUM/LARGE TREE >7m MATURE HT.)
 - 3.0m HYDRO TRANSFORMER 1.5m - PATH, DRIVEWAY, FENCE, SOUND WALL

 - 2.5m FIRE HYDRANTS 1.5m - WATER SERVICE / CURB STOP
 - 1.0m BELL / CABLE PEDESTALS
 - TOTAL NUMBER OF TREES REQUIRED, THE COMMONS PHASE 1: NUMBER OF STREET TREES SHOWN ON PLAN, THE COMMONS PHASE 1:
 - 105 TOTAL NUMBER OF TREES REQUIRED, THE COMMONS PHASE 2&3: NUMBER OF STREET TREES SHOWN ON PLAN, THE COMMONS PHASE 2&3: 137 DIFFERENCE:


TREE PLANTING IN MARINE CLAY SOILS

THE LANDSCAPE CONSIDERATIONS CONTAINED WITHIN SEC. 6.8 OF PATERSON GROUP'S GEOTECHNICAL INVESTIGATION, DATED JULY 8, 2024.

- 1. THIS LANDSCAPE PLAN CONFORMS WITH THE TREE-TO-FOUNDATION SETBACK, SOIL VOLUME, AND SURFACE-GRADING REQUIREMENTS OUTLINED IN THE CITY OF OTTAWA'S GUIDELINES FOR TREE PLANTING IN SENSITIVE MARINE CLAY SOILS (2017), BASED ON THE FINDINGS OUTLINED IN THE PROJECT GEOTECHNICAL REPORT BY PATERSON GROUP (REPORT PG4026-3-1 DATED JULY 8, 2024).
- 2. ADDITIONAL REQUIREMENTS OUTLINED IN THE CITY OF OTTAWA'S GUIDELINES FOR TREE PLANTING IN SENSITIVE MARINE CLAY SOILS (2017), INCLUDING USF DEPTH, FOUNDATION WALL REINFORCEMENT, AND SUBDIVISION GRADING, SHOULD BE CONFIRMED BY THE PROJECT ENGINEER(S).
- 3. THE CONTRACTOR SHOULD REPORT ANY DISCREPANCIES TO THE CONTRACT ADMINISTRATOR BEFORE PLANTING TREES.

PROPOSED TREE CANOPY PROJECTIONS					
TREE TYPE/SIZE	CROWN AREA PER TREE STANDARD RANGE (m ²)	CROWN AREA PER TREE USED FOR CALC. (m ²)	SITE CANOPY COVER		
LARGE (10)	135-250*	192	CANOPY (W. OVERLAP):4443m ²		
MEDIUM (65)	35-135*	85			
CONIFER (3)	45-96*	70			
*RANGE OF CROWN AREAS SPECIES	SITE: 19,975m ²				
**CROWN AREAS ARE ACC SIZE OF THE RESPECTIVE : DETERMINED IN REFEREN BOTANICAL SOURCES, SUC RESOURCES & FORESTRY TREES IN CANADA, UNIVER PUBLICATIONS	SPECIES. CANOPY SIZIN CE TO VARIOUS ARBORI CH AS: ONTARIO MINISTR (OMNRF); US FOREST SI	G HAS BEEN CULTURAL AND RY OF NATURAL ERVICE; FARRAR, J.L.	TOTAL PERCENT COVER: 22%		

TREE SOIL VOLUMES				
TREE TYPE/SIZE	SINGLE TREE SOIL VOLUME	MULTIPLE TREE SOIL VOLUME (m3/TREE)		
ORNAMENTAL	15	9		
COLUMNAR	15	9		
SMALL	20	12		
MEDIUM	25	15		
LARGE	30	18		
CONIFER	25	15		

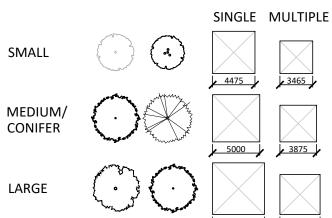

*SOIL VOLUME CALCULATION BASED ON 1.0m DEPTH

Contractor shall check all dimensions on the work and report any discrepancy to the Landscape Architect before proceeding. All drawings and specifications are the property of the Landscape Architect and must be returned at the completion of the work. This drawing is not to be used for construction until signed by the

Key Plan

Landscape Architect.



PROJECT CONSULTANTS

KORSIAK URBAN PLANNING

PLANNING: NOVATECH MECHANICAL & ELECTRICAL

GEOTECHNICAL & STRUCTURAL PATERSON GROUP

CIVIL ENGINEERING NOVATECH


LEGEND

PROPERTY LINE PHASE LINE

4.5m FOUNDATION SETBACK FENCING

PRIVACY FENCE —o—o—o— POST AND RAIL FENCE

PLANTING

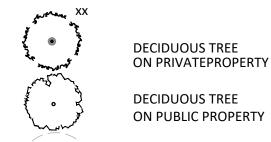

PROJECTED TREE CANOPY

APPROVED STREET TREES

ROOT BARRIER (REFER TO DETAIL 6/L02)

SODDING


SURFACING

ASPHALT PAVING

DRIVEWAY (BY OTHERS)

4	Re-Issued for SPA	Aug.8/25
3	Re-Issued for SPA	Feb.13/25
2	Issued for SPA	Oct.25/24
1	Issued for Coordination	Sep.11/24



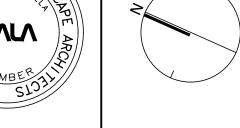




1285 WELLINGTON STREET, OTTAWA, ON K1Y 3A8 CANADA
T 613.237.2345 NAKDESIGNSTRATEGIES.COM

THE COMMONS SITE PLAN Ottawa, ON

LANDSCAPE PLAN

Job No. 24-219

Date Oct, 2024 Scale 1:500 L01 Drawn PG Checked PG

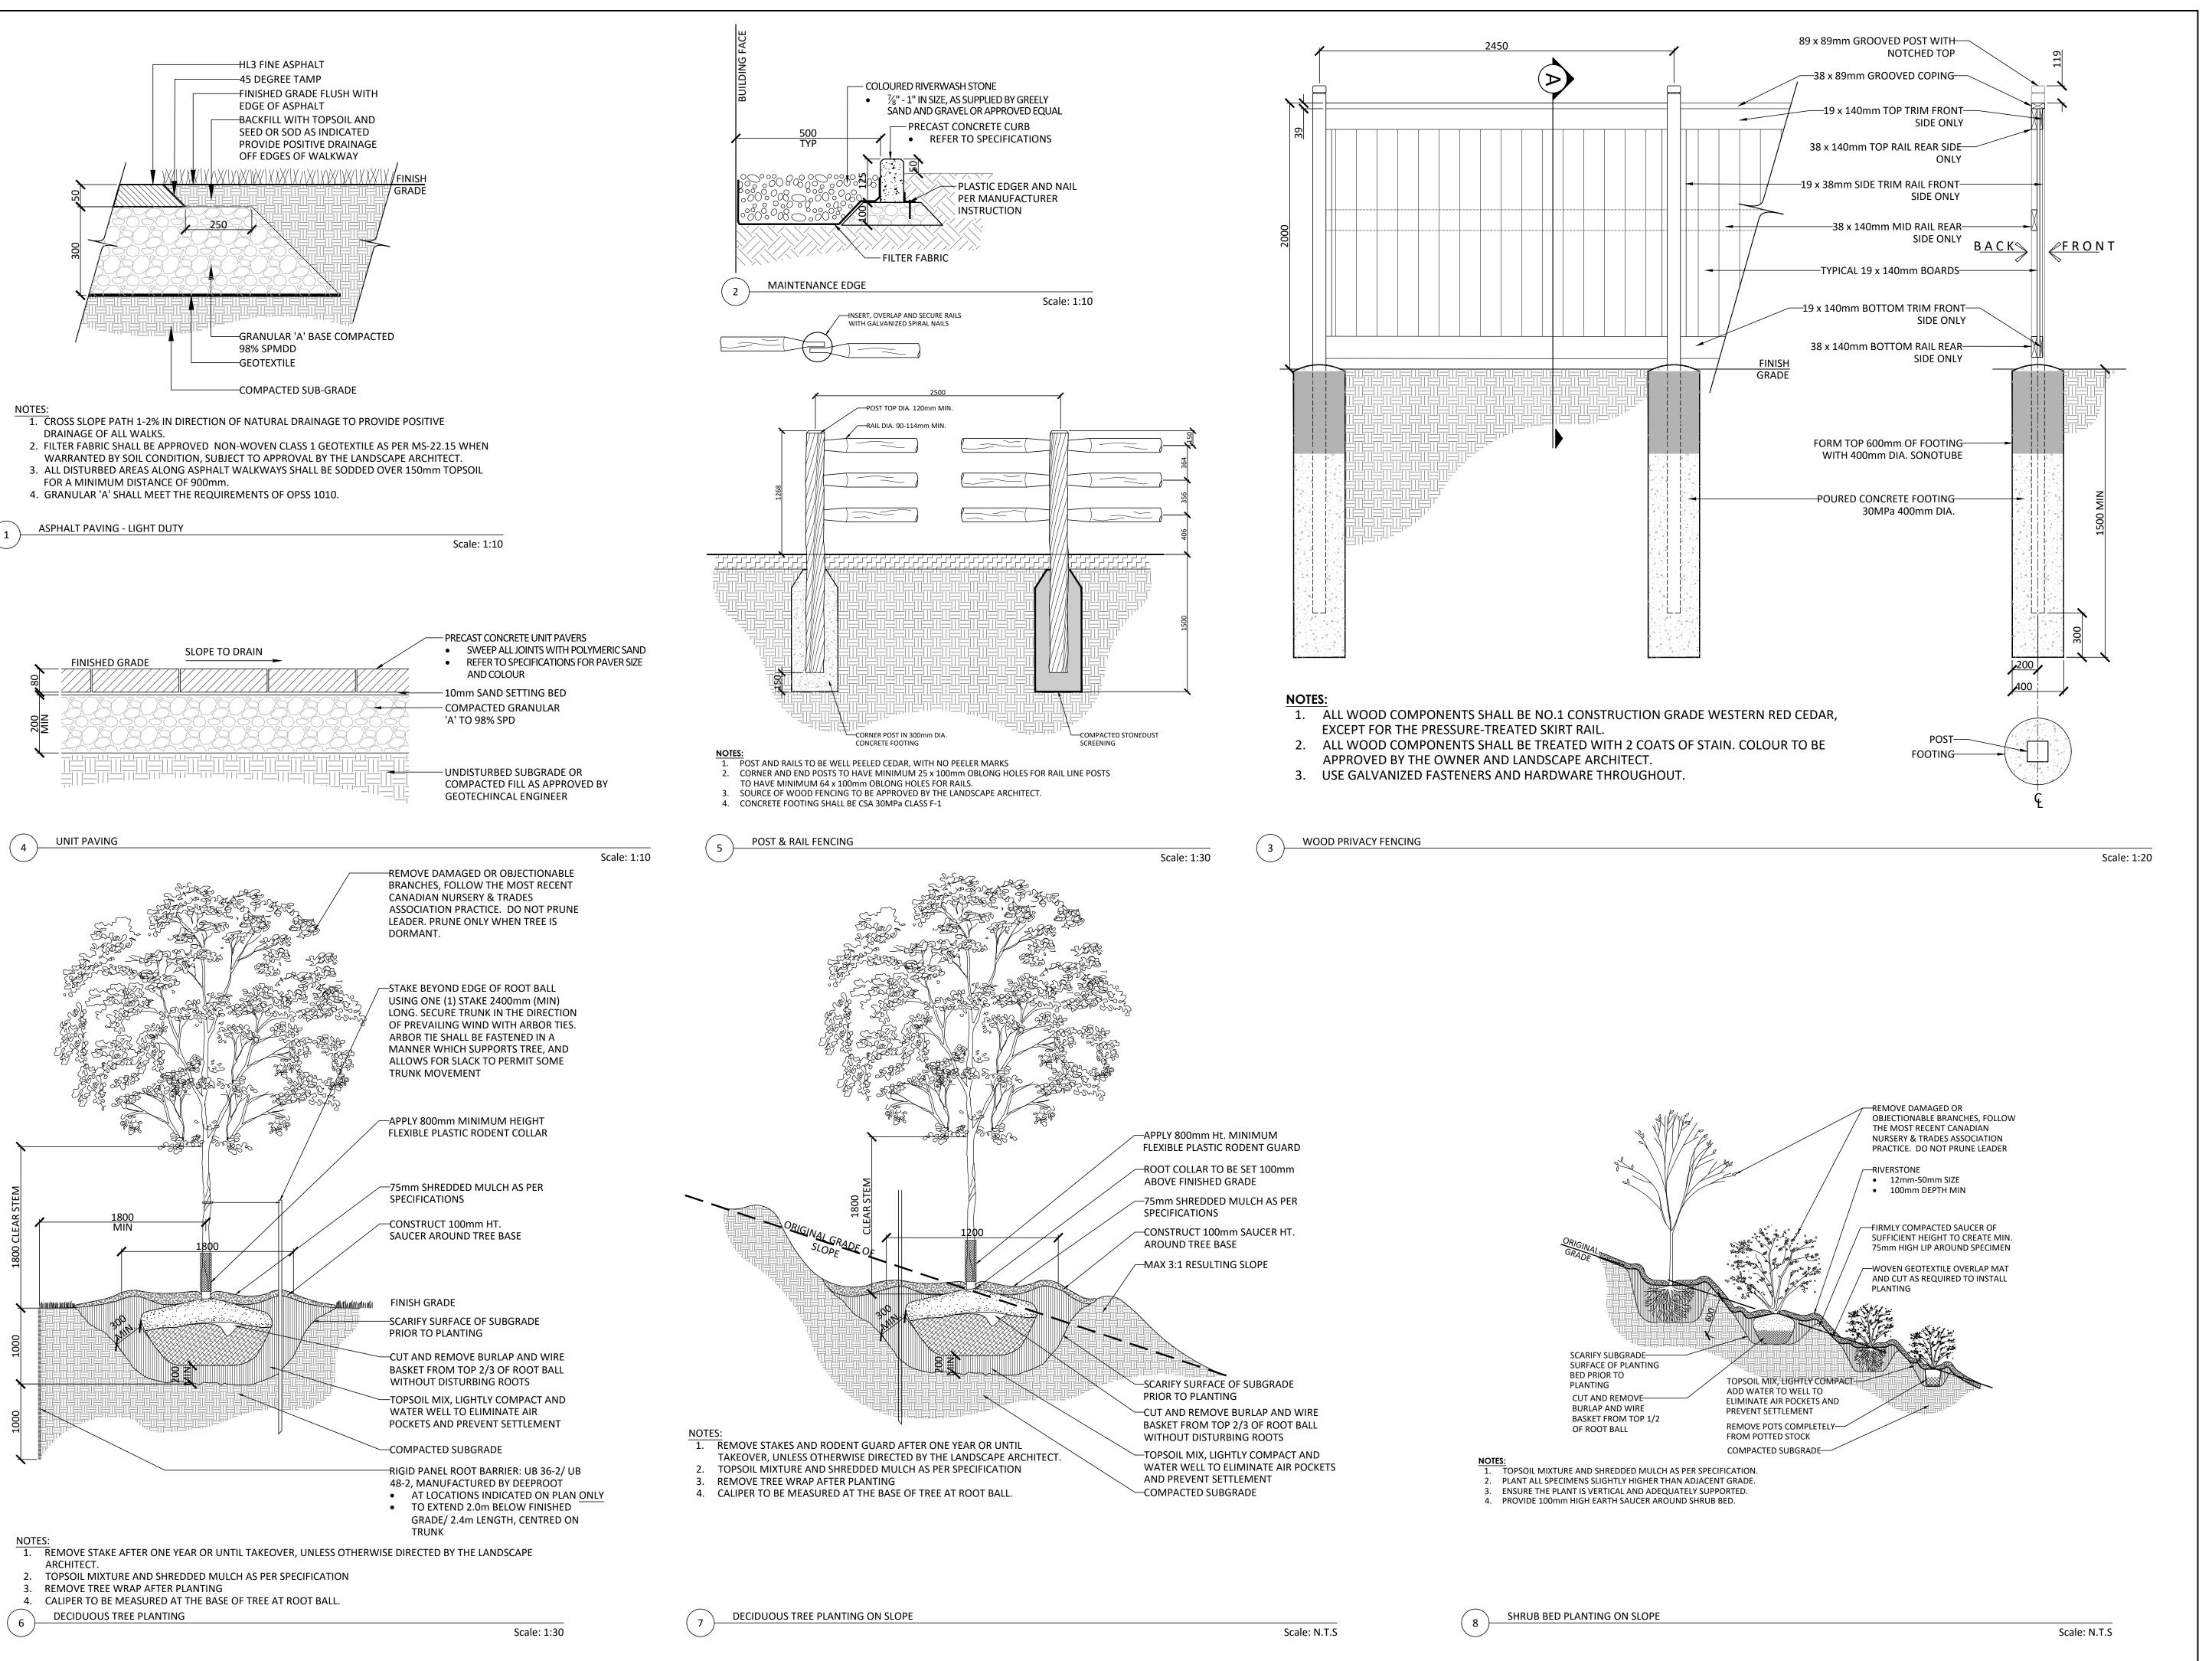

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PROJECT CONSULTANTS SITE PLAN DESIGN:

KORSIAK URBAN PLANNING PLANNING: NOVATECH

MECHANICAL & ELECTRICAL

CIVIL ENGINEERING:

NOVATECH


GEOTECHNICAL & STRUCTURAL PATERSON GROUP

Aug.8/25

Feb.13/25

Oct.25/24

Sep.11/24

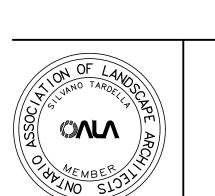

4 Re-Issued for SPA

3 Re-Issued for SPA

2 Issued for SPA

No. Description

Revision

1 Issued for Coordination

design strategies

1285 WELLINGTON STREET, OTTAWA, ON K1Y 3A8 CANADA T 613.237.2345 NAKDESIGNSTRATEGIES.COM

THE COMMONS SITE PLAN Ottawa, ON

LANDSCAPE DETAILS

Date Oct, 2024 Scale AS SHOWN L02 Drawn PG Checked PG

Job No. 24-219