500 COVENTRY ROAD

500 COVENTRY ROAD, OTTAWA, ON.

18.050 P01

	SPA DRAWINGS
SHEET NUMBER	SHEET NAME
SPA000	COVER SHEET
SPA001	SURVEY
SPA003	TGS CHECKLIST
SPA004	CONTEXT PLAN
SPA005A	MASTERPLAN / CONCEPT PLAN
SPA005B	SITE PLAN / ROOF PLAN - OVERALL SITE
SPA005C	SITE PLAN / ROOF PLAN
SPA005D	SITE PLAN / ROOF PLAN - OPTION 1
SPA006	RESIDENTIAL SOLID WASTE MANAGEMENT
SPA101	UNDERGROUND LEVEL 02
SPA102	UNDERGROUND LEVEL 01
SPA151	FLOOR 01
SPA152	FLOOR 02
SPA153	FLOOR 03 - 05
SPA154	FLOOR 06
SPA155	FLOOR 07
SPA156	FLOOR 08 - 28
SPA157	MPH
SPA301	ELEVATIONS
SPA302	ELEVATIONS
SPA311	1 TO 50 ELEVATIONS
SPA312	1 TO 50 ELEVATIONS
SPA321	BIRD FRIENDLY ELEVATIONS
SPA401	SECTION A - A
SPA411	WALL SECTIONS
SPA600	DETAILS
SPA801	3D PERSPECTIVES
SPA802	3D PERSPECTIVES
SPA803	3D PERSPECTIVE
SPA804	3D PERSPECTIVES
SPA805	3D PERSPECTIVES
SPA806	3D PERSPECTIVES
SPA807	3D PERSPECTIVES
SPA808	3D PERSPECTIVES
SPA809	3D PERSPECTIVES - PARKING RAMP
SPA810	3D PERSPECTIVES - PARKING RAMP
SPA811	JUNE SHADOW STUDIES
SPA812	JUNE SHADOW STUDIES
SPA813	JUNE SHADOW STUDIES
SPA814	JUNE SHADOW STUDIES
SPA815	JUNE SHADOW STUDIES
SPA816	JUNE SHADOW STUDIES
SPA817	JUNE SHADOW STUDIES
SPA818	SEPTEMBER SHADOW STUDIES
SPA819	SEPTEMBER SHADOW STUDIES
SPA820	SEPTEMBER SHADOW STUDIES
SPA821	SEPTEMBER SHADOW STUDIES
SPA822	SEPTEMBER SHADOW STUDIES
SPA823	SEPTEMBER SHADOW STUDIES
SPA824	DECEMBER SHADOW STUDIES
SPA825	DECEMBER SHADOW STUDIES
SPA826	DECEMBER SHADOW STUDIES
SPA827	DECEMBER SHADOW STUDIES



CGH Transportation

Traffic Consultant 13 Markham Ave Ottawa, ON, K2G 3Z1 Contact Name: Andrew Harte Tel.: (613) 697-3797 E-Mail: andrew.harte@cghtransportation.com

Civil Engineer 6240 Hwy 7, Suite 200 Woodbridge, ON, L4H 4G3 Contact Name: Alison Gosling Tel.: (613) 714 - 4629 E-Mail: Alison.GOSLING@egiś-group.com

Gradient Wind

Wind 127 Walgreed Rd, Carp, ON, K0A 1L0 Contact Name: David Hurtima Tel.: (613) 836-0934 E-Mail: david.hurtima@gradientwind.com



Morguard Corporation 55 City Centre Drive, Suite 1000 Mississauga, ON L5B 1M3 Contact Name: Mark Bradley Phone Number: D: (905) 281-5831 Email: mbradley@morguard.com

> **FLEISCHER** 67 Lesmill Rd Toronto, ON, M3B 2T8 **Contact Name: Anita Yu** Phone Number: 416-425-2222 ext 235 Email: anita.yu@turnerfleischer.com

ISSUED FOR SITE PLAN APPROVAL NOVEMBER 01, 2024


Vollebekk Ltd.


Surveyor 14 Concourse Gate, Suite 500 Nepean, ON, K2E 7S6 Contact Name: Annia O'sullivan Tel.: (613) 727-0850 E-Mail: Nepean@aovltd.com


Foten Planning + Design

Landscape & Urban Planner 396 Cooper Street, Suite 300 Ottawa, ON, K2P 2H7 Contact Name: Jillian Simpson Tel.: (613) 730-5709 E-Mail: simpson@fotenn.com

Egis

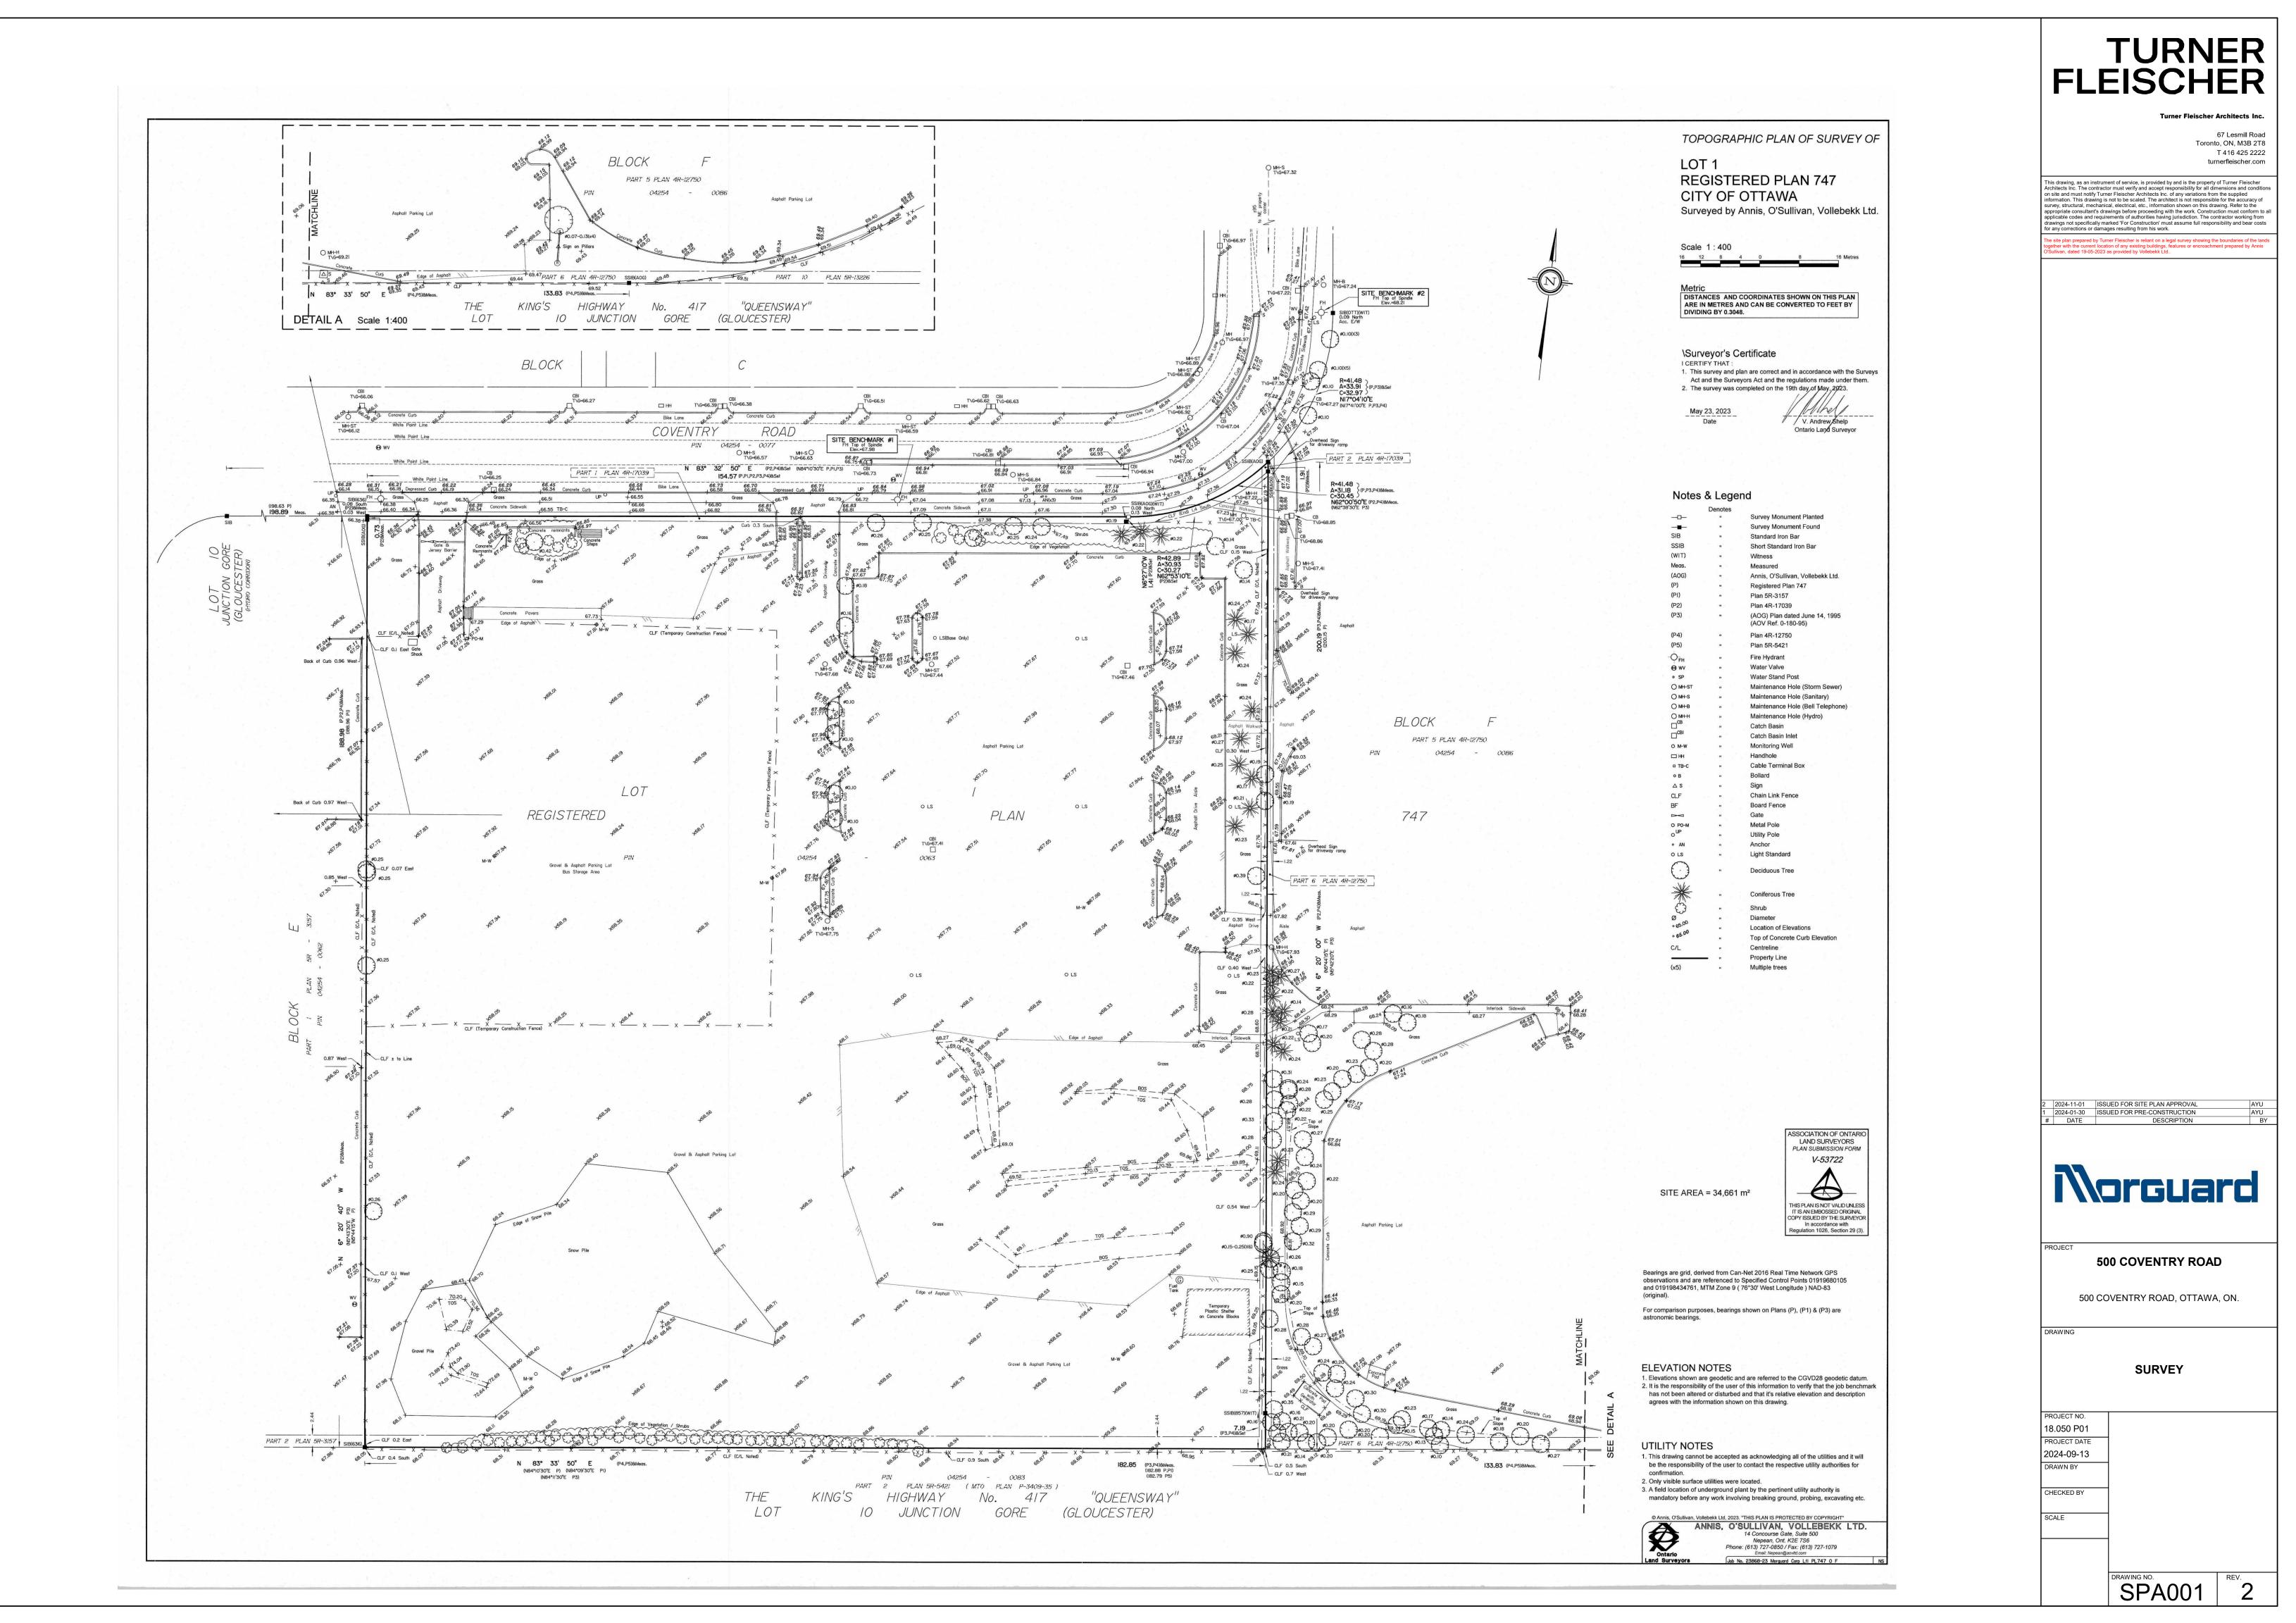


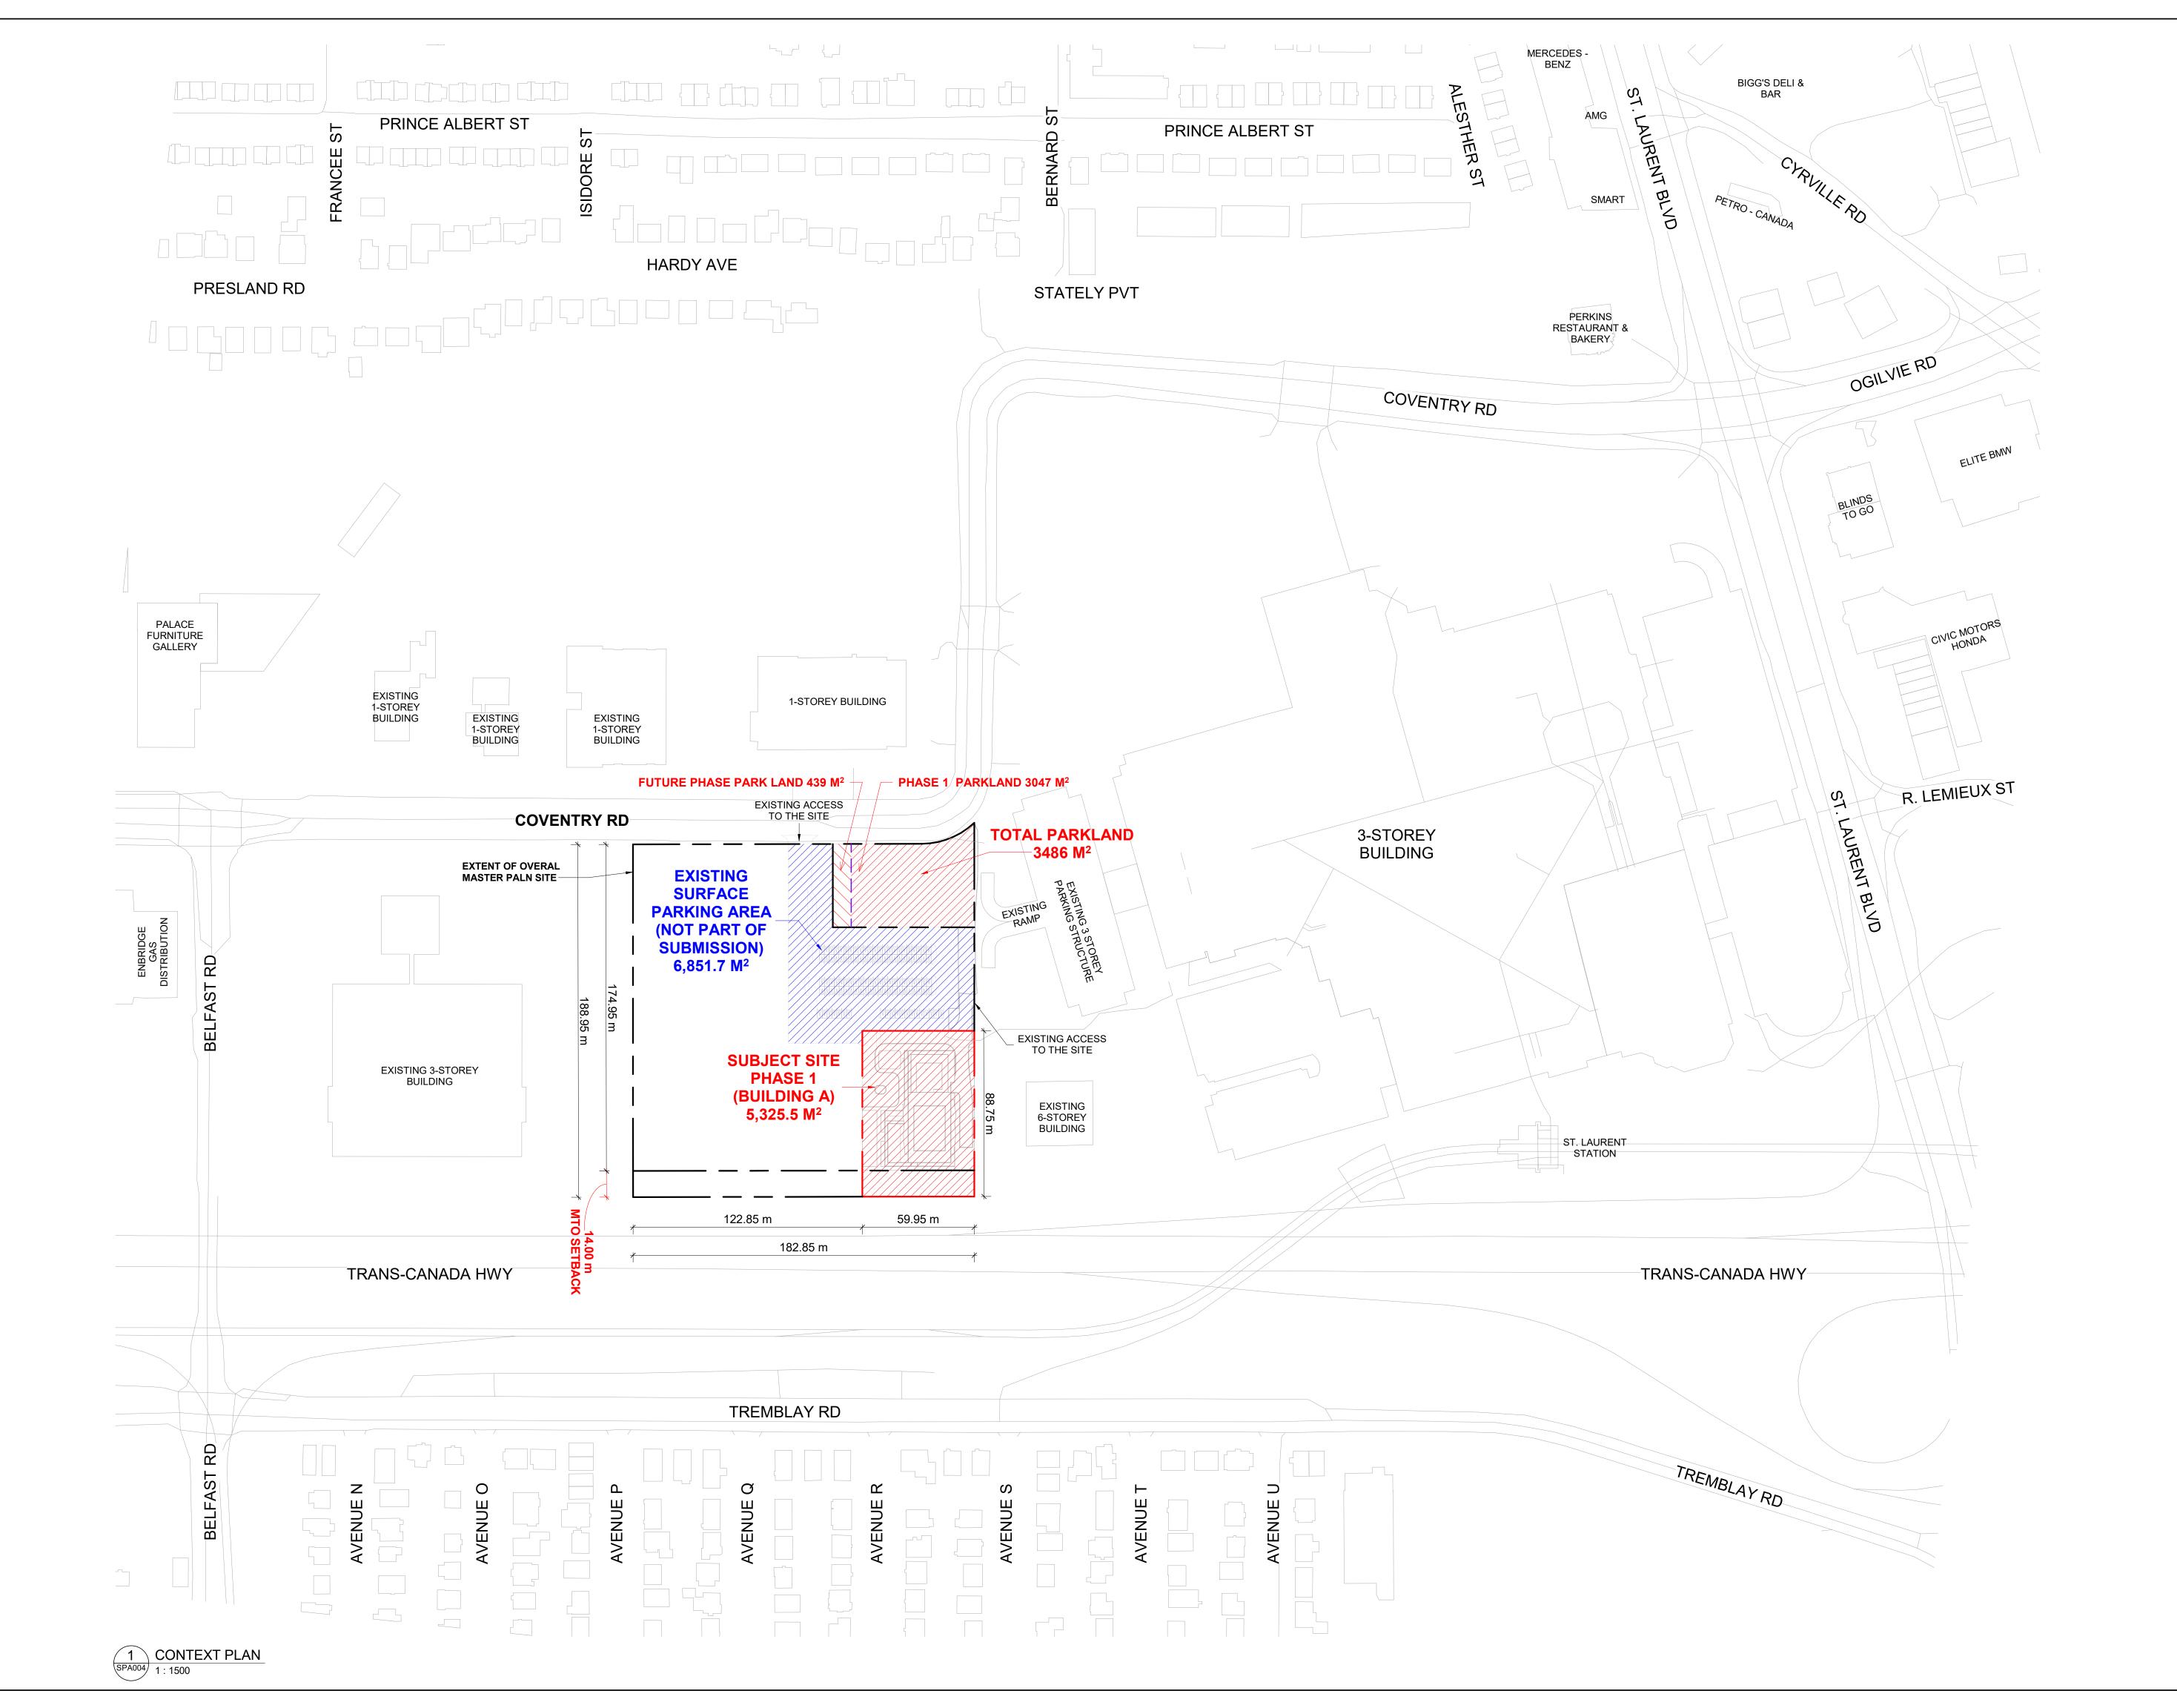


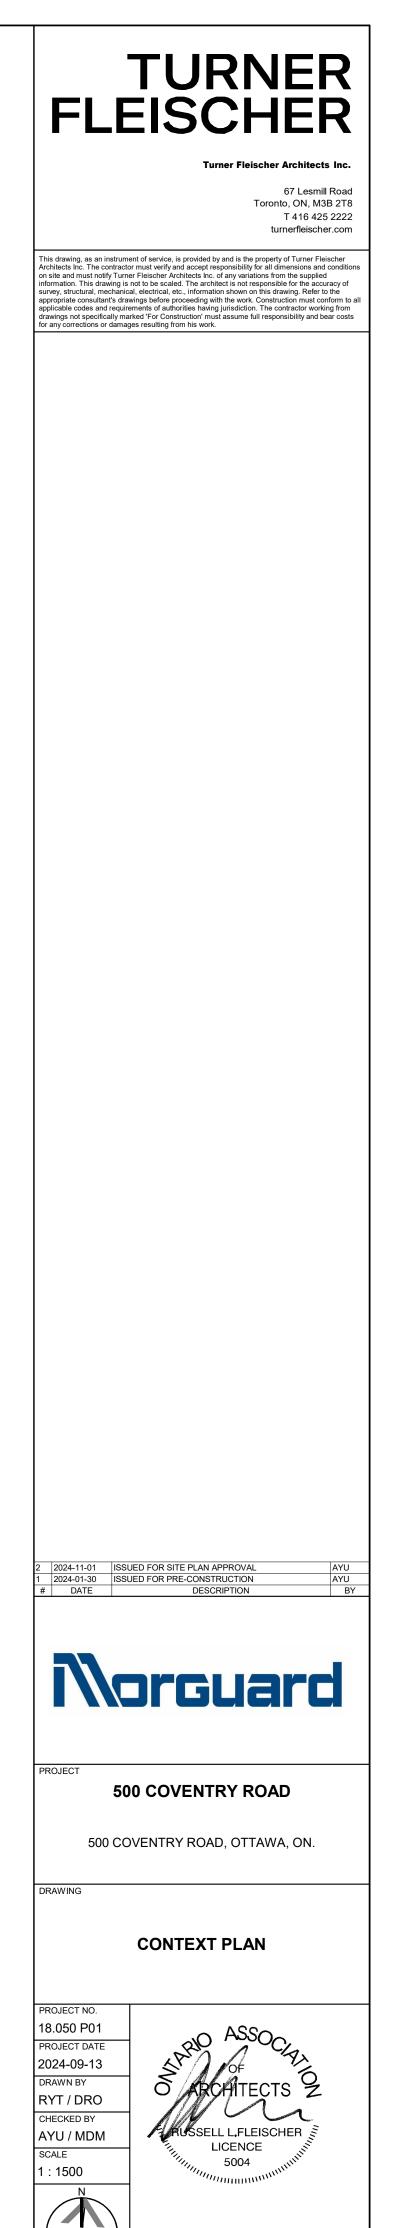


REV. 2

BRAWING NO. SPA004

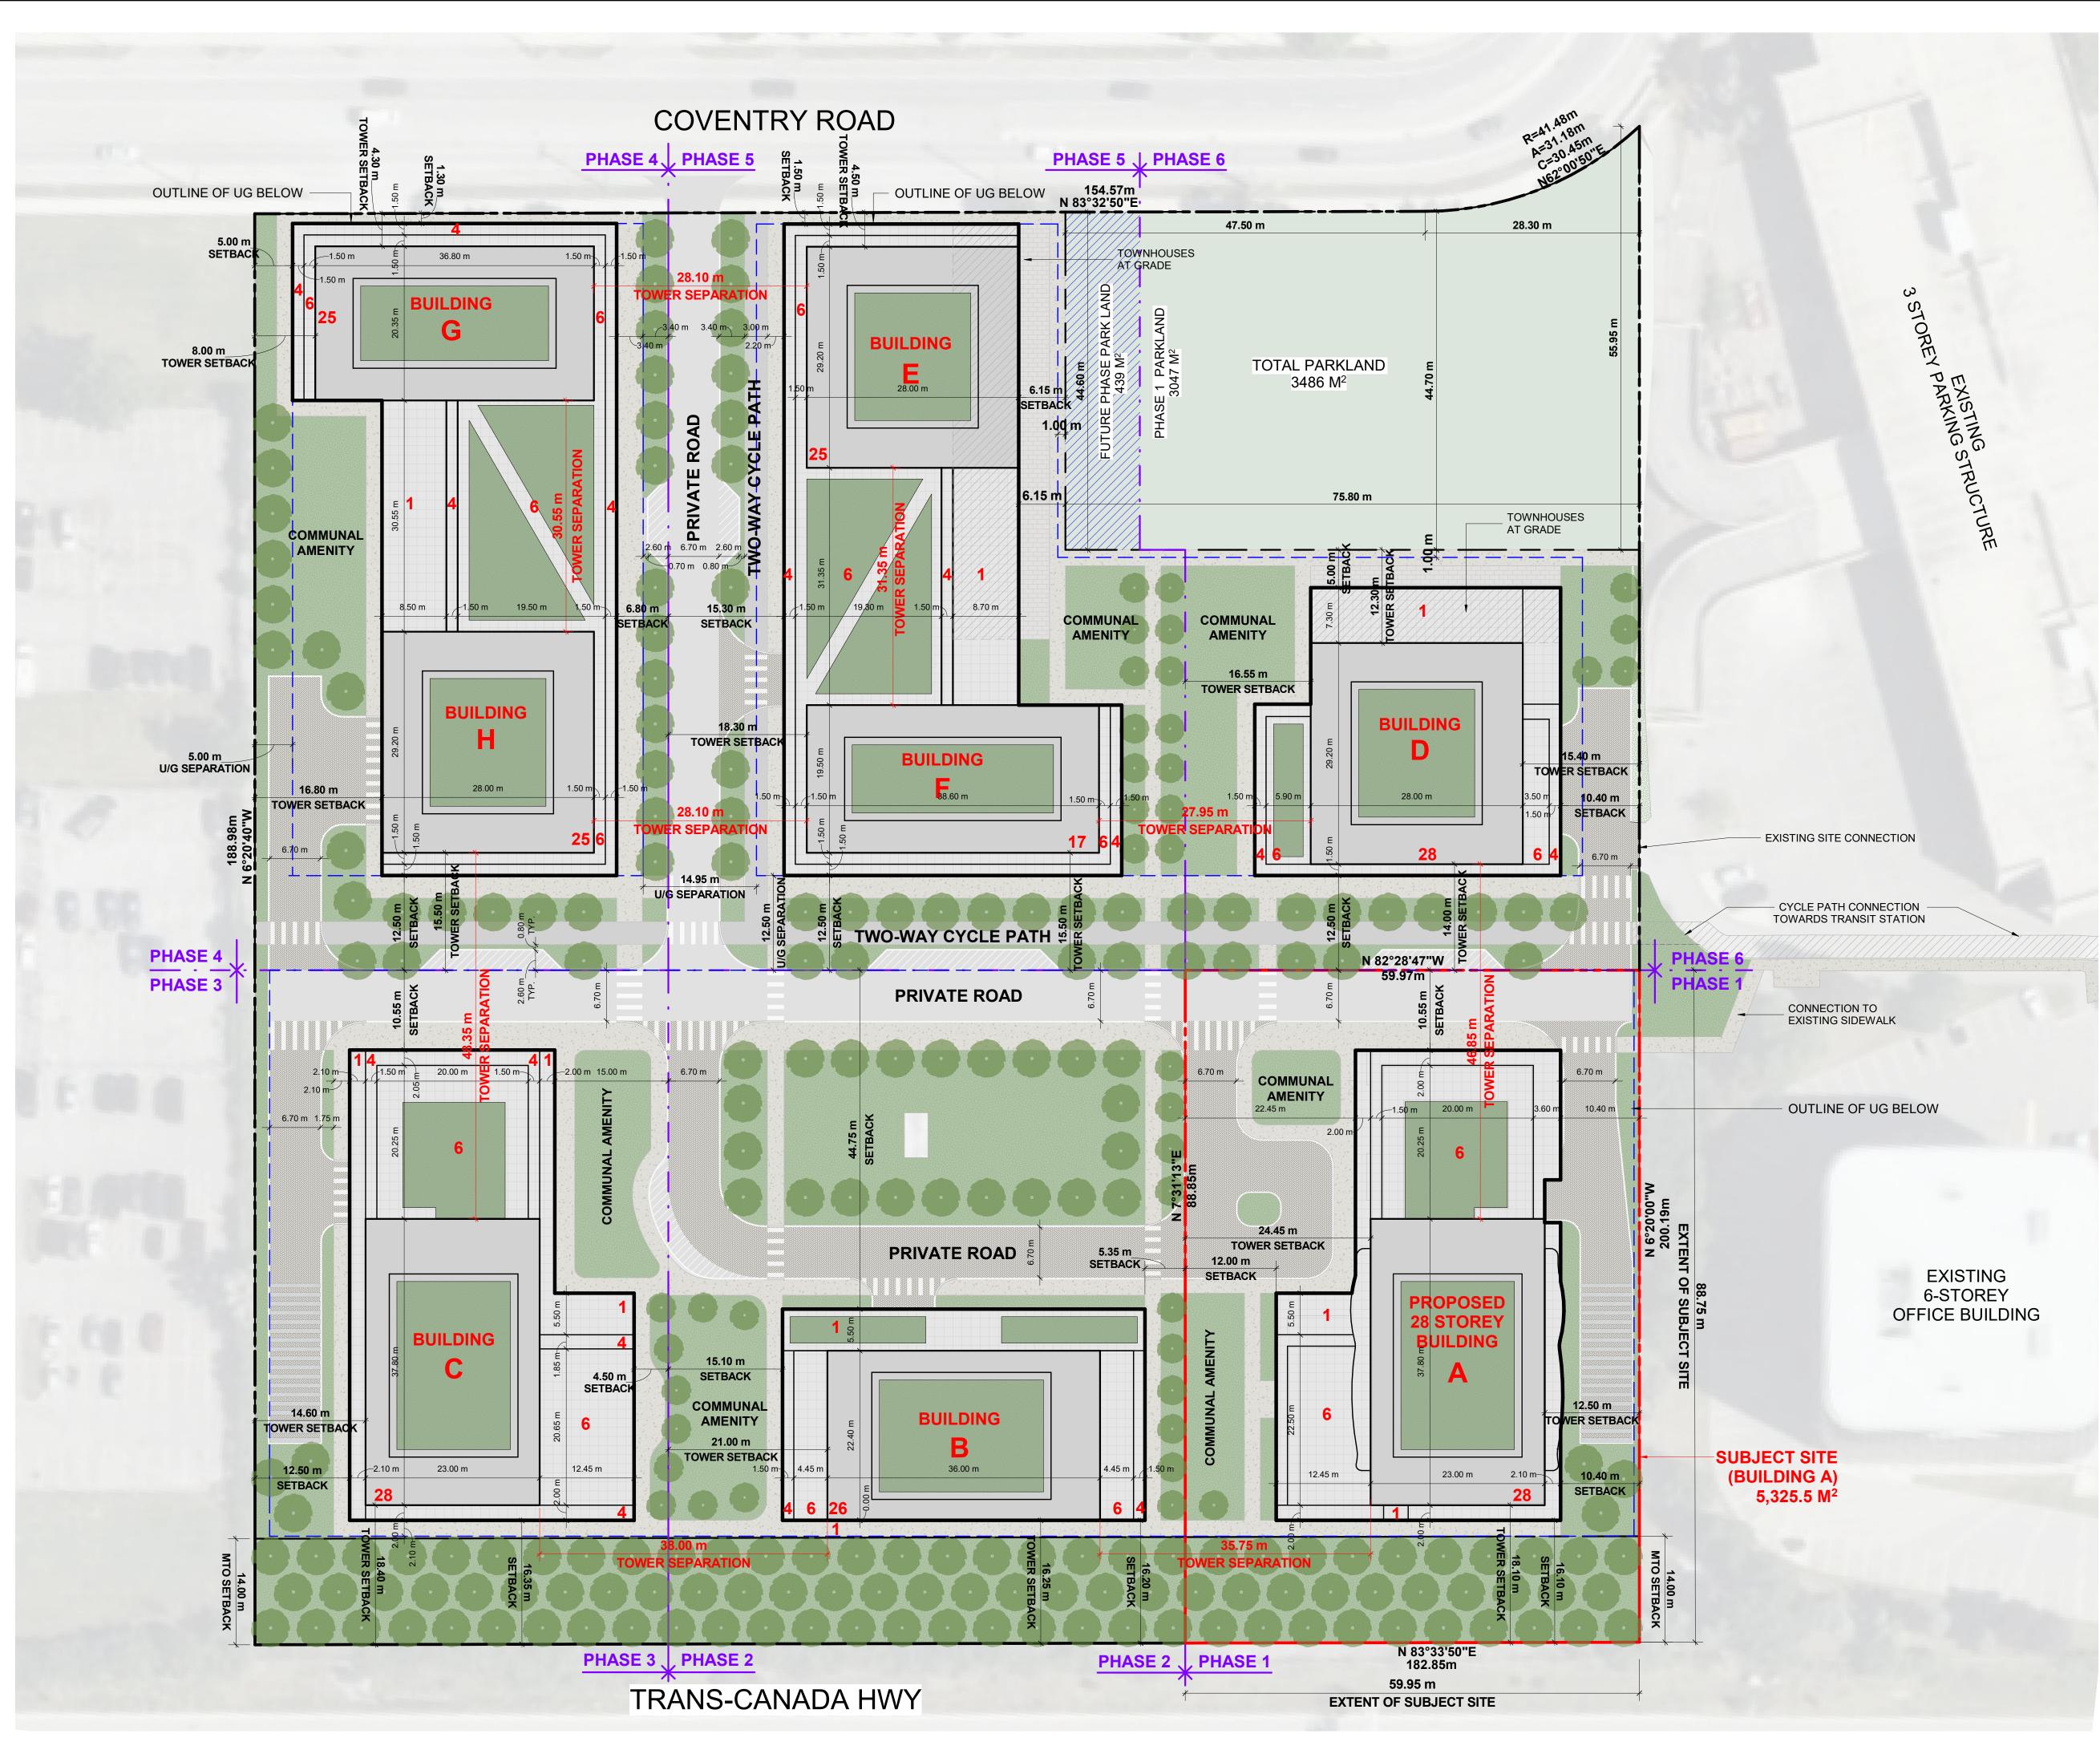


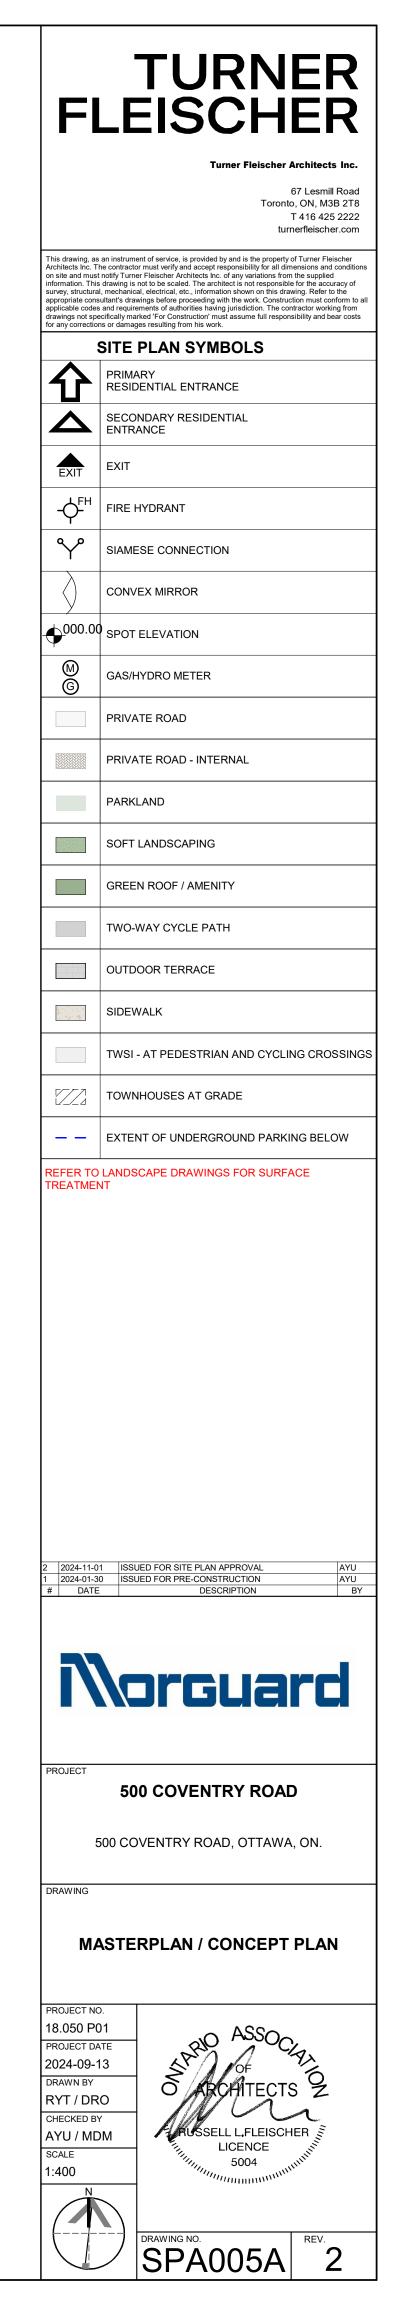

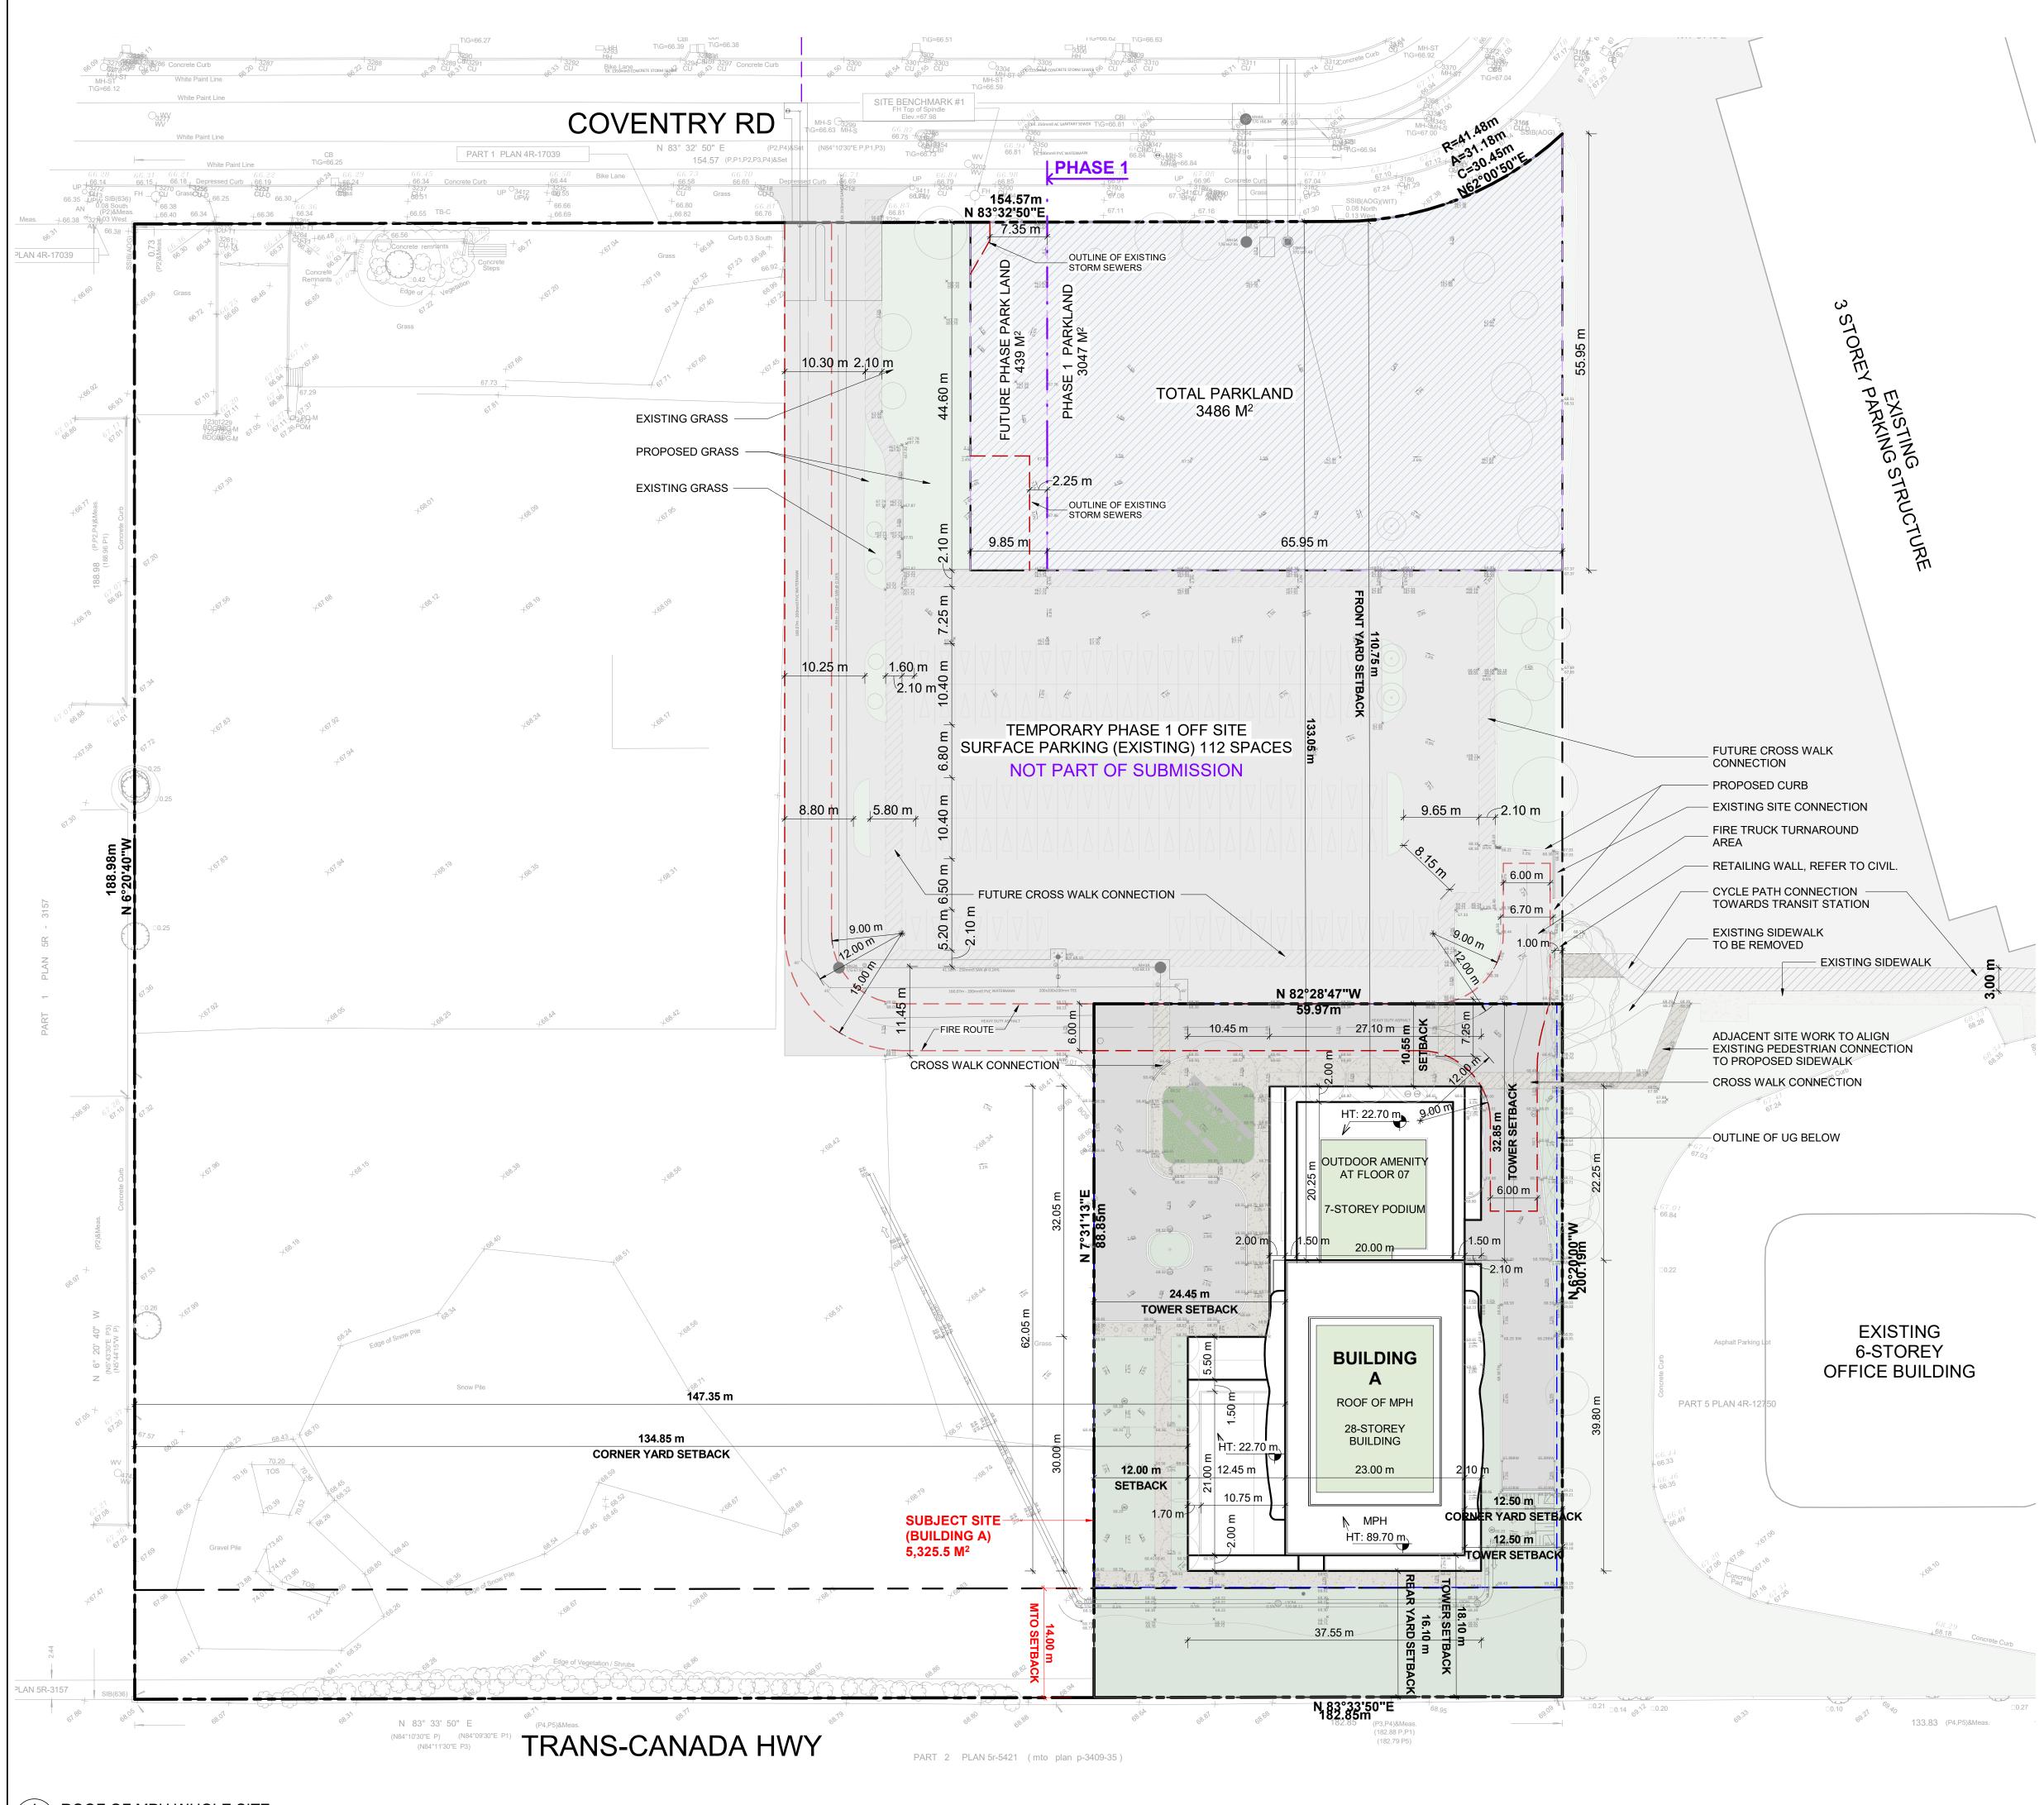


1 ROOF OF MPH WHOLE SITE SPA005B 1:400


AREA TYPE SITE AREA - BLDG A	m²	ft ²		LE
TOTAL PARKLAND AREA	5,325		323.4 7,523	
TEMPORARY OFF SITE PARKING (PHASE 1) PHASE 1 SURFACE PARKING	6,85	7 73	751.1	
ZONING			This drawing	g, as an instrument o
BUILDING HEIGHT	REQUIRED 30 STOREY		on site and m information.	c. The contractor mu nust notify Turner FI This drawing is not t tural, mechanical, e
GRADE (GEODETIC ELEVATION - ASL)	90.0		applicable co drawings not	consultant's drawing odes and requirement t specifically marked actions or damages r
ALLOWABLE PROJECTION - AMENITY LEVEL DENSITY - MINIMUM 350 units/hectare	0.0		2.7M The site plan together with t	prepared by Turner F the current location o ted 19-05-2023 as pr
FRONT YARD SETBACK	3.0		.75M	SITE P
CORNER YARD SETBACK(East / West) REAR YARD SETBACK(GROUND TO 6th FLO	3.0M/3.0 OOR) 0.0		2.5M	PRIMAR
REAR YARD SETBACK (ABOVE 7th STOREY	() 12.0	DM 18	.10M	RESIDE
AMENITY AREA - TOTAL PER UNIT AMENITY AREA - 50% COMMUNAL PER UNIT	6.0 3.0		7.4M ² 55M ²	SECONE ENTRAN
AMENITY AREA - 2.0% OF LOT EXTERIOR AT GRADE COMMUNAL	117.15	M ² 172	2.6M ²	EXIT
VEHICLE PARKING - RESIDENTIAL (AREA 'Z'		DT	289	н
1.5/PER UNIT) VEHICLE PARKING - VISITOR ONLY (MAX. 30	REQUIRI	<u>-</u> D 30		FIRE HY
AFTER 12 UNITS)			Y^	SIAMES
BICYCLE PARKING - RESIDENTIAL - 0.5 PER AISLE & DRIVEWAY MINIMUM / MAXIMUM WI		65 7M	309 6.7M	CONVEX
GROSS BUILDING FLOOR AREA (OTTAWA ZO				
UG1	m²	ft²		.00 _{SPOT EI}
FLOOR 01 FLOOR 02	4 000	6	4,419 ()	GAS/HY
FLOOR 03-05 1,339.6 m ² x 3	1,339 3 4,018		3,257 REFER	TO LANDSC
FLOOR 06 FLOOR 07	1,224		3,176 TREATM	IENT
FLOOR 08 - FLOOR 28 725.2 m ² x 21	15,229	.2 163	3,926	MINIMUN
TOTAL TYP. FLOOR PLATE	22,443 725		1,582	TYPICA
	120			
		UNIT	S	TYPICAL PA MIN 2.6 x 5.
1B 1B+D			58 82	
2B			77	×.
2B+D 3B			61 31	5200
TOTAL			309	
VEHICULAR PARKING SPACES REQUIRED- A				
VISITOR 0.1 SPACES PER UNIT AFT RESIDENTIAL N/A	TER 12 UNITS - MAX	30 30 0		6700 DRIVE AISLE
TOTAL		30		
VEHICULAR PARKING SPACES PROVIDED				2200
VISITOR 0.1 SPACES PER UNIT (309 RESIDENTIAL 0.56 SPACES PER UNIT (30	/	30 177		
TOTAL		177		
		207		TYPICA
		207 112 319		MIN 3.66 x 5
1.03 PER UNIT (309 UNITS))	112 319		MIN 3.66 x 5
TOTAL 1.03 PER UNIT (309 UNITS) ACCESSIBLE PARKING SPACES REQUIRED -)	112 319		MIN 3.66 x 5
TOTAL 1.03 PER UNIT (309 UNITS) ACCESSIBLE PARKING SPACES REQUIRED - TYPE 'A' TYPE 'B')	112 319 IRFACE PARKI 3 4		MIN 3.66 x 5
TOTAL1.03 PER UNIT (309 UNITS)ACCESSIBLE PARKING SPACES REQUIRED -TYPE 'A'TYPE 'B'TOTAL) (NOT INCLUDING SU	112 319 IRFACE PARKI 3 4 7	NG)	MIN 3.66 x 5
TOTAL 1.03 PER UNIT (309 UNITS) ACCESSIBLE PARKING SPACES REQUIRED - TYPE 'A' TYPE 'B' TOTAL ACCESSIBLE PARKING SPACES PROVIDED -) (NOT INCLUDING SU	112 319 IRFACE PARKI 3 4 7	NG)	MIN 3.66 x 5
TOTAL 1.03 PER UNIT (309 UNITS) ACCESSIBLE PARKING SPACES REQUIRED - TYPE 'A' TYPE 'B' ACCESSIBLE PARKING SPACES PROVIDED - TYPE 'A' TYPE 'A' TYPE 'A' TYPE 'B' TOTAL ACCESSIBLE PARKING SPACES PROVIDED - TYPE 'A' TYPE 'B') (NOT INCLUDING SU	112 319 IRFACE PARKI 3 4 7 IRFACE PARKI 3 5	NG)	MIN 3.66 x 5
TOTAL 1.03 PER UNIT (309 UNITS) ACCESSIBLE PARKING SPACES REQUIRED - TYPE 'A' TYPE 'B' ACCESSIBLE PARKING SPACES PROVIDED - TYPE 'A' TYPE 'A' TYPE 'A' TYPE 'B' TOTAL ACCESSIBLE PARKING SPACES PROVIDED - TYPE 'A' TYPE 'B') (NOT INCLUDING SU	112 319 IRFACE PARKI 3 4 7 IRFACE PARKI 3	NG)	MIN 3.66 x 5
TOTAL 1.03 PER UNIT (309 UNITS) ACCESSIBLE PARKING SPACES REQUIRED - TYPE 'A' TOTAL ACCESSIBLE PARKING SPACES PROVIDED - TYPE 'A' TYPE 'A' TYPE 'A' TYPE 'B' ACCESSIBLE PARKING SPACES PROVIDED - TYPE 'A' TYPE 'B' TYPE 'B' TYPE 'B') (NOT INCLUDING SU	112 319 IRFACE PARKI 3 4 7 IRFACE PARKI 3 5	NG) NG) NG)	MIN 3.66 x 5
TOTAL 1.03 PER UNIT (309 UNITS) ACCESSIBLE PARKING SPACES REQUIRED - TYPE 'A' TOTAL ACCESSIBLE PARKING SPACES PROVIDED - TYPE 'A' TYPE 'A' TYPE 'A' TYPE 'A' STANDARD PARKING SPACE PARALLEL PARKING SPACE) (NOT INCLUDING SU	112 319 IRFACE PARKI 3 4 7 IRFACE PARKI 3 5 8 2.6m X 5. 2.6m X 5.	NG) NG) NG) 2m 7m	MIN 3.66 x 5
TOTAL 1.03 PER UNIT (309 UNITS) ACCESSIBLE PARKING SPACES REQUIRED - TYPE 'A' TYPE 'B' ACCESSIBLE PARKING SPACES PROVIDED - TYPE 'A' TYPE 'A' TYPE 'A' STANDARD PARKING SPACE PARALLEL PARKING SPACE SMALL PARKING SPACE) (NOT INCLUDING SU	112 319 IRFACE PARKI 3 4 7 IRFACE PARKI 3 5 8 8 2.6m X 5.	NG) NG) NG) 2m 7m 6m	MIN 3.66 x 5
TOTAL 1.03 PER UNIT (309 UNITS) ACCESSIBLE PARKING SPACES REQUIRED - TYPE 'A' TYPE 'B' ACCESSIBLE PARKING SPACES PROVIDED - TYPE 'A' TYPE 'B' TOTAL STANDARD PARKING SPACE PARALLEL PARKING SPACE SMALL PARKING SPACE SMALL PARKING SPACE ACCESSIBLE PARKING SPACE ' TYPE A ' ACCESSIBLE PARKING SPACE ' TYPE B ') (NOT INCLUDING SU	112 319 IRFACE PARKI 3 4 7 IRFACE PARKI 3 5 8 2.6m X 5. 2.6m X 5. 2.6m X 6. 2.4m X 4. 3.4m X 5. 2.4m X 5.	NG) NG) NG) 2m 7m 6m 2m 2m	MIN 3.66 x 5
TOTAL 1.03 PER UNIT (309 UNITS) ACCESSIBLE PARKING SPACES REQUIRED - TYPE 'A' TYPE 'B' ACCESSIBLE PARKING SPACES PROVIDED - TYPE 'A' TYPE 'B' ACCESSIBLE PARKING SPACES PROVIDED - TYPE 'A' TYPE 'B' TOTAL STANDARD PARKING SPACE PARALLEL PARKING SPACE SMALL PARKING SPACE SMALL PARKING SPACE ACCESSIBLE PARKING SPACE ' TYPE A ' ACCESSIBLE PARKING SPACE ' TYPE B ' LOADING SPACE) (NOT INCLUDING SU	112 319 IRFACE PARKI 3 4 7 IRFACE PARKI 3 5 8 2.6m X 5. 2.6m X 5. 2.6m X 6. 2.4m X 4. 3.4m X 5.	NG) NG) 2m 7m 6m 2m 2m 2m 2m 2m 2m 2m 2m 2m 2m	MIN 3.66 x 5
TOTAL 1.03 PER UNIT (309 UNITS) ACCESSIBLE PARKING SPACES REQUIRED - TYPE 'A' TYPE 'B' ACCESSIBLE PARKING SPACES PROVIDED - TYPE 'A' TYPE 'B' ACCESSIBLE PARKING SPACES PROVIDED - TYPE 'A' TYPE 'B' TOTAL STANDARD PARKING SPACE PARALLEL PARKING SPACE SMALL PARKING SPACE SMALL PARKING SPACE ACCESSIBLE PARKING SPACE ' TYPE A ' ACCESSIBLE PARKING SPACE ' TYPE A ' ACCESSIBLE PARKING SPACE ' TYPE B ' LOADING SPACE BICYCLE PARKING SPACES REQUIRED RESIDENTIAL 0.5 PER UNIT (309 UNITS)) (NOT INCLUDING SU	112 319 IRFACE PARKI 3 4 7 IRFACE PARKI 3 5 8 2.6m X 5. 2.6m X 5. 2.6m X 6. 2.4m X 4. 3.4m X 5. 2.4m X 5. 3.5m X 7.	NG) NG) 2m 7m 6m 2m 2m 2m 2m 2m 2m 2m 2m 2m 2m	MIN 3.66 x 5
TOTAL 1.03 PER UNIT (309 UNITS) ACCESSIBLE PARKING SPACES REQUIRED - TYPE 'A' TOTAL ACCESSIBLE PARKING SPACES PROVIDED - TYPE 'A' TYPE 'A' TYPE 'A' TYPE 'A' TYPE 'A' TYPE 'A' TYPE 'B' TOTAL STANDARD PARKING SPACES PROVIDED - TYPE 'B' TOTAL STANDARD PARKING SPACE PARALLEL PARKING SPACE SMALL PARKING SPACE SMALL PARKING SPACE ACCESSIBLE PARKING SPACE ' TYPE A ' ACCESSIBLE PARKING SPACE ' TYPE A ' ACCESSIBLE PARKING SPACE ' TYPE B ' LOADING SPACE BICYCLE PARKING SPACES REQUIRED RESIDENTIAL 0.5 PER UNIT (309 UNITS) TOTAL) (NOT INCLUDING SU	112 319 IRFACE PARKI 3 4 7 IRFACE PARKI 3 5 8 2.6m X 5. 2.6m X 5. 2.6m X 6. 2.4m X 4. 3.4m X 5. 2.4m X 5. 3.5m X 7.	NG) NG) 2m 7m 6m 2m 2m 2m 2m 2m 2m 2m 2m 2m 2m	MIN 3.66 x 5
TOTAL 1.03 PER UNIT (309 UNITS) ACCESSIBLE PARKING SPACES REQUIRED - TYPE 'A' TYPE 'B' ACCESSIBLE PARKING SPACES PROVIDED - TYPE 'A' TYPE 'B' ACCESSIBLE PARKING SPACES PROVIDED - TYPE 'A' TYPE 'B' TOTAL STANDARD PARKING SPACE PARALLEL PARKING SPACE SMALL PARKING SPACE SMALL PARKING SPACE ACCESSIBLE PARKING SPACE ' TYPE A ' ACCESSIBLE PARKING SPACE ' TYPE B ' LOADING SPACE BICYCLE PARKING SPACES REQUIRED BICYCLE PARKING SPACES PROVIDED) (NOT INCLUDING SU	112 319 IRFACE PARKI 3 4 7 IRFACE PARKI 3 5 8 2.6m X 5. 2.6m X 5. 2.6m X 6. 2.4m X 4. 3.4m X 5. 2.4m X 5. 3.5m X 7.	NG) NG) 2m 7m 6m 2m 2m 2m 0m 2m 2m 0m 2 2 2024-1 1 2024-0 # DA	MIN 3.66 x 5
TOTAL 1.03 PER UNIT (309 UNITS) ACCESSIBLE PARKING SPACES REQUIRED - TYPE 'A' TYPE 'B' ACCESSIBLE PARKING SPACES PROVIDED - TYPE 'A' TYPE 'A' TYPE 'A' TYPE 'A' TYPE 'A' TYPE 'B' TOTAL STANDARD PARKING SPACES PROVIDED - TYPE 'B' TOTAL STANDARD PARKING SPACE PARALLEL PARKING SPACE SMALL PARKING SPACE SMALL PARKING SPACE SMALL PARKING SPACE SIBLE PARKING SPACE ' TYPE A ' ACCESSIBLE PARKING SPACE ' TYPE B ' LOADING SPACE BICYCLE PARKING SPACES REQUIRED RESIDENTIAL 0.5 PER UNIT (309 UNITS) TOTAL BICYCLE PARKING SPACES PROVIDED RESIDENTIAL INTERIOR EXTERIOR) (NOT INCLUDING SU	112 319 IRFACE PARKI 3 4 7 IRFACE PARKI 3 5 8 2.6m X 5. 2.6m X 5. 2.6m X 6. 2.4m X 4. 3.4m X 5. 2.4m X 5. 3.5m X 7. 155 155 309 0	NG) NG) 2m 7m 6m 2m 2m 2m 0m 2m 2m 0m 2 2 2024-1 1 2024-0 # DA	MIN 3.66 x 5
TOTAL 1.03 PER UNIT (309 UNITS) ACCESSIBLE PARKING SPACES REQUIRED - TYPE 'A' TOTAL ACCESSIBLE PARKING SPACES PROVIDED - TYPE 'A' TYPE 'A' TYPE 'A' TYPE 'A' TYPE 'A' TYPE 'B' TOTAL ACCESSIBLE PARKING SPACES PROVIDED - TYPE 'B' TOTAL STANDARD PARKING SPACE PARALLEL PARKING SPACE SMALL PARKING SPACE SMALL PARKING SPACE SMALL PARKING SPACE SIBLE PARKING SPACE ' TYPE A ' ACCESSIBLE PARKING SPACE ' TYPE B ' LOADING SPACE BICYCLE PARKING SPACES REQUIRED RESIDENTIAL 0.5 PER UNIT (309 UNITS) TOTAL BICYCLE PARKING SPACES PROVIDED RESIDENTIAL INTERIOR EXTERIOR) (NOT INCLUDING SU	112 319 IRFACE PARKI 3 4 7 IRFACE PARKI 3 5 8 2.6m X 5. 2.6m X 5. 2.6m X 6. 2.4m X 4. 3.4m X 5. 2.4m X 5. 3.5m X 7. 155 155	NG) NG) 2m 7m 6m 2m 2m 2m 0m 2m 2m 0m 2 2 2024-1 1 2024-0 # DA	MIN 3.66 x 5
TOTAL 1.03 PER UNIT (309 UNITS) ACCESSIBLE PARKING SPACES REQUIRED - TYPE 'A' TYPE 'B' ACCESSIBLE PARKING SPACES PROVIDED - TYPE 'A' TYPE 'B' ACCESSIBLE PARKING SPACES PROVIDED - TYPE 'B' TOTAL STANDARD PARKING SPACE PARALLEL PARKING SPACE SMALL PARKING SPACE SMALL PARKING SPACE SMALL PARKING SPACE SIBLE PARKING SPACE SIBLE PARKING SPACE SIBLE PARKING SPACE SIBLE PARKING SPACE SIGYCLE PARKING SPACES REQUIRED RESIDENTIAL 0.5 PER UNIT (309 UNITS) TOTAL INTERIOR EXTERIOR EXTERIOR TOTAL 1.0 PER UNIT (309 UNITS)) (NOT INCLUDING SU	112 319 IRFACE PARKI 3 4 7 IRFACE PARKI 3 5 8 2.6m X 5. 2.6m X 5. 2.6m X 6. 2.4m X 4. 3.4m X 5. 2.4m X 5. 3.5m X 7. 155 155 309 0	NG) NG) 2m 7m 6m 2m 2m 0m 2m 2m 0m 2 2 2 2024-1 1 2024-0 # DA	MIN 3.66 x 5
TOTAL 1.03 PER UNIT (309 UNITS) ACCESSIBLE PARKING SPACES REQUIRED - TYPE 'A' TYPE 'B' ACCESSIBLE PARKING SPACES PROVIDED - TYPE 'A' TYPE 'B' TOTAL ACCESSIBLE PARKING SPACES PROVIDED - TYPE 'A' TYPE 'B' TOTAL STANDARD PARKING SPACE PARALLEL PARKING SPACE SMALL PARKING SPACE SMALL PARKING SPACE SMALL PARKING SPACE ACCESSIBLE PARKING SPACE ' TYPE A ' ACCESSIBLE PARKING SPACE ' TYPE A ' ACCESSIBLE PARKING SPACE ' TYPE B ' LOADING SPACE BICYCLE PARKING SPACES REQUIRED RESIDENTIAL 0.5 PER UNIT (309 UNITS) TOTAL BICYCLE PARKING SPACES PROVIDED RESIDENTIAL INTERIOR EXTERIOR TOTAL 1.0 PER UNIT (309 UNITS)) (NOT INCLUDING SU (NOT INCLUDING SU INCLUDING SU INC	112 319 IRFACE PARKI 3 4 7 IRFACE PARKI 3 5 8 2.6m X 5. 2.6m X 6. 2.4m X 4. 3.4m X 5. 2.4m X 5. 2.4m X 5. 3.5m X 7. 155 155 309 0 309	NG) NG) 2m 7m 6m 2m 2m 0m 2 2024-1 1 2024-0 # DA	MIN 3.66 x 5
TOTAL 1.03 PER UNIT (309 UNITS) ACCESSIBLE PARKING SPACES REQUIRED - TYPE 'A' TYPE 'B' ACCESSIBLE PARKING SPACES PROVIDED - TYPE 'A' TYPE 'B' ACCESSIBLE PARKING SPACES PROVIDED - TYPE 'B' TOTAL STANDARD PARKING SPACE PARALLEL PARKING SPACE SMALL PARKING SPACE SMALL PARKING SPACE SMALL PARKING SPACE STANDARD PARKING SPACE BICYCLE PARKING SPACE BICYCLE PARKING SPACES REQUIRED RESIDENTIAL 0.5 PER UNIT (309 UNITS) TOTAL BICYCLE PARKING SPACES PROVIDED RESIDENTIAL 1.0 PER UNIT (309 UNITS) AMENITY AREA GRADE EXTERIOR - COMMUNAL) (NOT INCLUDING SU (NOT INCLUDING SU INCLUDING SU INC	112 319 IRFACE PARKI 3 4 7 IRFACE PARKI 3 5 8 2.6m X 5. 2.6m X 6. 2.4m X 4. 3.4m X 5. 2.4m X 5. 2.4m X 5. 3.5m X 7. 155 155 309 0 309 0 309	NG) NG) 2m 7m 6m 2m 2m 0m 2 2024-1 1 2024-0 # DA 0m 1,858	MIN 3.66 x 5
TOTAL 1.03 PER UNIT (309 UNITS) ACCESSIBLE PARKING SPACES REQUIRED - TYPE 'A' TYPE 'B' ACCESSIBLE PARKING SPACES PROVIDED - TYPE 'A' TYPE 'B' ACCESSIBLE PARKING SPACES PROVIDED - TYPE 'A' TYPE 'B' TOTAL ACCESSIBLE PARKING SPACE PARALLEL PARKING SPACE SMALL PARKING SPACE SMALL PARKING SPACE SMALL PARKING SPACE SIGUESIBLE PARKING SPACE ' TYPE A ' ACCESSIBLE PARKING SPACE ' TYPE A ' ACCESSIBLE PARKING SPACE ' TYPE B ' LOADING SPACE BICYCLE PARKING SPACES REQUIRED RESIDENTIAL 0.5 PER UNIT (309 UNITS) TOTAL 1.0 PER UNIT (309 UNITS) AMENITY AREA AMENITY AREA GRADE EXTERIOR - COMMUNAL 07F EXTERIOR - COMMUNAL) (NOT INCLUDING SU (NOT INCLUDING SU (NOT INCLUDING SU 1000 100 1000 1	112 319 IRFACE PARKI 3 4 7 IRFACE PARKI 3 4 7 IRFACE PARKI 3 5 8 2.6m X 5. 2.6m X 6. 2.4m X 4. 3.4m X 5. 2.4m X 5. 3.5m X 7. 155 155 309 0 309 0 309 0 309 1 1	NG) NG) 2m 7m 6m 2m 2m 0m 2 2024-1 1 2024-0 # DA 1 2024-0 # DA 1 2024-0 # DA	MIN 3.66 x 5
TOTAL 1.03 PER UNIT (309 UNITS) ACCESSIBLE PARKING SPACES REQUIRED - TYPE 'A' TYPE 'B' ACCESSIBLE PARKING SPACES PROVIDED - TYPE 'A' TYPE 'B' TOTAL ACCESSIBLE PARKING SPACES PROVIDED - TYPE 'A' TYPE 'B' TOTAL STANDARD PARKING SPACE PARALLEL PARKING SPACE SMALL PARKING SPACE SMALL PARKING SPACE SMALL PARKING SPACE SIDARDING SPACE BICYCLE PARKING SPACES REQUIRED RESIDENTIAL 0.5 PER UNIT (309 UNITS) TOTAL BICYCLE PARKING SPACES PROVIDED RESIDENTIAL INTERIOR EXTERIOR TOTAL BICYCLE PARKING SPACES PROVIDED RESIDENTIAL INTERIOR GRADE EXTERIOR - COMMUNAL INTERIOR - COMMUNAL O7F EXTERIOR - COMMUNAL TOTAL COMMUNAL) (NOT INCLUDING SU (NOT INCLUDING SU (NOT INCLUDING SU) (NOT INCLUDING SU)) (NOT INCLUDING SU)) (NOT INCLUDING SU)))))))))))))	112 319 URFACE PARKI 3 4 7 URFACE PARKI 3 2.6m X 5. 2.6m X 5. 2.6m X 6. 2.4m X 4. 3.4m X 5. 2.4m X 5. 3.5m X 7. 155 155 309 0 309 0 309 0 309 0 309	NG) NG) 2m 7m 6m 2m 2m 2m 0m 2 2024-1 1 2024-0 # DA PROJECT 1,858 1,791 2,175 5,824 7,741	MIN 3.66 x 5
TOTAL 1.03 PER UNIT (309 UNITS) ACCESSIBLE PARKING SPACES REQUIRED - TYPE 'A' TYPE 'B' ACCESSIBLE PARKING SPACES PROVIDED - TYPE 'A' TYPE 'B' TOTAL ACCESSIBLE PARKING SPACES PROVIDED - TYPE 'A' TYPE 'B' TOTAL STANDARD PARKING SPACE PARALLEL PARKING SPACE SMALL PARKING SPACE SMALL PARKING SPACE SMALL PARKING SPACE STANDARD PARKING SPACE STANDARD PARKING SPACE BICYCLE PARKING SPACE BICYCLE PARKING SPACES REQUIRED RESIDENTIAL 0.5 PER UNIT (309 UNITS) TOTAL 1.0 PER UNIT (309 UNITS) RESIDENTIAL INTERIOR EXTERIOR 1.0 PER UNIT (309 UNITS) AMENITY AREA AMENITY AREA GRADE EXTERIOR - COMMUNAL 07F EXTERIOR - COMMUNAL D7F EXTERIOR - COMMUNAL 07F EXTERIOR - COMMUNAL BALCONIES / TERRACE - PRIVATE DIVATE) (NOT INCLUDING SU (NOT INCLUDING SU (NOT INCLUDING SU	112 319 IRFACE PARKI 3 4 7 IRFACE PARKI 3 4 7 IRFACE PARKI 3 2.6m X 5. 2.6m X 5. 2.6m X 6. 2.4m X 4. 3.4m X 5. 2.4m X 5. 3.5m X 7. 155 309 0 309 0 309 0 309 1 2 37	NG) NG) 2m 7m 6m 2m 2m 0m 2 2024-1 1 2024-0 # DA 0m 2 2024-1 1 2024-0 # DA 1,858 1,791 2,175 5,824	MIN 3.66 x 5
TOTAL 1.03 PER UNIT (309 UNITS) ACCESSIBLE PARKING SPACES REQUIRED - TYPE 'A' TOTAL ACCESSIBLE PARKING SPACES PROVIDED - TYPE 'A' TYPE 'B' TOTAL ACCESSIBLE PARKING SPACES PROVIDED - TYPE 'B' TOTAL STANDARD PARKING SPACE PARALLEL PARKING SPACE SMALL PARKING SPACE SMALL PARKING SPACE ACCESSIBLE PARKING SPACE ' TYPE A ' ACCESSIBLE PARKING SPACE ' TYPE A ' ACCESSIBLE PARKING SPACE ' TYPE B ' LOADING SPACE BICYCLE PARKING SPACES REQUIRED RESIDENTIAL 0.5 PER UNIT (309 UNITS) TOTAL 1.0 PER UNIT (309 UNITS) AMENITY AREA EXTERIOR GRADE EXTERIOR - COMMUNAL 07F EXTERIOR - COMMUNAL 07F EXTERIOR - COMMUNAL 07F EXTERIOR - COMMUNAL BALCONIES / TERRACE - PRIVATE TOTAL REQUIRED (309 UNITS X 6 m²) = 1,854 sq. m.) (NOT INCLUDING SU (NOT INCLUDING SU (NOT INCLUDING SU	112 319 IRFACE PARKI 3 4 7 IRFACE PARKI 3 4 7 IRFACE PARKI 3 2.6m X 5. 2.6m X 5. 2.6m X 6. 2.4m X 4. 3.4m X 5. 2.4m X 5. 3.5m X 7. 155 309 0 309 0 309 0 309 1 2 37	NG) NG) 2m 7m 6m 2m 2m 0m 2 2024-1 1 2024-0 # DA 0m 2 2024-1 1 2024-0 # DA 0 PROJECT 1,858 1,791 2,175 5,824 7,741 B,565 DRAWING	MIN 3.66 x 5
TOTAL 1.03 PER UNIT (309 UNITS) ACCESSIBLE PARKING SPACES REQUIRED - TYPE 'A' TYPE 'B' TOTAL ACCESSIBLE PARKING SPACES PROVIDED - TYPE 'A' TYPE 'B' TOTAL ACCESSIBLE PARKING SPACES PROVIDED - TYPE 'B' TOTAL STANDARD PARKING SPACE PARALLEL PARKING SPACE SMALL PARKING SPACE SMALL PARKING SPACE ACCESSIBLE PARKING SPACE ' TYPE A ' ACCESSIBLE PARKING SPACE ' TYPE B ' LOADING SPACE BICYCLE PARKING SPACES REQUIRED RESIDENTIAL 0.5 PER UNIT (309 UNITS) TOTAL BICYCLE PARKING SPACES PROVIDED RESIDENTIAL INTERIOR EXTERIOR TOTAL BICYCLE PARKING SPACES PROVIDED RESIDENTIAL INTERIOR GRADE EXTERIOR - COMMUNAL OTF EXTERIOR - COMMUNAL OTF EXTERIOR - COMMUNAL BALCONIES / TERRACE - PRIVATE TOTAL REQUIRED (309 UNITS X 6 m²) = 1,854 sq. m.) (NOT INCLUDING SU (NOT INCLUDING SU (NOT INCLUDING SU	112 319 IRFACE PARKI 3 4 7 IRFACE PARKI 3 4 7 IRFACE PARKI 3 2.6m X 5. 2.6m X 5. 2.6m X 6. 2.4m X 4. 3.4m X 5. 2.4m X 5. 3.5m X 7. 155 309 0 309 0 309 0 309 1 2 37	NG) NG) 2m 7m 6m 2m 2m 0m 2 2024-1 1 2024-0 # DA 0m 2 2024-1 1 2024-0 # DA 0 PROJECT 1,858 1,791 2,175 5,824 7,741 B,565 DRAWING	MIN 3.66 x 5
TOTAL 1.03 PER UNIT (309 UNITS) ACCESSIBLE PARKING SPACES REQUIRED - TYPE 'A' TYPE 'B' TOTAL ACCESSIBLE PARKING SPACES PROVIDED - TYPE 'A' TYPE 'B' TYPE 'B' TOTAL STANDARD PARKING SPACE PARALLEL PARKING SPACE SMALL PARKING SPACE SMALL PARKING SPACE SMALL PARKING SPACE SIGYCLE PARKING SPACE BICYCLE PARKING SPACES REQUIRED RESIDENTIAL 0.5 PER UNIT (309 UNITS) TOTAL BICYCLE PARKING SPACES PROVIDED RESIDENTIAL INTERIOR EXTERIOR GRADE EXTERIOR - COMMUNAL INTERIOR - COMMUNAL O7F EXTERIOR - COMMUNAL BALCONIES / TERRACE - PRIVATE TOTAL REQUIRED (309 UNITS X 6 m²) = 1,854 sq. m. REQUIRED COMMUNAL @ 50% = 927 sq. m.) (NOT INCLUDING SU (NOT INCLUDING SU (NOT INCLUDING SU	112 319 IRFACE PARKI 3 4 7 IRFACE PARKI 3 4 7 IRFACE PARKI 3 2.6m X 5. 2.6m X 5. 2.6m X 6. 2.4m X 4. 3.4m X 5. 2.4m X 5. 3.5m X 7. 155 309 0 309 0 309 0 309 1 2 37	NG) NG) 2m 7m 6m 2m 2m 0m 2 2024-1 1 2024-0 # DA 0m 2 2024-1 1 2024-0 # DA 0 PROJECT 1,858 1,791 2,175 5,824 7,741 B,565 DRAWING	MIN 3.66 x 5
TOTAL 1.03 PER UNIT (309 UNITS) ACCESSIBLE PARKING SPACES REQUIRED - TYPE 'A' TYPE 'B' TOTAL ACCESSIBLE PARKING SPACES PROVIDED - TYPE 'A' TYPE 'B' TOTAL ACCESSIBLE PARKING SPACES PROVIDED - TYPE 'A' TYPE 'B' TOTAL STANDARD PARKING SPACE PARALLEL PARKING SPACE SMALL PARKING SPACE SMALL PARKING SPACE SMALL PARKING SPACE SIBLE PARKING SPACE ' TYPE A ' ACCESSIBLE PARKING SPACE ' TYPE B ' LOADING SPACE BICYCLE PARKING SPACES REQUIRED RESIDENTIAL 0.5 PER UNIT (309 UNITS) TOTAL 0.5 PER UNIT (309 UNITS) TOTAL 1.0 PER UNIT (309 UNITS) AMENITY AREA EXTERIOR GRADE EXTERIOR - COMMUNAL 07F EXTERIOR - COMMUNAL 07F EXTERIOR - COMMUNAL 07F EXTERIOR - COMMUNAL BALCONIES / TERRACE - PRIVATE TOTAL REQUIRED (309 UNITS X 6 m²) = 1,854 sq. m. REQUIRED COMMUNAL @ 50% = 927 sq. m.) (NOT INCLUDING SU (NOT INCLUDING SU (NOT INCLUDING SU 1 1 1 1 1 1 1 1 1 1 1 1 1	112 319 IRFACE PARKI 3 4 7 IRFACE PARKI 3 5 8 2.6m X 5. 2.6m X 6. 2.4m X 4. 3.4m X 5. 2.6m X 5. 2.6m X 6. 2.4m X 4. 3.4m X 5. 2.4m X 5. 3.5m X 7. 155 155 155 309 0 0 309 0 0 0 0 0 0 0 0 0 0 0 0 0	NG) NG) 2m 7m 6m 2m 2m 0m 2 2024-1 1 2024-0 # DA 0m 2 2024-1 1 2024-0 # DA 0m 2 2024-1 1 2024-0 # DA 0 0 0 0 0 0 0 0 0 0 0 0 0	MIN 3.66 x 5 0 0 0 0 0 0 0 0 0 0 0 0 0
TOTAL 1.03 PER UNIT (309 UNITS) ACCESSIBLE PARKING SPACES REQUIRED - TYPE 'A' TYPE 'B' ACCESSIBLE PARKING SPACES PROVIDED - TYPE 'A' TYPE 'B' TOTAL ACCESSIBLE PARKING SPACES PROVIDED - TYPE 'A' TYPE 'B' TOTAL STANDARD PARKING SPACE PARALLEL PARKING SPACE SMALL PARKING SPACE SMALL PARKING SPACE SMALL PARKING SPACE SIBLE PARKING SPACE ' TYPE A ' ACCESSIBLE PARKING SPACE ' TYPE B ' LOADING SPACE BICYCLE PARKING SPACES REQUIRED RESIDENTIAL 0.5 PER UNIT (309 UNITS) TOTAL 0.5 PER UNIT (309 UNITS) TOTAL 1.0 PER UNIT (309 UNITS) AMENITY AREA EXTERIOR GRADE EXTERIOR - COMMUNAL INTERIOR - COMMUNAL INTERIOR - COMMUNAL OTF EXTERIOR - COMMUNAL TOTAL BALCONIES / TERRACE - PRIVATE TOTAL REQUIRED (309 UNITS X 6 m²) = 1,854 sq. m. REQUIRED COMMUNAL @ 50% = 927 sq. m. SITE COVERAGE) (NOT INCLUDING SU (NOT INCLUDING SU (NOT INCLUDING SU 1 1 1 1 1 1 1 1 1 1 1 1 1	112 319 IRFACE PARKI 3 4 7 IRFACE PARKI 3 5 8 2.6m X 5. 2.6m X 6. 2.4m X 4. 3.4m X 5. 2.4m X 5. 3.5m X 7. 155 155 155 155 309 0 309 10 10 10 10 10 10 10 10 10 10	NG) NG) 2m 7m 6m 2m 2m 0m 2 2024-1 1 2024-0 # DA 0m 2 2024-1 1 2024-0 # DA 0m 2 2024-1 1 2024-0 # DA 0 0 1 2024-0 # DA 0 0 1 2024-0 # DA 0 0 1 2024-1 1 2024-0 # DA 0 0 0 0 0 0 0 0 0 0 0 0 0	MIN 3.66 x 5
TOTAL 1.03 PER UNIT (309 UNITS) ACCESSIBLE PARKING SPACES REQUIRED - TYPE 'A' TYPE 'B' ACCESSIBLE PARKING SPACES PROVIDED - TYPE 'A' TYPE 'B' TOTAL ACCESSIBLE PARKING SPACES PROVIDED - TYPE 'B' TOTAL STANDARD PARKING SPACE PARALLEL PARKING SPACE SMALL PARKING SPACE SMALL PARKING SPACE SMALL PARKING SPACE SIDENTIAL 0.5 PER UNIT (309 UNITS) TOTAL BICYCLE PARKING SPACES REQUIRED RESIDENTIAL 0.5 PER UNIT (309 UNITS) TOTAL 1.0 PER UNIT (309 UNITS) TOTAL 1.0 PER UNIT (309 UNITS) AMENITY AREA EXTERIOR GRADE EXTERIOR - COMMUNAL 1.0 PER UNIT (309 UNITS) AMENITY AREA INTERIOR - COMMUNAL 07F EXTERIOR - COMMUNAL 07F EXTERIOR - COMMUNAL BALCONIES / TERRACE - PRIVATE TOTAL REQUIRED (309 UNITS X 6 m²) = 1,854 sq. m. REQUIRED COMMUNAL @ 50% = 927 sq. m. SITE COVERAGE BUILDING FOOTPRINT DRIVING SURFACE LANDSCAPE AREA <td>) (NOT INCLUDING SU (NOT INCLUDING SU (NOT INCLUDING SU 1000</td> <td>$\begin{array}{c ccccccccccccccccccccccccccccccccccc$</td> <td>NG) NG) 2m 7m 6m 2m 2m 7m 6m 2m 2m 0m 2 2024-1 1 2024-0 # DA PROJECT 1,858 1,791 2,175 5,824 7,741 B,565 PROJECT 4.1% 3,7% 2024-05 PROJECT</td> <td>MIN 3.66 x 5</td>) (NOT INCLUDING SU (NOT INCLUDING SU (NOT INCLUDING SU 1000	$ \begin{array}{c ccccccccccccccccccccccccccccccccccc$	NG) NG) 2m 7m 6m 2m 2m 7m 6m 2m 2m 0m 2 2024-1 1 2024-0 # DA PROJECT 1,858 1,791 2,175 5,824 7,741 B,565 PROJECT 4.1% 3,7% 2024-05 PROJECT	MIN 3.66 x 5
TOTAL 1.03 PER UNIT (309 UNITS) ACCESSIBLE PARKING SPACES REQUIRED - TYPE 'A' TYPE 'B' ACCESSIBLE PARKING SPACES PROVIDED - TYPE 'A' TYPE 'B' ACCESSIBLE PARKING SPACES PROVIDED - TYPE 'A' TYPE 'B' TOTAL ACCESSIBLE PARKING SPACE SMALL PARKING SPACE BICYCLE PARKING SPACE ' TYPE A ' ACCESSIBLE PARKING SPACE SEQUIRED RESIDENTIAL 0.5 PER UNIT (309 UNITS) TOTAL 0.5 PER UNIT (309 UNITS) TOTAL 1.0 PER UNIT (309 UNITS) AMENITY AREA EXTERIOR GRADE EXTERIOR - COMMUNAL INTERIOR INTERIOR - COMMUNAL 07F EXTERIOR - COMMUNAL OTF EXTERIOR - COMMUNAL DALCONIES / TERRACE - PRIVATE TOTAL 1.0 PER UNIT (309 UNITS) AMENITY AREA EQUIRED (309 UNITS X 6 m²) = 1,854 sq. m. REQUIRED COMMUNAL @ 50% = 927 sq. m. SITE COVERAGE BUILDING FOOTPRINT DRIVING SURFACE) (NOT INCLUDING SU (NOT INCLUDING SU (NOT INCLUDING SU 1 1 1 1 1 1 1 1 1 1 1 1 1	$ \begin{array}{c ccccccccccccccccccccccccccccccccccc$	NG) NG) 2m 7m 6m 2m 2m 7m 6m 2m 2m 0m 2 2024-1 1 2024-0 # D PROJECT 1,858 1,791 2,175 5,824 7,741 3,565 PROJECT 18.050 SIT PROJECT 18.050 RYT / D	MIN 3.66 x 5
TOTAL 1.03 PER UNIT (309 UNITS) ACCESSIBLE PARKING SPACES REQUIRED - TYPE 'A' TYPE 'B' ACCESSIBLE PARKING SPACES PROVIDED - TYPE 'A' TYPE 'B' TOTAL ACCESSIBLE PARKING SPACES PROVIDED - TYPE 'A' TYPE 'B' TOTAL ACCESSIBLE PARKING SPACE SMALL PARKING SPACE SMALL PARKING SPACE SMALL PARKING SPACE SMALL PARKING SPACE SIBLE PARKING SPACE ' TYPE A ' ACCESSIBLE PARKING SPACE SEQUIRED RESIDENTIAL 0.5 PER UNIT (309 UNITS) TOTAL 0.5 PER UNIT (309 UNITS) TOTAL 1.0 PER UNIT (309 UNITS) AMENITY AREA EXTERIOR GRADE EXTERIOR - COMMUNAL 1.0 PER UNIT (309 UNITS) AMENITY AREA INTERIOR - COMMUNAL D7F EXTERIOR - COMMUNAL D7F EXTERIOR - COMMUNAL BALCONIES / TERRACE - PRIVATE TOTAL REQUIRED (309 UNITS X 6 m²) = 1,854 sq. m. REQUIRED COMMUNAL @ 50% = 927 sq. m. SITE COVERAGE EANDSCAPE AREA TOTAL BUILDING A) (NOT INCLUDING SU (NOT INCLUDING SU (NOT INCLUDING SU 1000	$ \begin{array}{c} 112\\319\\ \hline \\ $	NG) NG) 2m 7m 6m 2m 2m 7m 6m 2m 2m 0m 2 2024.1 1 2024.0 # DA PROJECT 1,858 1,791 2,175 5,824 7,741 3,565 PROJECT 18.050 SIT PROJECT 18.050 PROJECT 10.050 PROJECT	MIN 3.66 x 5
TOTAL 1.03 PER UNIT (309 UNITS) ACCESSIBLE PARKING SPACES REQUIRED - TYPE 'A' TOTAL ACCESSIBLE PARKING SPACES PROVIDED - TYPE 'A' TYPE 'B' TOTAL ACCESSIBLE PARKING SPACE PARALLEL PARKING SPACE PARALLEL PARKING SPACE SMALL PARKING SPACE SMALL PARKING SPACE SMALL PARKING SPACE SIDE PARKING SPACE SIDE PARKING SPACE ' TYPE B ' LOADING SPACE BICYCLE PARKING SPACES REQUIRED RESIDENTIAL 0.5 PER UNIT (309 UNITS) TOTAL 0.5 PER UNIT (309 UNITS) TOTAL 1.0 PER UNIT (309 UNITS) AMENITY AREA EXTERIOR GRADE EXTERIOR - COMMUNAL INTERIOR - COMMUNAL INTERIOR - COMMUNAL 07F EXTERIOR - COMMUNAL OTFAL 1.0 PER UNIT (309 UNITS) AMENITY AREA INTERIOR - COMMUNAL BALCONIES / TERRACE - PRIVATE INTERIOR BALCONIES / TERRACE - PRIVATE INTERIOR BALCONIES / TERRACE - PRIVATE INTERIOR BUILDING FOOTPRINT DRIVING SURFACE LA) (NOT INCLUDING SU (NOT INCLUDING SU (NOT INCLUDING SU 1000	112 319 IRFACE PARKI 3 4 7 IRFACE PARKI 3 5 8 2.6m X 5. 2.6m X 6. 2.4m X 4. 3.4m X 5. 2.4m X 5. 2.4m X 5. 3.5m X 7. 155 155 155 155 309 0 0 309 0 0 309 0 0 0 0 0 0 0 0 0 0 0 0 0	NG) NG) 2m 7m 6m 2m 2m 7m 6m 2m 2m 7m 6m 2m 2m 7m 6m 2m 2m 7m 6m 2m 2m 7m 6m 2m 2m 7m 6m 2m 2m 7m 6m 2m 2m 7m 6m 2m 2m 7m 6m 2m 2m 7m 6m 2m 2m 7m 6m 2m 2m 7m 6m 2m 2m 7m 6m 2m 7m 6m 2m 7m 6m 2m 7m 6m 2m 7m 6m 2m 7m 6m 2m 7m 6m 2m 7m 6m 2m 7m 7m 6m 2m 7m 7m 6m 2m 7m 7m 7m 7m 7m 7m 7m 7m 7m 7	MIN 3.66 x 5
ACCESSIBLE PARKING SPACES REQUIRED - TYPE 'A' TYPE 'B' ACCESSIBLE PARKING SPACES PROVIDED - TYPE 'A' TYPE 'B' TOTAL STANDARD PARKING SPACE PARALLEL PARKING SPACE SMALL PARKING SPACE SMALL PARKING SPACE ACCESSIBLE PARKING SPACE ' TYPE A ' ACCESSIBLE PARKING SPACE ' TYPE A ' ACCESSIBLE PARKING SPACE ' TYPE B ' LOADING SPACE BICYCLE PARKING SPACES REQUIRED RESIDENTIAL 0.5 PER UNIT (309 UNITS) TOTAL BICYCLE PARKING SPACES PROVIDED RESIDENTIAL INTERIOR EXTERIOR) (NOT INCLUDING SU (NOT INCLUDING SU (NOT INCLUDING SU 1000	112 319 IRFACE PARKI 3 4 7 IRFACE PARKI 3 4 7 IRFACE PARKI 3 5 2.6m X 5. 2.6m X 6. 2.4m X 4. 3.4m X 5. 2.4m X 5. 3.5m X 7. 155 309 0 309 0 309 0 309 0 309 0 309 0 309 0 309 0 309 0 309 0 309 0 309 0 309 0 CO CUBIC YA T T 0 CUBIC YA 1 <	NG) NG) 2m 7m 6m 2m 2m 7m 6m 2m 2m 2m 0m 2 2024-1 1 2024-0 # DA 0m 2 2024-1 1 2024-0 # DA 0m 2 2024-1 1 2024-0 # DA 0m 2 2024-1 1 2024-0 # DA 0 0 0 0 0 0 0 0 0 0 0 0 0	1-01 ISSUED 3400 TYPE 3400 TYPE 1-01 ISSUED 1-01 ISSUED 1-01 ISSUED 1-01 ISSUED 1-01 ISSUED 1-01 ISSUED 500 <t< td=""></t<>

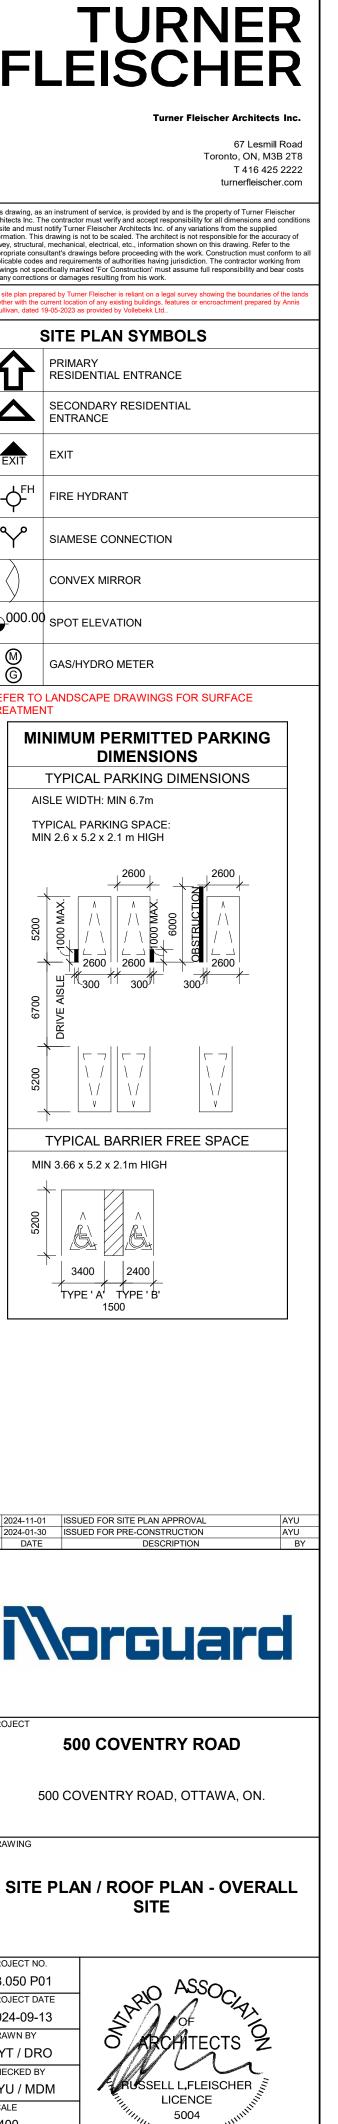

DRAWING NO. SPA005B 2

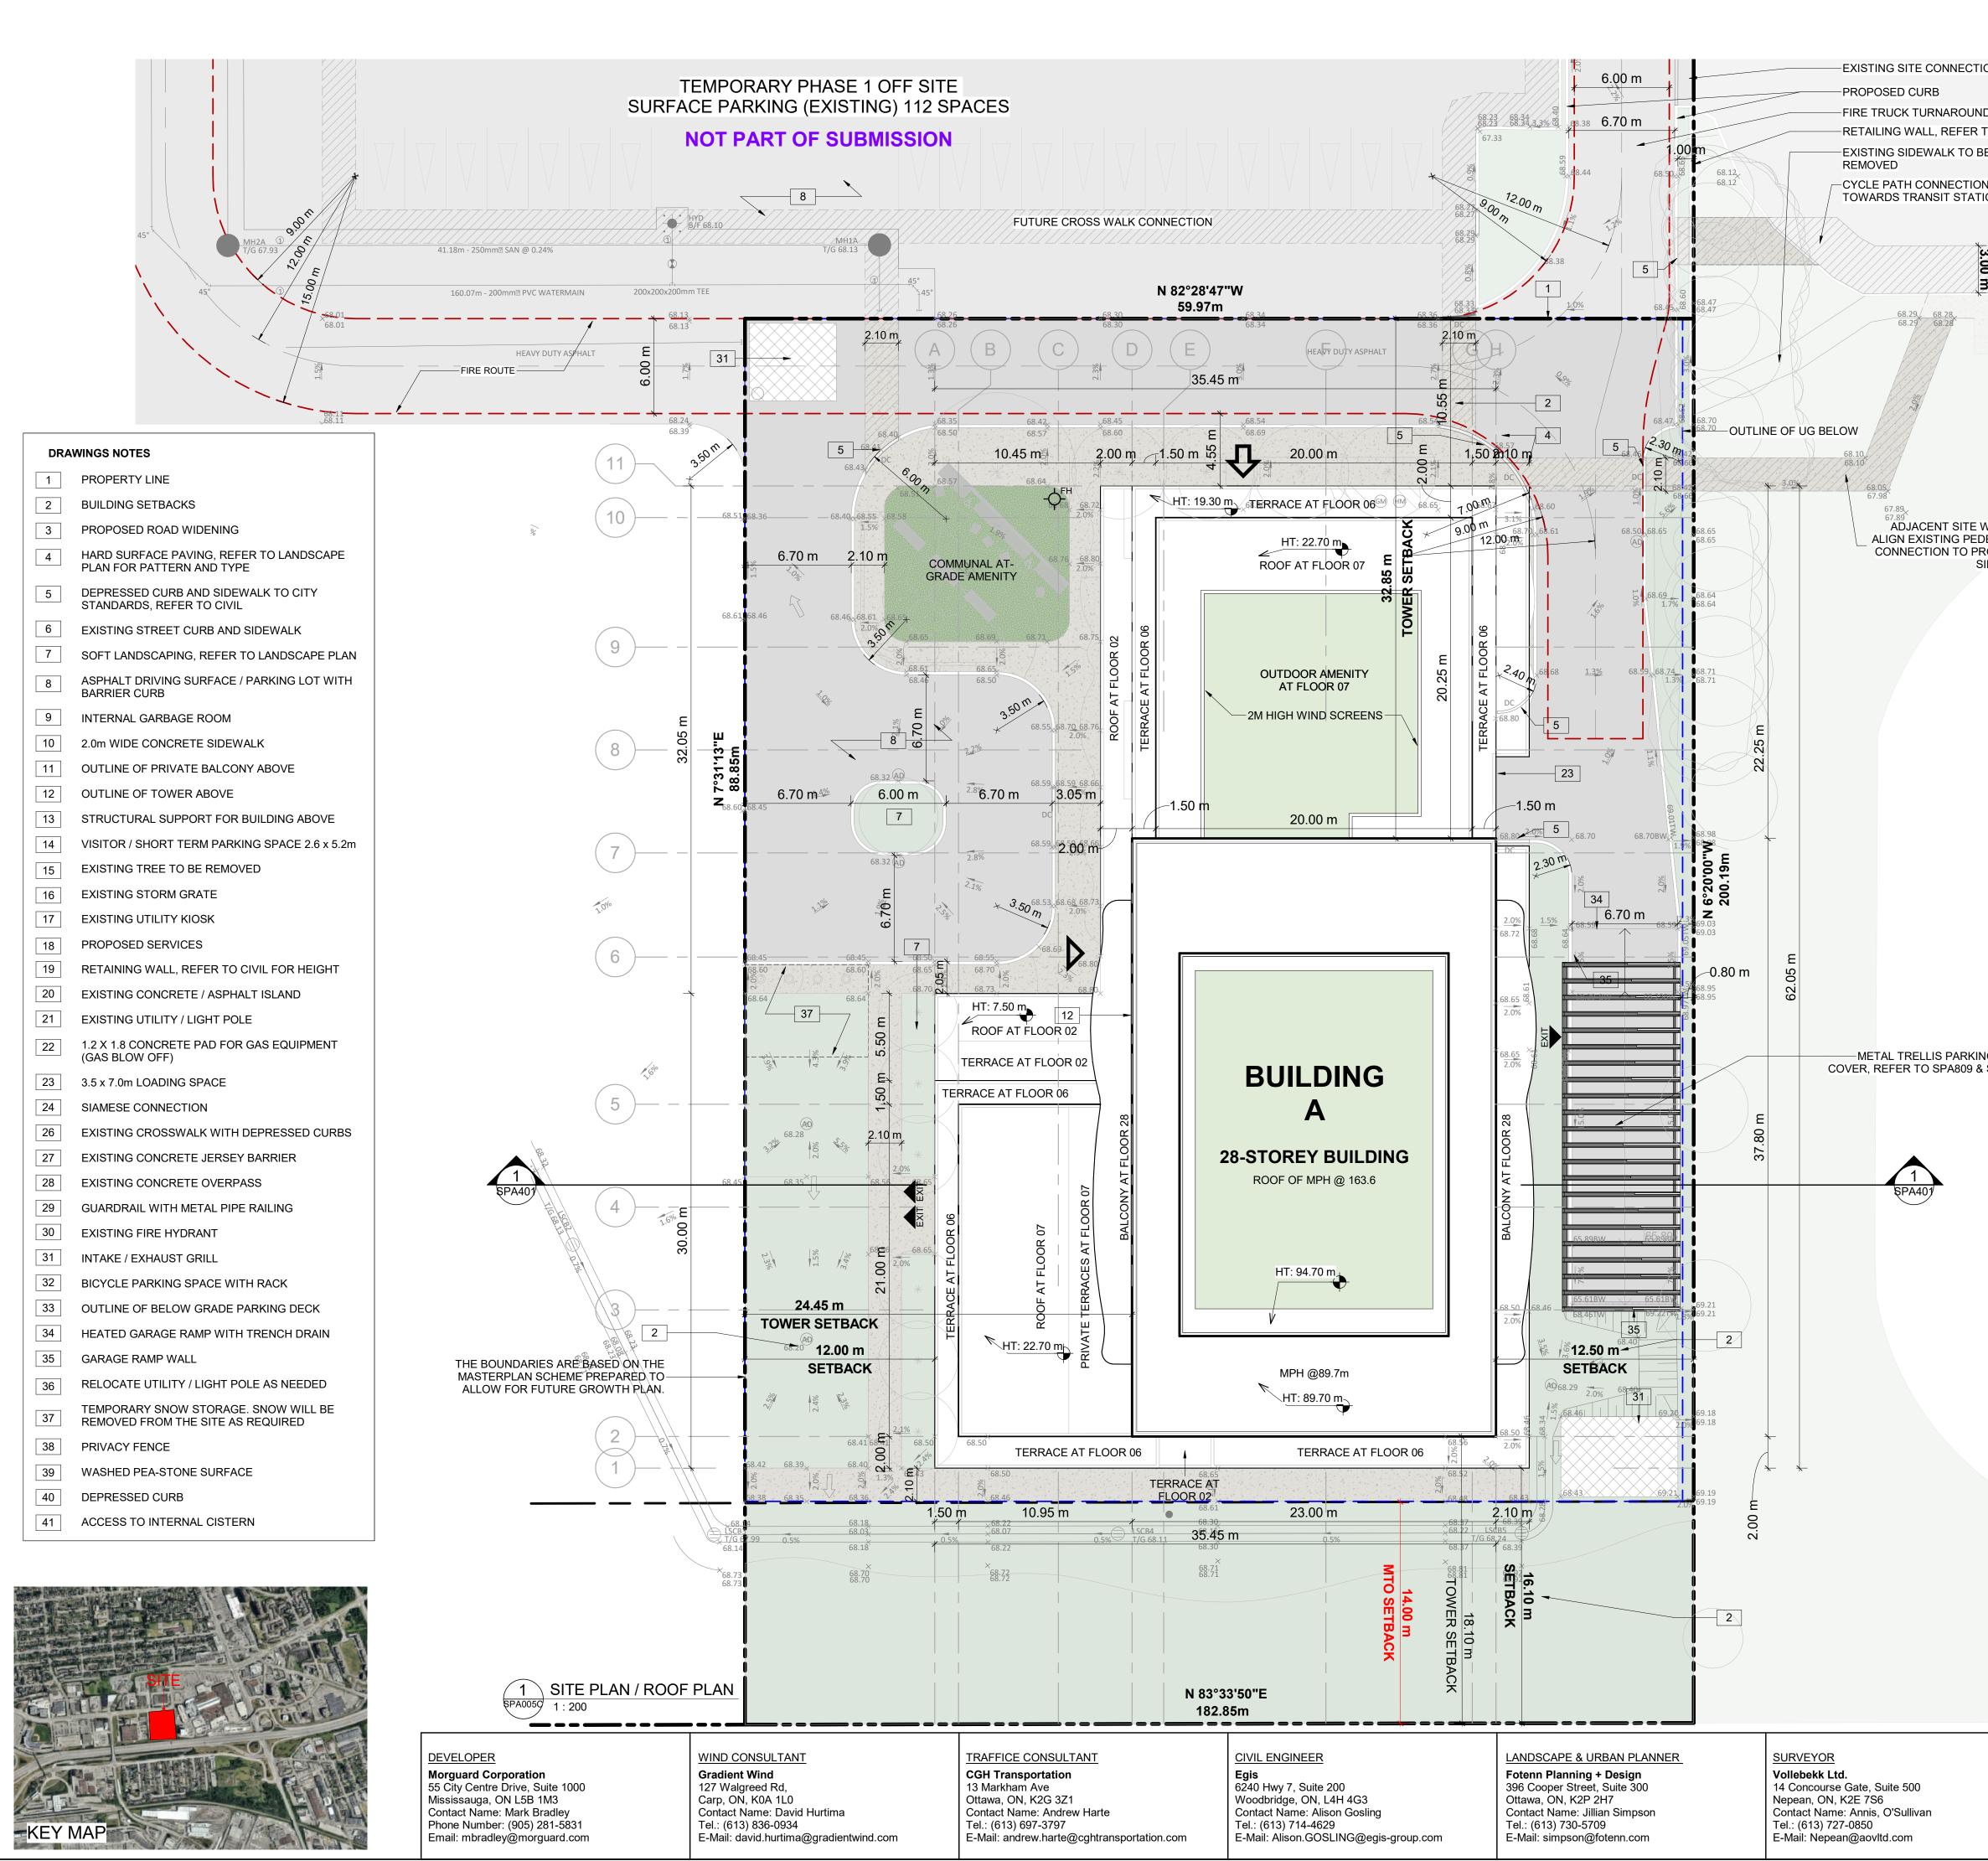

	PROJECT INFORMATION Zoning By-law 2008-250 Consolidation NET OVERALL SITE AREA BREAKDOWN	TD3		-	TURNER
	AREA TYPE	m²	ft²	╎┣∟	EISCHER
TION	SITE AREA - BLDG A TOTAL PARKLAND AREA	5,325.5 3,486.0	57,323.4 37,523		Turner Fleischer Architects Inc.
ND AREA			0.,020		67 Lesmill Road
R TO CIVIL.	TEMPORARY OFF SITE PARKING (PHASE 1) PHASE 1 SURFACE PARKING	6,851.7	73,751.1		Toronto, ON, M3B 2T8 T 416 425 2222
BE	ZONING	0,031.7	73,731.1	This drawing, as an inc	turnerfleischer.com
ON	BUILDING HEIGHT	REQUIRED 30 STOREYS /	PROVIDED 28 STOREYS /	Architects Inc. The con on site and must notify information. This drawi	trument of service, is provided by and is the property of Turner Fleischer tractor must verify and accept responsibility for all dimensions and conditions Turner Fleischer Architects Inc. of any variations from the supplied ng is not to be scaled. The architect is not responsible for the accuracy of
TION		90.0M	89.7M	survey, structural, mech appropriate consultant's applicable codes and re	hanical, electrical, etc., information shown on this drawing. Refer to the s drawings before proceeding with the work. Construction must conform to all equirements of authorities having jurisdiction. The contractor working from
	GRADE (GEODETIC ELEVATION - ASL) ALLOWABLE PROJECTION - AMENITY LEVEL	0.0M	68.80M 22.7M	for any corrections or d	ly marked 'For Construction' must assume full responsibility and bear costs amages resulting from his work. y Turner Fleischer is reliant on a legal survey showing the boundaries of the lands
<u></u>	DENSITY - MINIMUM 350 units/hectare	206 UNITS	309 UNITS	together with the current	location of any existing buildings, features or encroachment prepared by Annis 2023 as provided by Vollebekk Ltd
3.00 m	FRONT YARD SETBACK CORNER YARD SETBACK (East / West)	3.0M 3.0M/3.0M	110.75M 134.85M/12.5M	SIT	E PLAN SYMBOLS
₽////	REAR YARD SETBACK (GROUND TO 6th FLOOR)	0.0M	16.10M		IMARY SIDENTIAL ENTRANCE
	REAR YARD SETBACK (ABOVE 7th STOREY) AMENITY AREA - TOTAL PER UNIT	12.0M 6.0M ²	18.10M 17.4M ²		CONDARY RESIDENTIAL
- 6	AMENITY AREA - 50% COMMUNAL PER UNIT	3.0M ²	4.55M ²		ITRANCE
	AMENITY AREA - 2.0% OF LOT EXTERIOR AT GRADE COMMUNAL	117.15M ²	172.6M ²	EXIT EX	IT
	VEHICLE PARKING - RESIDENTIAL (AREA 'Z' - MAX 1.5/PER UNIT)	NOT REQUIRED	289		RE HYDRANT
	VEHICLE PARKING - VISITOR ONLY (MAX. 30,	30	30	∇	
	AFTER 12 UNITS)	405	000		AMESE CONNECTION
	BICYCLE PARKING - RESIDENTIAL - 0.5 PER UNIT AISLE & DRIVEWAY MINIMUM / MAXIMUM WIDTH	165 6.0M/6.7M	309 6.7M		
	GROSS BUILDING FLOOR AREA (OTTAWA ZONING D	•			
	UG1	m²	ft²	⊕ ^{000.00} sP	OT ELEVATION
E WORK TO EDESTRIAN	FLOOR 01			M GA	S/HYDRO METER
PROPOSED SIDEWALK	FLOOR 02 FLOOR 03-05 1,339.6 m² x 3	1,339.6 4,018.8	14,419 43,257	<u> </u>	
	FLOOR 05-05 1,359.0 III x 3	1,224.1	43,237 13,176	REFER TO LAN	IDSCAPE DRAWINGS FOR SURFACE
	FLOOR 07 FLOOR 08 - FLOOR 28 725.2 m² x 21	631.4 15,229.2	6,796 163,926	MININ	MUM PERMITTED PARKING
	TOTAL	22,443.7	241,582		
	TYP. FLOOR PLATE	725.2	7,806		PICAL PARKING DIMENSIONS WIDTH: MIN 6.7m
	UNIT STATISTICS				AL PARKING SPACE:
	1B		UNITS 58	MIN 2.	6 x 5.2 x 2.1 m HIGH
	1B+D		82		
	2B 2B+D		77 61		
	3B		31	5200 ,	2 / / / / 1000 MAX / / / / / / / / / / / / / / / / / / / / / / / / / / / / / / / / / / / / / / / / / / / / / / / / / / / / / / / / / / / / / / / / / / /
	TOTAL		309		
	VEHICULAR PARKING SPACES REQUIRED- AREA 'Z' VISITOR 0.1 SPACES PER UNIT AFTER 12 U		<u>,</u>	AISI F	300 3002 3002
	VISITOR 0.1 SPACES PER UNIT AFTER 12 U RESIDENTIAL N/A	UNITS - MAX 30	30 0	6700 DRIVE AI	
	TOTAL		30		
	VEHICULAR PARKING SPACES PROVIDED			5200	
	VISITOR 0.1 SPACES PER UNIT (309 UNITS RESIDENTIAL 0.56 SPACES PER UNIT (309 UNIT	/	30 177		
	TOTAL	3)	207	TY	PICAL BARRIER FREE SPACE
	EXISTING SURFACE PARKING LOTTOTAL1.03 PER UNIT (309 UNITS)	_	112 319	MIN 3.	66 x 5.2 x 2.1m HIGH
			019		
	ACCESSIBLE PARKING SPACES REQUIRED - (NOT IN	NCLUDING SURF		5200	
	TYPE 'A' TYPE 'B'		3		
ING RAMP & SPA810.	TOTAL		7		
	ACCESSIBLE PARKING SPACES PROVIDED - (NOT IN		CE PARKING)		TYPE'A' TYPE'B' 1500
	TYPE 'A' TYPE 'B'		3		
	TOTAL		8		
	STANDARD PARKING SPACE PARALLEL PARKING SPACE		2.6m X 5.2m 2.6m X 6.7m		
	SMALL PARKING SPACE		2.4m X 4.6m		
	ACCESSIBLE PARKING SPACE ' TYPE A '		3.4m X 5.2m		
	ACCESSIBLE PARKING SPACE ' TYPE B ' LOADING SPACE		2.4m X 5.2m 3.5m X 7.0m	2 2024-11-01	ISSUED FOR SITE PLAN APPROVAL AYU
	BICYCLE PARKING SPACES REQUIRED			1 2024-01-30 # DATE	ISSUED FOR PRE-CONSTRUCTION AYU DESCRIPTION BY
	RESIDENTIAL0.5 PER UNIT (309 UNITS)TOTAL		155 155		
	BICYCLE PARKING SPACES PROVIDED		100		
	RESIDENTIAL INTERIOR		309		orguard
	EXTERIOR TOTAL 1.0 PER UNIT (309 UNITS)		0 309		JI GUdi L
	AMENITY AREA				
		m²	ft²	PROJECT	500 COVENTRY ROAD
	GRADE EXTERIOR - COMMUNAL INTERIOR - COMMUNAL	172.6 1,095.4	1,858 11,791		
	07F EXTERIOR - COMMUNAL	202.1	2,175	500	COVENTRY ROAD, OTTAWA, ON.
	TOTAL COMMUNAL BALCONIES / TERRACE - PRIVATE	1,470.1 3,506.2	15,824 37,741		
	TOTAL	4,976.3	53,565	DRAWING	
	REQUIRED (309 UNITS X 6 m²) = 1,854 sq. m.				
	REQUIRED COMMUNAL @ 50% = 927 sq. m.			S	ITE PLAN / ROOF PLAN
	SITE COVERAGE				
		m²	%	PROJECT NO.	
	BUILDING FOOTPRINT DRIVING SURFACE	1,815.4 1,260.5	34.1% 23.7%	18.050 P01 PROJECT DATE	- ASSOC
	LANDSCAPE AREA	2,249.6	42.2%	2024-09-13	Strand of The
	TOTAL BUILDING A	5,325.5	100%	DRAWN BY RYT / DRO	
	REFUGE REQUIREMENT (309 UNITS)			CHECKED BY	
	COMF GARBAGE	PACTED RATIO 0.053 yd ³ /UNIT	CUBIC YARDS 17	SCALE	LICENCE 1
	RECYCLING GMP	0.018 yd ³ /UNIT	6	1:200	

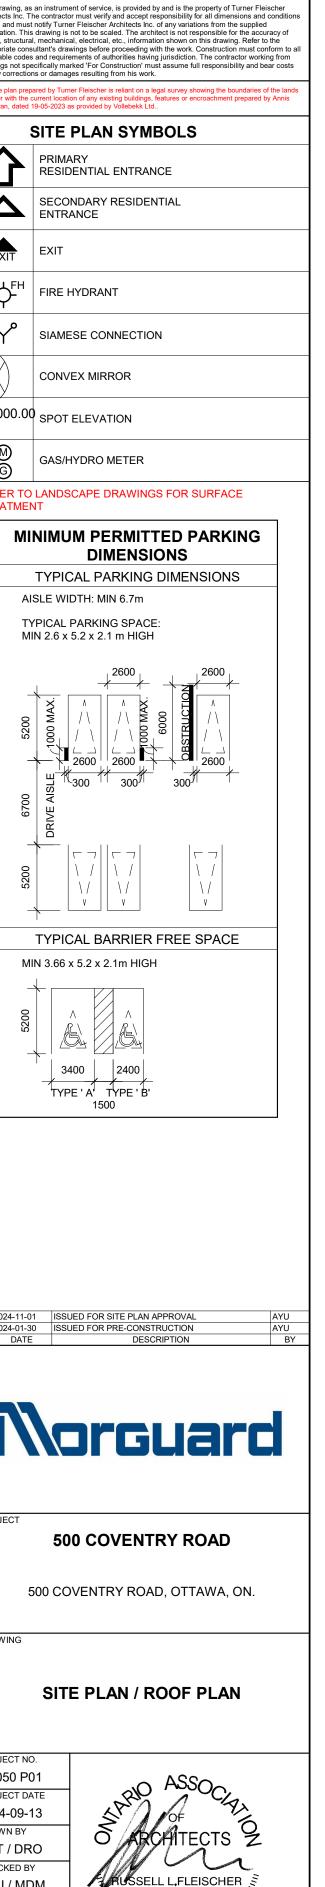

SPA005C 2


7 BINS

0.038 yd3/UNIT


240L PER 50 UNITS


COMPOST


RECYCLING FIBER

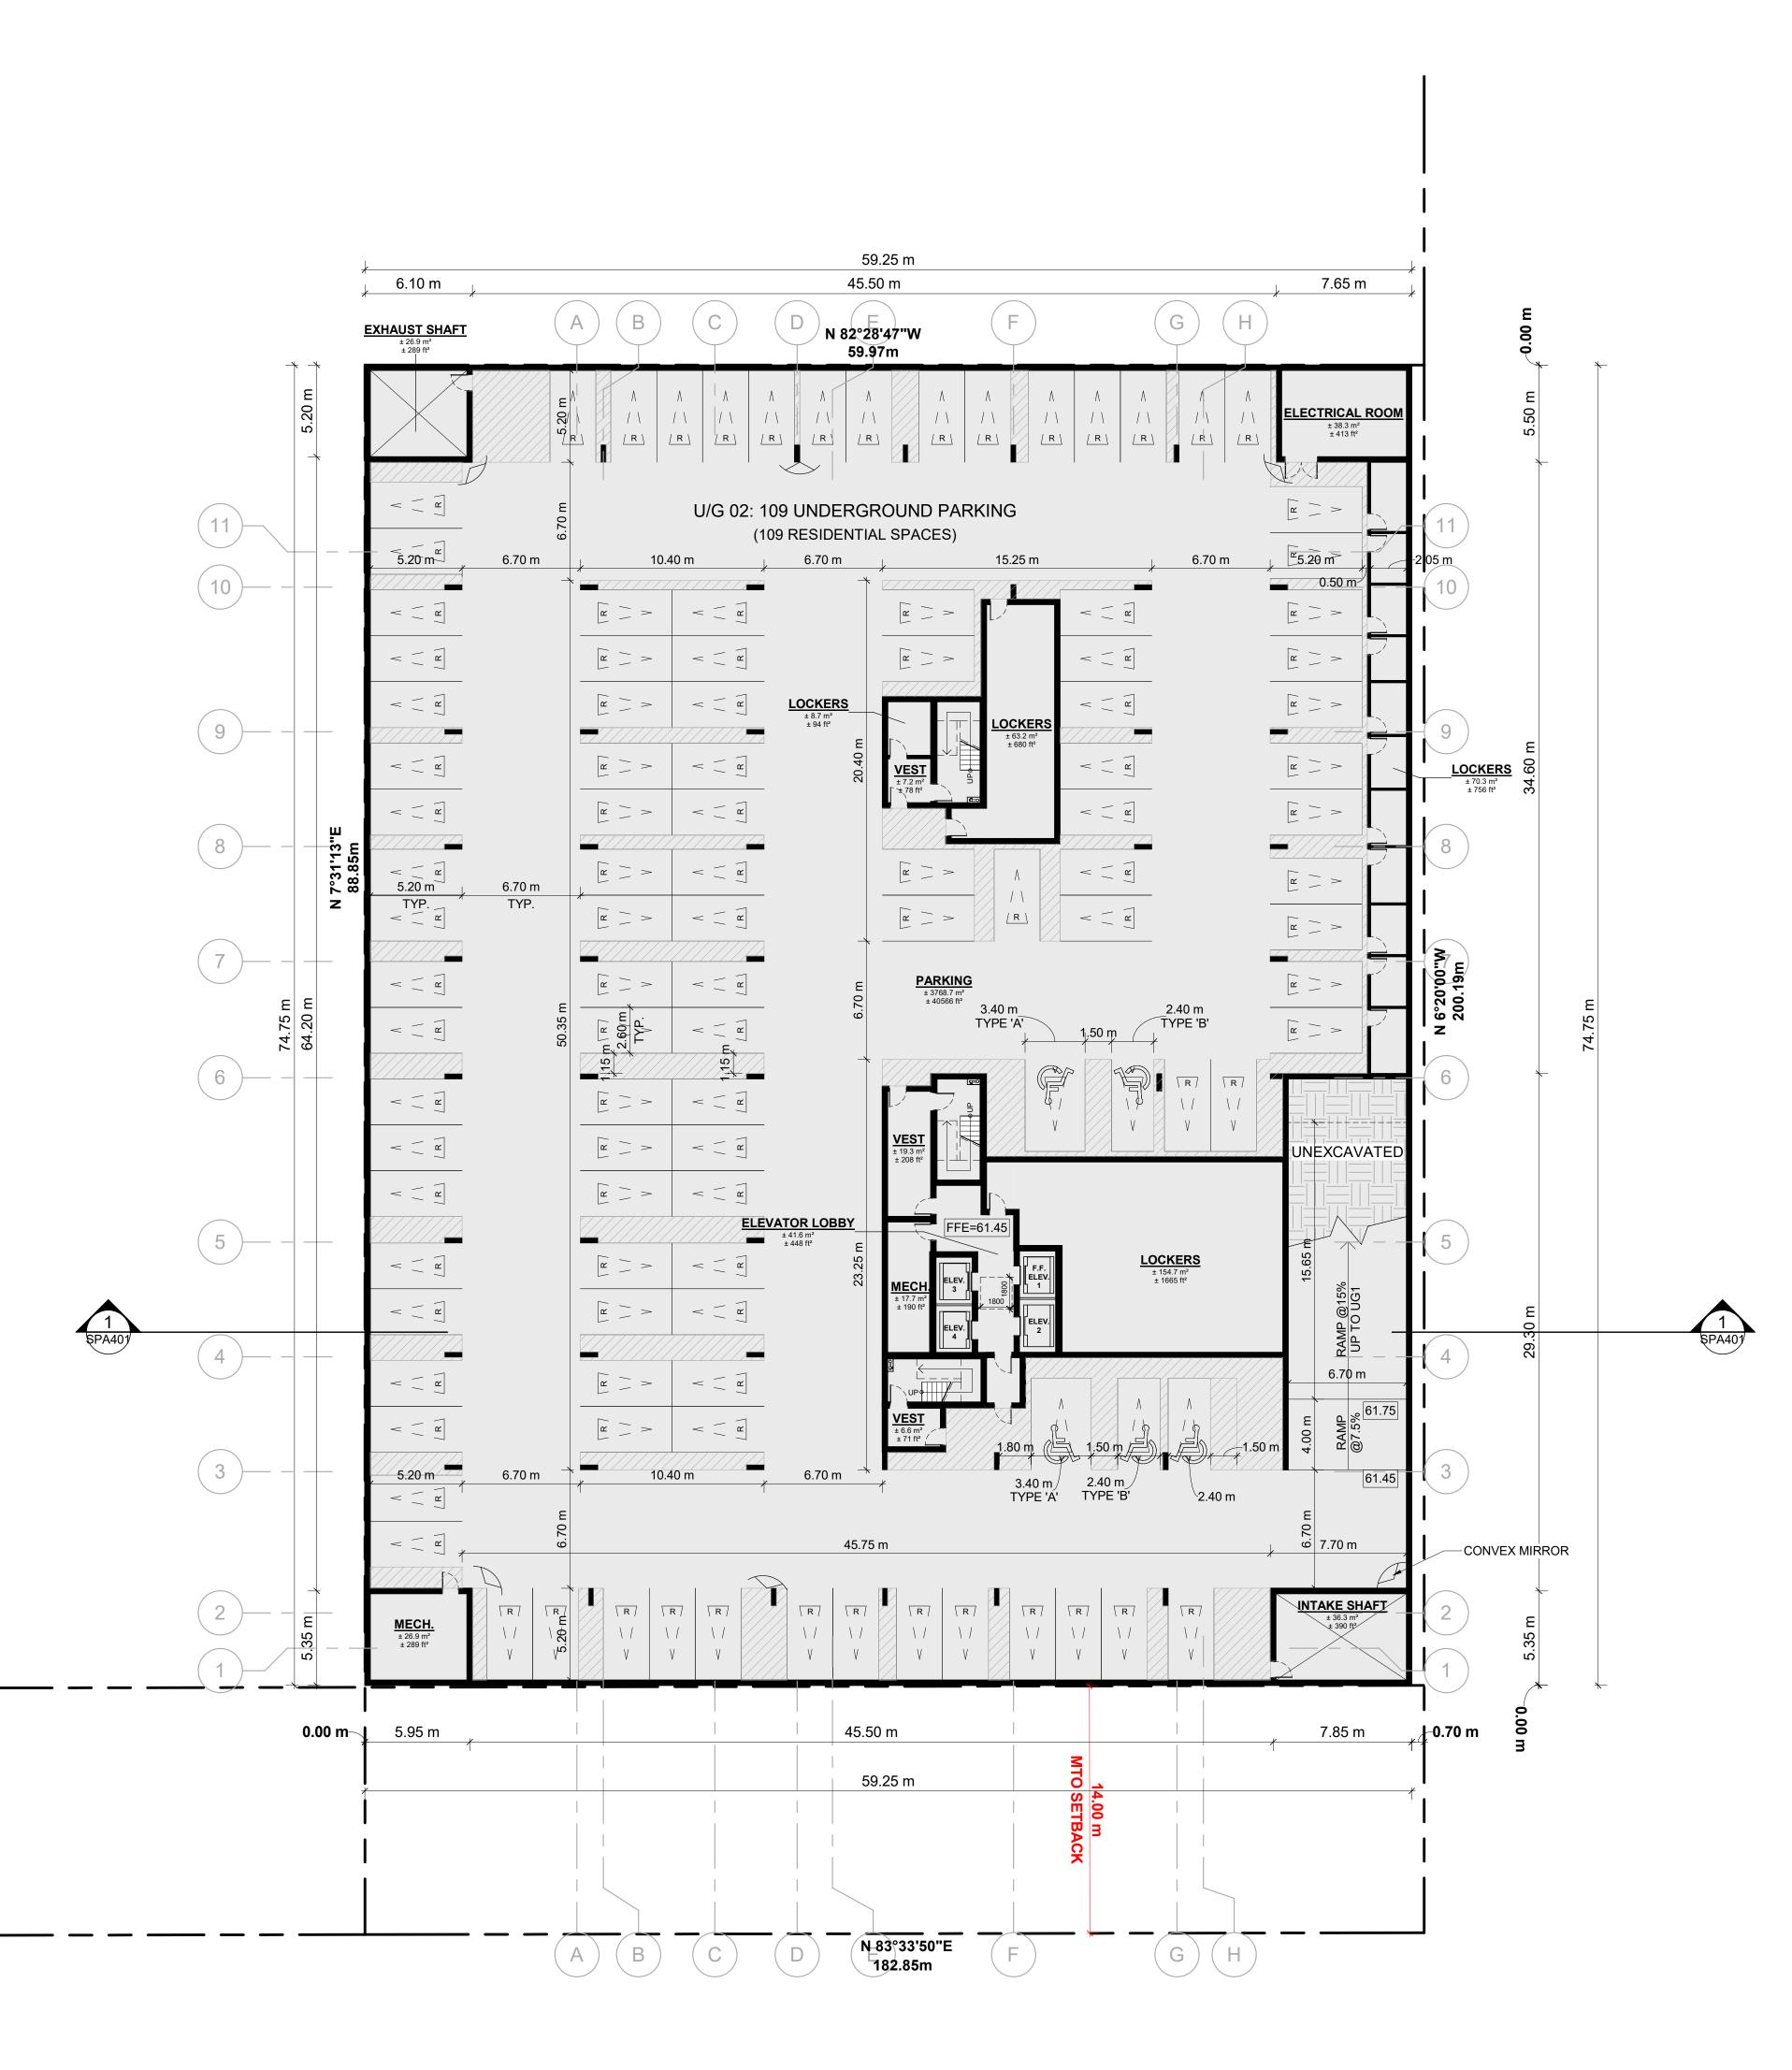




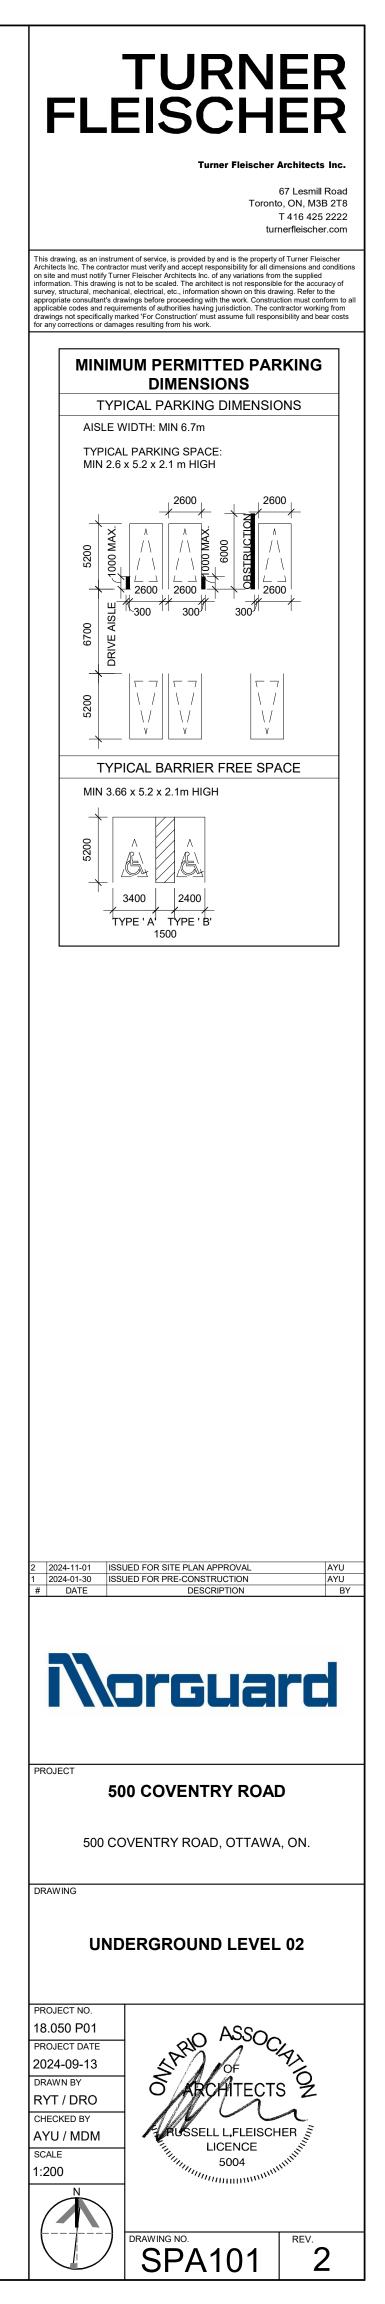

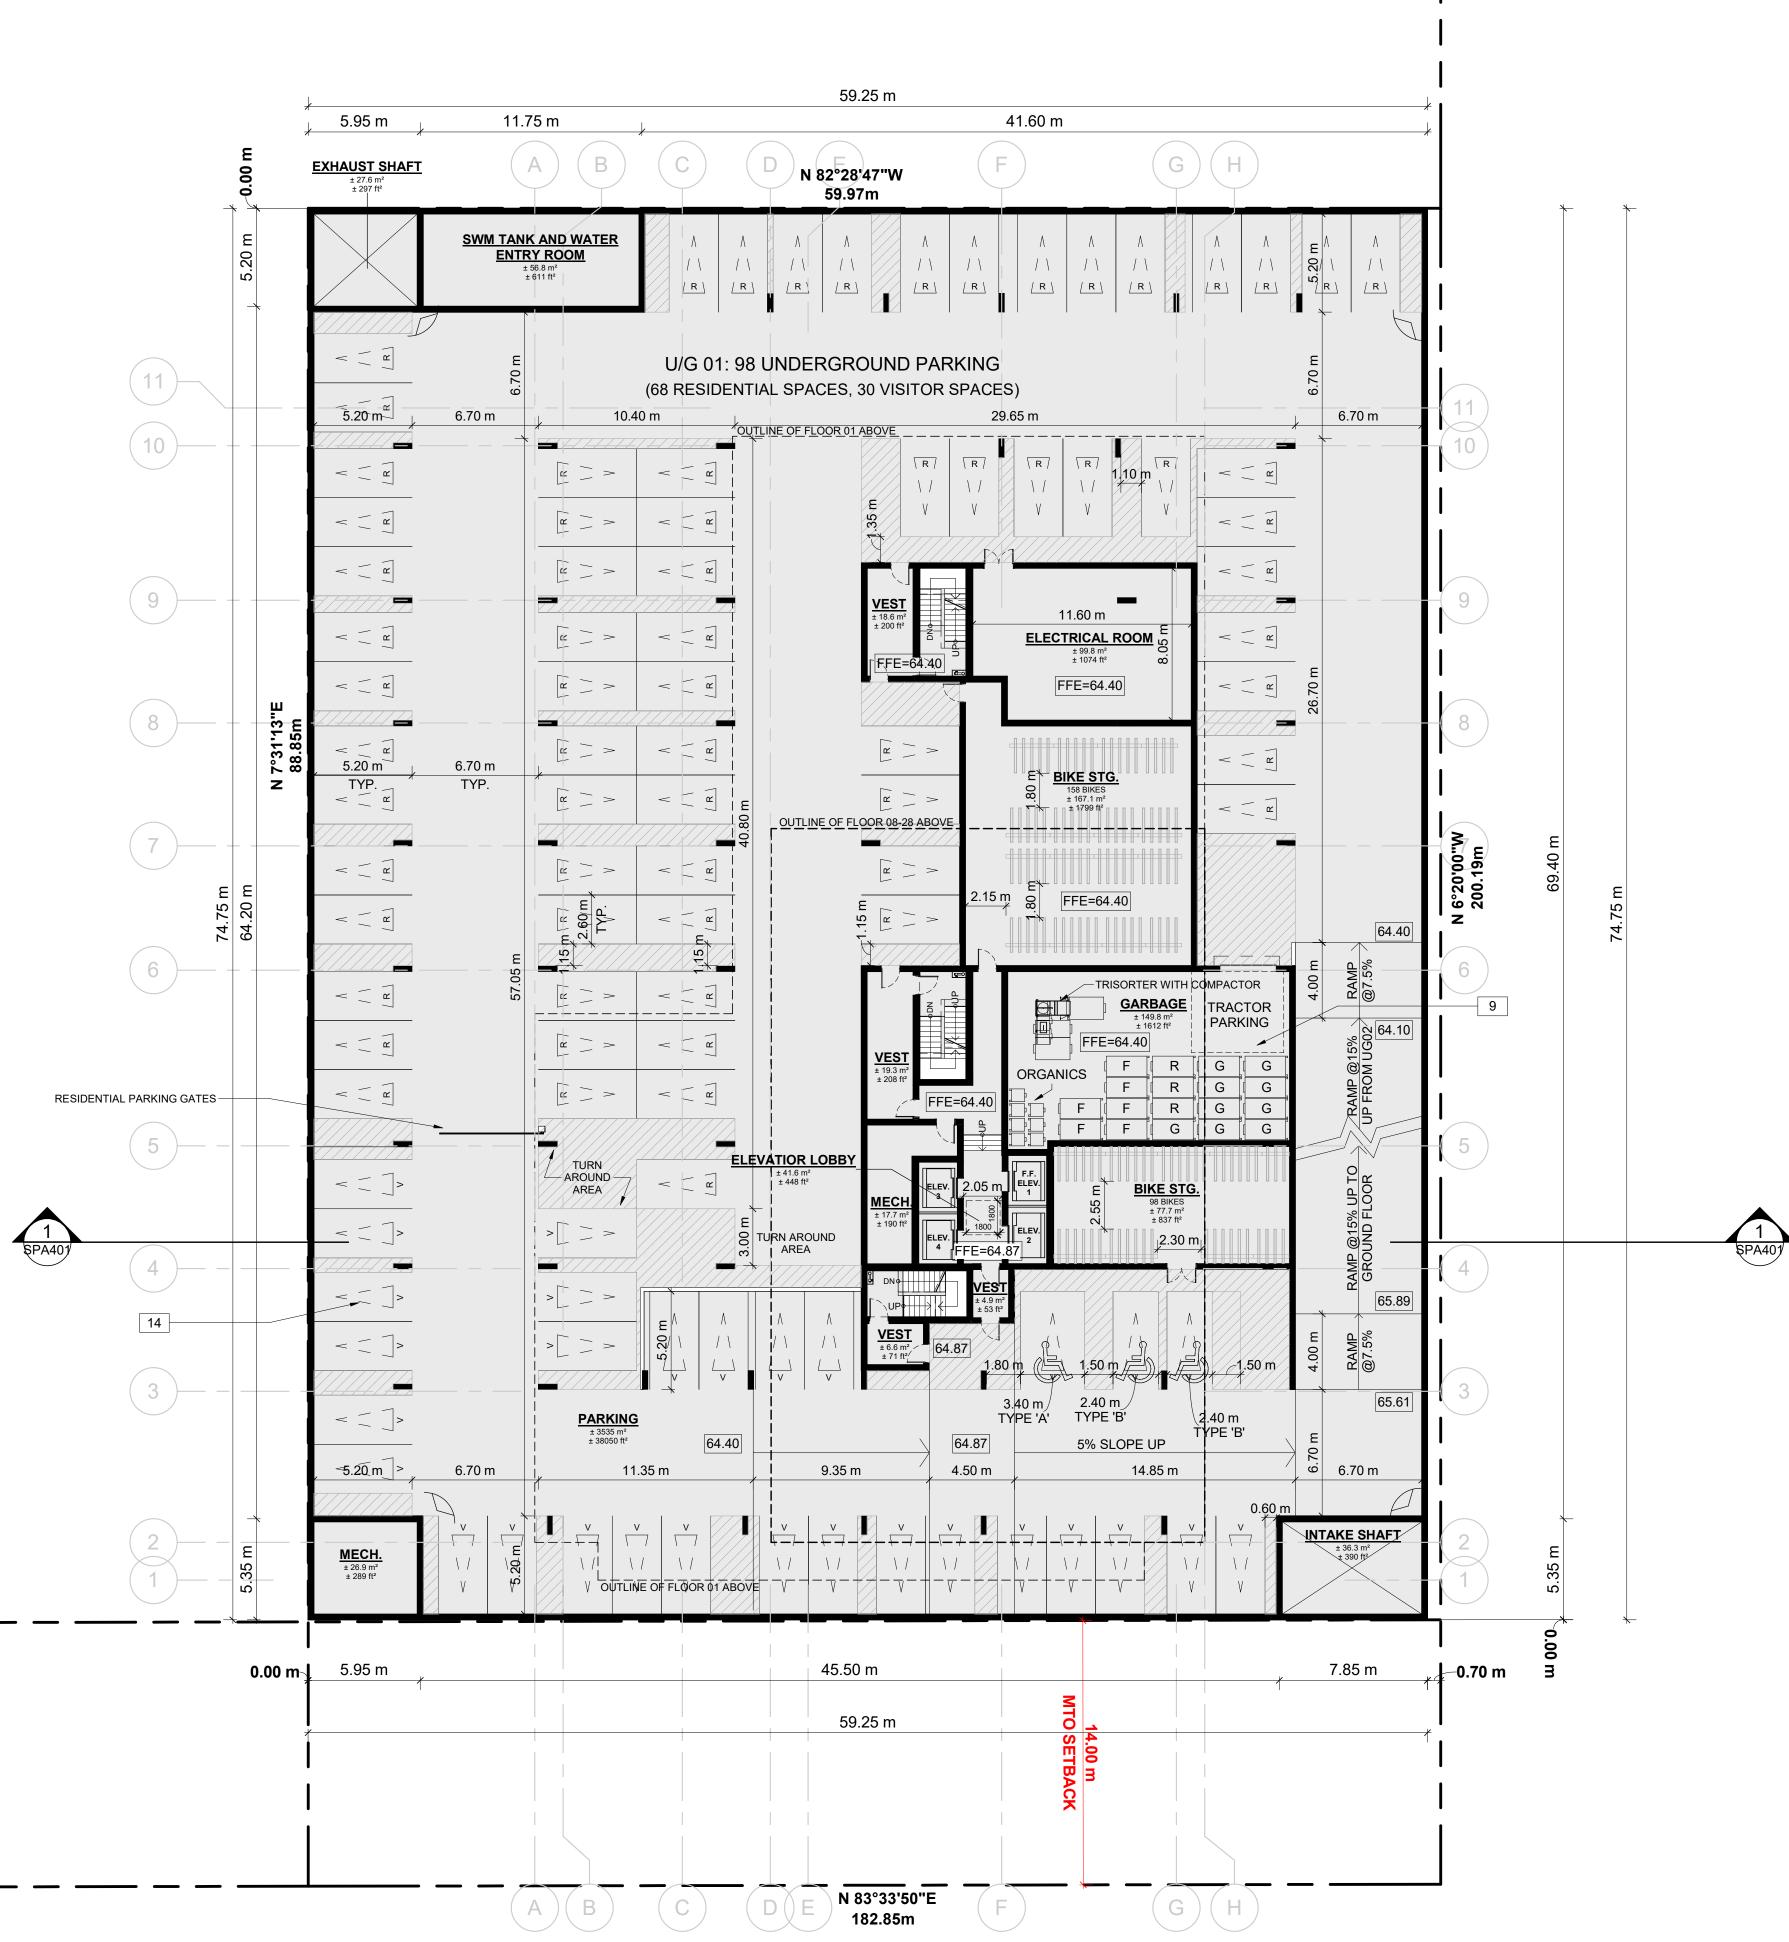


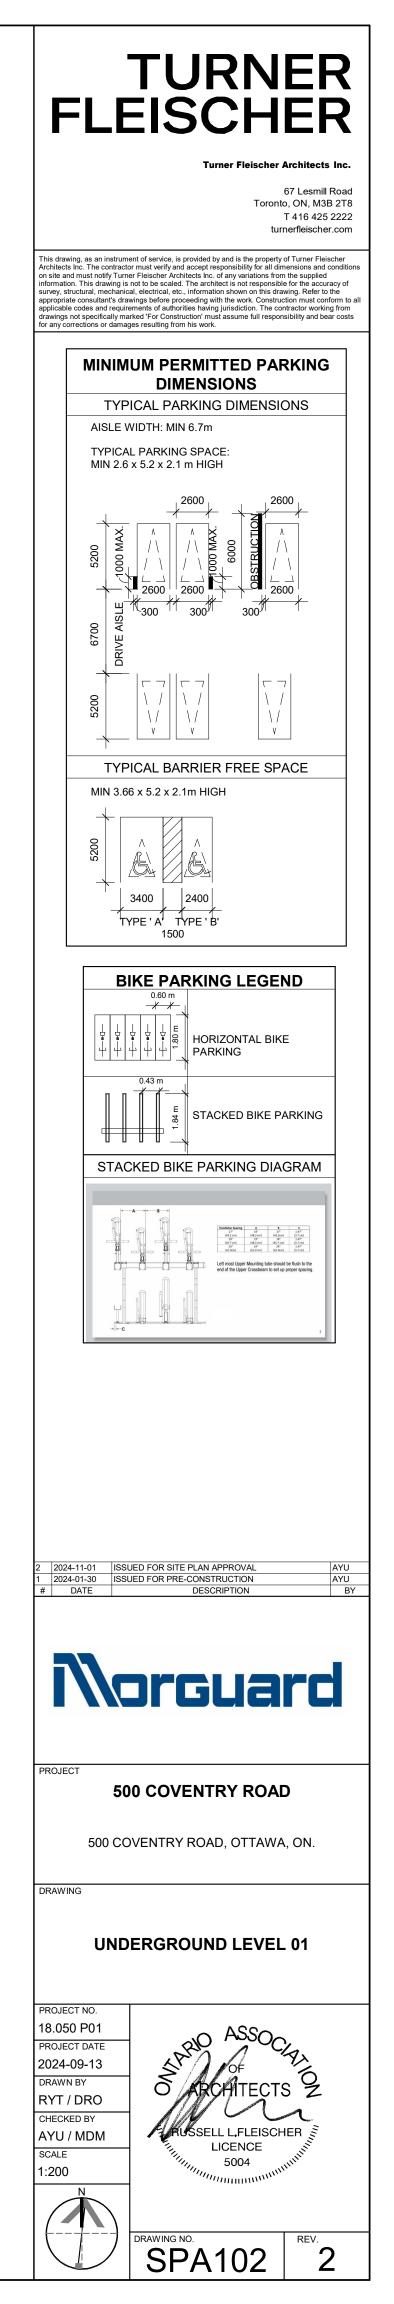

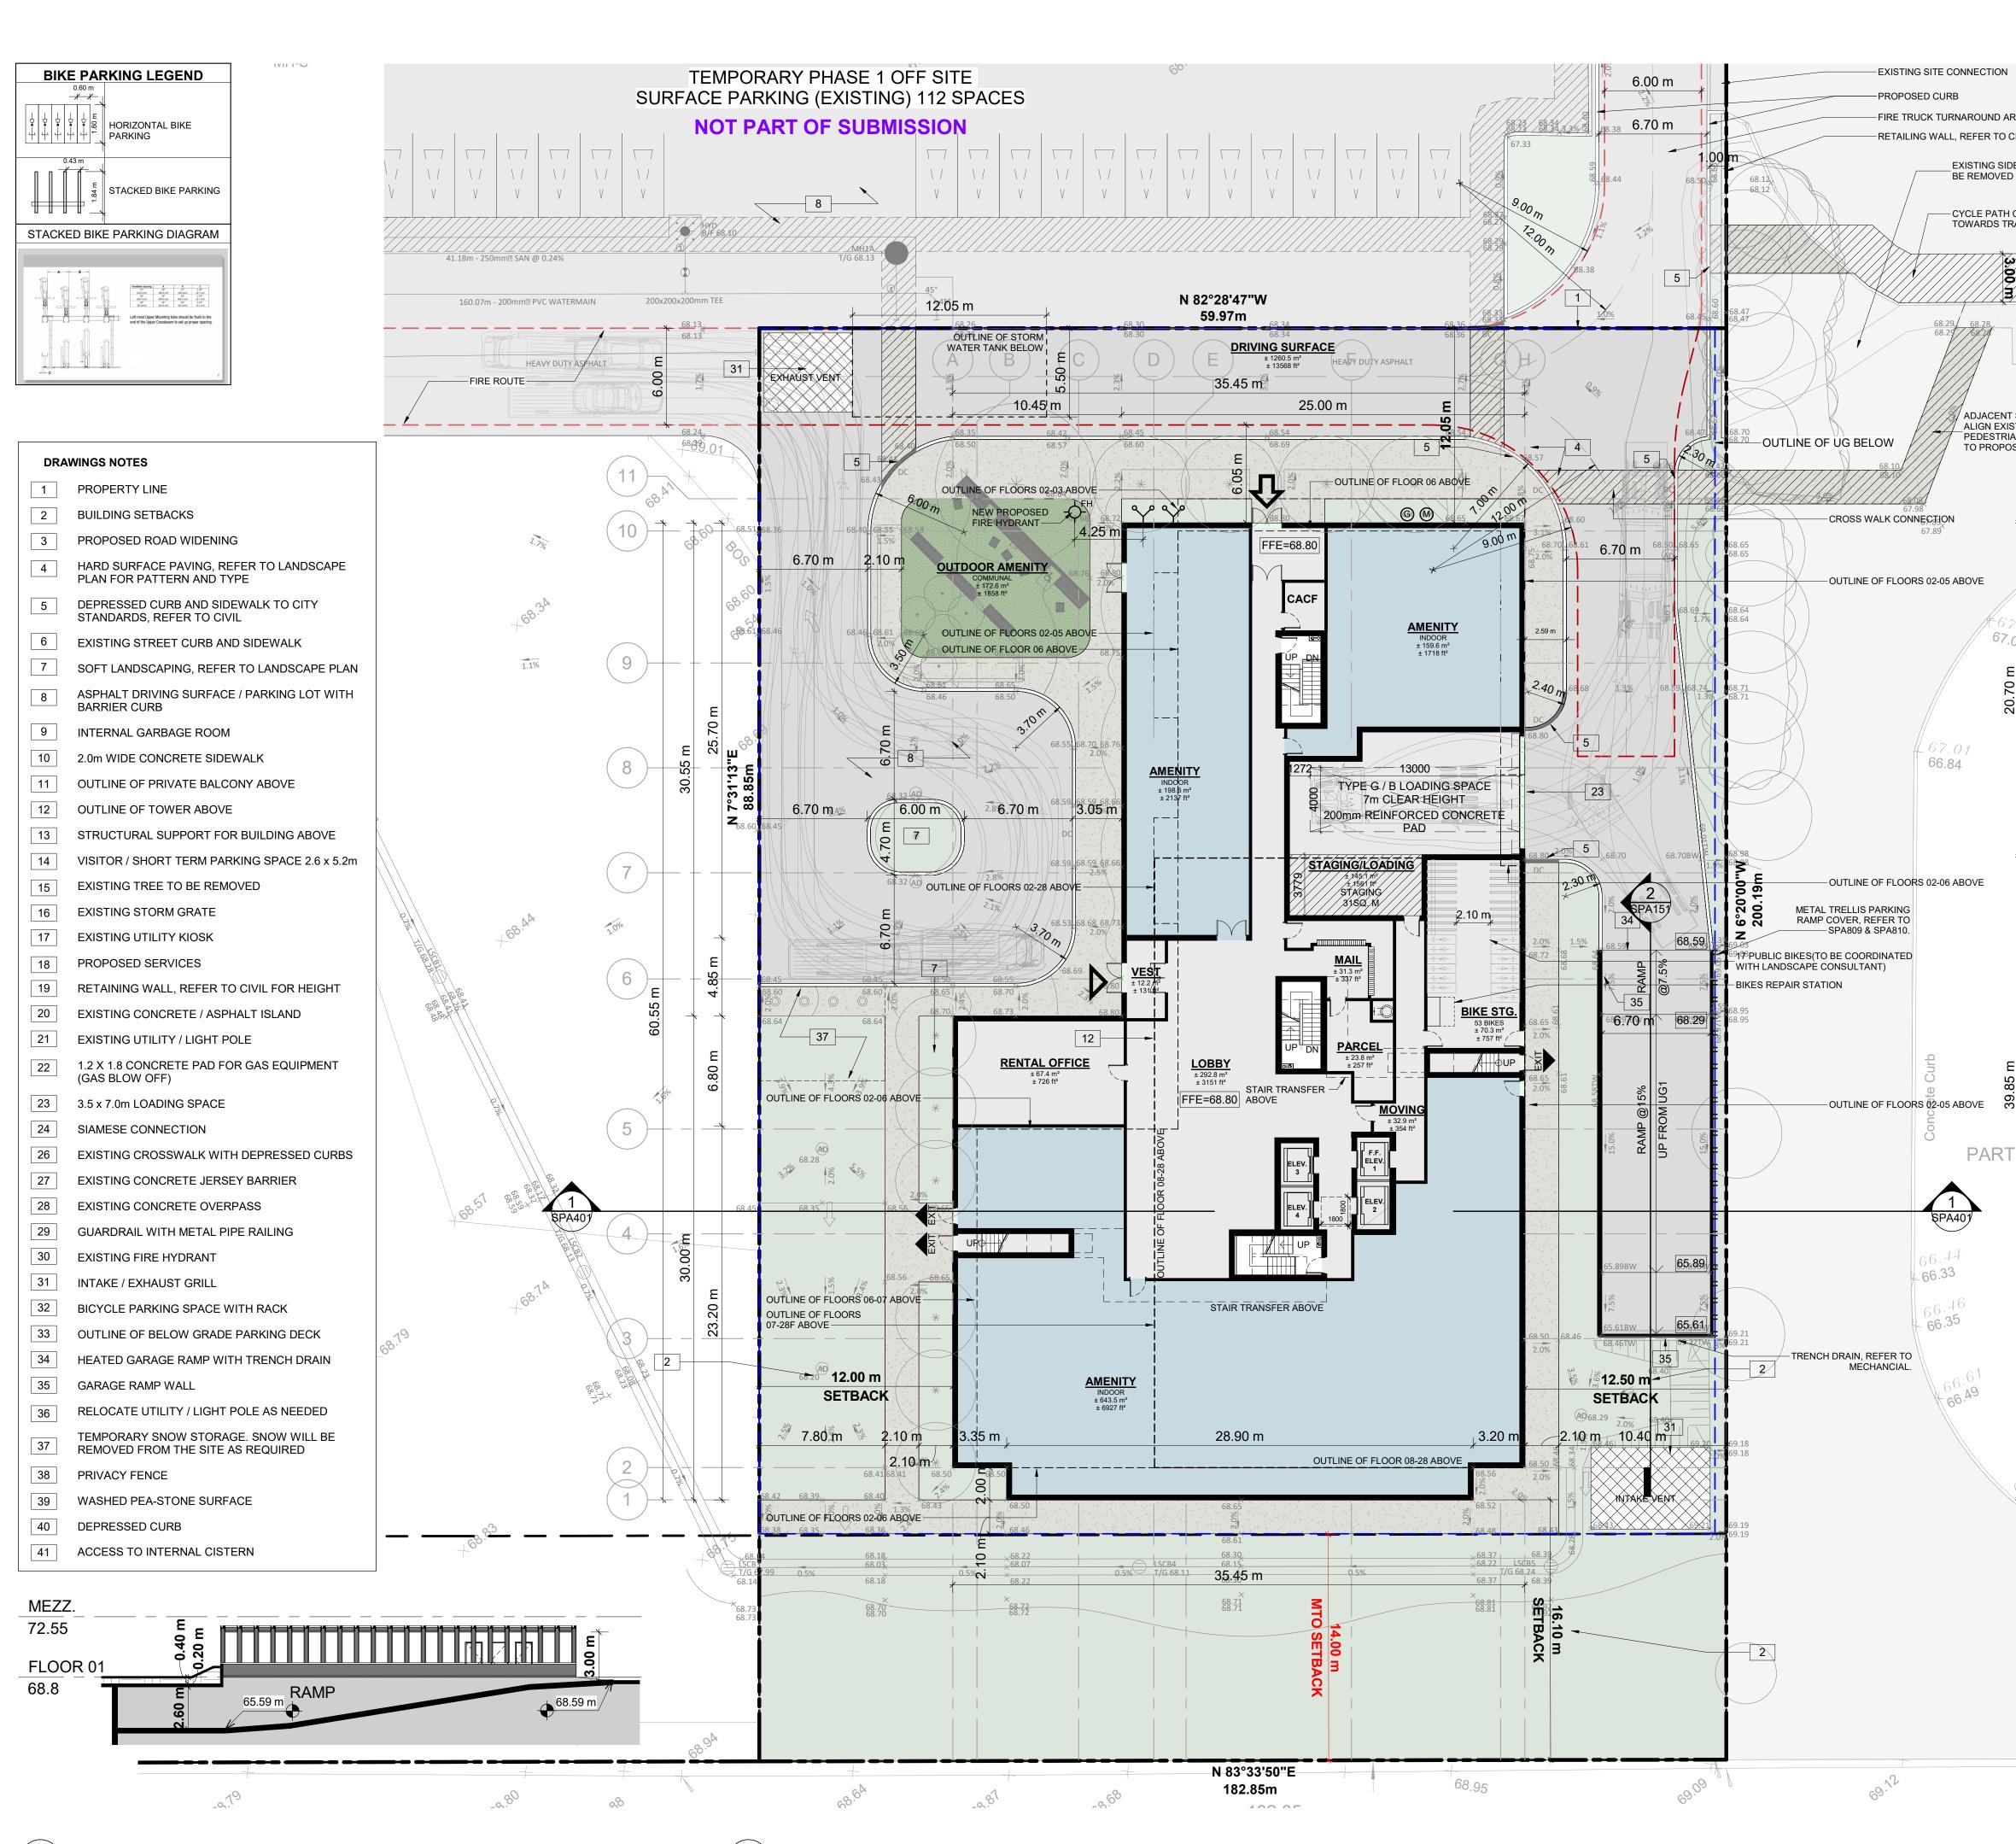

2 RAMP SECTION SPA151 1 : 200

I	NET OVERALL SITE AREA BREAKDOWN	TD3		
	AREA TYPE SITE AREA - BLDG A	m² 5,325.5	ft² 57,323.4	FLEIJUHER
ΕA	TOTAL PARKLAND AREA	3,486.0	37,523	Turner Fleischer Architects Inc. 67 Lesmill Road
EA VIL.	TEMPORARY OFF SITE PARKING (PHASE 1) PHASE 1 SURFACE PARKING	£ 0E4 7	72 754 4	Toronto, ON, M3B 2T8 T 416 425 2222
WALK TO	PHASE 1 SURFACE PARKING ZONING	6,851.7	73,751.1	turnerfleischer.com
	BUILDING HEIGHT	REQUIRED 30 STOREYS /	PROVIDED 28 STOREYS /	Architects Inc. The contractor must verify and accept responsibility for all dimensions and condition on site and must notify Turner Fleischer Architects Inc. of any variations from the supplied information. This drawing is not to be scaled. The architect is not responsible for the accuracy of survey, structural, mechanical, electrical, etc., information shown on this drawing. Refer to the
ONNECTION	GRADE (GEODETIC ELEVATION - ASL)	90.0M	89.7M 68.80M	appropriate consultant's drawings before proceeding with the work. Construction must conform to a applicable codes and requirements of authorities having jurisdiction. The contractor working from drawings not specifically marked 'For Construction' must assume full responsibility and bear costs for any corrections or damages resulting from his work.
	ALLOWABLE PROJECTION - AMENITY LEVEL DENSITY - MINIMUM 350 units/hectare	0.0M 206 UNITS	22.7M 309 UNITS	SITE PLAN SYMBOLS
	FRONT YARD SETBACK CORNER YARD SETBACK (East / West)	3.0M 3.0M/3.0M	110.75M 134.85M/12.5M	PRIMARY RESIDENTIAL ENTRANCE
<u>///////</u>	REAR YARD SETBACK (GROUND TO 6th FLOOR)	0.0M	16.10M	SECONDARY RESIDENTIAL ENTRANCE
	REAR YARD SETBACK (ABOVE 7th STOREY)AMENITY AREA - TOTAL PER UNIT	12.0M 6.0M ²	18.10M 17.4M ²	
- 6	AMENITY AREA - 50% COMMUNAL PER UNIT AMENITY AREA - 2.0% OF LOT EXTERIOR AT	3.0M ² 117.15M ²	4.55M ² 172.6M ²	EXIT
	GRADE COMMUNAL VEHICLE PARKING - RESIDENTIAL (AREA 'Z' - MAX	NOT	289	
TE WORK TO NG	1.5/PER UNIT) VEHICLE PARKING - VISITOR ONLY (MAX. 30,	REQUIRED 30	30	SIAMESE CONNECTION
CONNECTION D SIDEWALK	AFTER 12 UNITS)			
	BICYCLE PARKING - RESIDENTIAL - 0.5 PER UNIT AISLE & DRIVEWAY MINIMUM / MAXIMUM WIDTH	165 6.0M/6.7M	309 6.7M	000.00 SPOT ELEVATION
	GROSS BUILDING FLOOR AREA (OTTAWA ZONING D	EFINITION)	ft²	
- +	UG1	111-	11-	GAS/HYDRO METER
	FLOOR 01 FLOOR 02	1,339.6	14,419	REFER TO LANDSCAPE DRAWINGS FOR SURFACE TREATMENT
	FLOOR 03-05 1,339.6 m² x 3 FLOOR 06	4,018.8 1,224.1	43,257 13,176	MINIMUM PERMITTED PARKING
1 ~	FLOOR 07 FLOOR 08 - FLOOR 28 725.2 m² x 21	631.4 15,229.2	6,796	DIMENSIONS TYPICAL PARKING DIMENSIONS
}	TOTAL	22,443.7	163,926 241,582	AISLE WIDTH: MIN 6.7m
		725.2	7,806	TYPICAL PARKING SPACE: MIN 2.6 x 5.2 x 2.1 m HIGH
	UNIT STATISTICS		UNITS	2600
	1B 1B+D		58 82	
	2B 2B+D		77 61	
	3B		31	
	TOTAL VEHICULAR PARKING SPACES REQUIRED- AREA 'Z'		309	A A A A A A A A A A A A A A A A A A A
_	VISITOR 0.1 SPACES PER UNIT AFTER 12 U		30	
	RESIDENTIAL N/A		0 30	
	VEHICULAR PARKING SPACES PROVIDED			
	VISITOR 0.1 SPACES PER UNIT (309 UNITS	,	30	TYPICAL BARRIER FREE SPACE
	RESIDENTIAL0.56 SPACES PER UNIT (309 UNITTOTAL	S)	177 207	MIN 3.66 x 5.2 x 2.1m HIGH
E	EXISTING SURFACE PARKING LOTTOTAL1.03 PER UNIT (309 UNITS)		112 319	
Asghali				
<i>u</i>	ACCESSIBLE PARKING SPACES REQUIRED - (NOT IN TYPE 'A'		3	3400 2400
	TYPE 'B'		Ű	TYPE'A' TYPE'B' 1500
	TOTAL		4 7	
	TOTAL ACCESSIBLE PARKING SPACES PROVIDED - (NOT IN	ICLUDING SURFA	4 7	
			4 7	
5 PLAN	ACCESSIBLE PARKING SPACES PROVIDED - (NOT IN TYPE 'A'		4 7 ACE PARKING) 3	
5 PLAN	ACCESSIBLE PARKING SPACES PROVIDED - (NOT IN TYPE 'A' TYPE 'B'		4 7 ACE PARKING) 3 5	
5 PLAN	ACCESSIBLE PARKING SPACES PROVIDED - (NOT IN TYPE 'A' TYPE 'B' TOTAL STANDARD PARKING SPACE PARALLEL PARKING SPACE		4 7 ACE PARKING) 3 5 8 2.6m X 5.2m 2.6m X 6.7m	
5 PLAN	ACCESSIBLE PARKING SPACES PROVIDED - (NOT IN TYPE 'A' TYPE 'B' TOTAL STANDARD PARKING SPACE		4 7 ACE PARKING) 3 5 8 2.6m X 5.2m	
5 PLAN	ACCESSIBLE PARKING SPACES PROVIDED - (NOT IN TYPE 'A' TYPE 'B' TOTAL STANDARD PARKING SPACE PARALLEL PARKING SPACE SMALL PARKING SPACE		4 7 ACE PARKING) 3 5 8 2.6m X 5.2m 2.6m X 5.2m 2.6m X 6.7m 2.4m X 4.6m	
5 PLAN	ACCESSIBLE PARKING SPACES PROVIDED - (NOT IN TYPE 'A' TYPE 'B' TOTAL STANDARD PARKING SPACE PARALLEL PARKING SPACE SMALL PARKING SPACE ACCESSIBLE PARKING SPACE ' TYPE A ' ACCESSIBLE PARKING SPACE ' TYPE B ' LOADING SPACE BICYCLE PARKING SPACES REQUIRED		4 7 ACE PARKING) 3 5 8 2.6m X 5.2m 2.6m X 5.2m 2.6m X 6.7m 2.4m X 4.6m 3.4m X 5.2m 2.4m X 5.2m 3.5m X 7.0m	2 2024-11-01 ISSUED FOR SITE PLAN APPROVAL AYU 1 2024-01-30 ISSUED FOR PRE-CONSTRUCTION AYU # DATE DESCRIPTION BY
5 PLAN	ACCESSIBLE PARKING SPACES PROVIDED - (NOT IN TYPE 'A' TYPE 'B' TOTAL STANDARD PARKING SPACE PARALLEL PARKING SPACE SMALL PARKING SPACE ACCESSIBLE PARKING SPACE ' TYPE A ' ACCESSIBLE PARKING SPACE ' TYPE B ' LOADING SPACE		4 7 ACE PARKING) 3 5 8 2.6m X 5.2m 2.6m X 6.7m 2.4m X 4.6m 3.4m X 5.2m 2.4m X 5.2m	2 2024-11-01 ISSUED FOR SITE PLAN APPROVAL AYU 1 2024-01-30 ISSUED FOR PRE-CONSTRUCTION AYU
5 PLAN	ACCESSIBLE PARKING SPACES PROVIDED - (NOT IN TYPE 'A' TYPE 'B' TOTAL STANDARD PARKING SPACE PARALLEL PARKING SPACE SMALL PARKING SPACE ACCESSIBLE PARKING SPACE ' TYPE A ' ACCESSIBLE PARKING SPACE ' TYPE B ' LOADING SPACE BICYCLE PARKING SPACES REQUIRED RESIDENTIAL 0.5 PER UNIT (309 UNITS) TOTAL BICYCLE PARKING SPACES PROVIDED		4 7 ACE PARKING) 3 5 8 2.6m X 5.2m 2.6m X 5.2m 2.6m X 6.7m 2.4m X 4.6m 3.4m X 5.2m 2.4m X 5.2m 3.5m X 7.0m 155 155	2 2024-11-01 ISSUED FOR SITE PLAN APPROVAL AYU 1 2024-01-30 ISSUED FOR PRE-CONSTRUCTION AYU # DATE DESCRIPTION BY
5 PLAN	ACCESSIBLE PARKING SPACES PROVIDED - (NOT IN TYPE 'A' TYPE 'B' TOTAL STANDARD PARKING SPACE PARALLEL PARKING SPACE SMALL PARKING SPACE ACCESSIBLE PARKING SPACE ' TYPE A ' ACCESSIBLE PARKING SPACE ' TYPE B ' LOADING SPACE BICYCLE PARKING SPACES REQUIRED RESIDENTIAL 0.5 PER UNIT (309 UNITS) TOTAL BICYCLE PARKING SPACES PROVIDED RESIDENTIAL INTERIOR EXTERIOR		4 7 ACE PARKING) 3 5 8 2.6m X 5.2m 2.6m X 5.2m 2.6m X 6.7m 2.4m X 4.6m 3.4m X 5.2m 2.4m X 5.2m 3.5m X 7.0m 155 155 309 0	2 2024-11-01 ISSUED FOR SITE PLAN APPROVAL AYU 1 2024-01-30 ISSUED FOR PRE-CONSTRUCTION AYU # DATE DESCRIPTION BY
5 PLAN	ACCESSIBLE PARKING SPACES PROVIDED - (NOT IN TYPE 'A' TYPE 'B' TOTAL STANDARD PARKING SPACE PARALLEL PARKING SPACE SMALL PARKING SPACE ACCESSIBLE PARKING SPACE ' TYPE A ' ACCESSIBLE PARKING SPACE ' TYPE B ' LOADING SPACE BICYCLE PARKING SPACES REQUIRED RESIDENTIAL 0.5 PER UNIT (309 UNITS) TOTAL BICYCLE PARKING SPACES PROVIDED RESIDENTIAL INTERIOR		4 7 ACE PARKING) 3 5 8 2.6m X 5.2m 2.6m X 5.2m 2.6m X 6.7m 2.4m X 4.6m 3.4m X 5.2m 2.4m X 5.2m 3.5m X 7.0m 155 155 309	2 2024-11-01 ISSUED FOR SITE PLAN APPROVAL AYU 1 2024-01-30 ISSUED FOR PRE-CONSTRUCTION AYU
5 PLAN	ACCESSIBLE PARKING SPACES PROVIDED - (NOT IN TYPE 'A' TYPE 'B' TOTAL STANDARD PARKING SPACE PARALLEL PARKING SPACE SMALL PARKING SPACE ACCESSIBLE PARKING SPACE ' TYPE A ' ACCESSIBLE PARKING SPACE ' TYPE B ' LOADING SPACE BICYCLE PARKING SPACES REQUIRED RESIDENTIAL 0.5 PER UNIT (309 UNITS) TOTAL BICYCLE PARKING SPACES PROVIDED RESIDENTIAL INTERIOR EXTERIOR		4 7 ACE PARKING) 3 5 8 2.6m X 5.2m 2.6m X 5.2m 2.6m X 6.7m 2.4m X 4.6m 3.4m X 5.2m 2.4m X 5.2m 3.5m X 7.0m 155 155 309 0	2 2024-11-01 ISSUED FOR SITE PLAN APPROVAL AYU 1 2024-01-30 ISSUED FOR PRE-CONSTRUCTION AYU # DATE DESCRIPTION BY
5 PLAN	ACCESSIBLE PARKING SPACES PROVIDED - (NOT IN TYPE 'A' TYPE 'B' TOTAL STANDARD PARKING SPACE PARALLEL PARKING SPACE SMALL PARKING SPACE ACCESSIBLE PARKING SPACE ' TYPE A ' ACCESSIBLE PARKING SPACE ' TYPE B ' LOADING SPACE BICYCLE PARKING SPACES REQUIRED RESIDENTIAL 0.5 PER UNIT (309 UNITS) TOTAL BICYCLE PARKING SPACES PROVIDED RESIDENTIAL INTERIOR EXTERIOR TOTAL 1.0 PER UNIT (309 UNITS) AMENITY AREA		4 7 ACE PARKING) 3 5 8 2.6m X 5.2m 2.6m X 5.2m 2.4m X 4.6m 3.4m X 5.2m 2.4m X 5.2m 3.5m X 7.0m 155 155 309 0 309	2 2024-11-01 ISSUED FOR SITE PLAN APPROVAL AYU 1 2024-01-30 ISSUED FOR PRE-CONSTRUCTION AYU # DATE DESCRIPTION BY
5 PLAN	ACCESSIBLE PARKING SPACES PROVIDED - (NOT IN TYPE 'A' TYPE 'B' TOTAL STANDARD PARKING SPACE PARALLEL PARKING SPACE SMALL PARKING SPACE ACCESSIBLE PARKING SPACE ' TYPE A ' ACCESSIBLE PARKING SPACE ' TYPE B ' LOADING SPACE BICYCLE PARKING SPACES REQUIRED RESIDENTIAL 0.5 PER UNIT (309 UNITS) TOTAL BICYCLE PARKING SPACES PROVIDED RESIDENTIAL INTERIOR EXTERIOR TOTAL 1.0 PER UNIT (309 UNITS) AMENITY AREA GRADE EXTERIOR - COMMUNAL INTERIOR - COMMUNAL	m ² 172.6 1,095.4	4 7 ACE PARKING) 3 5 8 2.6m X 5.2m 2.6m X 5.2m 2.6m X 6.7m 2.4m X 4.6m 3.4m X 5.2m 3.4m X 5.2m 3.5m X 7.0m 155 155 309 0 309 0 309 0 309 1,858 11,791	2 2024-11-01 ISSUED FOR SITE PLAN APPROVAL AYU 1 2024-01-30 ISSUED FOR PRE-CONSTRUCTION AYU # DATE DESCRIPTION BY ISSUED FOR SITE PLAN APPROVAL # DATE DESCRIPTION BY ISSUED FOR SITE PLAN APPROVAL # DATE DESCRIPTION BY
5 PLAN	ACCESSIBLE PARKING SPACES PROVIDED - (NOT IN TYPE 'A' TYPE 'B' TOTAL STANDARD PARKING SPACE PARALLEL PARKING SPACE SMALL PARKING SPACE ACCESSIBLE PARKING SPACE ' TYPE A ' ACCESSIBLE PARKING SPACE ' TYPE B ' LOADING SPACE BICYCLE PARKING SPACES REQUIRED RESIDENTIAL 0.5 PER UNIT (309 UNITS) TOTAL BICYCLE PARKING SPACES PROVIDED RESIDENTIAL INTERIOR EXTERIOR TOTAL 1.0 PER UNIT (309 UNITS) AMENITY AREA GRADE EXTERIOR - COMMUNAL	m ² 172.6	4 7 ACE PARKING) 3 5 8 2.6m X 5.2m 2.6m X 6.7m 2.4m X 4.6m 3.4m X 5.2m 2.4m X 5.2m 3.5m X 7.0m 155 155 309 0 309 0 309 1,858	2 2024-11-01 ISSUED FOR SITE PLAN APPROVAL AYU 1 2024-01-30 ISSUED FOR PRE-CONSTRUCTION AYU # DATE DESCRIPTION BY ISSUED FOR SITE PLAN APPROVAL # DATE DESCRIPTION BY ISSUED FOR SITE PLAN APPROVAL # DATE DESCRIPTION BY
5 PLAN	ACCESSIBLE PARKING SPACES PROVIDED - (NOT IN TYPE 'A' TYPE 'B' TOTAL STANDARD PARKING SPACE PARALLEL PARKING SPACE SMALL PARKING SPACE ACCESSIBLE PARKING SPACE ' TYPE A ' ACCESSIBLE PARKING SPACE ' TYPE B ' LOADING SPACE BICYCLE PARKING SPACES REQUIRED RESIDENTIAL 0.5 PER UNIT (309 UNITS) TOTAL BICYCLE PARKING SPACES PROVIDED RESIDENTIAL INTERIOR EXTERIOR TOTAL 1.0 PER UNIT (309 UNITS) AMENITY AREA GRADE EXTERIOR - COMMUNAL INTERIOR - COMMUNAL OTF EXTERIOR - COMMUNAL TOTAL COMMUNAL BALCONIES / TERRACE - PRIVATE	m ² 172.6 1,095.4 202.1 1,470.1 3,506.2	4 7 ACE PARKING) 3 5 8 2.6m X 5.2m 2.6m X 6.7m 2.4m X 4.6m 3.4m X 5.2m 2.4m X 5.2m 3.5m X 7.0m 155 155 309 0 309 0 309 0 309 0 309 0 309 155 155 155 155 155 155 155 15	2 2024-11-01 ISSUED FOR SITE PLAN APPROVAL AYU 1 2024-01-30 ISSUED FOR PRE-CONSTRUCTION AYU # DATE DESCRIPTION BY INTERCEMENTION # DESCRIPTION INTERCEMENTED PROJECT 500 COVENTRY ROAD
5 PLAN	ACCESSIBLE PARKING SPACES PROVIDED - (NOT IN TYPE 'A' TYPE 'B' TOTAL STANDARD PARKING SPACE PARALLEL PARKING SPACE SMALL PARKING SPACE ACCESSIBLE PARKING SPACE ' TYPE A ' ACCESSIBLE PARKING SPACE ' TYPE B ' LOADING SPACE BICYCLE PARKING SPACES REQUIRED RESIDENTIAL 0.5 PER UNIT (309 UNITS) TOTAL BICYCLE PARKING SPACES PROVIDED RESIDENTIAL INTERIOR EXTERIOR TOTAL 1.0 PER UNIT (309 UNITS) AMENITY AREA GRADE EXTERIOR - COMMUNAL INTERIOR - COMMUNAL TOTAL COMMUNAL	m² 172.6 1,095.4 202.1 1,470.1	4 7 ACE PARKING) 3 5 8 2.6m X 5.2m 2.6m X 6.7m 2.4m X 4.6m 3.4m X 5.2m 2.4m X 5.2m 3.5m X 7.0m 155 155 309 0 309 0 309 0 309 0 309 155 155 155 155 155 155 155 15	2 2024-11-01 ISSUED FOR SITE PLAN APPROVAL AYU 1 2024-01-30 ISSUED FOR PRE-CONSTRUCTION AYU # DATE DESCRIPTION BY INTERCONSTRUCTION # DATE DESCRIPTION BY INTERCONSTRUCTION PROJECT S00 COVENTRY ROAD, OTTAWA, ON.
5 PLAN	ACCESSIBLE PARKING SPACES PROVIDED - (NOT IN TYPE 'A' TYPE 'B' TOTAL STANDARD PARKING SPACE PARALLEL PARKING SPACE SMALL PARKING SPACE ACCESSIBLE PARKING SPACE ' TYPE A ' ACCESSIBLE PARKING SPACE ' TYPE B ' LOADING SPACE BICYCLE PARKING SPACES REQUIRED RESIDENTIAL 0.5 PER UNIT (309 UNITS) TOTAL BICYCLE PARKING SPACES PROVIDED RESIDENTIAL INTERIOR EXTERIOR TOTAL 1.0 PER UNIT (309 UNITS) AMENITY AREA GRADE EXTERIOR - COMMUNAL INTERIOR - COMMUNAL O7F EXTERIOR - COMMUNAL TOTAL BALCONIES / TERRACE - PRIVATE TOTAL	m ² 172.6 1,095.4 202.1 1,470.1 3,506.2	4 7 ACE PARKING) 3 5 8 2.6m X 5.2m 2.6m X 6.7m 2.4m X 4.6m 3.4m X 5.2m 2.4m X 5.2m 3.5m X 7.0m 155 155 309 0 309 0 309 0 309 0 309 0 309 155 155 155 155 155 155 155 15	2 2024-11-01 ISSUED FOR SITE PLAN APPROVAL AYU 1 2024-01-30 ISSUED FOR PRE-CONSTRUCTION AYU # DATE DESCRIPTION BY INTERCONSTRUCTION # DATE DESCRIPTION BY INTERCONSTRUCTION PROJECT S00 COVENTRY ROAD, OTTAWA, ON.
5 PLAN	ACCESSIBLE PARKING SPACES PROVIDED - (NOT IN TYPE 'A' TYPE 'B' TOTAL STANDARD PARKING SPACE PARALLEL PARKING SPACE SMALL PARKING SPACE ACCESSIBLE PARKING SPACE ' TYPE A ' ACCESSIBLE PARKING SPACE ' TYPE B ' LOADING SPACE BICYCLE PARKING SPACES REQUIRED RESIDENTIAL 0.5 PER UNIT (309 UNITS) TOTAL BICYCLE PARKING SPACES PROVIDED RESIDENTIAL INTERIOR EXTERIOR TOTAL 1.0 PER UNIT (309 UNITS) AMENITY AREA GRADE EXTERIOR - COMMUNAL INTERIOR - COMMUNAL O7F EXTERIOR - COMMUNAL TOTAL 5 / TERRACE - PRIVATE TOTAL BALCONIES / TERRACE - PRIVATE TOTAL REQUIRED (309 UNITS X 6 m²) = 1,854 sq. m.	m ² 172.6 1,095.4 202.1 1,470.1 3,506.2	4 7 ACE PARKING) 3 5 8 2.6m X 5.2m 2.6m X 6.7m 2.4m X 4.6m 3.4m X 5.2m 2.4m X 5.2m 3.5m X 7.0m 155 155 309 0 309 0 309 0 309 0 309 0 309 155 155 155 155 155 155 155 15	2 2024-11-01 ISSUED FOR SITE PLAN APPROVAL AYU 1 2024-01-30 ISSUED FOR PRE-CONSTRUCTION AYU # DATE DESCRIPTION BY OPOJECT PROJECT S00 COVENTRY ROAD, OTTAWA, ON. DRAWING
5 PLAN	ACCESSIBLE PARKING SPACES PROVIDED - (NOT IN TYPE 'A' TYPE 'B' TOTAL STANDARD PARKING SPACE PARALLEL PARKING SPACE SMALL PARKING SPACE ACCESSIBLE PARKING SPACE ' TYPE A ' ACCESSIBLE PARKING SPACE ' TYPE B ' LOADING SPACE BICYCLE PARKING SPACES REQUIRED RESIDENTIAL 0.5 PER UNIT (309 UNITS) TOTAL BICYCLE PARKING SPACES PROVIDED RESIDENTIAL INTERIOR EXTERIOR TOTAL 1.0 PER UNIT (309 UNITS) AMENITY AREA GRADE EXTERIOR - COMMUNAL INTERIOR - COMMUNAL 07F EXTERIOR - COMMUNAL D7F EXTERIOR - COMMUNAL BALCONIES / TERRACE - PRIVATE TOTAL REQUIRED (309 UNITS X 6 m ²) = 1,854 sq. m. REQUIRED COMMUNAL @ 50% = 927 sq. m.	m² 172.6 1,095.4 202.1 1,470.1 3,506.2 4,976.3	4 7 ACE PARKING) 3 5 8 2.6m X 5.2m 2.6m X 5.2m 2.6m X 6.7m 2.4m X 4.6m 3.4m X 5.2m 2.4m X 5.2m 3.5m X 7.0m 155 155 309 0 309 30 309 30 30 30 30 30 30 30 30 30 30 30 30 30	2 2024-11-01 ISSUED FOR SITE PLAN APPROVAL AYU 1 2024-01-30 ISSUED FOR PRE-CONSTRUCTION AYU # DATE DESCRIPTION BY INTERCEMENTION DESCRIPTION INTERCEMENTION PROJECT DOD COVENTRY ROAD 500 COVENTRY ROAD, OTTAWA, ON. DRAWING FLOOR 01
5 PLAN	ACCESSIBLE PARKING SPACES PROVIDED - (NOT IN TYPE 'A' TYPE 'B' TOTAL STANDARD PARKING SPACE PARALLEL PARKING SPACE SMALL PARKING SPACE ACCESSIBLE PARKING SPACE ' TYPE A ' ACCESSIBLE PARKING SPACE ' TYPE B ' LOADING SPACE BICYCLE PARKING SPACES REQUIRED RESIDENTIAL 0.5 PER UNIT (309 UNITS) TOTAL BICYCLE PARKING SPACES PROVIDED RESIDENTIAL INTERIOR EXTERIOR TOTAL 1.0 PER UNIT (309 UNITS) AMENITY AREA GRADE EXTERIOR - COMMUNAL INTERIOR - COMMUNAL O7F EXTERIOR - COMMUNAL TOTAL COMMUNAL BALCONIES / TERRACE - PRIVATE TOTAL REQUIRED (309 UNITS X 6 m ²) = 1,854 sq. m. REQUIRED COMMUNAL @ 50% = 927 sq. m. SITE COVERAGE BUILDING FOOTPRINT DRIVING SURFACE	m ² 172.6 1,095.4 202.1 1,470.1 3,506.2 4,976.3 m ² 1,815.4 1,260.5	4 7 ACE PARKING) 3 5 8 2.6m X 5.2m 2.6m X 5.2m 2.6m X 6.7m 2.4m X 4.6m 3.4m X 5.2m 2.4m X 5.2m 3.5m X 7.0m 155 155 309 0 309 0 309 0 309 0 309 0 309 0 309 0 309 0 309 0 309 0 309 0 309 0 309 0 309	2 2024-11-01 ISSUED FOR SITE PLAN APPROVAL AYU 1 2024-01-30 ISSUED FOR PRE-CONSTRUCTION AYU # DATE DESCRIPTION BY INTERCEMENTION DESCRIPTION INTERCEMENTION PROJECT DOD COVENTRY ROAD 500 COVENTRY ROAD, OTTAWA, ON. DRAWING FLOOR 01
5 PLAN	ACCESSIBLE PARKING SPACES PROVIDED - (NOT IN TYPE 'A' TYPE 'B' TOTAL STANDARD PARKING SPACE PARALLEL PARKING SPACE SMALL PARKING SPACE ACCESSIBLE PARKING SPACE ' TYPE A ' ACCESSIBLE PARKING SPACE ' TYPE B ' LOADING SPACE BICYCLE PARKING SPACES REQUIRED RESIDENTIAL 0.5 PER UNIT (309 UNITS) TOTAL BICYCLE PARKING SPACES PROVIDED RESIDENTIAL INTERIOR EXTERIOR TOTAL 1.0 PER UNIT (309 UNITS) AMENITY AREA GRADE EXTERIOR - COMMUNAL INTERIOR - COMMUNAL 07F EXTERIOR - COMMUNAL TOTAL COMMUNAL BALCONIES / TERRACE - PRIVATE TOTAL REQUIRED (309 UNITS X 6 m²) = 1,854 sq. m. REQUIRED COMMUNAL @ 50% = 927 sq. m. SITE COVERAGE BUILDING FOOTPRINT	m² 172.6 1,095.4 202.1 1,470.1 3,506.2 4,976.3 m² 1,815.4	4 7 ACE PARKING) 3 5 8 2.6m X 5.2m 2.6m X 5.2m 2.6m X 6.7m 2.4m X 4.6m 3.4m X 5.2m 2.4m X 5.2m 3.5m X 7.0m 155 155 309 0 309 309	2 2024-11-01 ISSUED FOR SITE PLAN APPROVAL AYU 1 2024-01-30 ISSUED FOR SITE PLAN APPROVAL AYU 1 2024-01-30 ISSUED FOR PRE-CONSTRUCTION AYU # DATE DESCRIPTION BY OPOJECT PROJECT DO COVENTRY ROAD, OTTAWA, ON. DRAWING FLOOR 01 PROJECT NO. 18.050 P01 PROJECT NO.
5 PLAN	ACCESSIBLE PARKING SPACES PROVIDED - (NOT IN TYPE 'A' TYPE 'B' TOTAL STANDARD PARKING SPACE PARALLEL PARKING SPACE SMALL PARKING SPACE ACCESSIBLE PARKING SPACE ' TYPE A ' ACCESSIBLE PARKING SPACE ' TYPE B ' LOADING SPACE BICYCLE PARKING SPACES REQUIRED RESIDENTIAL 0.5 PER UNIT (309 UNITS) TOTAL BICYCLE PARKING SPACES PROVIDED RESIDENTIAL INTERIOR EXTERIOR TOTAL 1.0 PER UNIT (309 UNITS) AMENITY AREA GRADE EXTERIOR - COMMUNAL INTERIOR - COMMUNAL 07F EXTERIOR - COMMUNAL TOTAL COMMUNAL BALCONIES / TERRACE - PRIVATE TOTAL REQUIRED (309 UNITS X 6 m²) = 1,854 sq. m. REQUIRED COMMUNAL @ 50% = 927 sq. m. SITE COVERAGE BUILDING FOOTPRINT DRIVING SURFACE LANDSCAPE AREA	m ² 172.6 1,095.4 202.1 1,470.1 3,506.2 4,976.3 m ² 1,815.4 1,260.5 2,249.6	4 7 ACE PARKING) 3 5 8 2.6m X 5.2m 2.6m X 6.7m 2.4m X 4.6m 3.4m X 5.2m 2.4m X 5.2m 3.5m X 7.0m 155 155 309 0 309 30 309 0 309 0 309 0 309 0 309 30 30 30 30 30 30 30 30 30 30	2 2024-11-01 ISSUED FOR SITE PLAN APPROVAL AYU 1 2024-01-30 ISSUED FOR PRE-CONSTRUCTION AYU # DATE DESCRIPTION BY INCOMPRE-CONSTRUCTION
5 PLAN	ACCESSIBLE PARKING SPACES PROVIDED - (NOT IN TYPE 'A' TYPE 'B' TOTAL STANDARD PARKING SPACE PARALLEL PARKING SPACE SMALL PARKING SPACE ACCESSIBLE PARKING SPACE ' TYPE A ' ACCESSIBLE PARKING SPACE ' TYPE B ' LOADING SPACE BICYCLE PARKING SPACES REQUIRED RESIDENTIAL 0.5 PER UNIT (309 UNITS) TOTAL BICYCLE PARKING SPACES PROVIDED RESIDENTIAL INTERIOR EXTERIOR TOTAL 1.0 PER UNIT (309 UNITS) AMENITY AREA GRADE EXTERIOR - COMMUNAL INTERIOR - COMMUNAL 07F EXTERIOR - COMMUNAL O7F EXTERIOR - COMMUNAL TOTAL COMMUNAL BALCONIES / TERRACE - PRIVATE TOTAL REQUIRED (309 UNITS X 6 m²) = 1,854 sq. m. REQUIRED COMMUNAL @ 50% = 927 sq. m. SITE COVERAGE BUILDING FOOTPRINT DRIVING SURFACE LANDSCAPE AREA TOTAL BUILDING A REFUGE REQUIREMENT (309 UNITS)	m ² 172.6 1,095.4 202.1 1,470.1 3,506.2 4,976.3 m ² 1,815.4 1,260.5 2,249.6 5,325.5	4 7 ACE PARKING) 3 5 8 2.6m X 5.2m 2.6m X 5.2m 2.6m X 6.7m 2.4m X 4.6m 3.4m X 5.2m 2.4m X 5.2m 3.5m X 7.0m 155 155 309 0 309 30 30 30 30 30 30 30 30 30 30 30 30 30	2 2024-11-01 ISSUED FOR SITE PLAN APPROVAL AYU 1 2024-01-30 ISSUED FOR PRE-CONSTRUCTION AYU # DATE DESCRIPTION BY INCONCECTION AYU # DATE DESCRIPTION BY INCONCECTION PROJECT PROJECT DO COVENTRY ROAD, OTTAWA, ON. DRAWING FLOOR 01 PROJECT NO. 18.050 P01 PROJECT TATE PROJECT TATE 2024-09-13 DRAWINBY RYT / DRO CHECKED BY ASSOUT
	ACCESSIBLE PARKING SPACES PROVIDED - (NOT IN TYPE 'A' TYPE 'B' TOTAL STANDARD PARKING SPACE PARALLEL PARKING SPACE SMALL PARKING SPACE ACCESSIBLE PARKING SPACE ' TYPE A ' ACCESSIBLE PARKING SPACE ' TYPE B ' LOADING SPACE BICYCLE PARKING SPACES REQUIRED RESIDENTIAL 0.5 PER UNIT (309 UNITS) TOTAL BICYCLE PARKING SPACES PROVIDED RESIDENTIAL INTERIOR EXTERIOR TOTAL 1.0 PER UNIT (309 UNITS) AMENITY AREA GRADE EXTERIOR - COMMUNAL INTERIOR - COMMUNAL INTERIOR - COMMUNAL O7F EXTERIOR - COMMUNAL TOTAL BALCONIES / TERRACE - PRIVATE TOTAL REQUIRED (309 UNITS X 6 m²) = 1,854 sq. m. REQUIRED COMMUNAL @ 50% = 927 sq. m. SITE COVERAGE BUILDING FOOTPRINT DRIVING SURFACE LANDSCAPE AREA TOTAL BUILDING A REFUGE REQUIREMENT (309 UNITS)	m² 172.6 1,095.4 202.1 1,095.4 202.1 1,470.1 3,506.2 4,976.3 1,815.4 1,260.5 2,249.6 5,325.5 PACTED RATIO 0.053 yd³/UNIT 0.018 yd³/UNIT	4 7 ACE PARKING) 3 5 8 2.6m X 5.2m 2.6m X 5.2m 2.6m X 6.7m 2.4m X 4.6m 3.4m X 5.2m 3.4m X 5.2m 3.5m X 7.0m 155 155 309 0 309 30 30 30 30 30 30 30 30 30 30 30 30 30	2 2024-11-01 ISSUED FOR SITE PLAN APPROVAL AYU 1 2024-01-30 ISSUED FOR PRE-CONSTRUCTION AYU # DATE DESCRIPTION BY INCOMPRESSION CONSTRUCTION
5 PLAN	ACCESSIBLE PARKING SPACES PROVIDED - (NOT IN TYPE 'A' TYPE 'B' TOTAL STANDARD PARKING SPACE PARALLEL PARKING SPACE SMALL PARKING SPACE SMALL PARKING SPACE SMALL PARKING SPACE ' TYPE A ' ACCESSIBLE PARKING SPACE ' TYPE B ' LOADING SPACE BICYCLE PARKING SPACES REQUIRED RESIDENTIAL 0.5 PER UNIT (309 UNITS) TOTAL BICYCLE PARKING SPACES PROVIDED RESIDENTIAL INTERIOR EXTERIOR TOTAL 1.0 PER UNIT (309 UNITS) AMENITY AREA GRADE EXTERIOR - COMMUNAL INTERIOR - COMMUNAL 07F EXTERIOR - COMMUNAL TOTAL COMMUNAL BALCONIES / TERRACE - PRIVATE TOTAL REQUIRED (309 UNITS X 6 m²) = 1,854 sq. m. REQUIRED COMMUNAL @ 50% = 927 sq. m. SITE COVERAGE BUILDING FOOTPRINT DRIVING SURFACE LANDSCAPE AREA TOTAL BUILDING A REFUGE REQUIREMENT (309 UNITS)	m ² 172.6 1,095.4 202.1 1,470.1 3,506.2 4,976.3	4 7 ACE PARKING) 3 5 8 2.6m X 5.2m 2.6m X 5.2m 2.6m X 6.7m 2.4m X 4.6m 3.4m X 5.2m 2.4m X 5.2m 3.5m X 7.0m 155 155 309 0 309 30 30 30 30 30 30 30 30 30 30 30 30 30	2 2024-11-01 ISSUED FOR SITE PLAN APPROVAL AYU 1 2024-01-30 ISSUED FOR PRE-CONSTRUCTION AYU # DATE DESCRIPTION BY INCONCECTION AYU # DATE DESCRIPTION BY INCONCECTION PROJECT PROJECT DO COVENTRY ROAD, OTTAWA, ON. DRAWING FLOOR 01 PROJECT NO. 18.050 P01 PROJECT TATE PROJECT TATE 2024-09-13 DRAWINBY RYT / DRO CHECKED BY ASSOUT

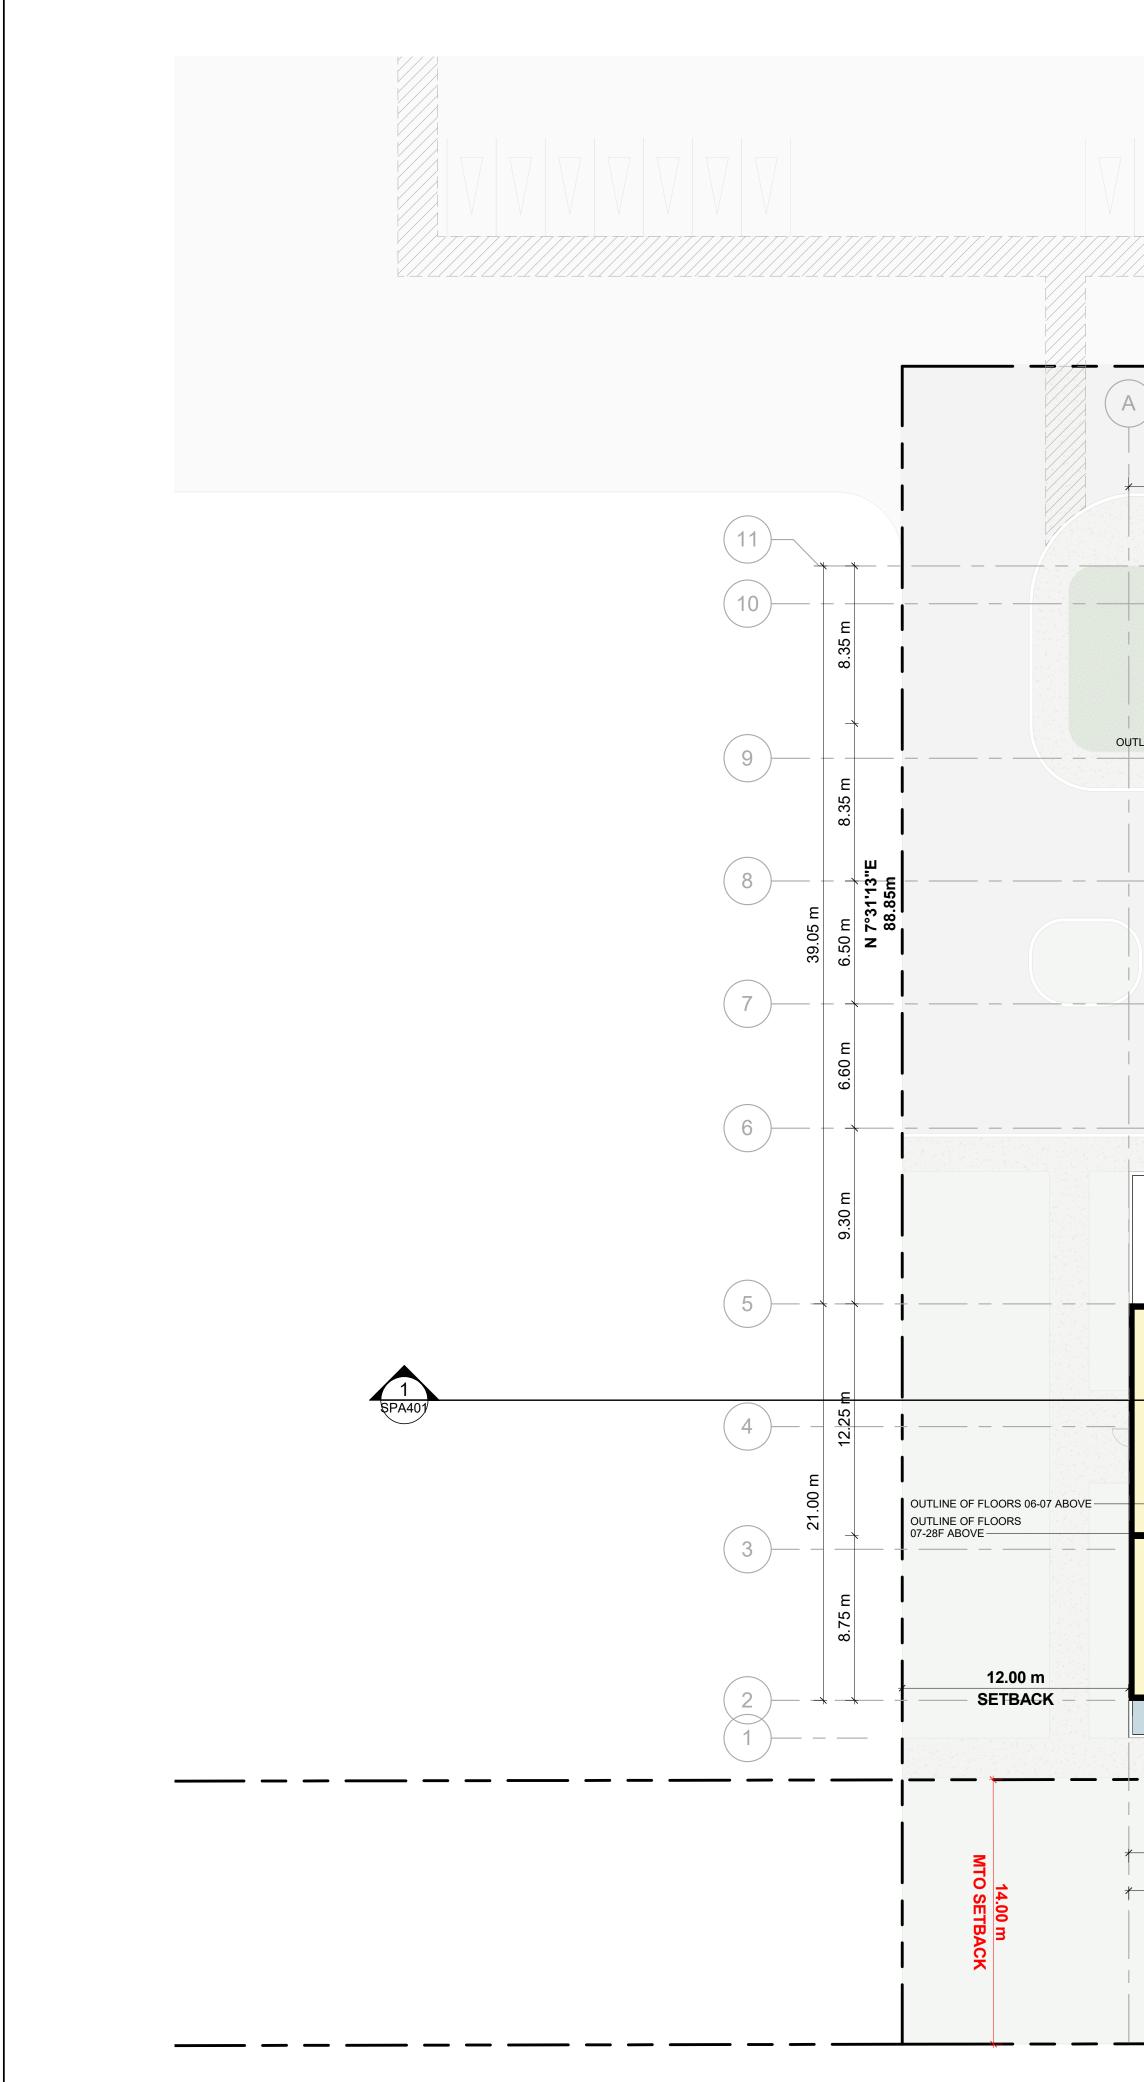

N 82°28'47"W 59.97m (C)В (D)(E (F ЕŊ 10.55 I SETBA 10.45 m 25.00 m 12.25 m 10.75 m -2.10 m 2.00 m OUTLINE OF FLOOR 06 ABOVE + 4 -___'__ _____ 20 2B+D(BF) ± 90 m² ± 968 ft² **3B(BF)** ± 103.7 m² ± 1117 ft² 10 OUTLINE OF FLOOR 06 ABOVE 1B+D(BF) ± 66.5 m² ± 716 ft² 1B+D(BF) ± 67.8 m² ± 730 ft² ഗ –1.50 m **<u>1B</u>** ± 58.3 m² ± 628 ft² **1B+D** ± 63 m² ± 678 ft² 50 9 1B+D(BF) ± 63.8 m² ± 687 ft² 1B+D(BF) ± 67.1 m² ± 722 ft² Γī $\mathbf{\times}$ 02 PRIVACY SCRENS-00 2B+D(BF) ± 82.9 m² ± 892 ft² **1B+D** ± 64 m² ± 689 ft² E RÓOF .30 S S TERRACE F.F. 6.50 m **1B+D** ± 61.8 m² ± 666 ft² **3B(BF)** ± 100.5 m² ± 1082 ft² 2B+D(BF) ± 99.5 m² ± 1011 ft² €HUF 1B+D(BF) ± 64 m² ± 689 ft² 50 9 2B(BF) ± 76.2 m² ± 821 ft² 2B(BF) ± 70.1 m² ± 755 ft² 2B+D(BF) ± 88.3 m² ± 950 ft² **1B** ± 52.1 m² ± 561 ft² 8 12.50 m SETBACK TERRACE PRIVACY SCRENS 8 Ś 9.80 m 11.50 m 7.80 m 6.40 m **町**6 35.45 m .10 m "BACK

N 83°33'50"E 182.85m













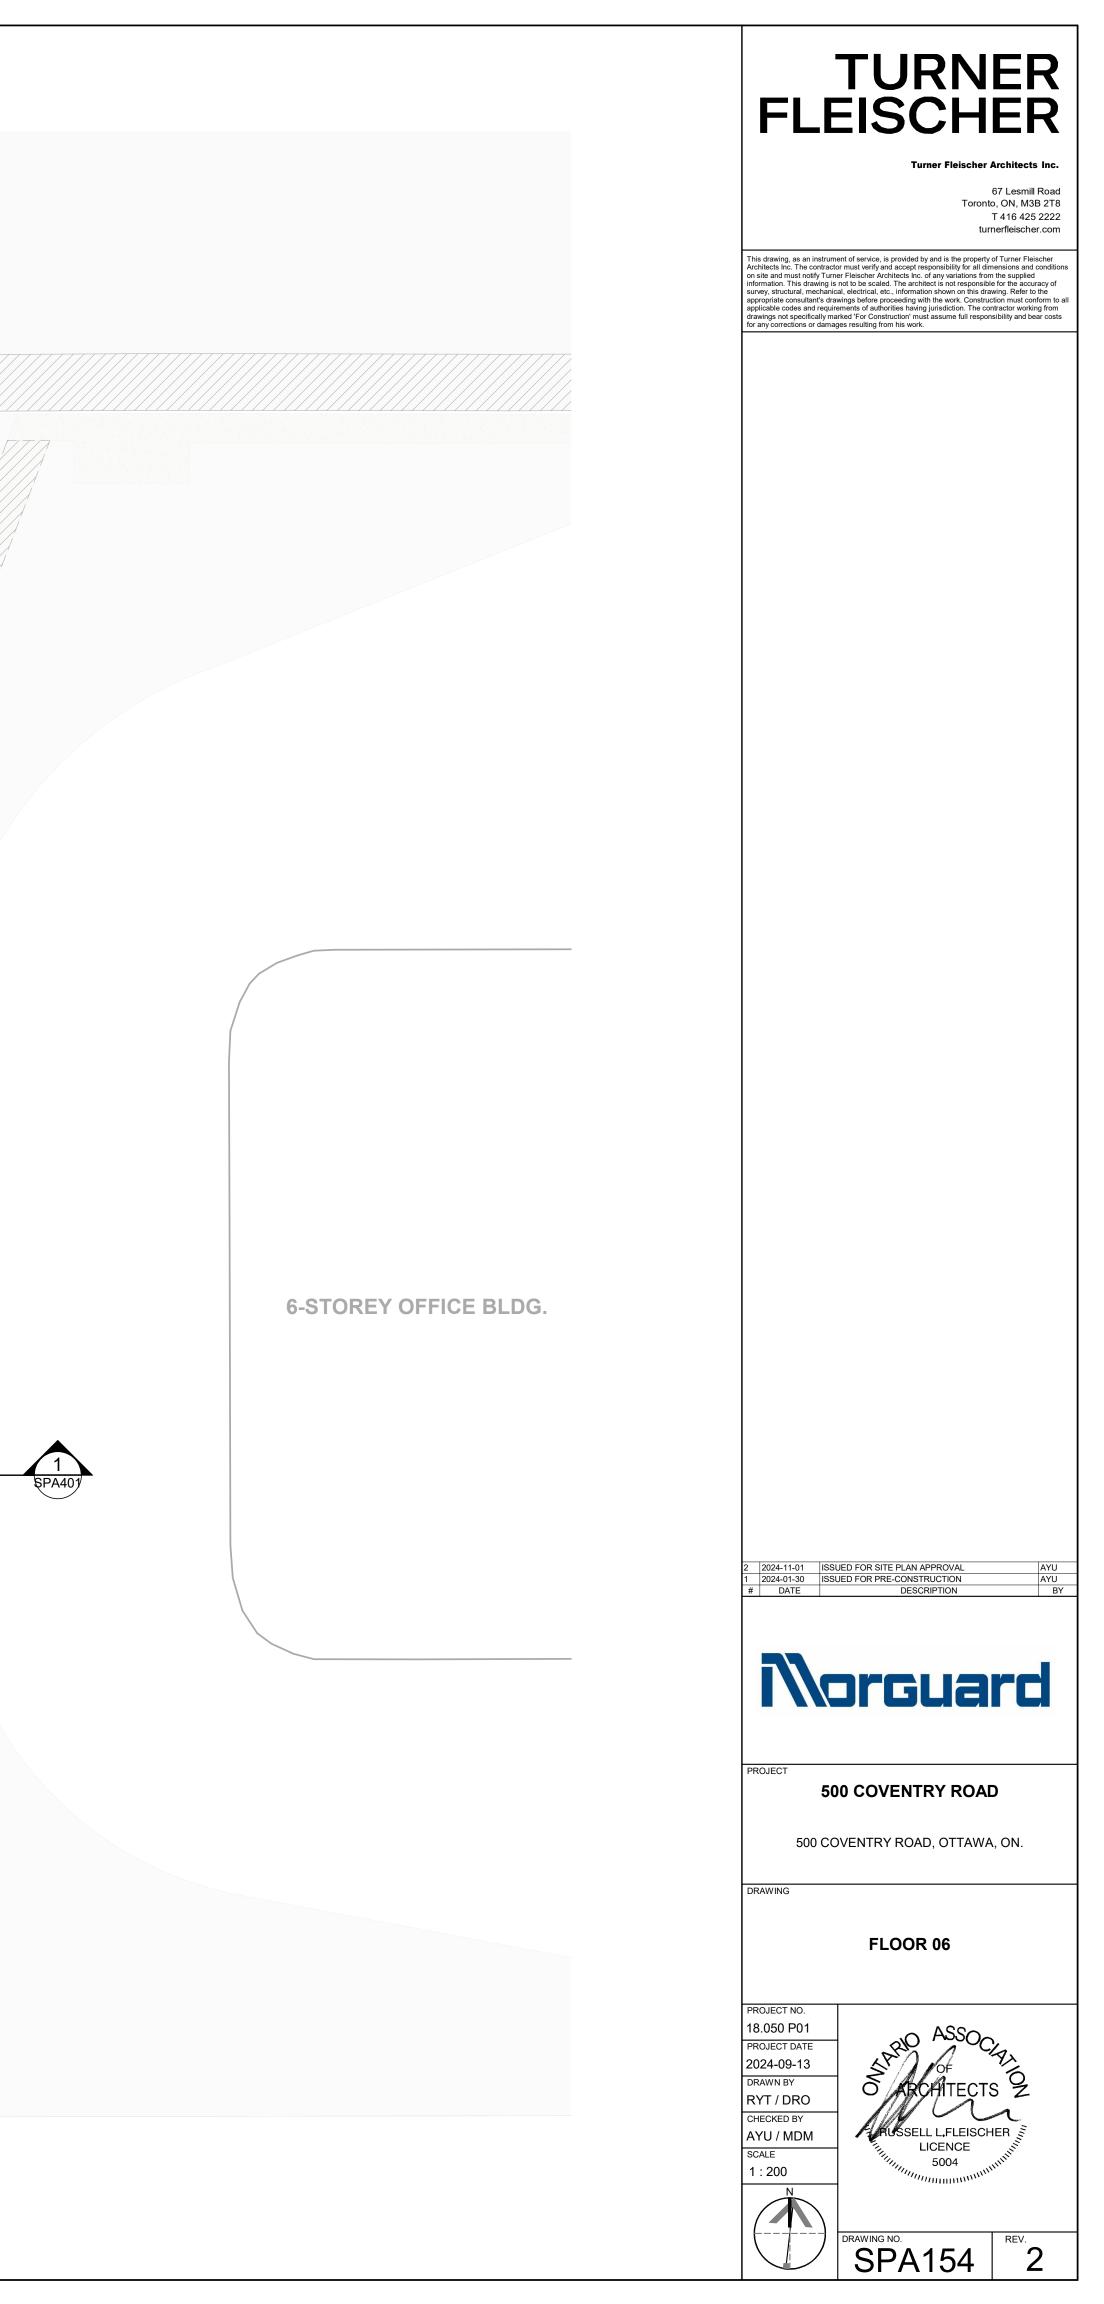






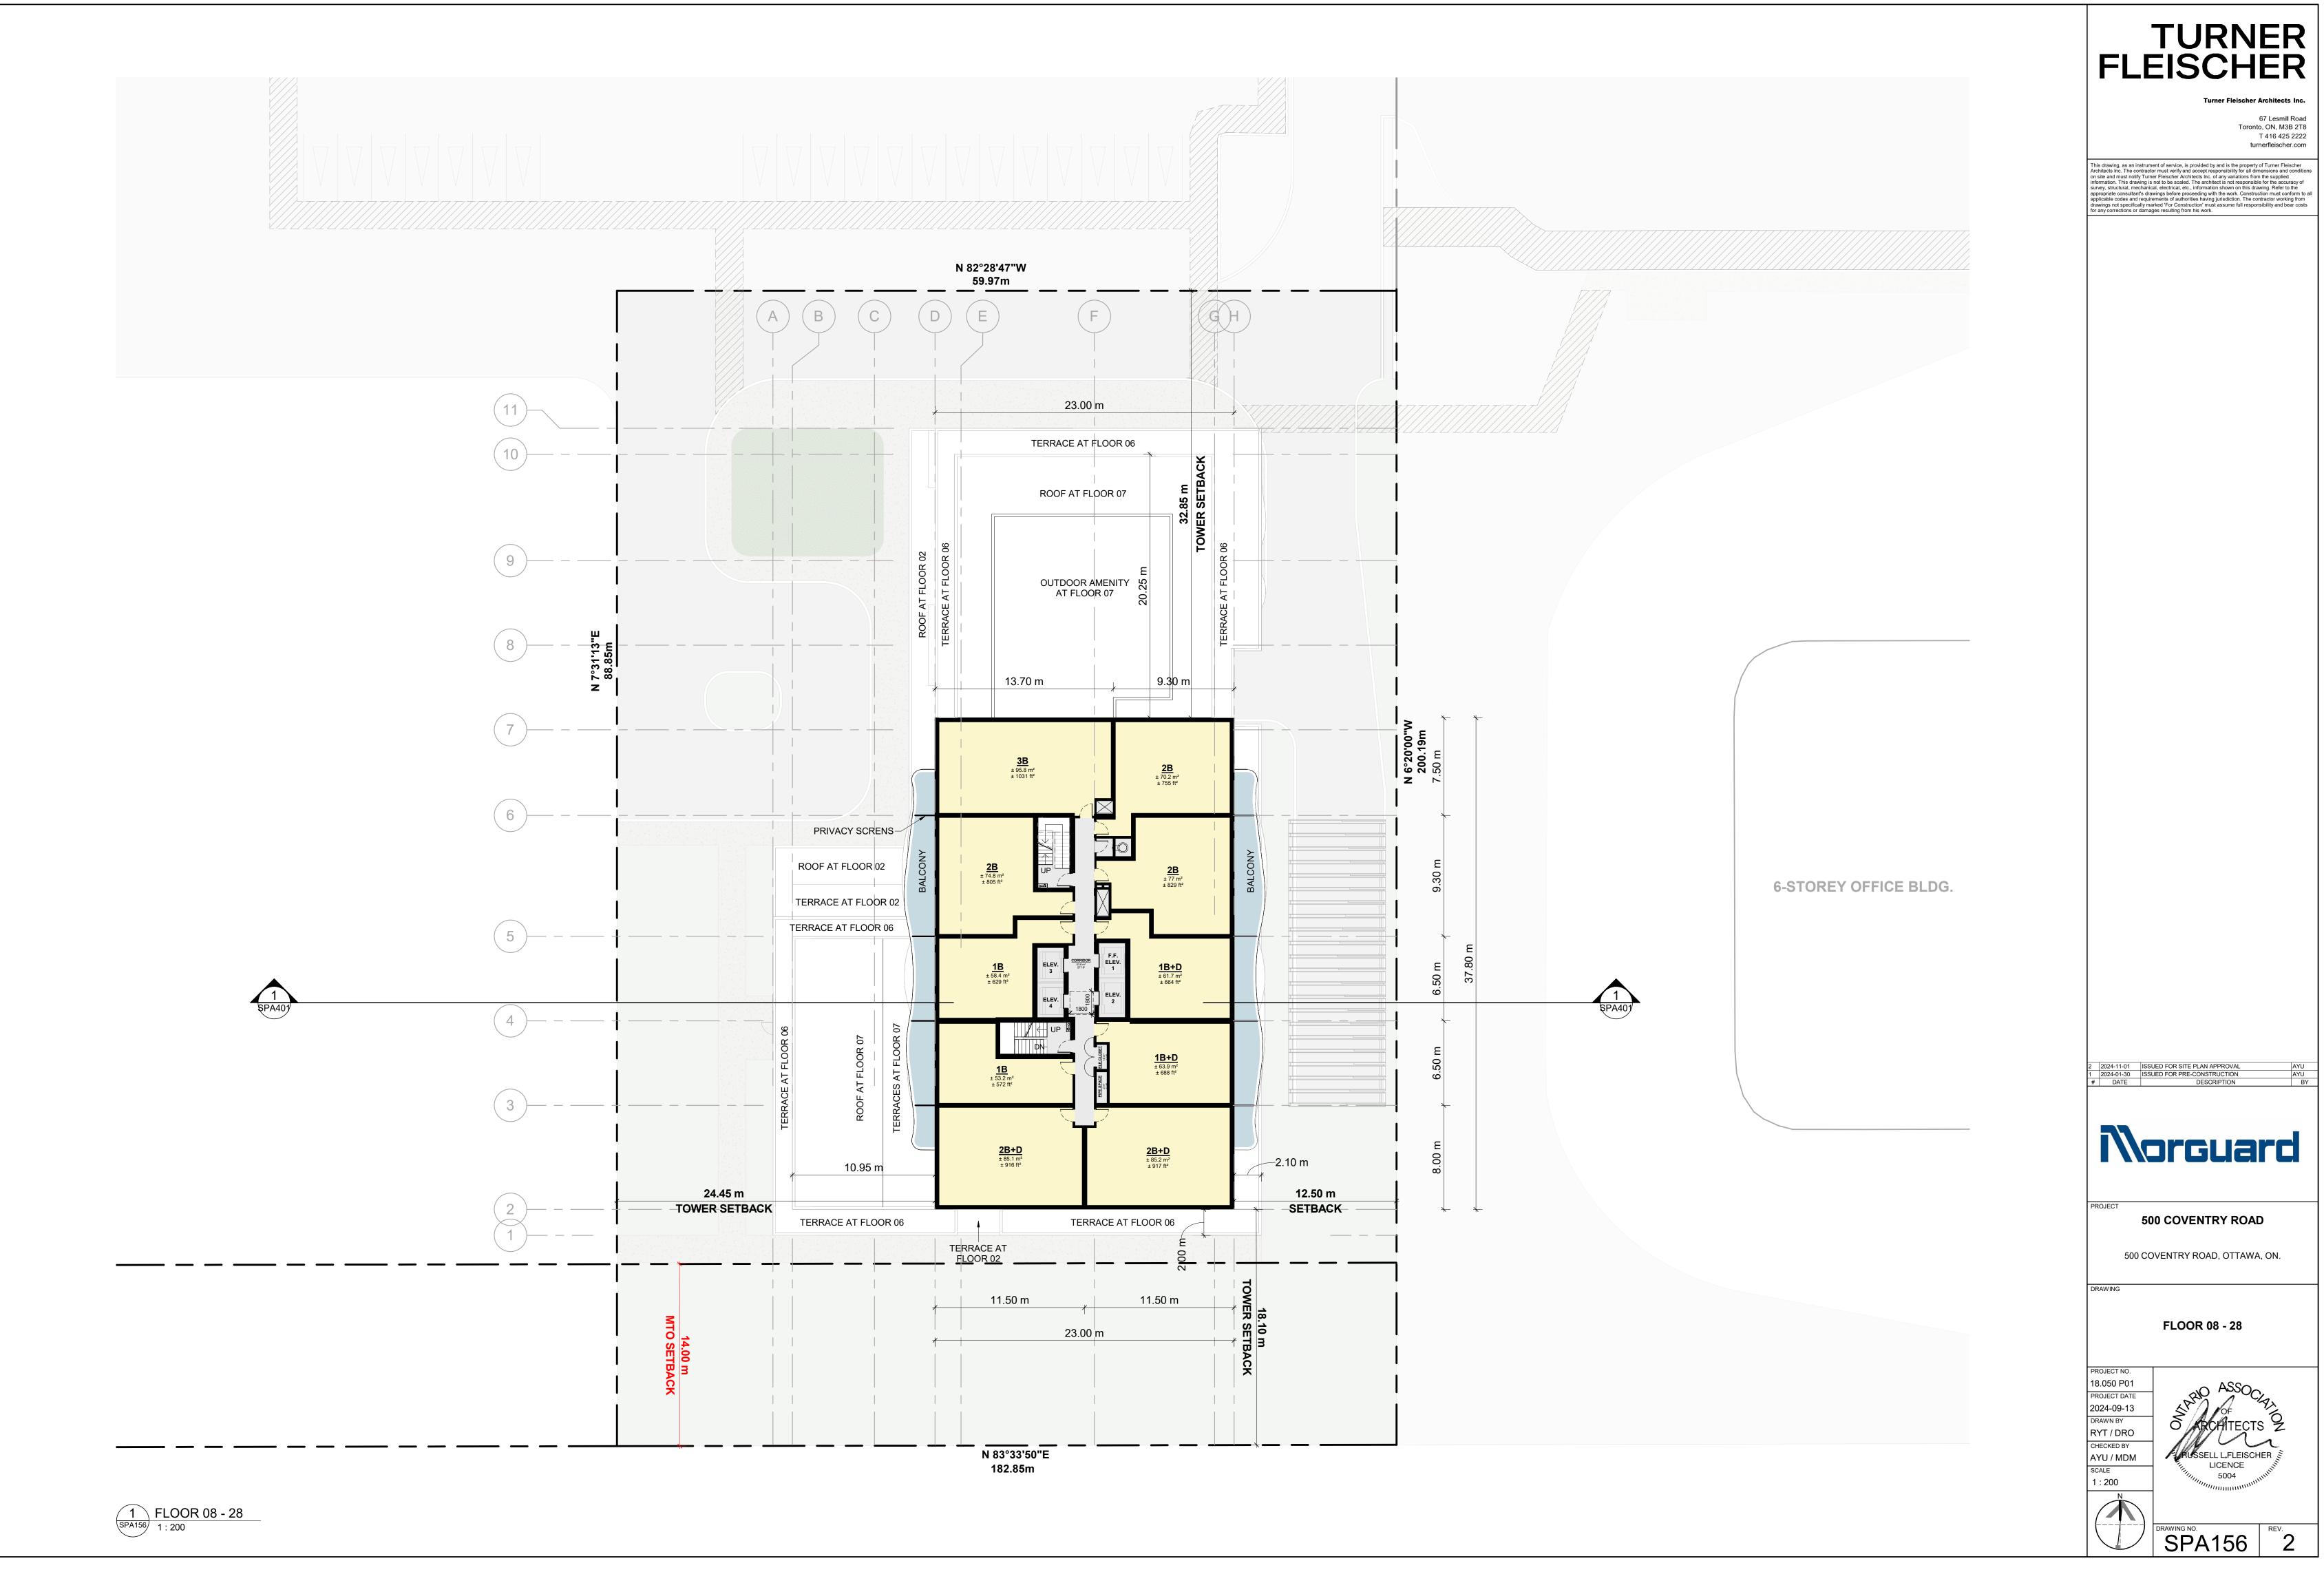



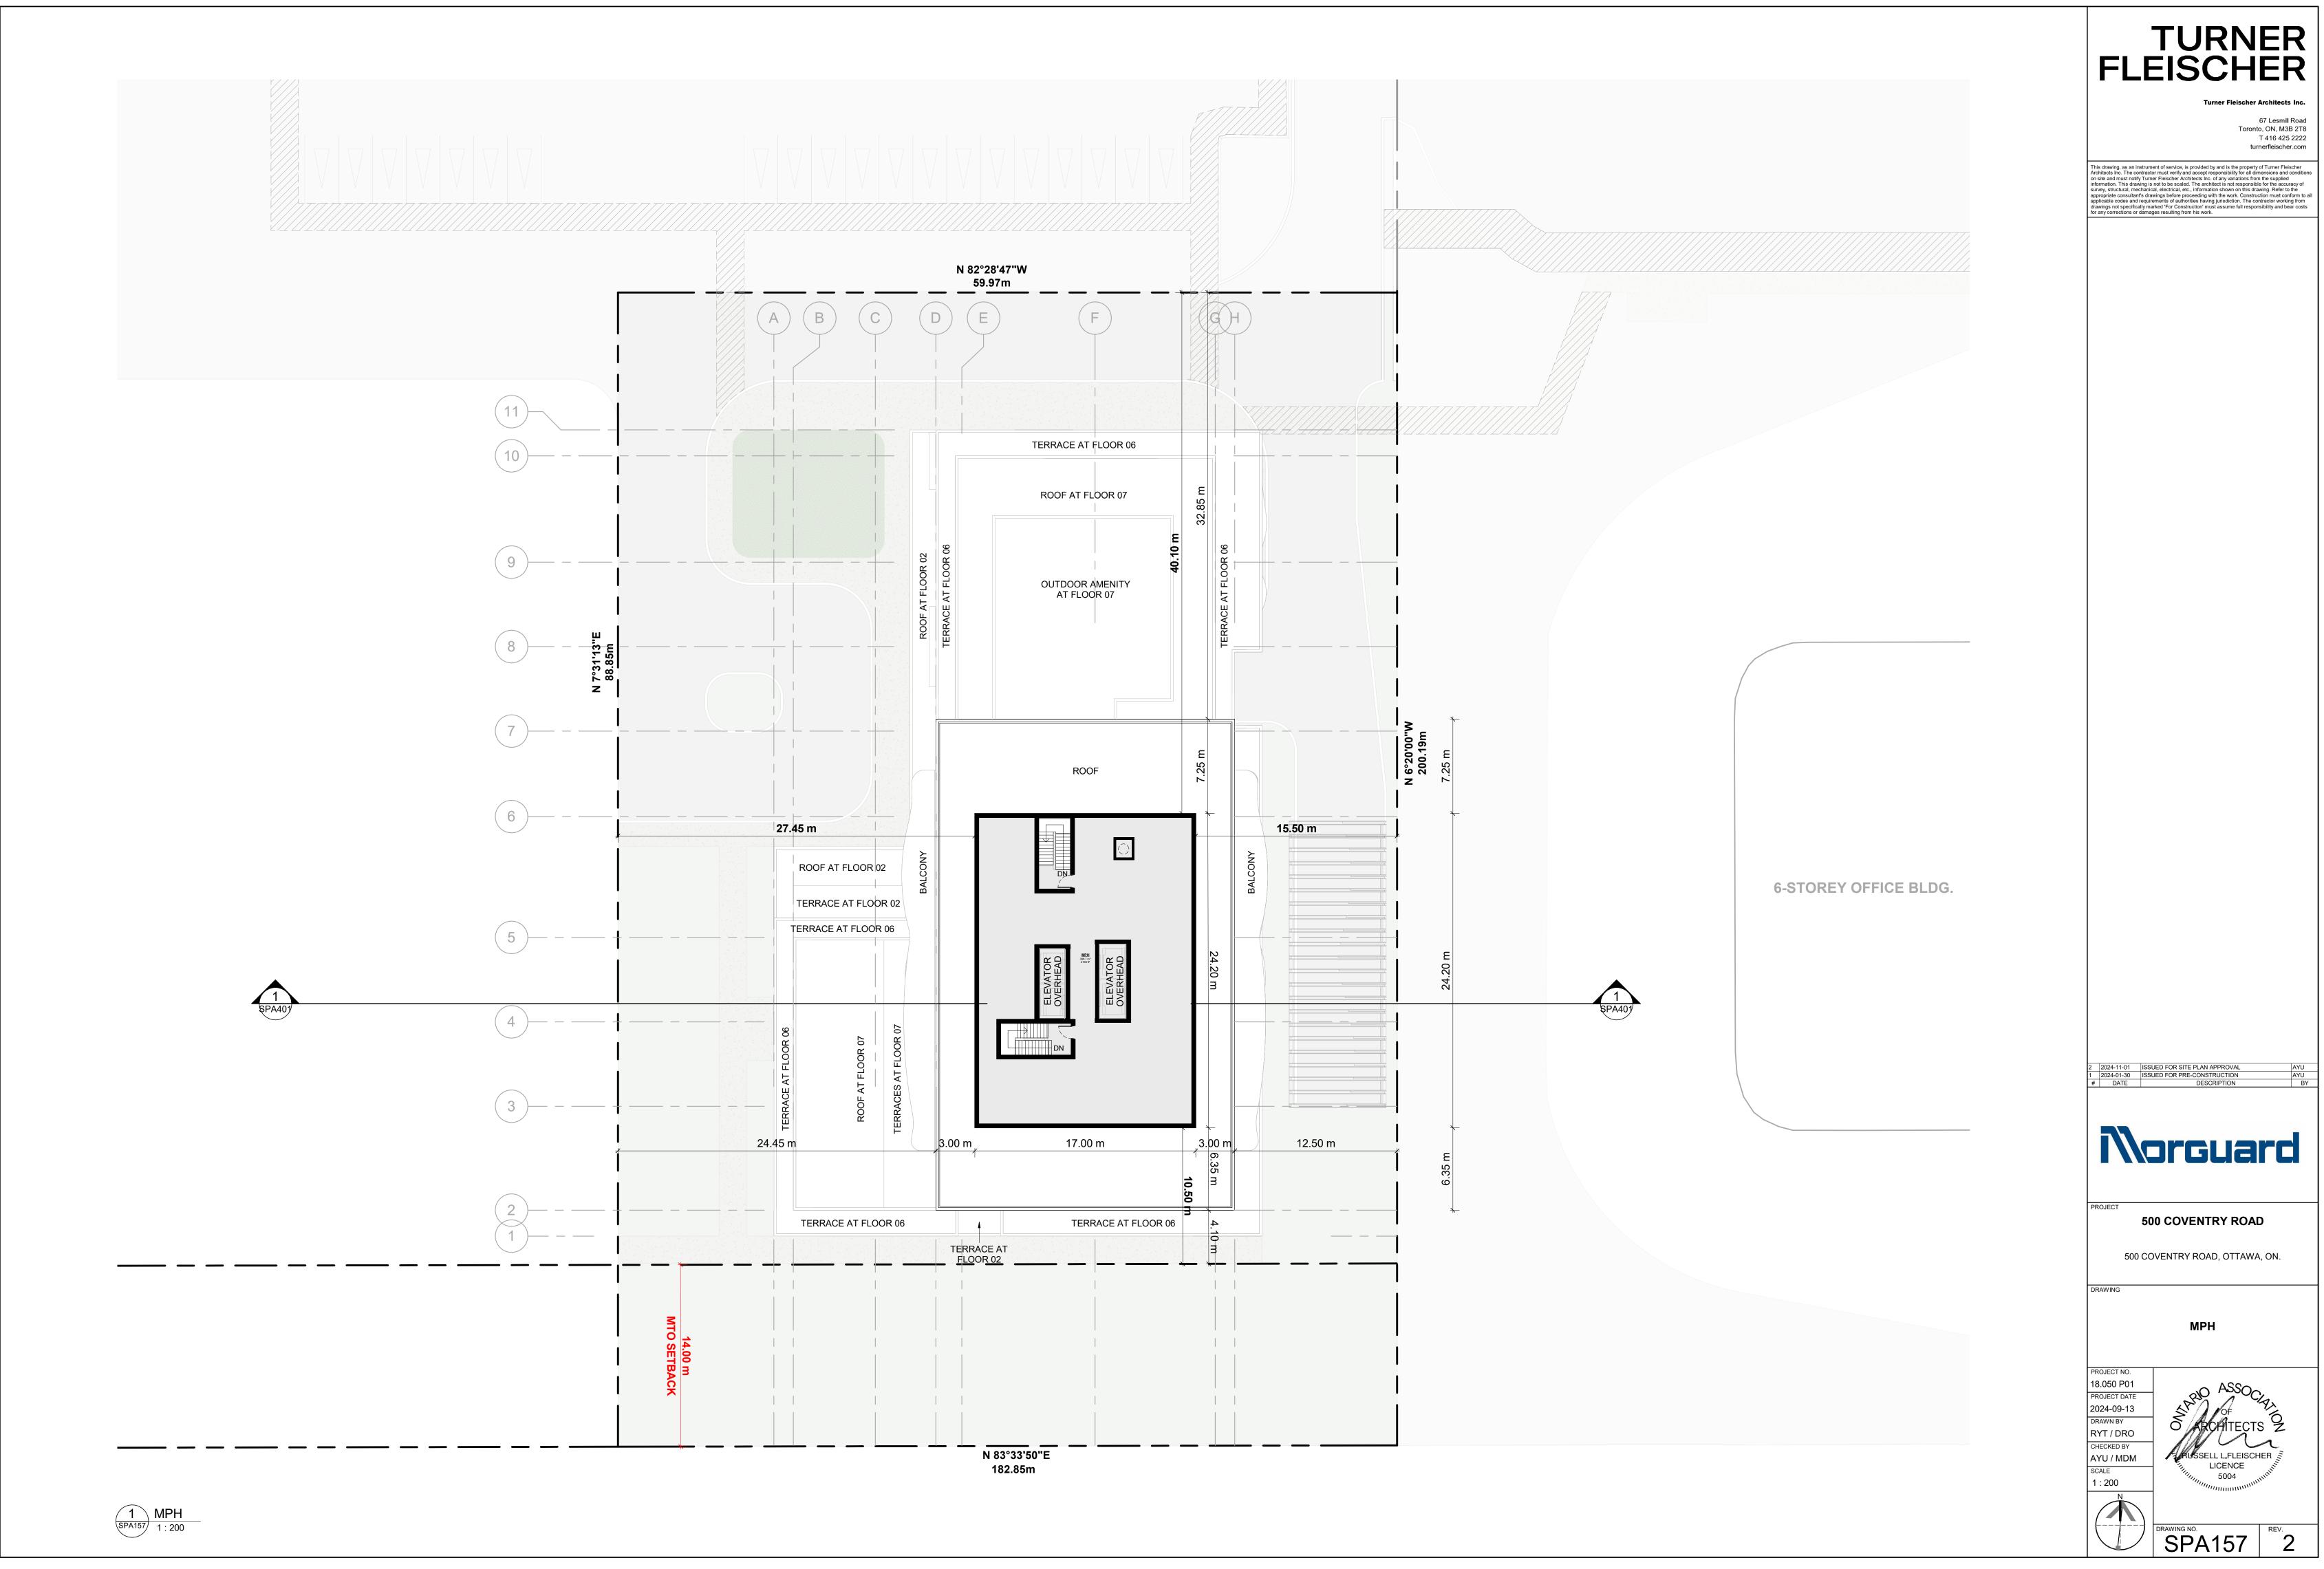






BLDG A



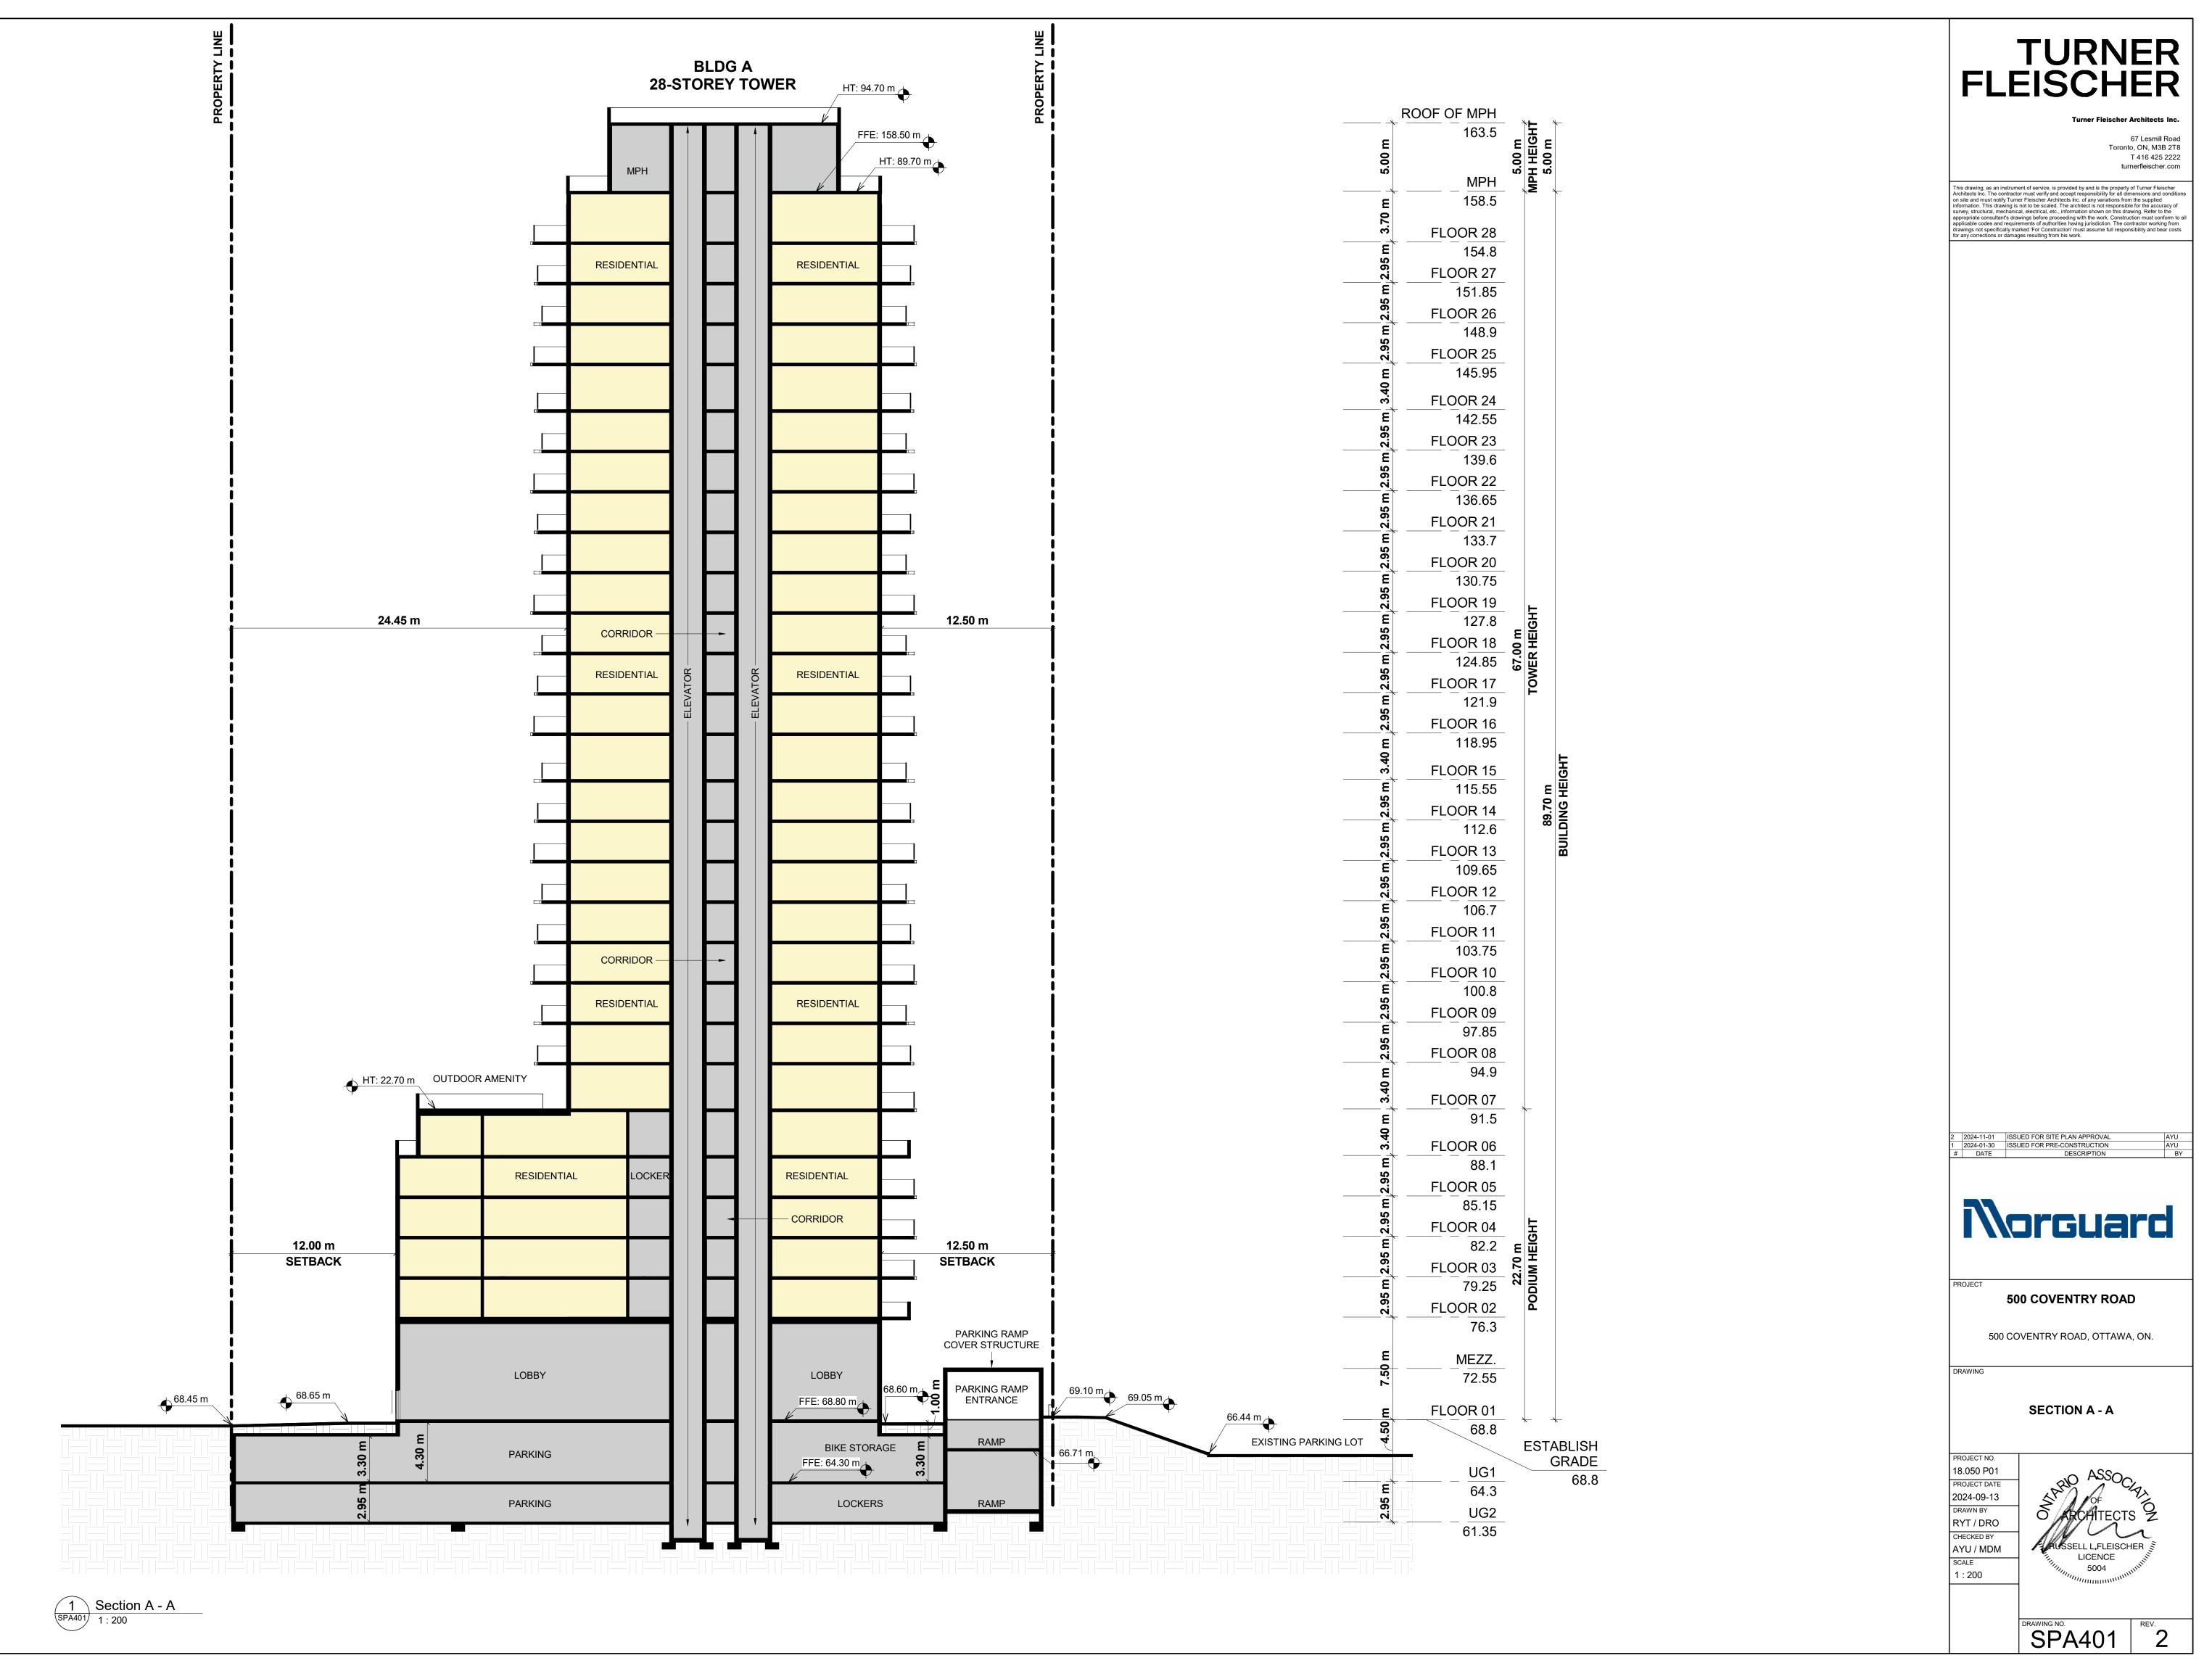



VIEW FROM TRANS-CANADA HWY LOOKING NORTH WEST



67 Lesmill Road Toronto, ON, M3B 2T8 T 416 425 2222 turnerfleischer.com



 1
 2024-11-01
 ISSUED FOR SITE PLAN APPROVAL

 #
 DATE
 DESCRIPTION

500 COVENTRY ROAD

500 COVENTRY ROAD, OTTAWA, ON.

RAWING

3D PERSPECTIVES

PROJECT NO. 18.050 P01 PROJECT DATE 2024-09-13 DRAWN BY EHS CHECKED BY AYU SCALE



DRAWING NO. SPA801

T REV.



VIEW FROM TRANS-CANADA HWY LOOKING NORTH EAST



Turner Fleischer Architects Inc.

67 Lesmill Road Toronto, ON, M3B 2T8 T 416 425 2222 turnerfleischer.com



 2024-11-01
 ISSUED FOR SITE PLAN APPROVAL


 #
 DATE
 DESCRIPTION

500 COVENTRY ROAD

500 COVENTRY ROAD, OTTAWA, ON.

3D PERSPECTIVES

PROJECT NO. 18.050 P01 PROJECT DATE 2024-09-13 DRAWN B EHS CHECKED BY SCALE

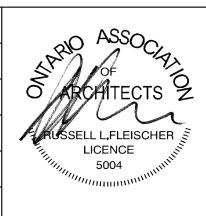

DRAWING NO. SPA802



VIEW FROM TRANS-CANADA HWY LOOKING NORTH



67 Lesmill Road Toronto, ON, M3B 2T8 T 416 425 2222 turnerfleischer.com



1 2024-11-01 ISSUED FOR SITE PLAN APPROVAL # DATE DESCRIPTION


500 COVENTRY ROAD

500 COVENTRY ROAD, OTTAWA, ON.

RAWING

3D PERSPECTIVE

PROJECT NO. 18.050 P01 PROJECT DATE 2024-09-13 DRAWN BY EHS CHECKED BY AYU SCALE

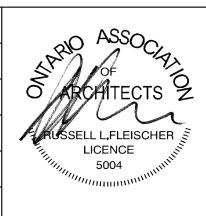

DRAWING NO. SPA803



VIEW LOOKING SOUTH WEST FROM EXISTING BUS STOP



67 Lesmill Road Toronto, ON, M3B 2T8 T 416 425 2222 turnerfleischer.com



 2024-11-01
 ISSUED FOR SITE PLAN APPROVAL

 #
 DATE
 DESCRIPTION


500 COVENTRY ROAD

500 COVENTRY ROAD, OTTAWA, ON.

RAWING

3D PERSPECTIVES

PROJECT NO. 18.050 P01 PROJECT DATE 2024-09-13 DRAWN BY EHS CHECKED BY AYU SCALE

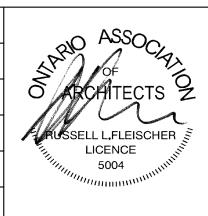


DRAWING NO. SPA804

T REV.



VIEW LOOKING EAST FROM PHASE 2

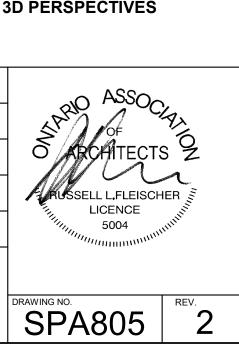


2024-09-13 DRAWN BY EHS CHECKED BY

SCALE



VIEW LOOKING WEST FROM EXISTING 6-STOREY OFFICE BUILDING

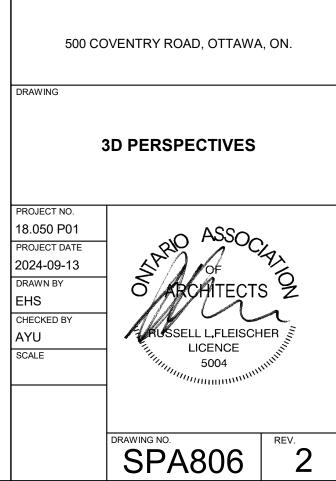

 2
 2024-11-01
 ISSUED FOR SITE PLAN APPROVAL

 1
 2024-01-30
 ISSUED FOR PRE-CONSTRUCTION

 #
 DATE
 DESCRIPTION

500 COVENTRY ROAD







67 Lesmill Road Toronto, ON, M3B 2T8

T 416 425 2222 turnerfleischer.com



VIEW LOOKING TOWARDS MAIN ENTRANCE AND DROP-OFF AREA



Turner Fleischer Architects Inc.

67 Lesmill Road Toronto, ON, M3B 2T8 T 416 425 2222 turnerfleischer.com



 I
 2024-11-01
 ISSUED FOR SITE PLAN APPROVAL

 #
 DATE
 DESCRIPTION


500 COVENTRY ROAD

500 COVENTRY ROAD, OTTAWA, ON.

RAWING

3D PERSPECTIVES

PROJECT NO. 18.050 P01 PROJECT DATE 2024-09-13 DRAWN BY EHS CHECKED BY AYU SCALE

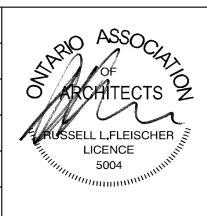

DRAWING NO. REV.



VIEW FROM TRANS-CANADA HWY LOOKING NORTH EAST



Turner Fleischer Architects Inc.

67 Lesmill Road Toronto, ON, M3B 2T8 T 416 425 2222 turnerfleischer.com



 1
 2024-11-01
 ISSUED FOR SITE PLAN APPROVAL

 #
 DATE
 DESCRIPTION


500 COVENTRY ROAD

500 COVENTRY ROAD, OTTAWA, ON.

RAWING

3D PERSPECTIVES

PROJECT NO. 18.050 P01 PROJECT DATE 2024-09-13 DRAWN BY EHS CHECKED BY AYU SCALE

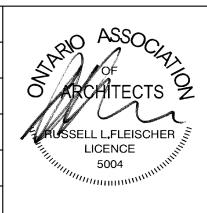

DRAWING NO. SPA808



VIEW LOOKING SOUTH WEST TOWARDS THE PARKING RAMP COVER STRUCTURE



Turner Fleischer Architects Inc.

67 Lesmill Road Toronto, ON, M3B 2T8 T 416 425 2222

T 416 425 2222 turnerfleischer.com



 2024-11-01
 ISSUED FOR SITE PLAN APPROVAL

 #
 DATE
 DESCRIPTION


500 COVENTRY ROAD

500 COVENTRY ROAD, OTTAWA, ON.

DRAWING

3D PERSPECTIVES - PARKING RAMP

PROJECT NO. 18.050 P01 PROJECT DATE 2024-09-13 DRAWN BY EHS CHECKED BY AYU SCALE

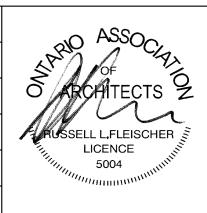

DRAWING NO. SPA809

T REV.



VIEW LOOKING WEST TOWARDS THE PARKING RAMP COVER STRUCTURE



67 Lesmill Road Toronto, ON, M3B 2T8

T 416 425 2222 turnerfleischer.com



 I
 2024-11-01
 ISSUED FOR SITE PLAN APPROVAL

 #
 DATE
 DESCRIPTION

500 COVENTRY ROAD


500 COVENTRY ROAD, OTTAWA, ON.

DRAWING

PROJECT

3D PERSPECTIVES - PARKING RAMP

PROJECT NO. 18.050 P01 PROJECT DATE 2024-09-13 DRAWN BY EHS CHECKED BY AYU SCALE

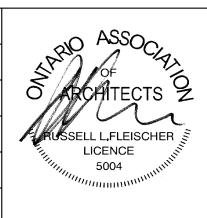


DRAWING NO. SPA810







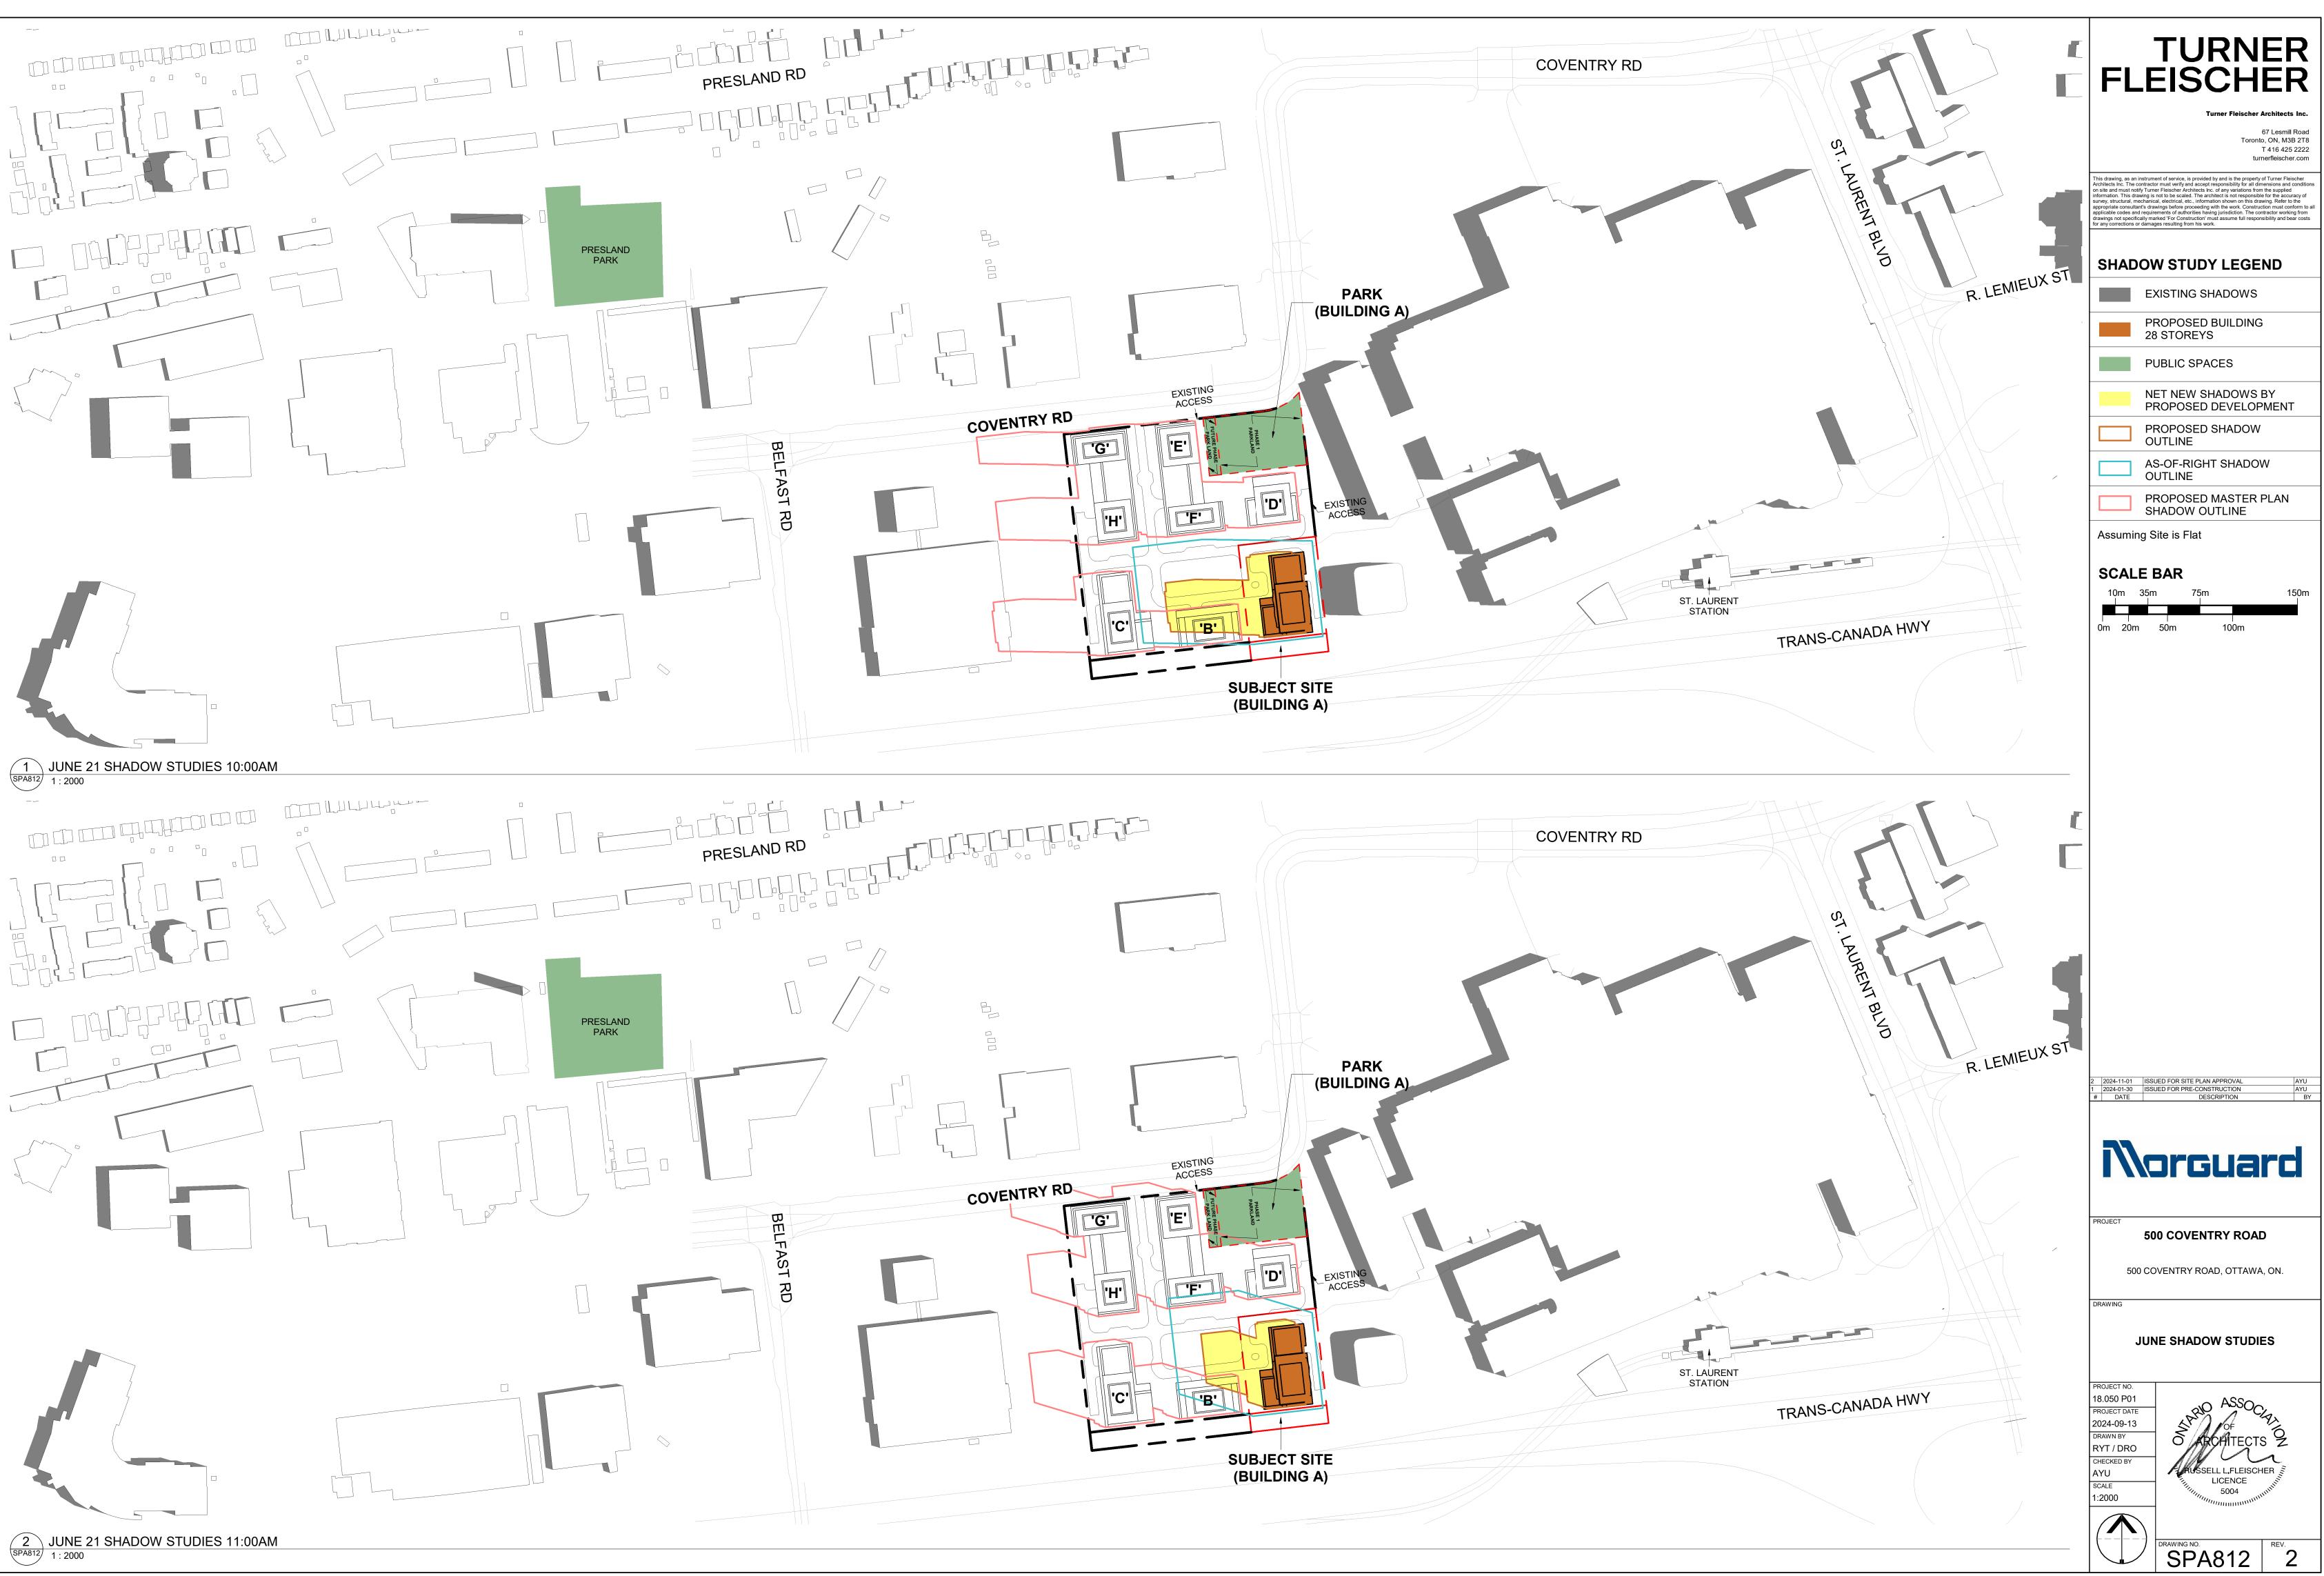










Ω Π

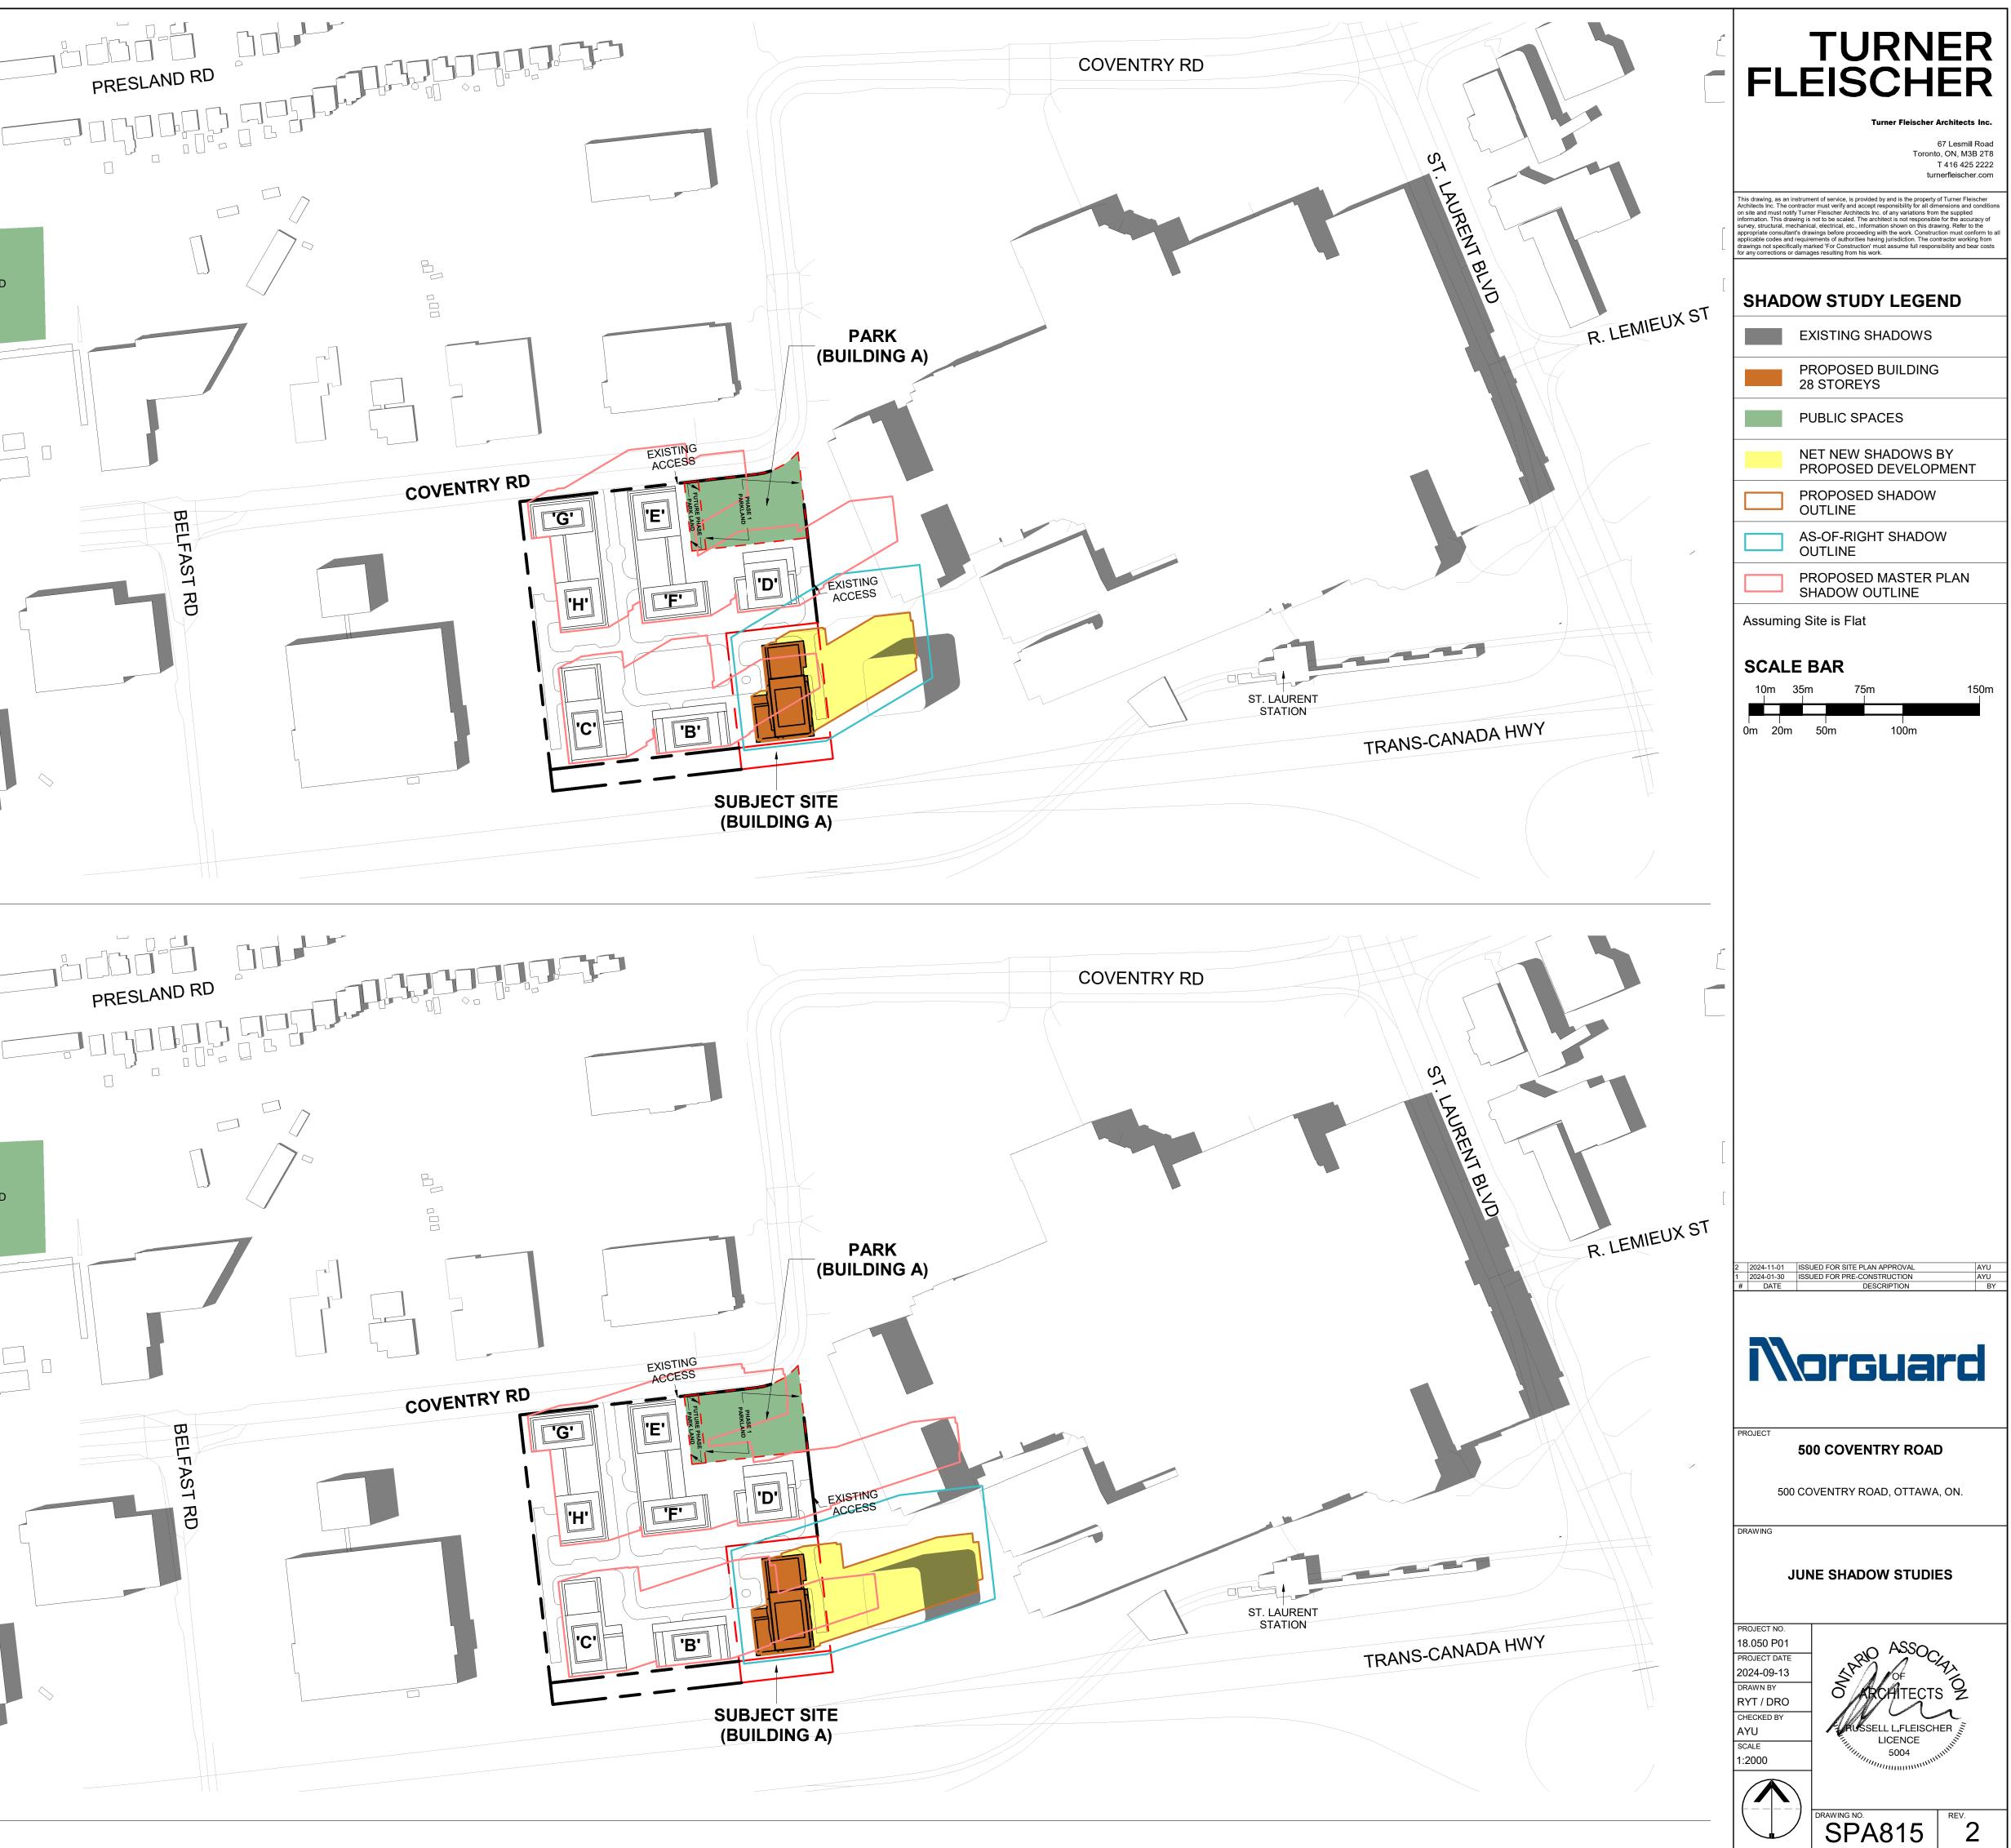

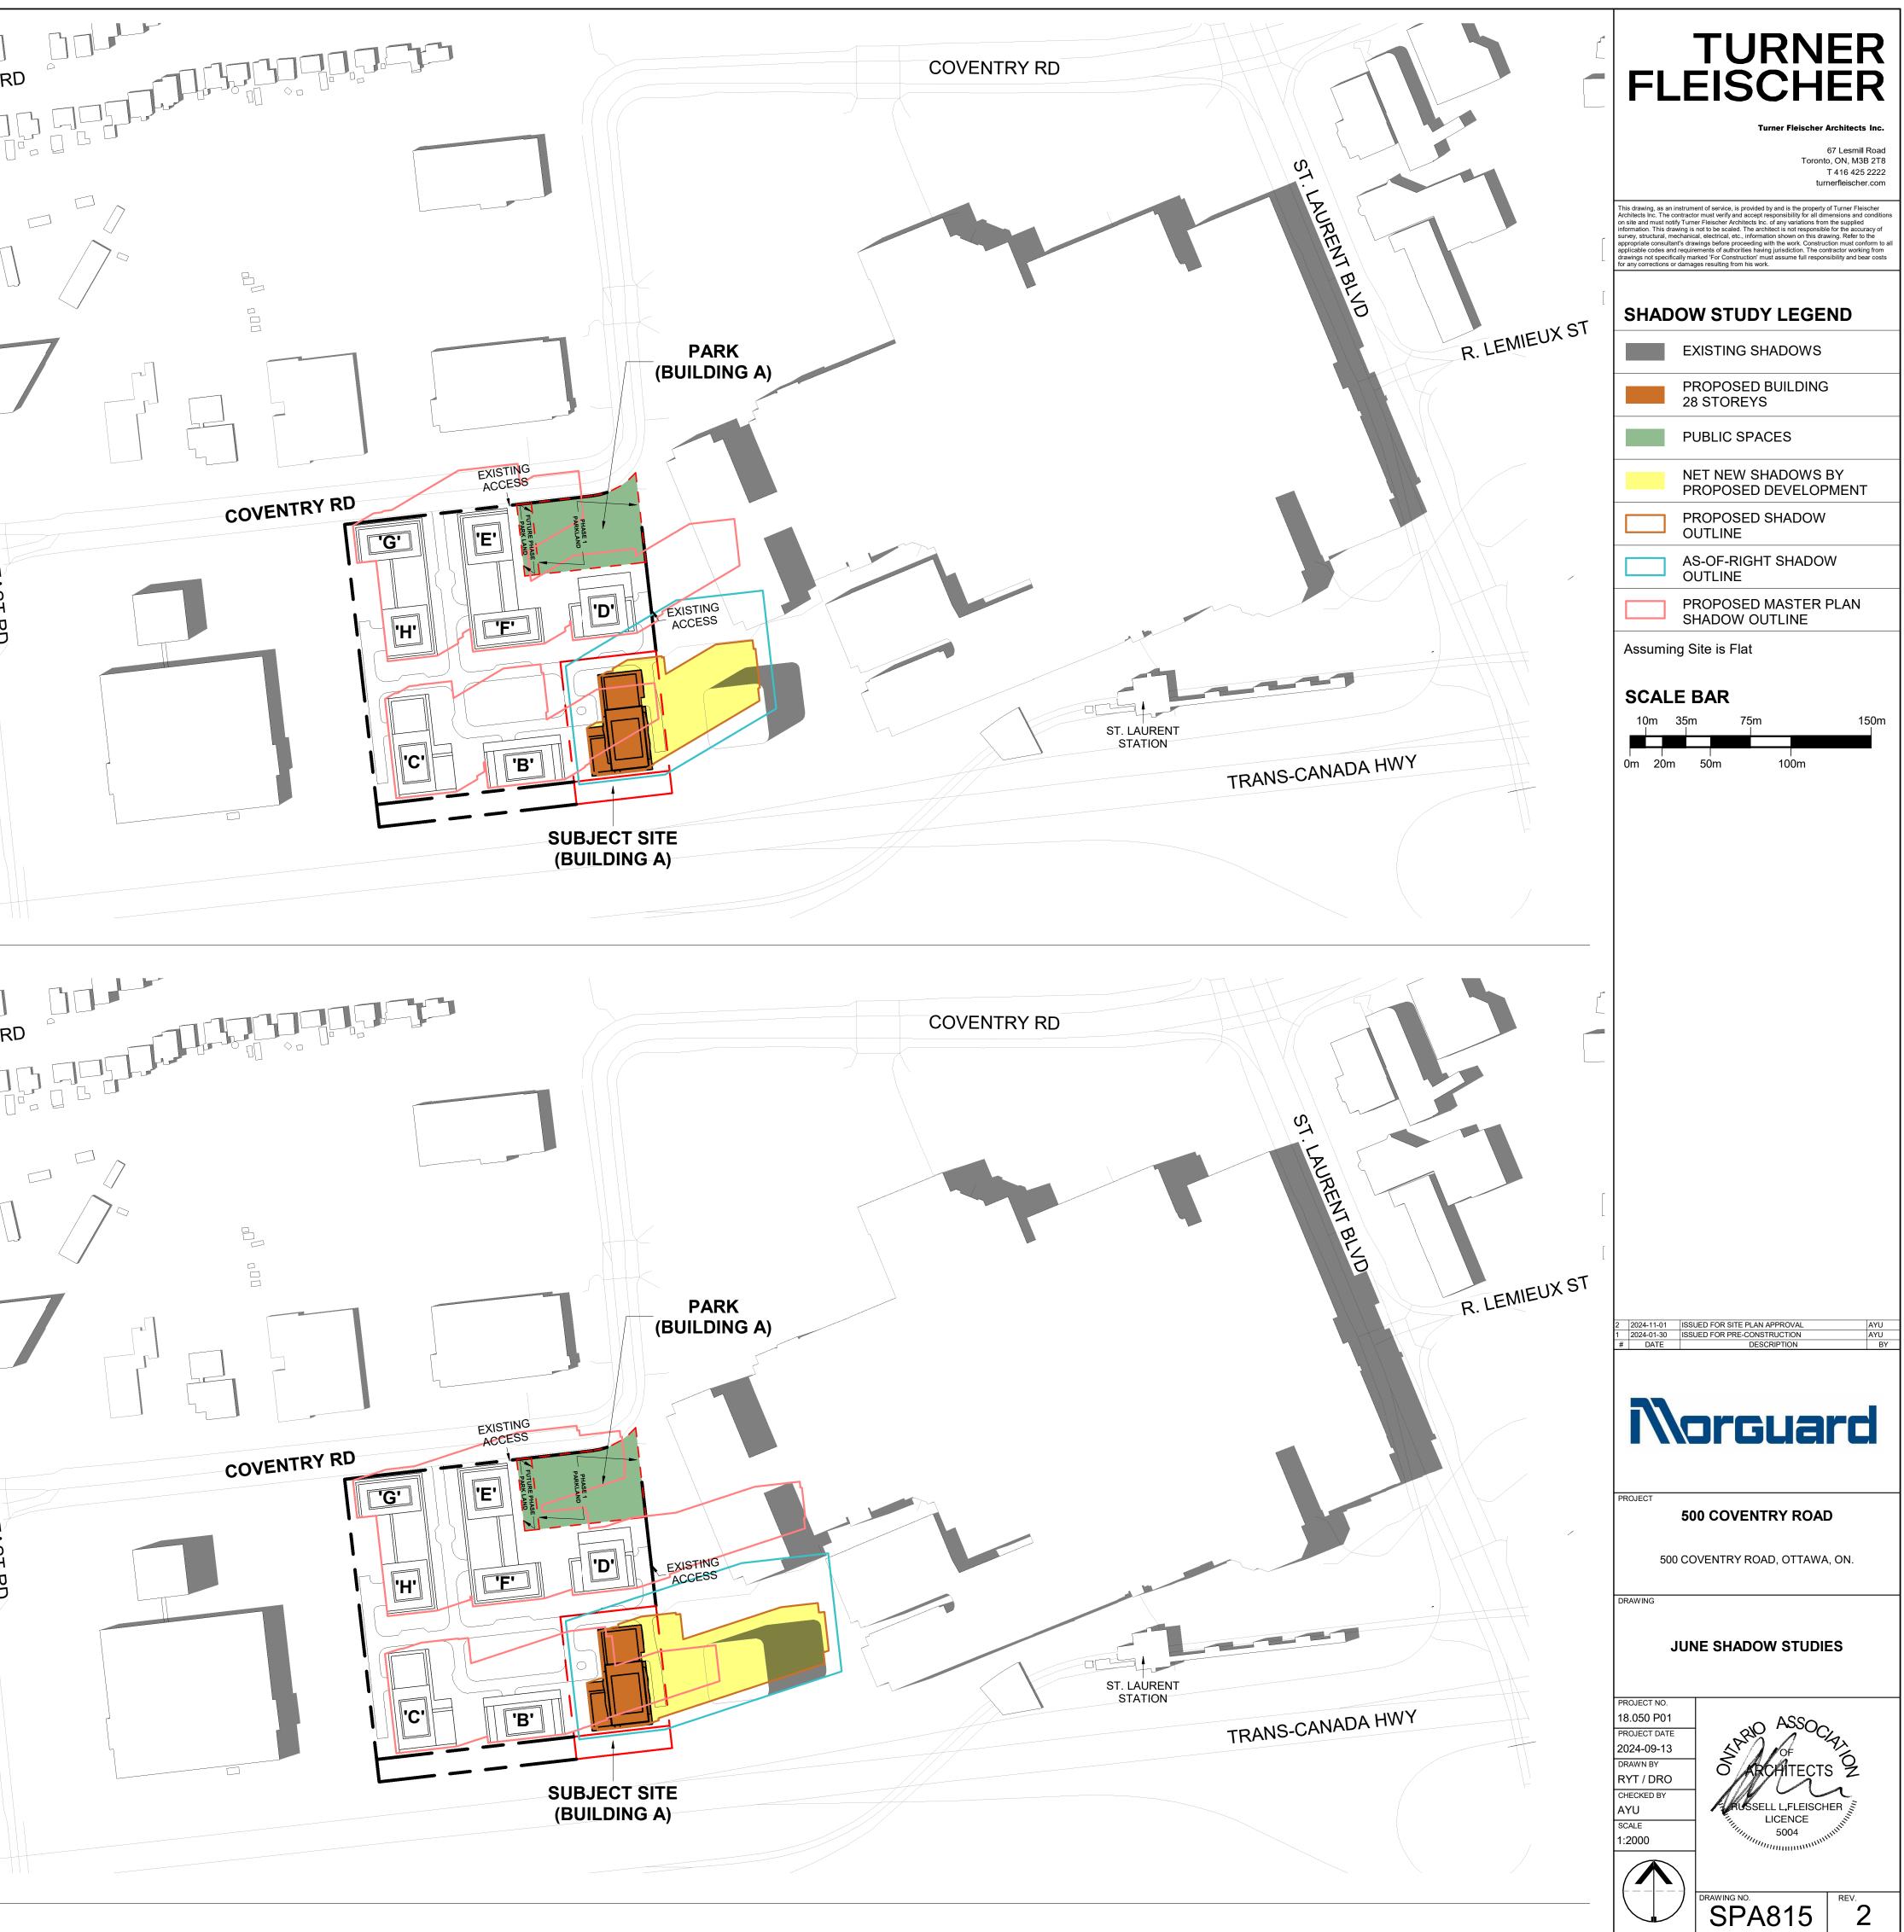

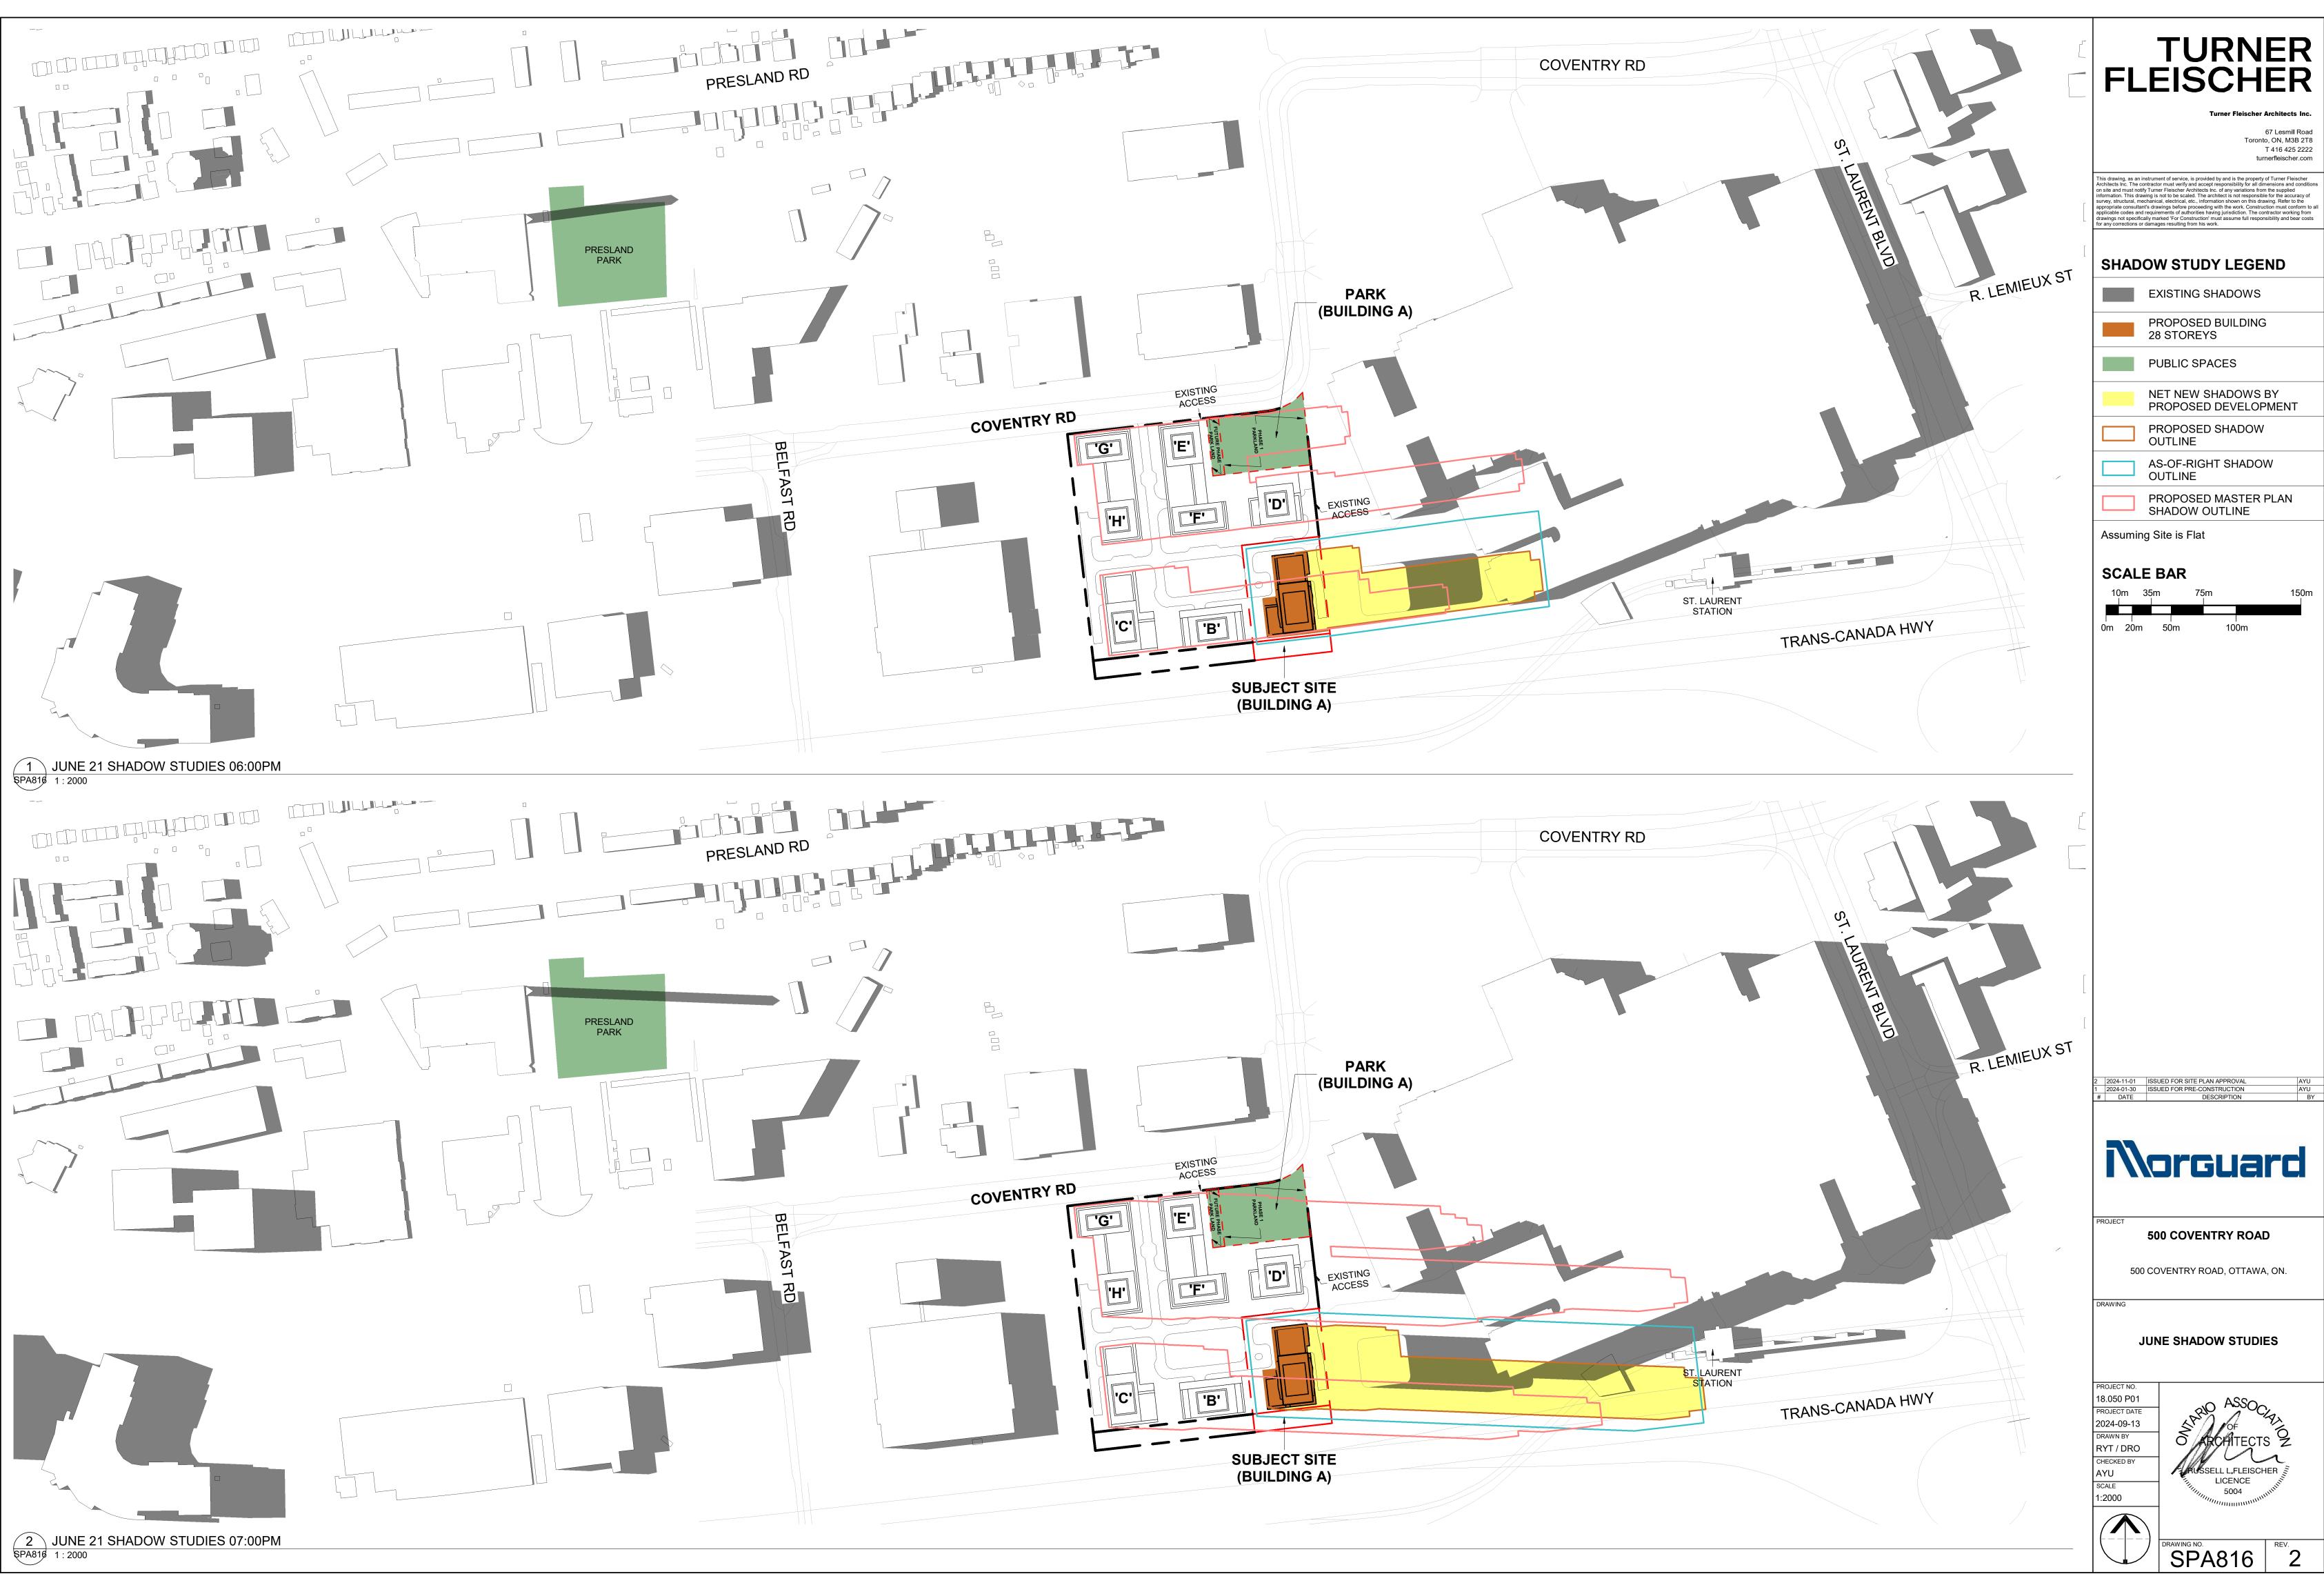





500 COVENTRY ROAD


500 COVENTRY ROAD, OTTAWA, ON.

ORAWING


JUNE SHADOW STUDIES

PROJECT NO. 18.050 P01 PROJECT DATE 2024-09-13 DRAWN BY RYT / DRO CHECKED BY AYU SCALE 1:2000



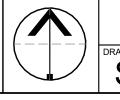



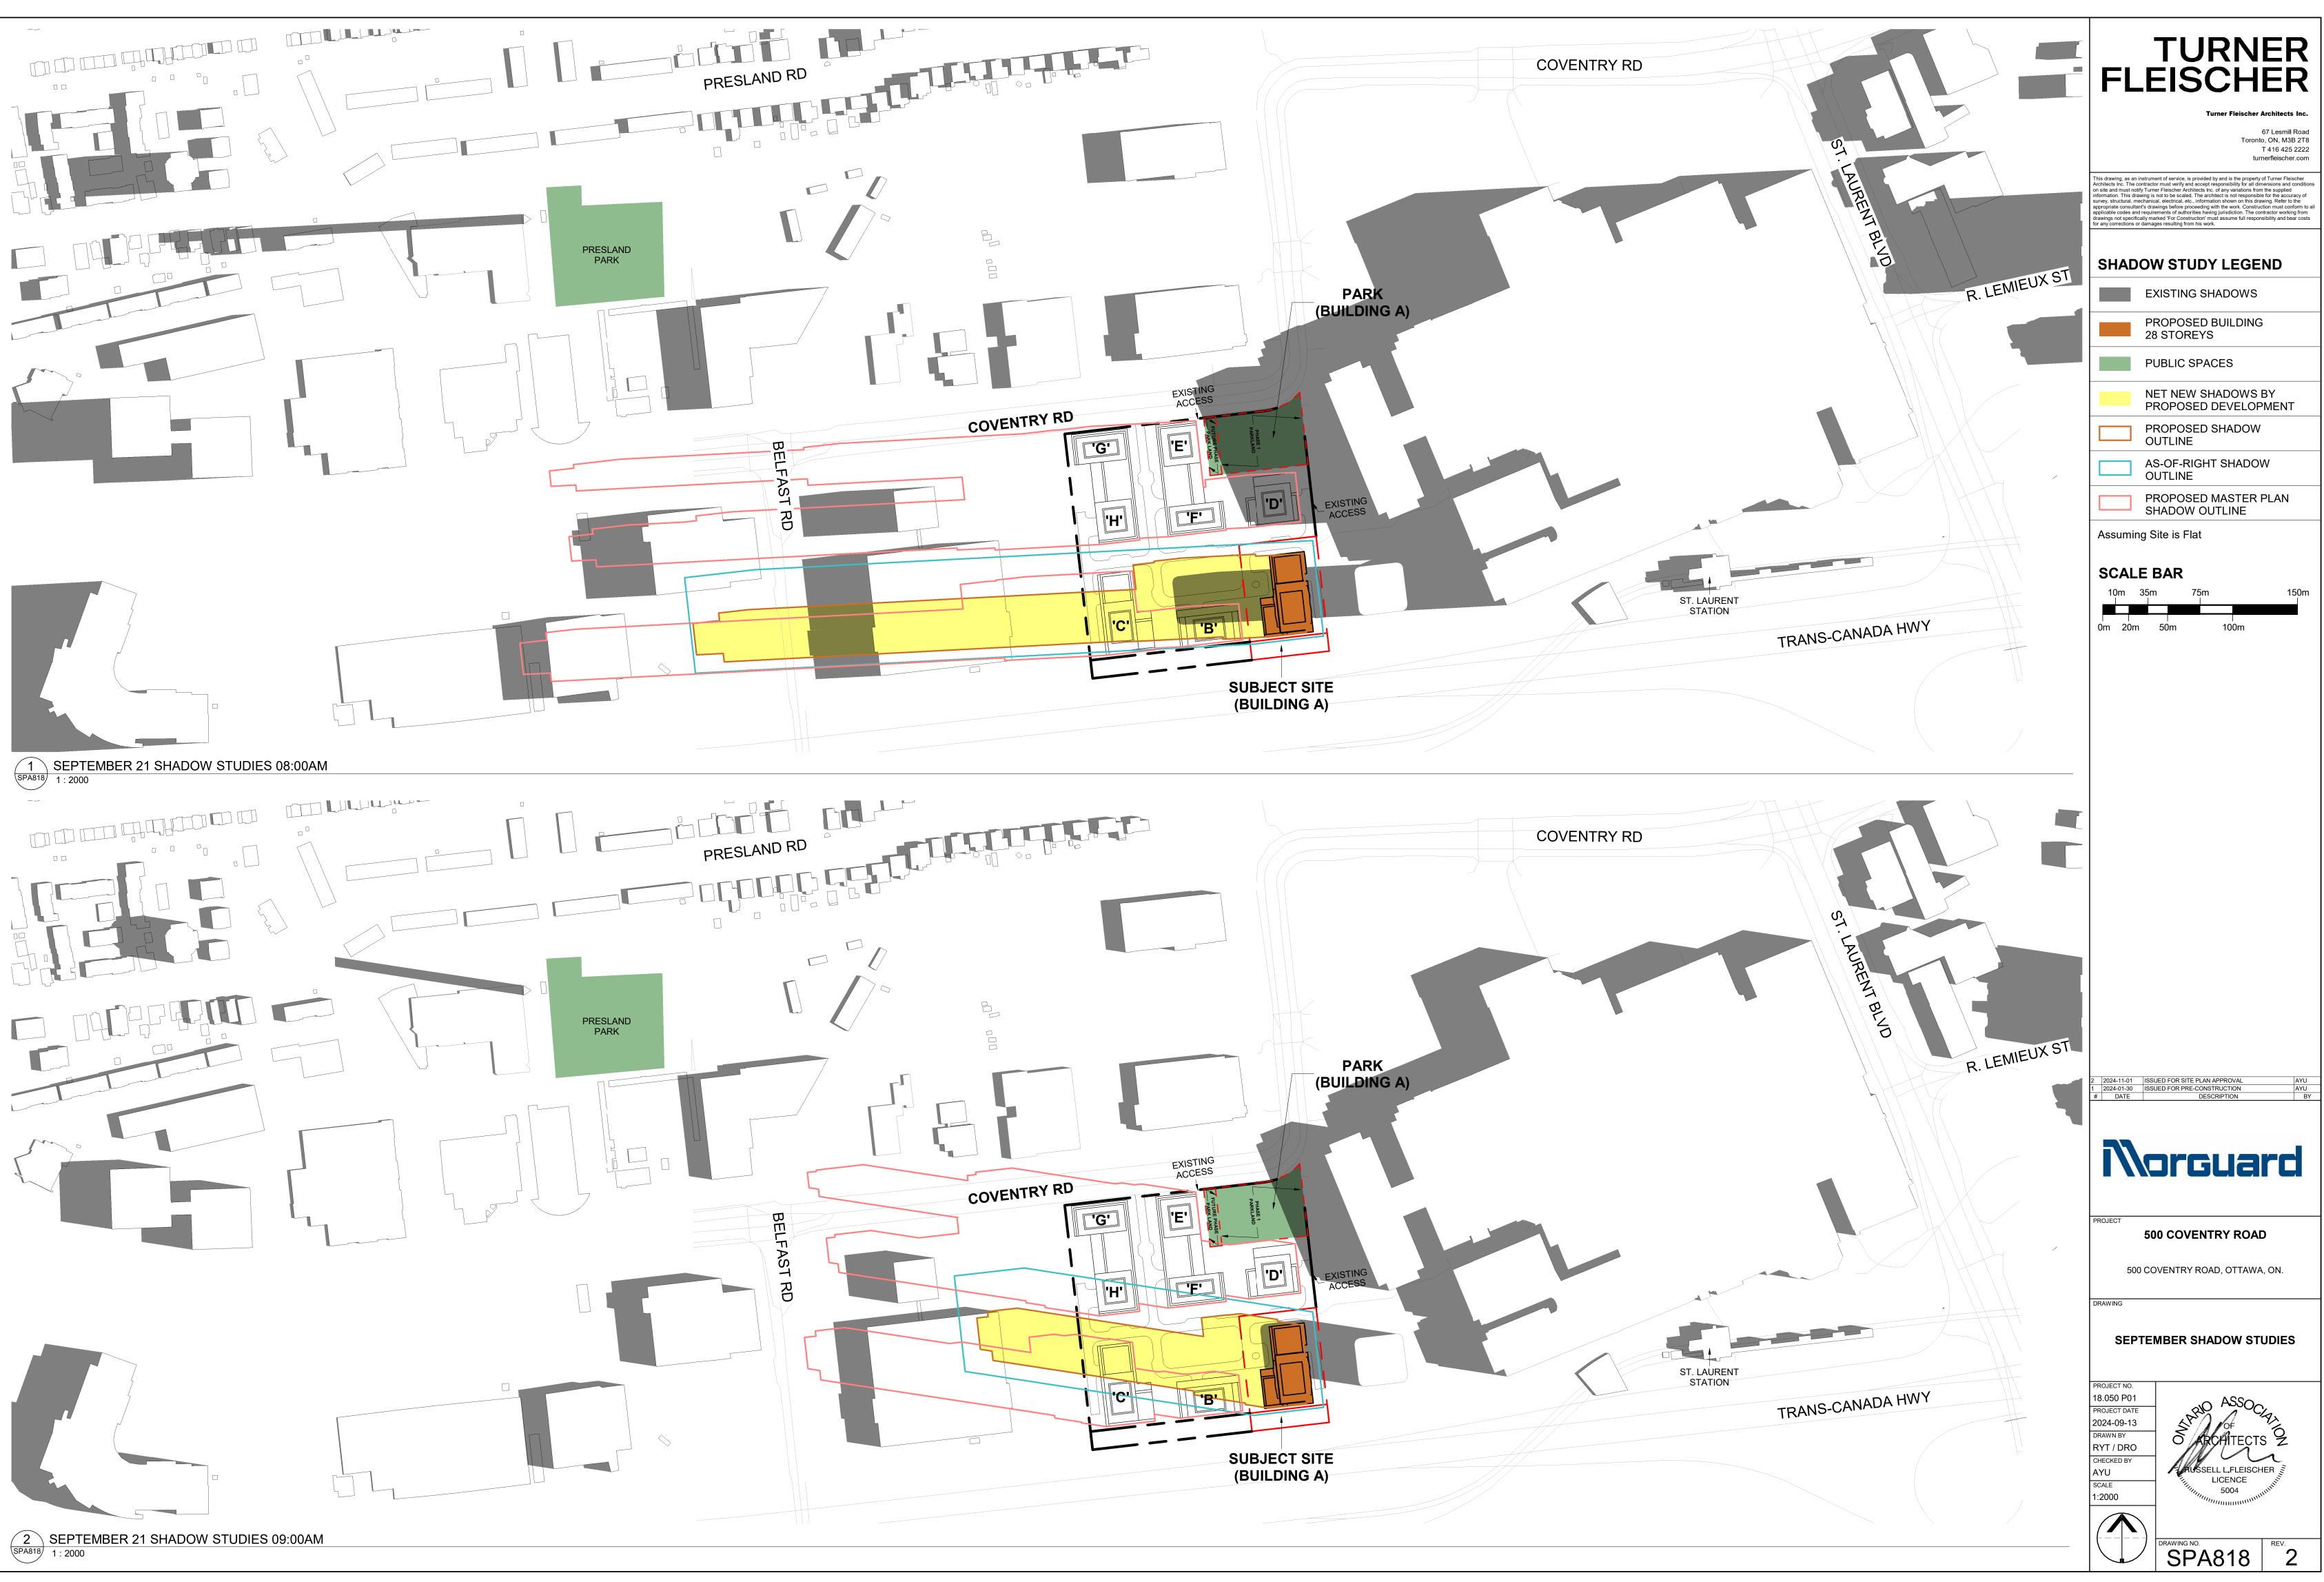





BE





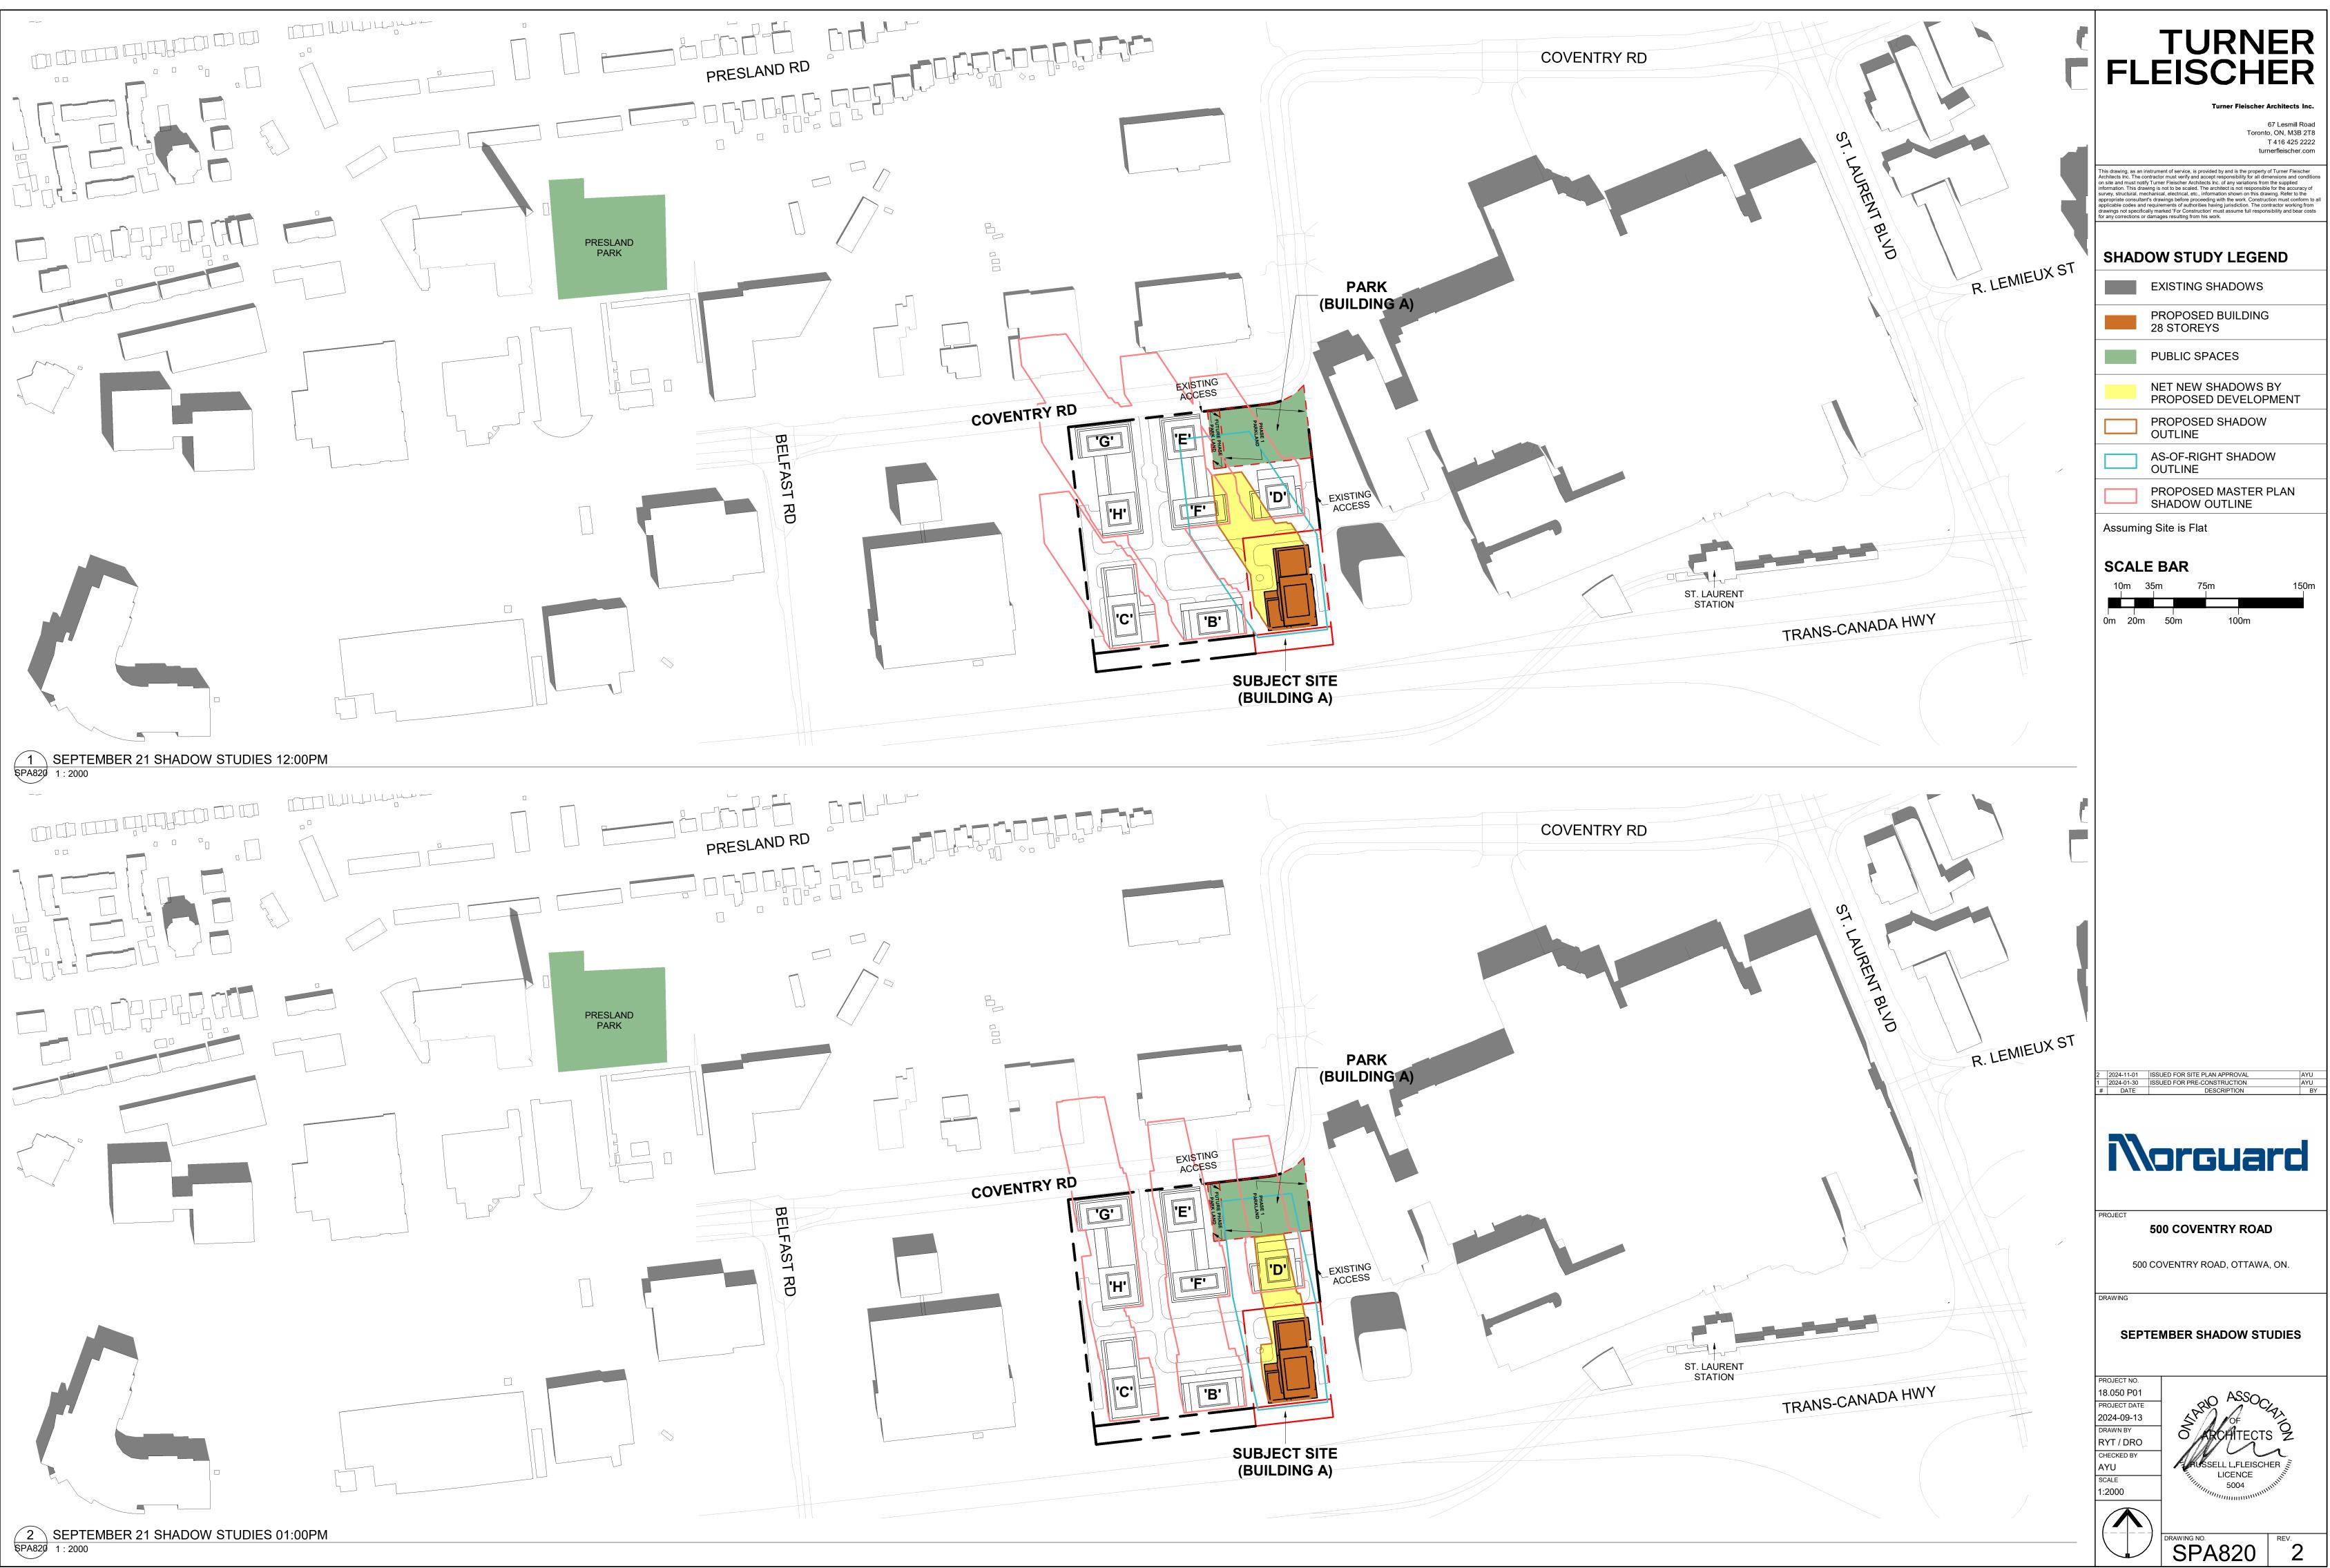


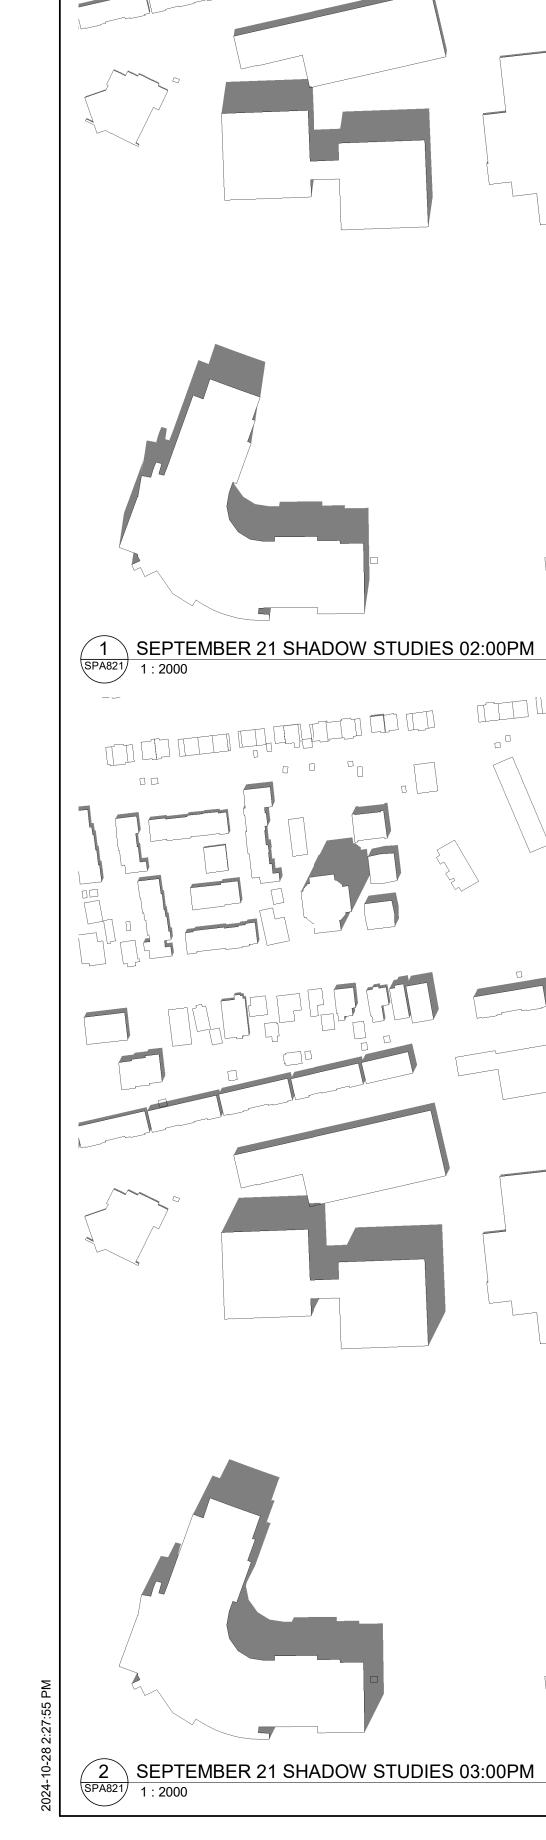


PRESLAND RD PRESLAND PARK Ū 1 SEPTEMBER 21 SHADOW STUDIES 02:00PM SPA821 1:2000 PRESLAND RD PRESLAND PARK







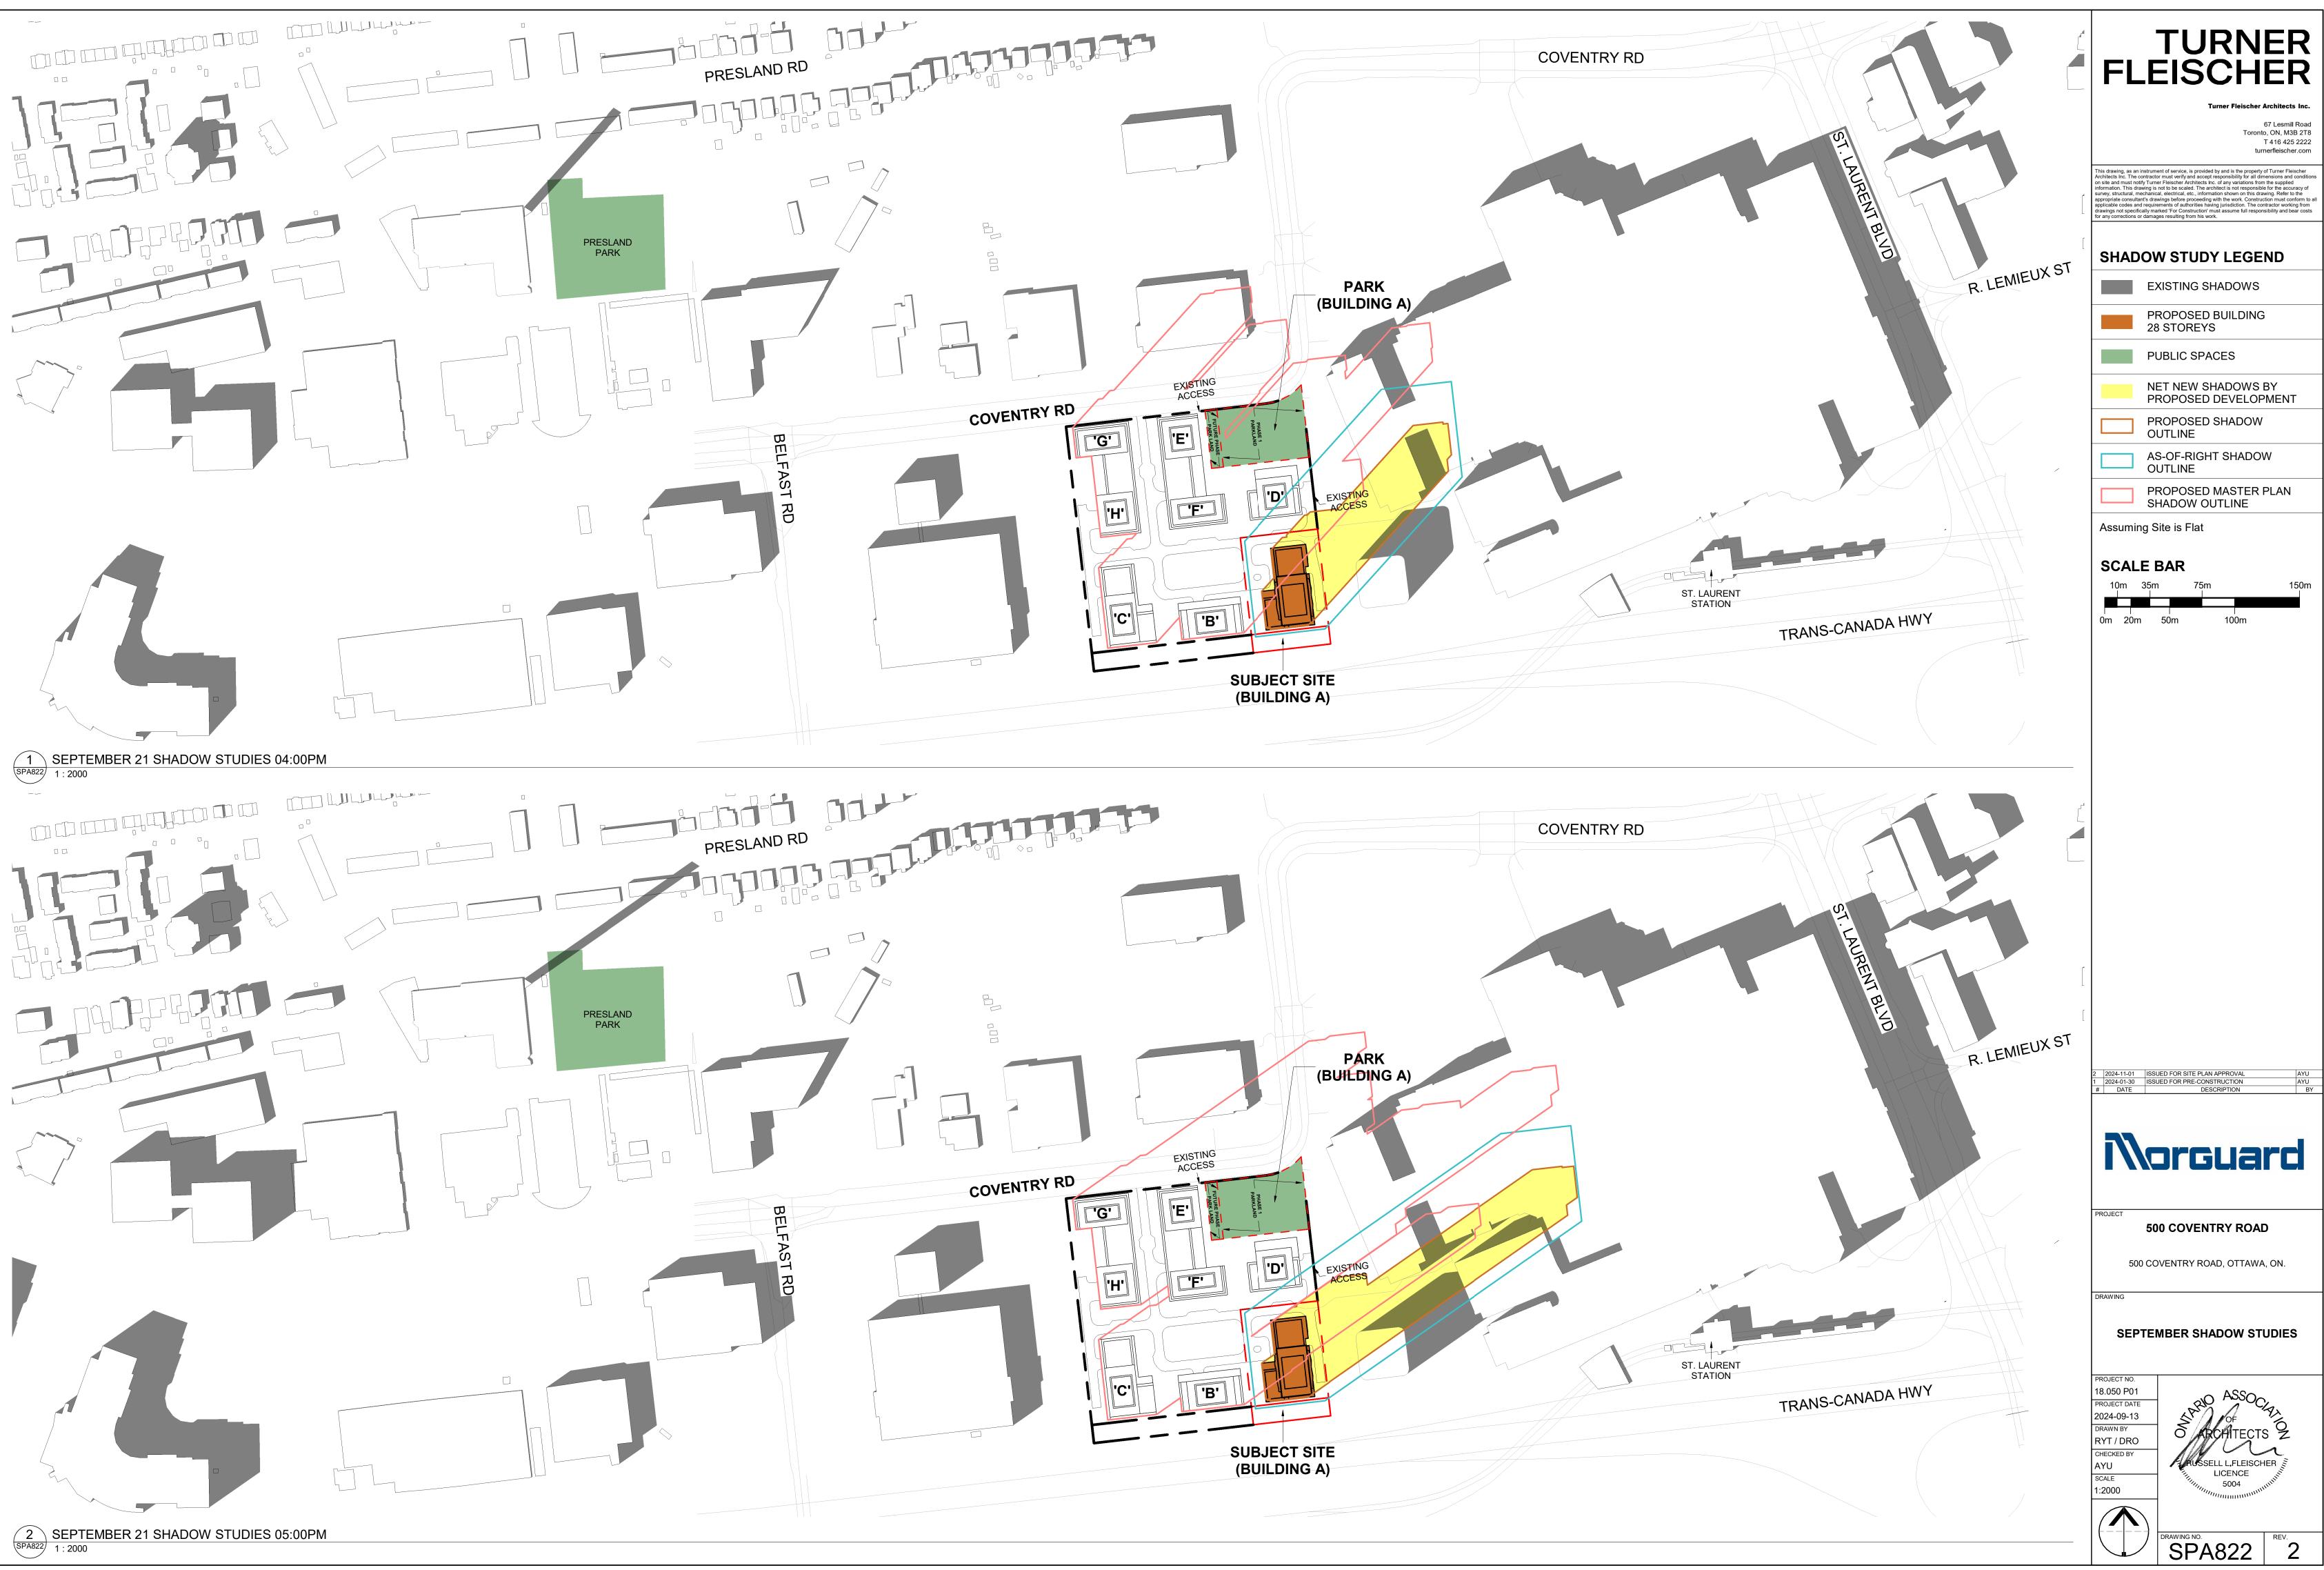





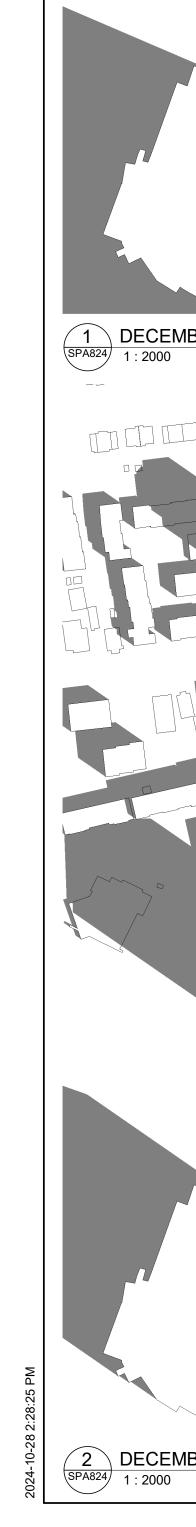

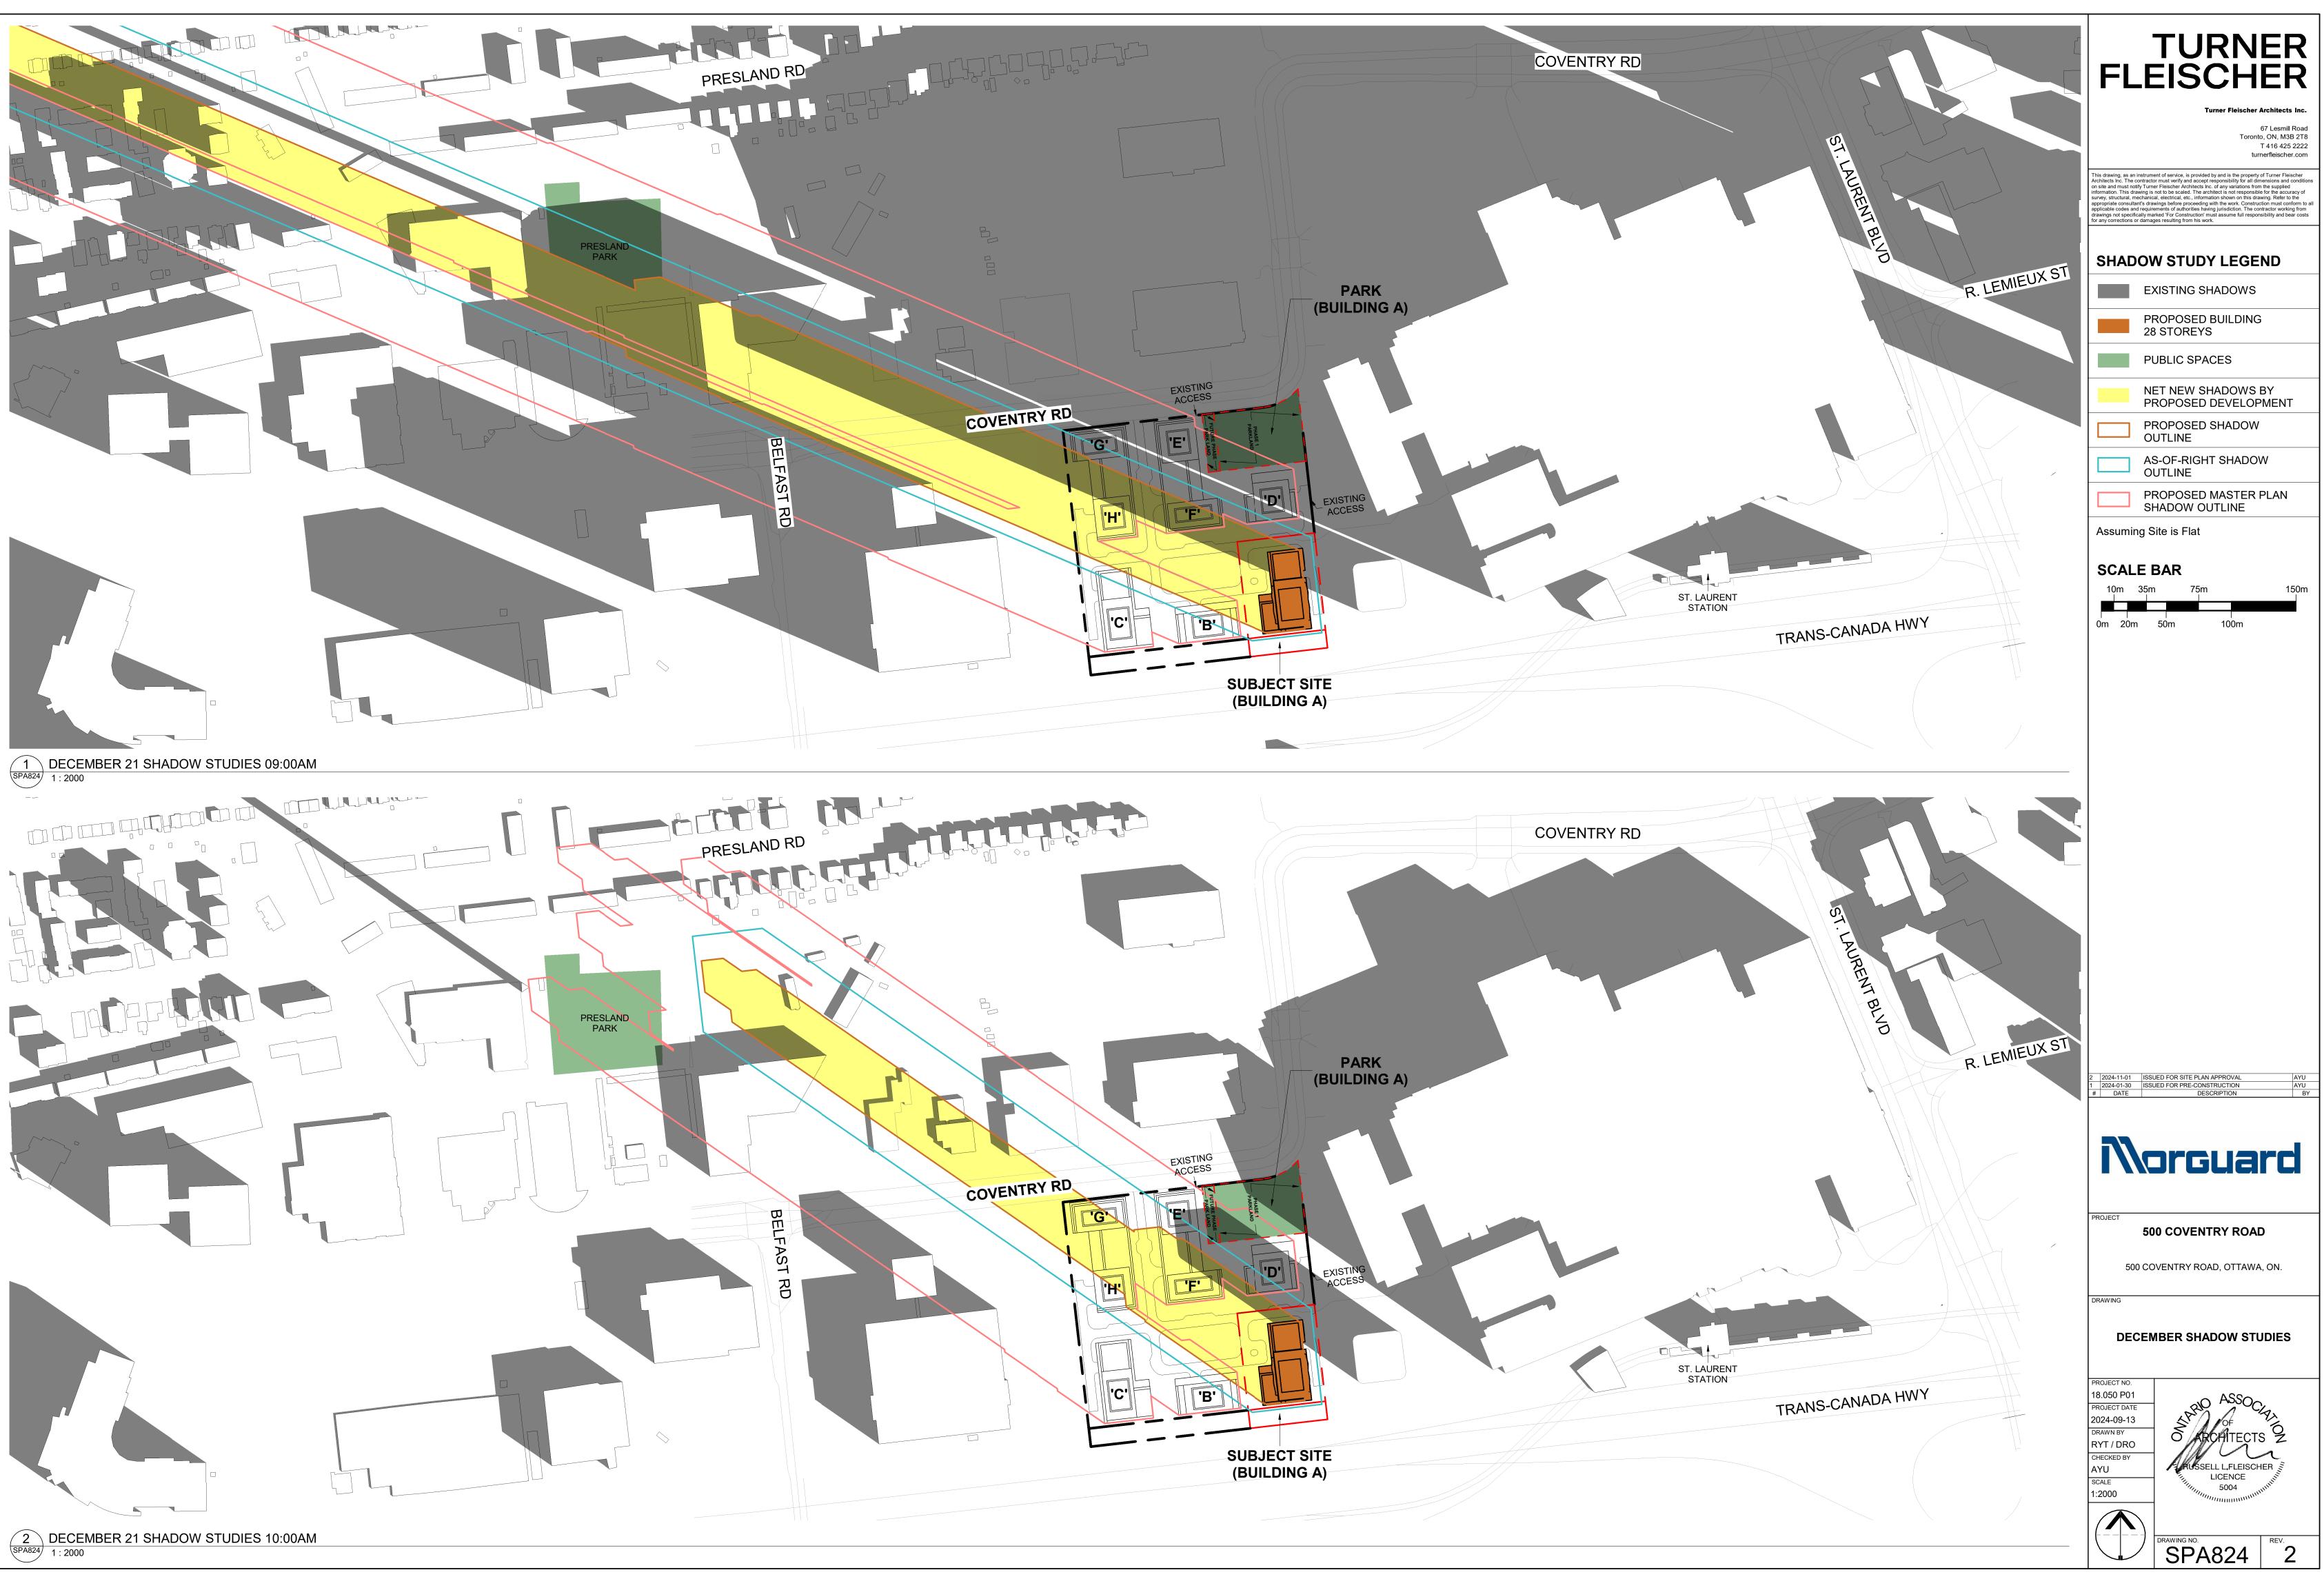

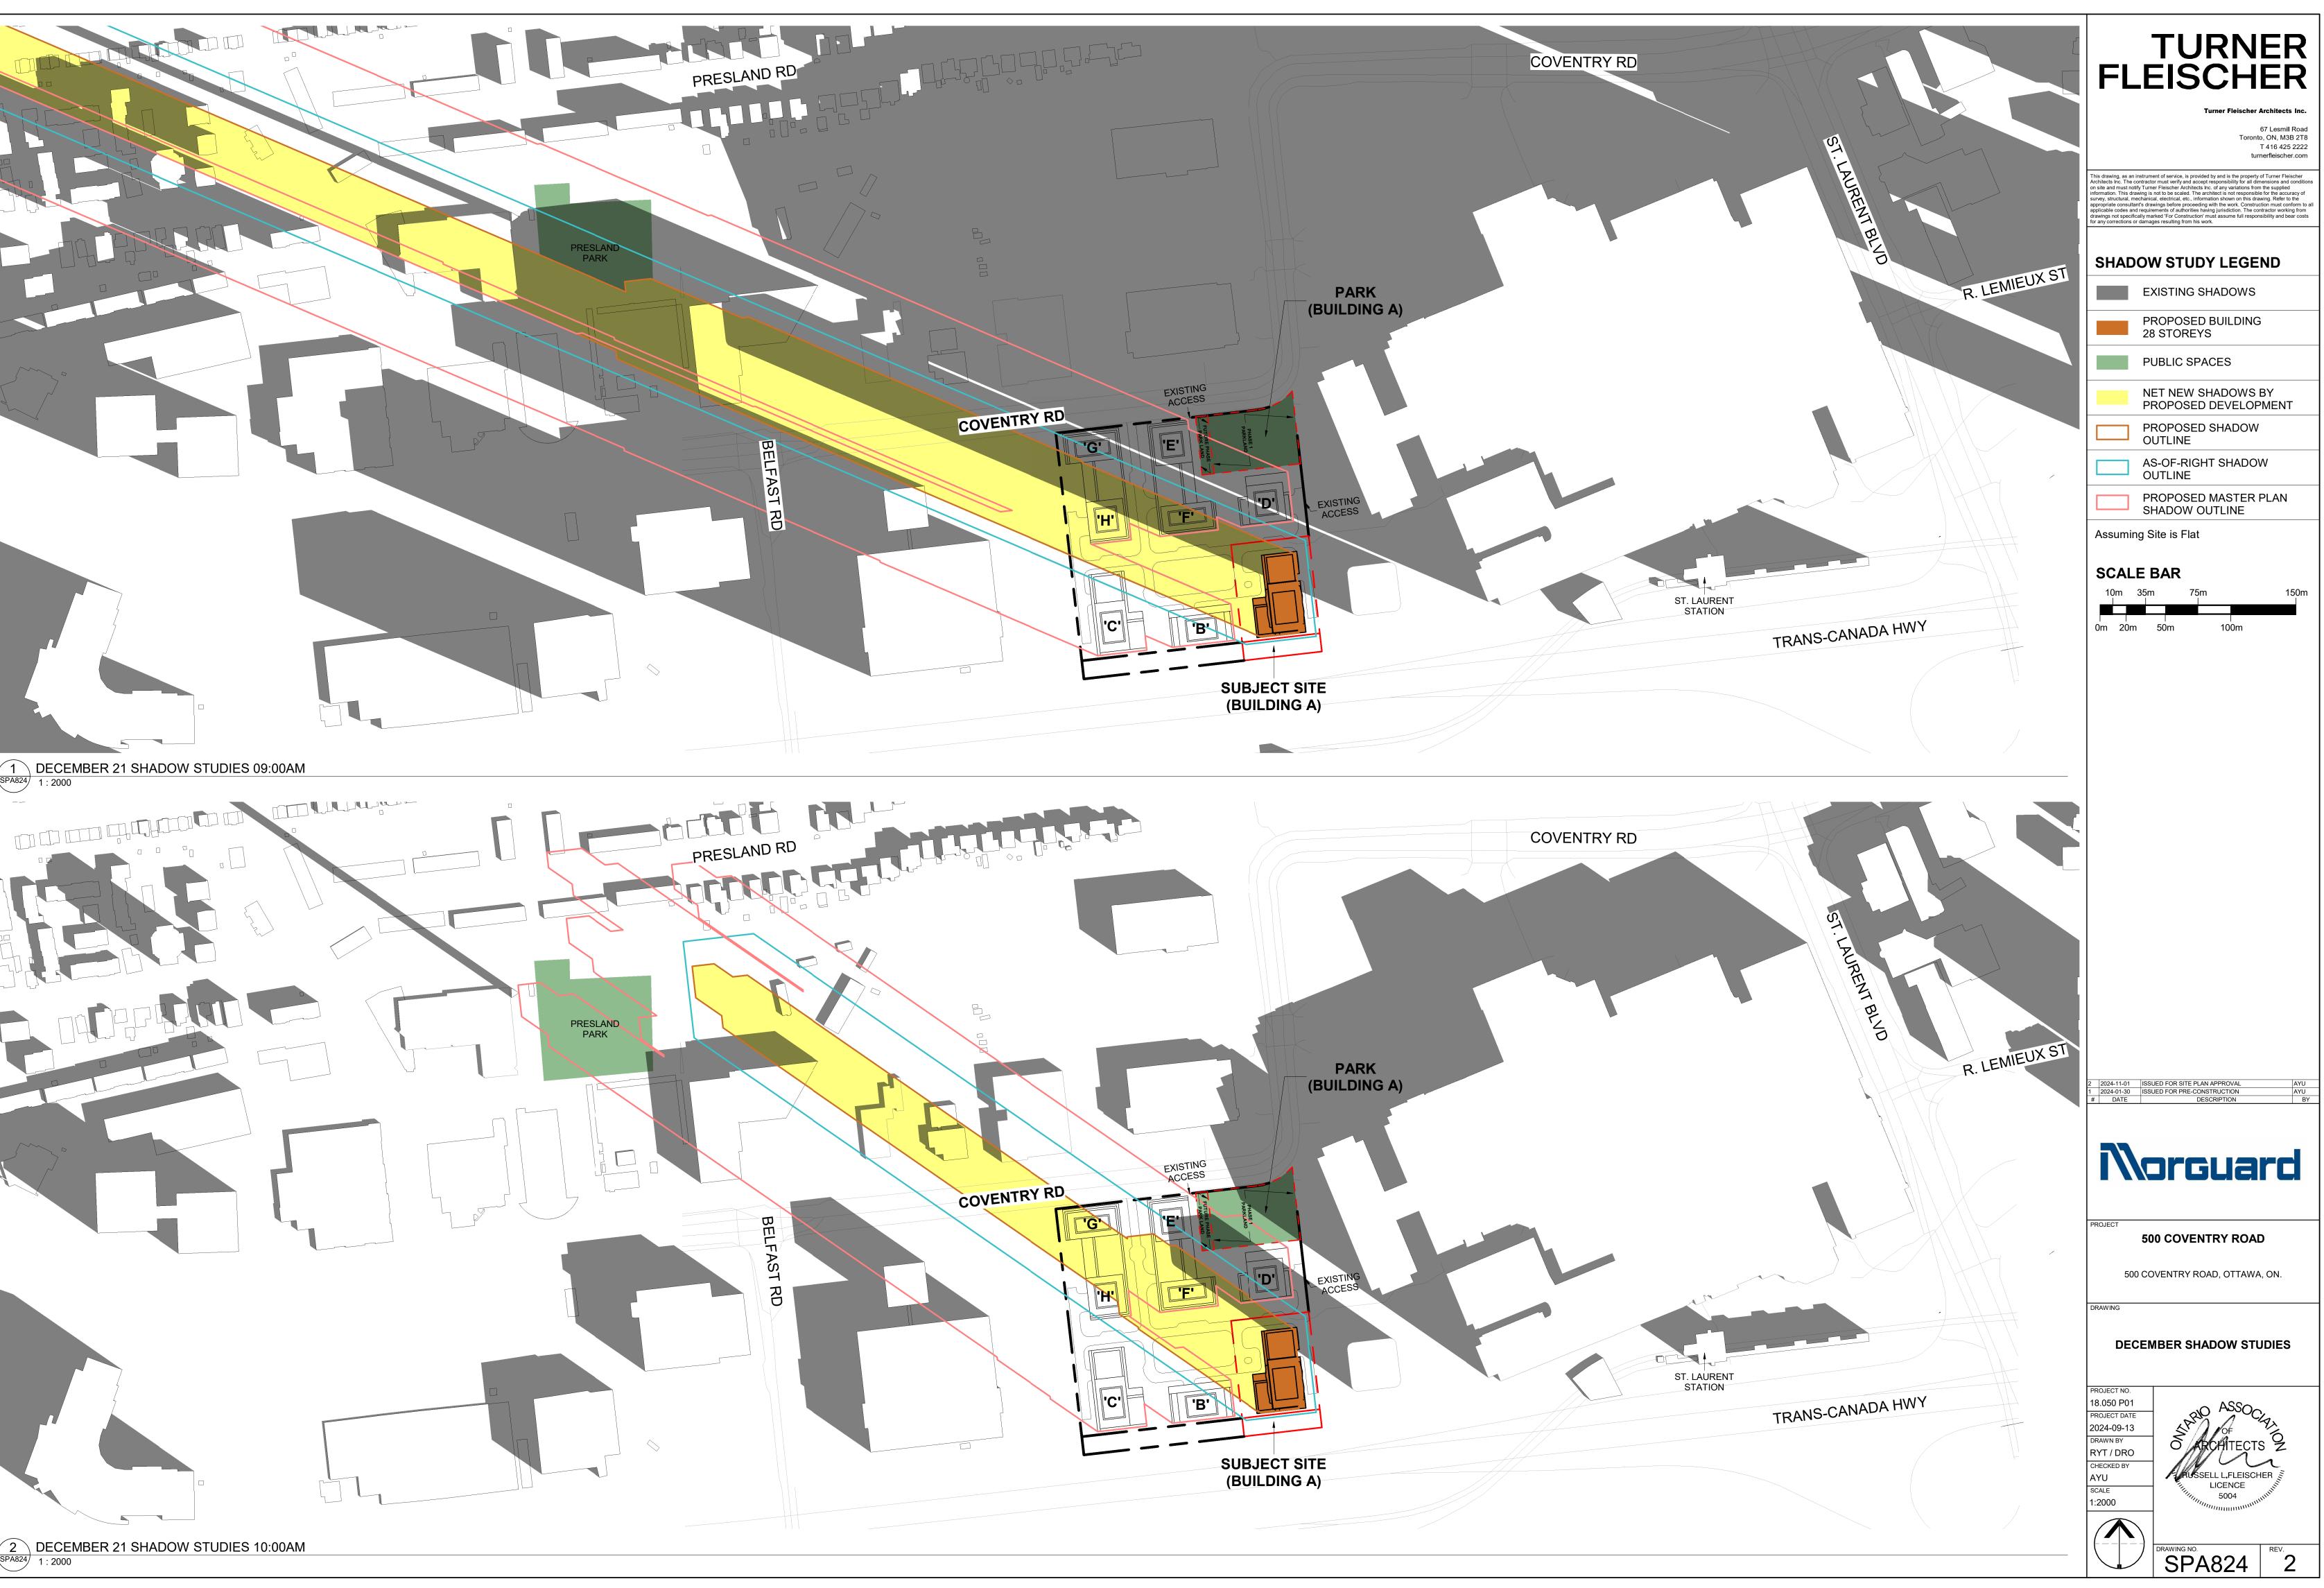

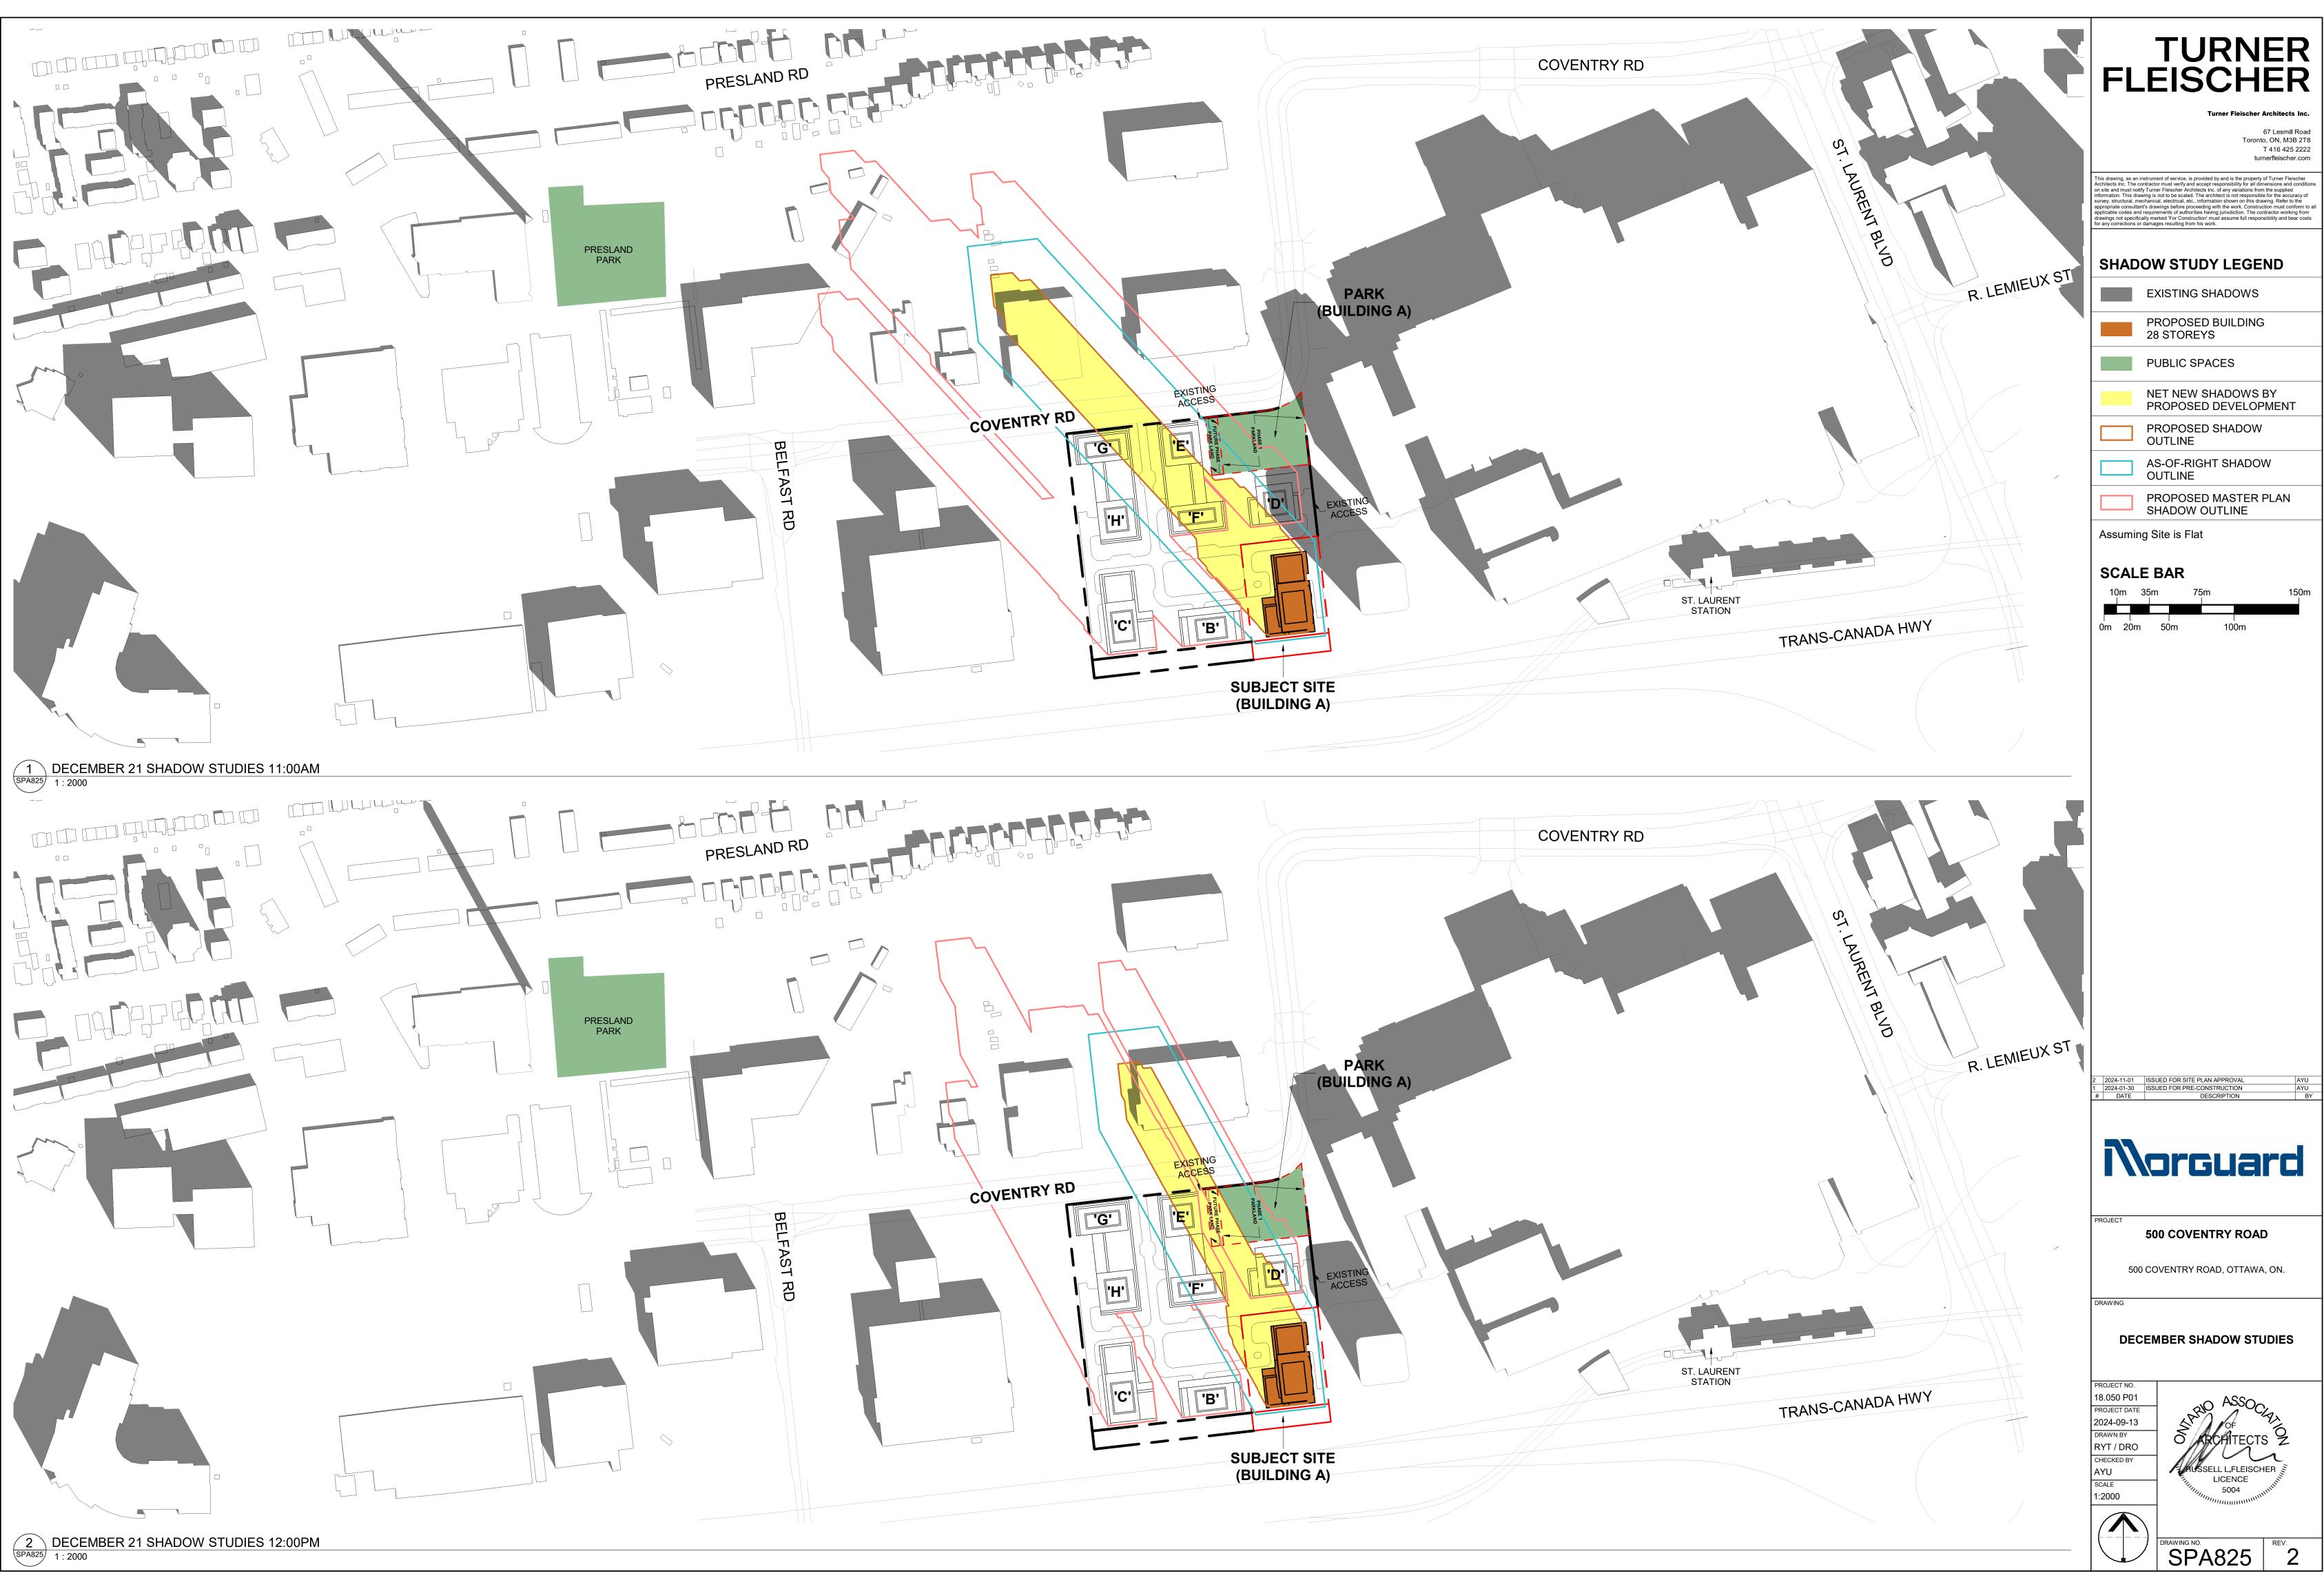

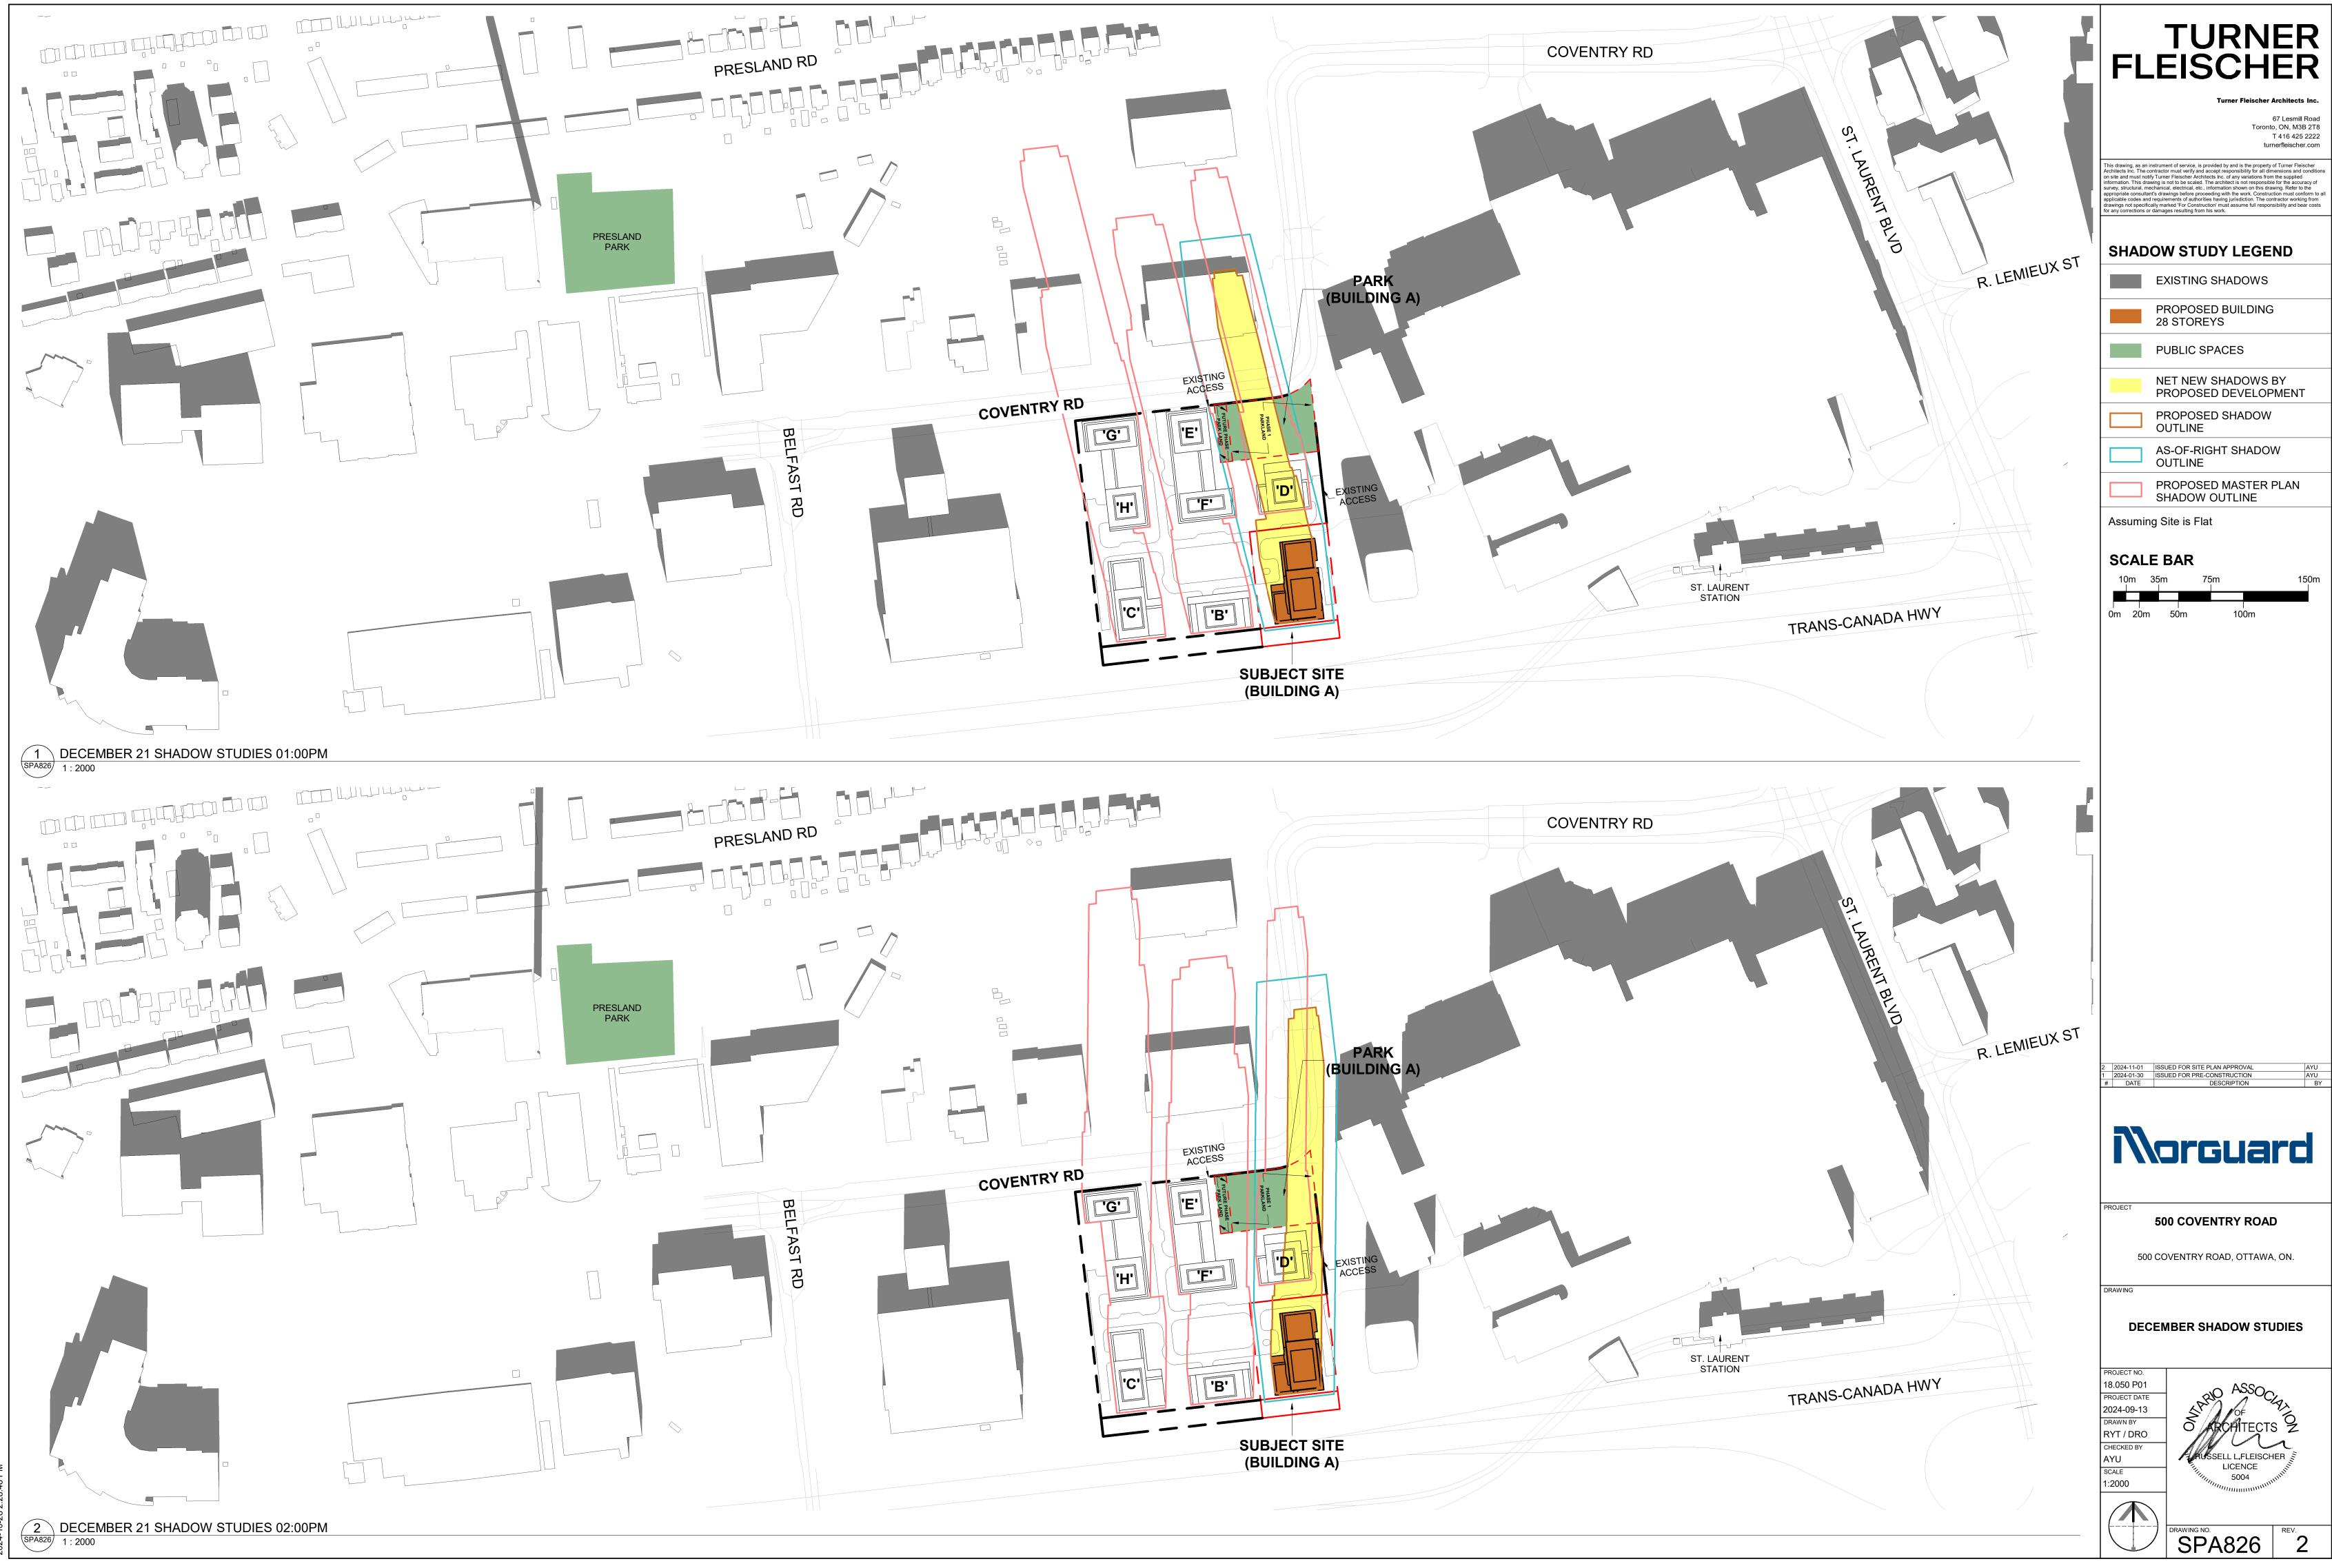







AYU AYU BY

500 COVENTRY ROAD

500 COVENTRY ROAD, OTTAWA, ON.

DRAWING

DECEMBER SHADOW STUDIES

PROJECT NO. 18.050 P01 PROJECT DATE 2024-09-13 DRAWN BY RYT / DRO CHECKED BY AYU SCALE 1:2000



DRAWING NO. SPA827