# **500 COVENTRY ROAD**

# 500 COVENTRY ROAD, OTTAWA, ON.

## 18.050 P01

	SPA DRAWINGS
SHEET NUMBER	SHEET NAME
SPA000	COVER SHEET
SPA001	SURVEY
SPA003	TGS CHECKLIST
SPA004	CONTEXT PLAN
SPA005A	MASTERPLAN / CONCEPT PLAN
SPA005B	SITE PLAN / ROOF PLAN - OVERALL SITE
SPA005C	SITE PLAN / ROOF PLAN
SPA005D	SITE PLAN / ROOF PLAN - OPTION 1
SPA006	RESIDENTIAL SOLID WASTE MANAGEMENT
SPA101	UNDERGROUND LEVEL 02
SPA102	UNDERGROUND LEVEL 01
SPA151	FLOOR 01
SPA152	FLOOR 02
SPA153	FLOOR 03 - 05
SPA154	FLOOR 06
SPA155	FLOOR 07
SPA156	FLOOR 08 - 28
SPA157	MPH
SPA301	ELEVATIONS
SPA302	ELEVATIONS
SPA311	1 TO 50 ELEVATIONS
SPA312	1 TO 50 ELEVATIONS
SPA321	BIRD FRIENDLY ELEVATIONS
SPA401	SECTION A - A
SPA411	WALL SECTIONS
SPA600	DETAILS
SPA801	3D PERSPECTIVES
SPA802	3D PERSPECTIVES
SPA803	3D PERSPECTIVE
SPA804	3D PERSPECTIVES
SPA805	3D PERSPECTIVES
SPA806	3D PERSPECTIVES
SPA807	3D PERSPECTIVES
SPA808	3D PERSPECTIVES
SPA809	3D PERSPECTIVES - PARKING RAMP
SPA810	3D PERSPECTIVES - PARKING RAMP
SPA811	JUNE SHADOW STUDIES
SPA812	JUNE SHADOW STUDIES
SPA813	JUNE SHADOW STUDIES
SPA814	JUNE SHADOW STUDIES
SPA815	JUNE SHADOW STUDIES
SPA816	JUNE SHADOW STUDIES
SPA817	JUNE SHADOW STUDIES
SPA818	SEPTEMBER SHADOW STUDIES
SPA819	SEPTEMBER SHADOW STUDIES
SPA820	SEPTEMBER SHADOW STUDIES
SPA821	SEPTEMBER SHADOW STUDIES
SPA822	SEPTEMBER SHADOW STUDIES
SPA823	SEPTEMBER SHADOW STUDIES
SPA824	DECEMBER SHADOW STUDIES
SPA825	DECEMBER SHADOW STUDIES
SPA826	DECEMBER SHADOW STUDIES
SPA827	DECEMBER SHADOW STUDIES



#### **CGH Transportation**

Traffic Consultant 13 Markham Ave Ottawa, ON, K2G 3Z1 Contact Name: Andrew Harte Tel.: (613) 697-3797 E-Mail: andrew.harte@cghtransportation.com

Civil Engineer 6240 Hwy 7, Suite 200 Woodbridge, ON, L4H 4G3 Contact Name: Alison Gosling Tel.: (613) 714 - 4629 E-Mail: Alison.GOSLING@egiś-group.com

#### **Gradient Wind**

Wind 127 Walgreed Rd, Carp, ON, K0A 1L0 Contact Name: David Hurtima Tel.: (613) 836-0934 E-Mail: david.hurtima@gradientwind.com



Morguard Corporation 55 City Centre Drive, Suite 1000 Mississauga, ON L5B 1M3 Contact Name: Mark Bradley Phone Number: D: (905) 281-5831 Email: mbradley@morguard.com

> **FLEISCHER** 67 Lesmill Rd Toronto, ON, M3B 2T8 **Contact Name: Anita Yu** Phone Number: 416-425-2222 ext 235 Email: anita.yu@turnerfleischer.com

# **ISSUED FOR SITE PLAN APPROVAL NOVEMBER 01, 2024**


Vollebekk Ltd.


Surveyor 14 Concourse Gate, Suite 500 Nepean, ON, K2E 7S6 Contact Name: Annia O'sullivan Tel.: (613) 727-0850 E-Mail: Nepean@aovltd.com


#### Foten Planning + Design

Landscape & Urban Planner 396 Cooper Street, Suite 300 Ottawa, ON, K2P 2H7 Contact Name: Jillian Simpson Tel.: (613) 730-5709 E-Mail: simpson@fotenn.com

#### Egis

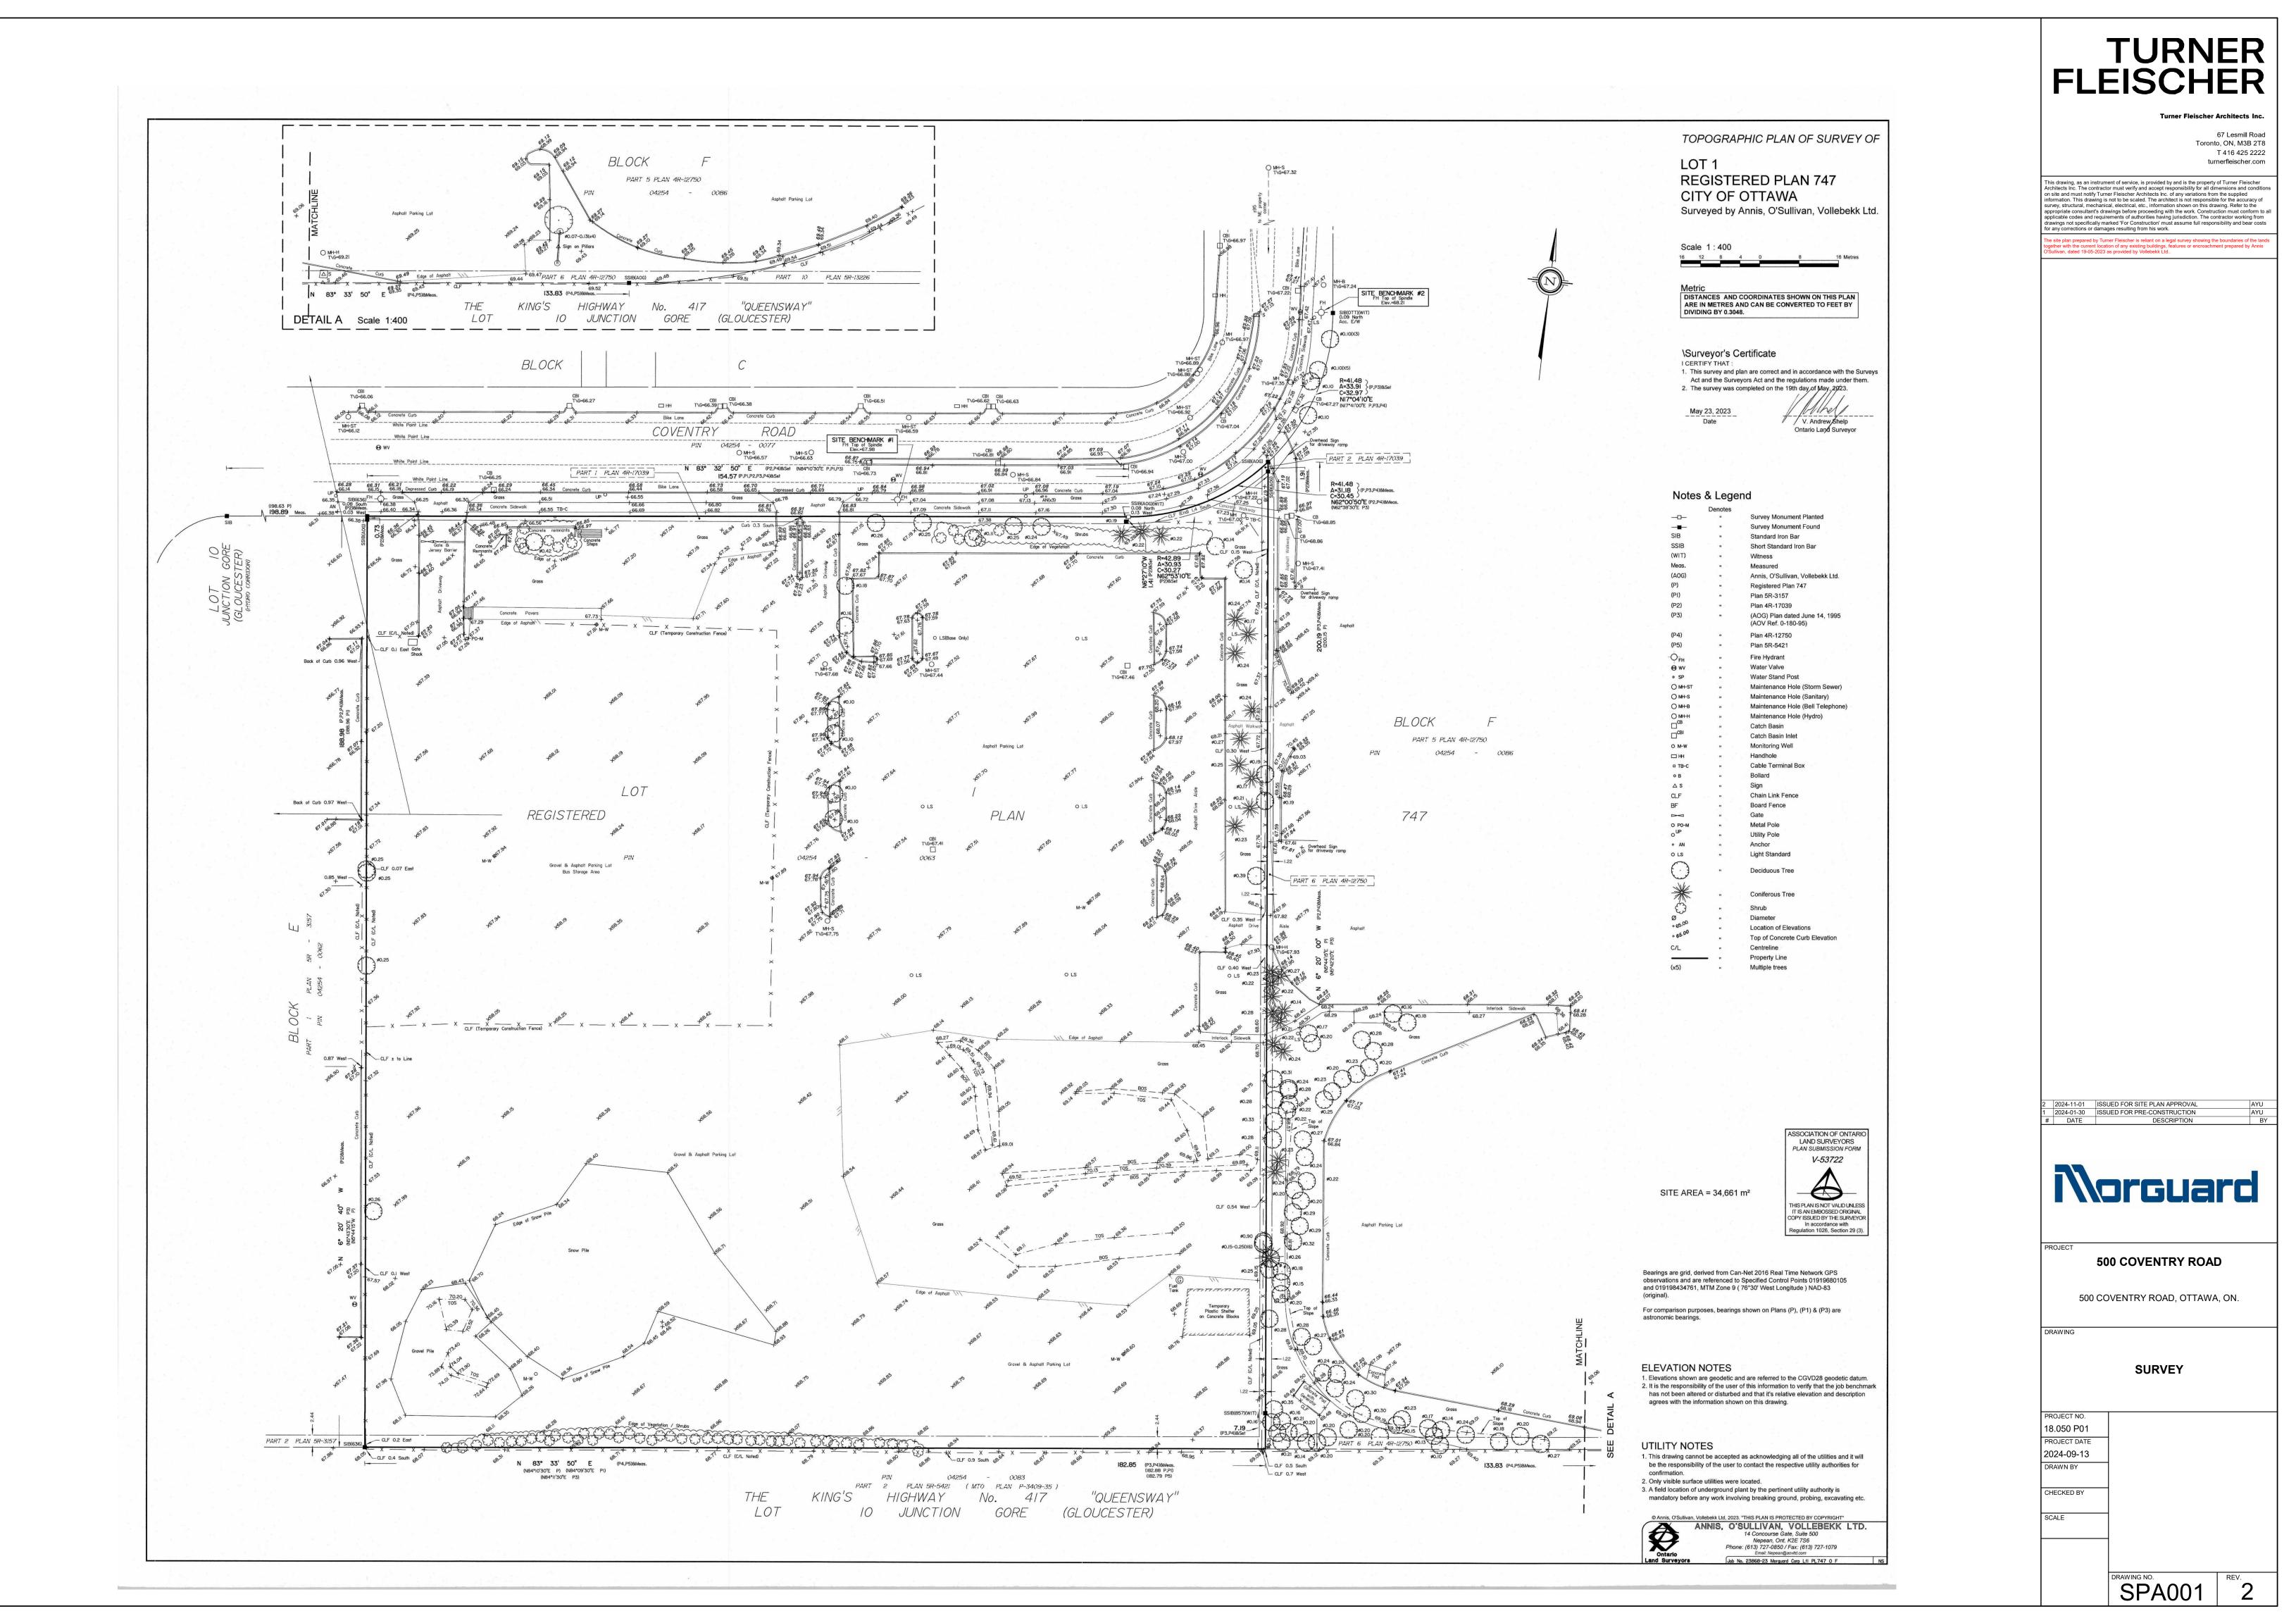


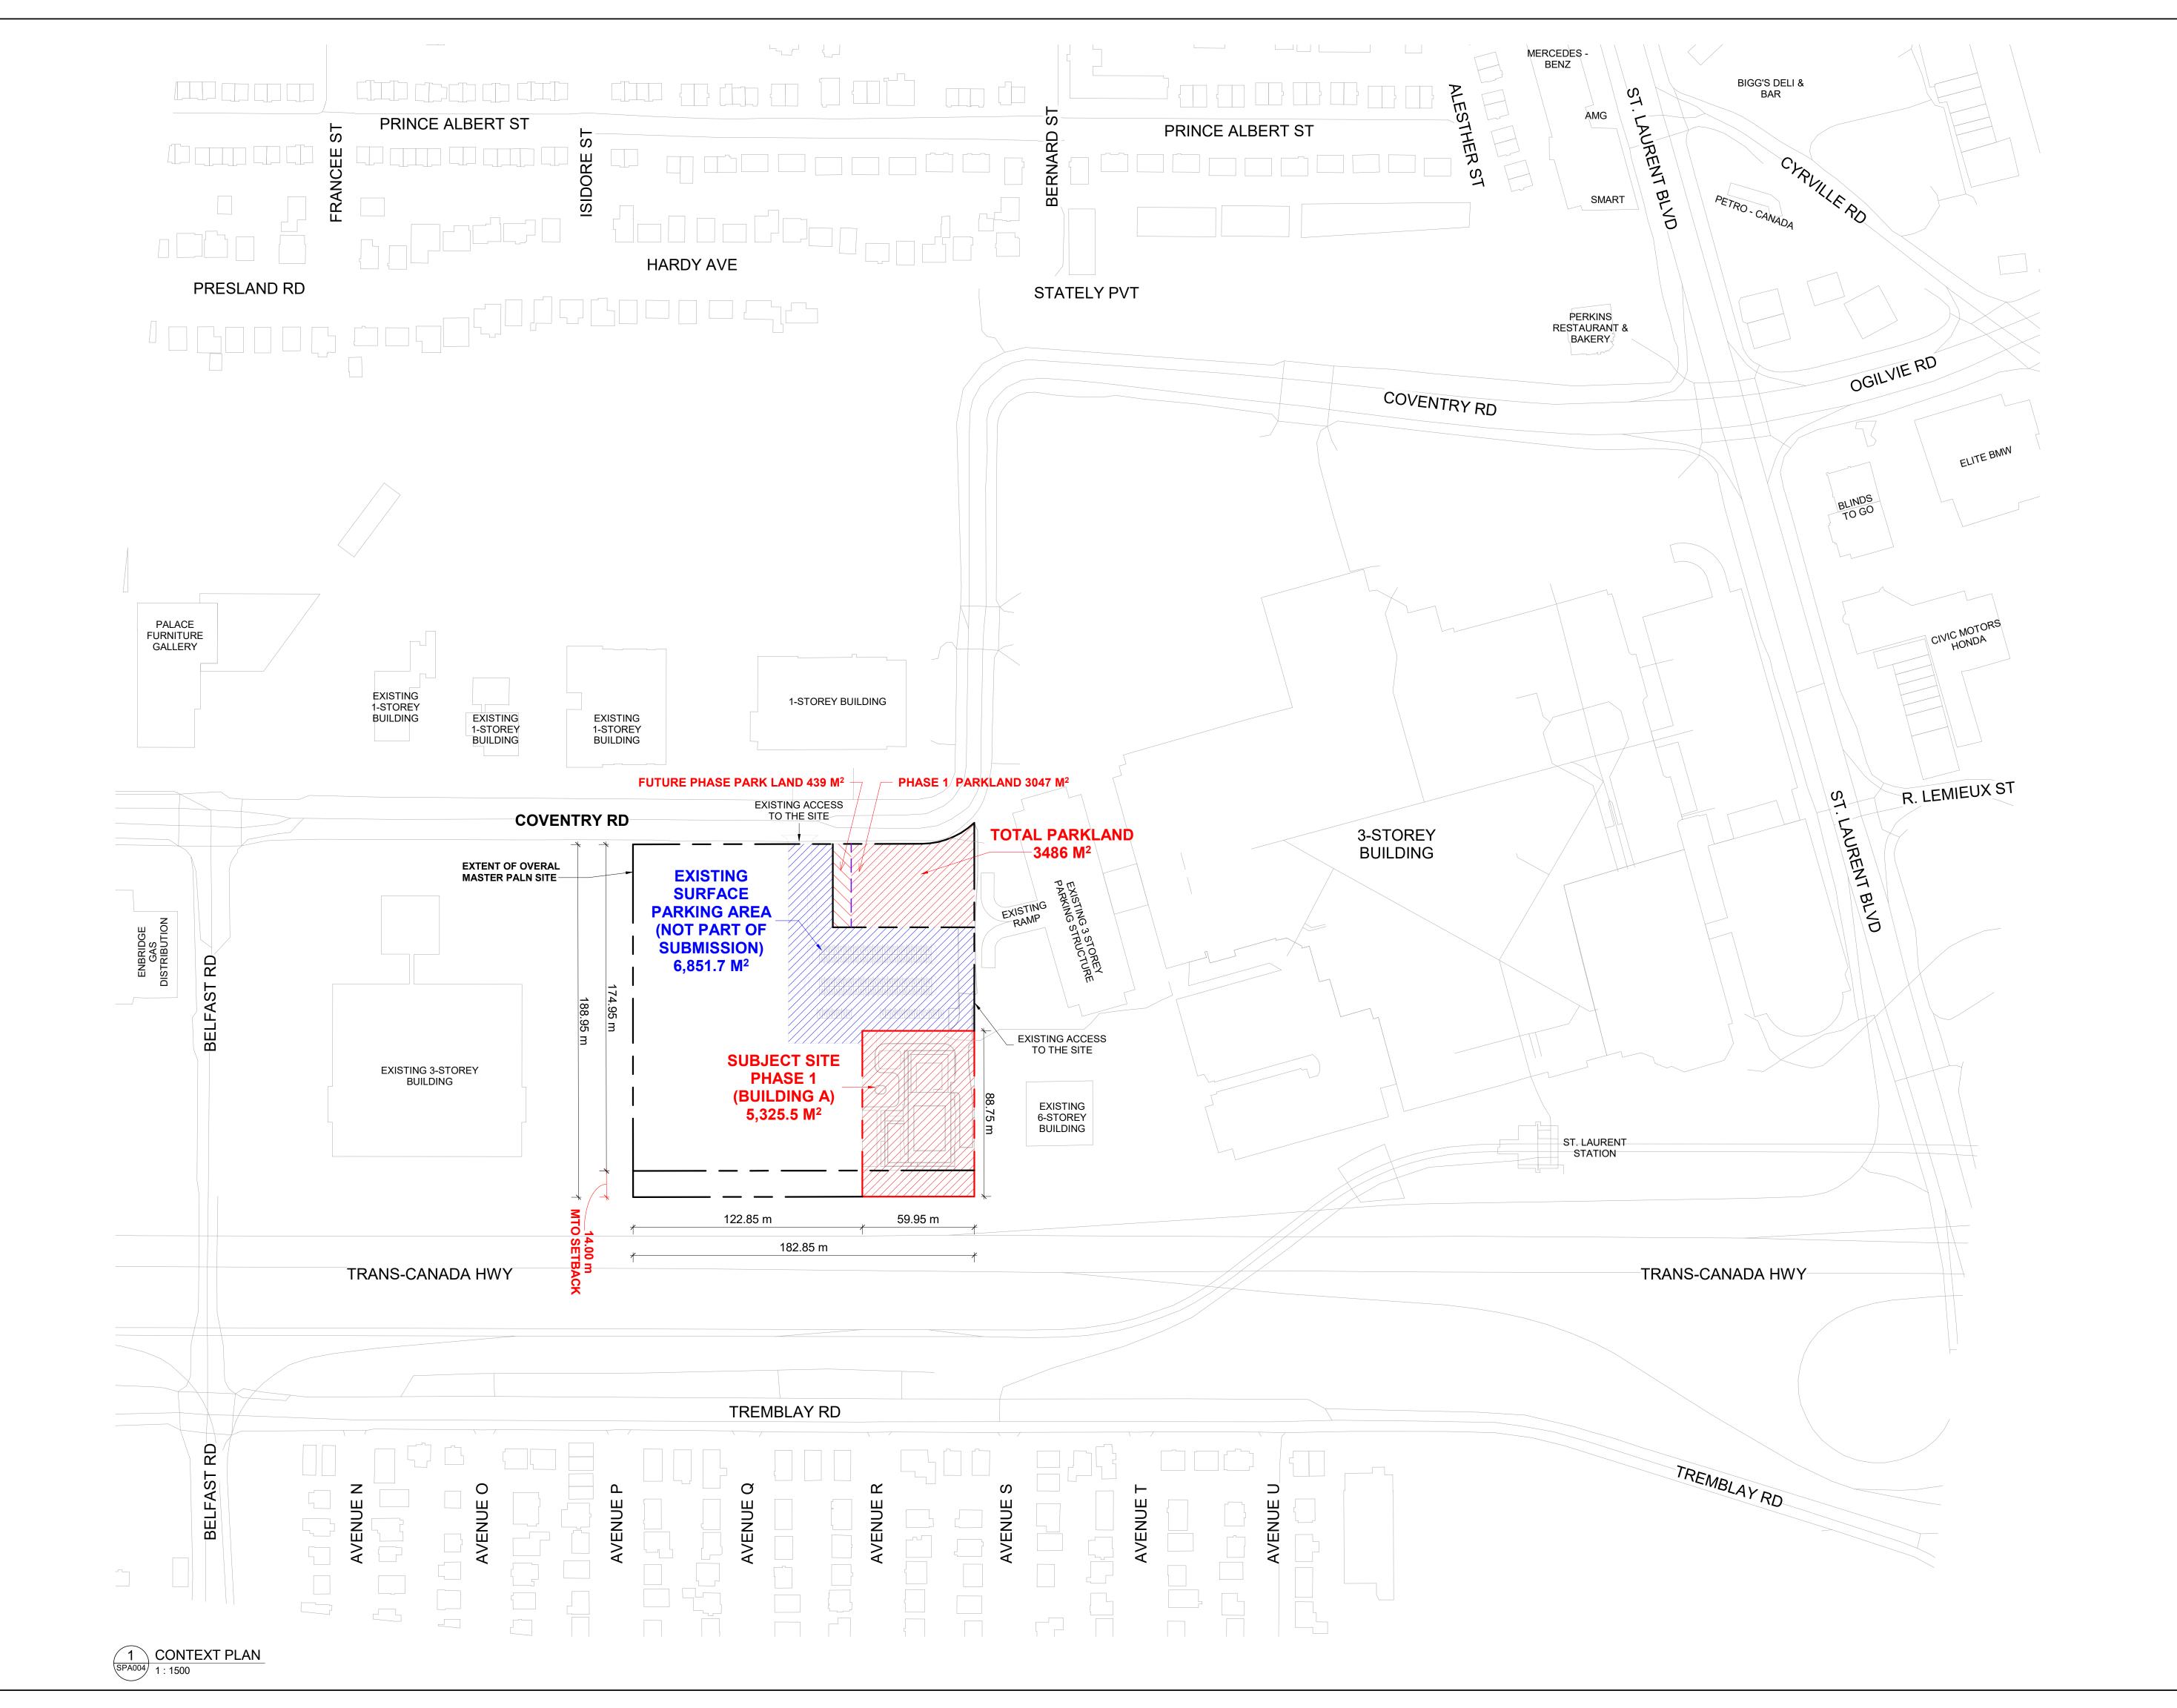


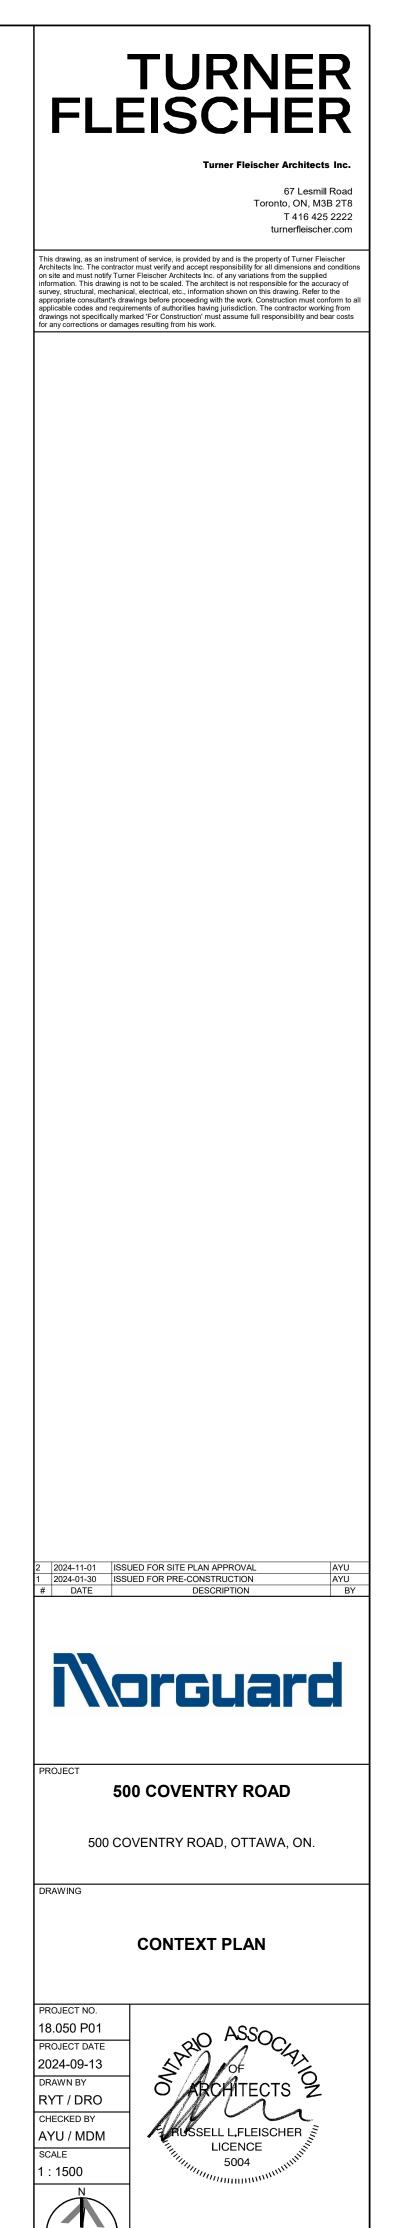


REV. 2

BRAWING NO. SPA004

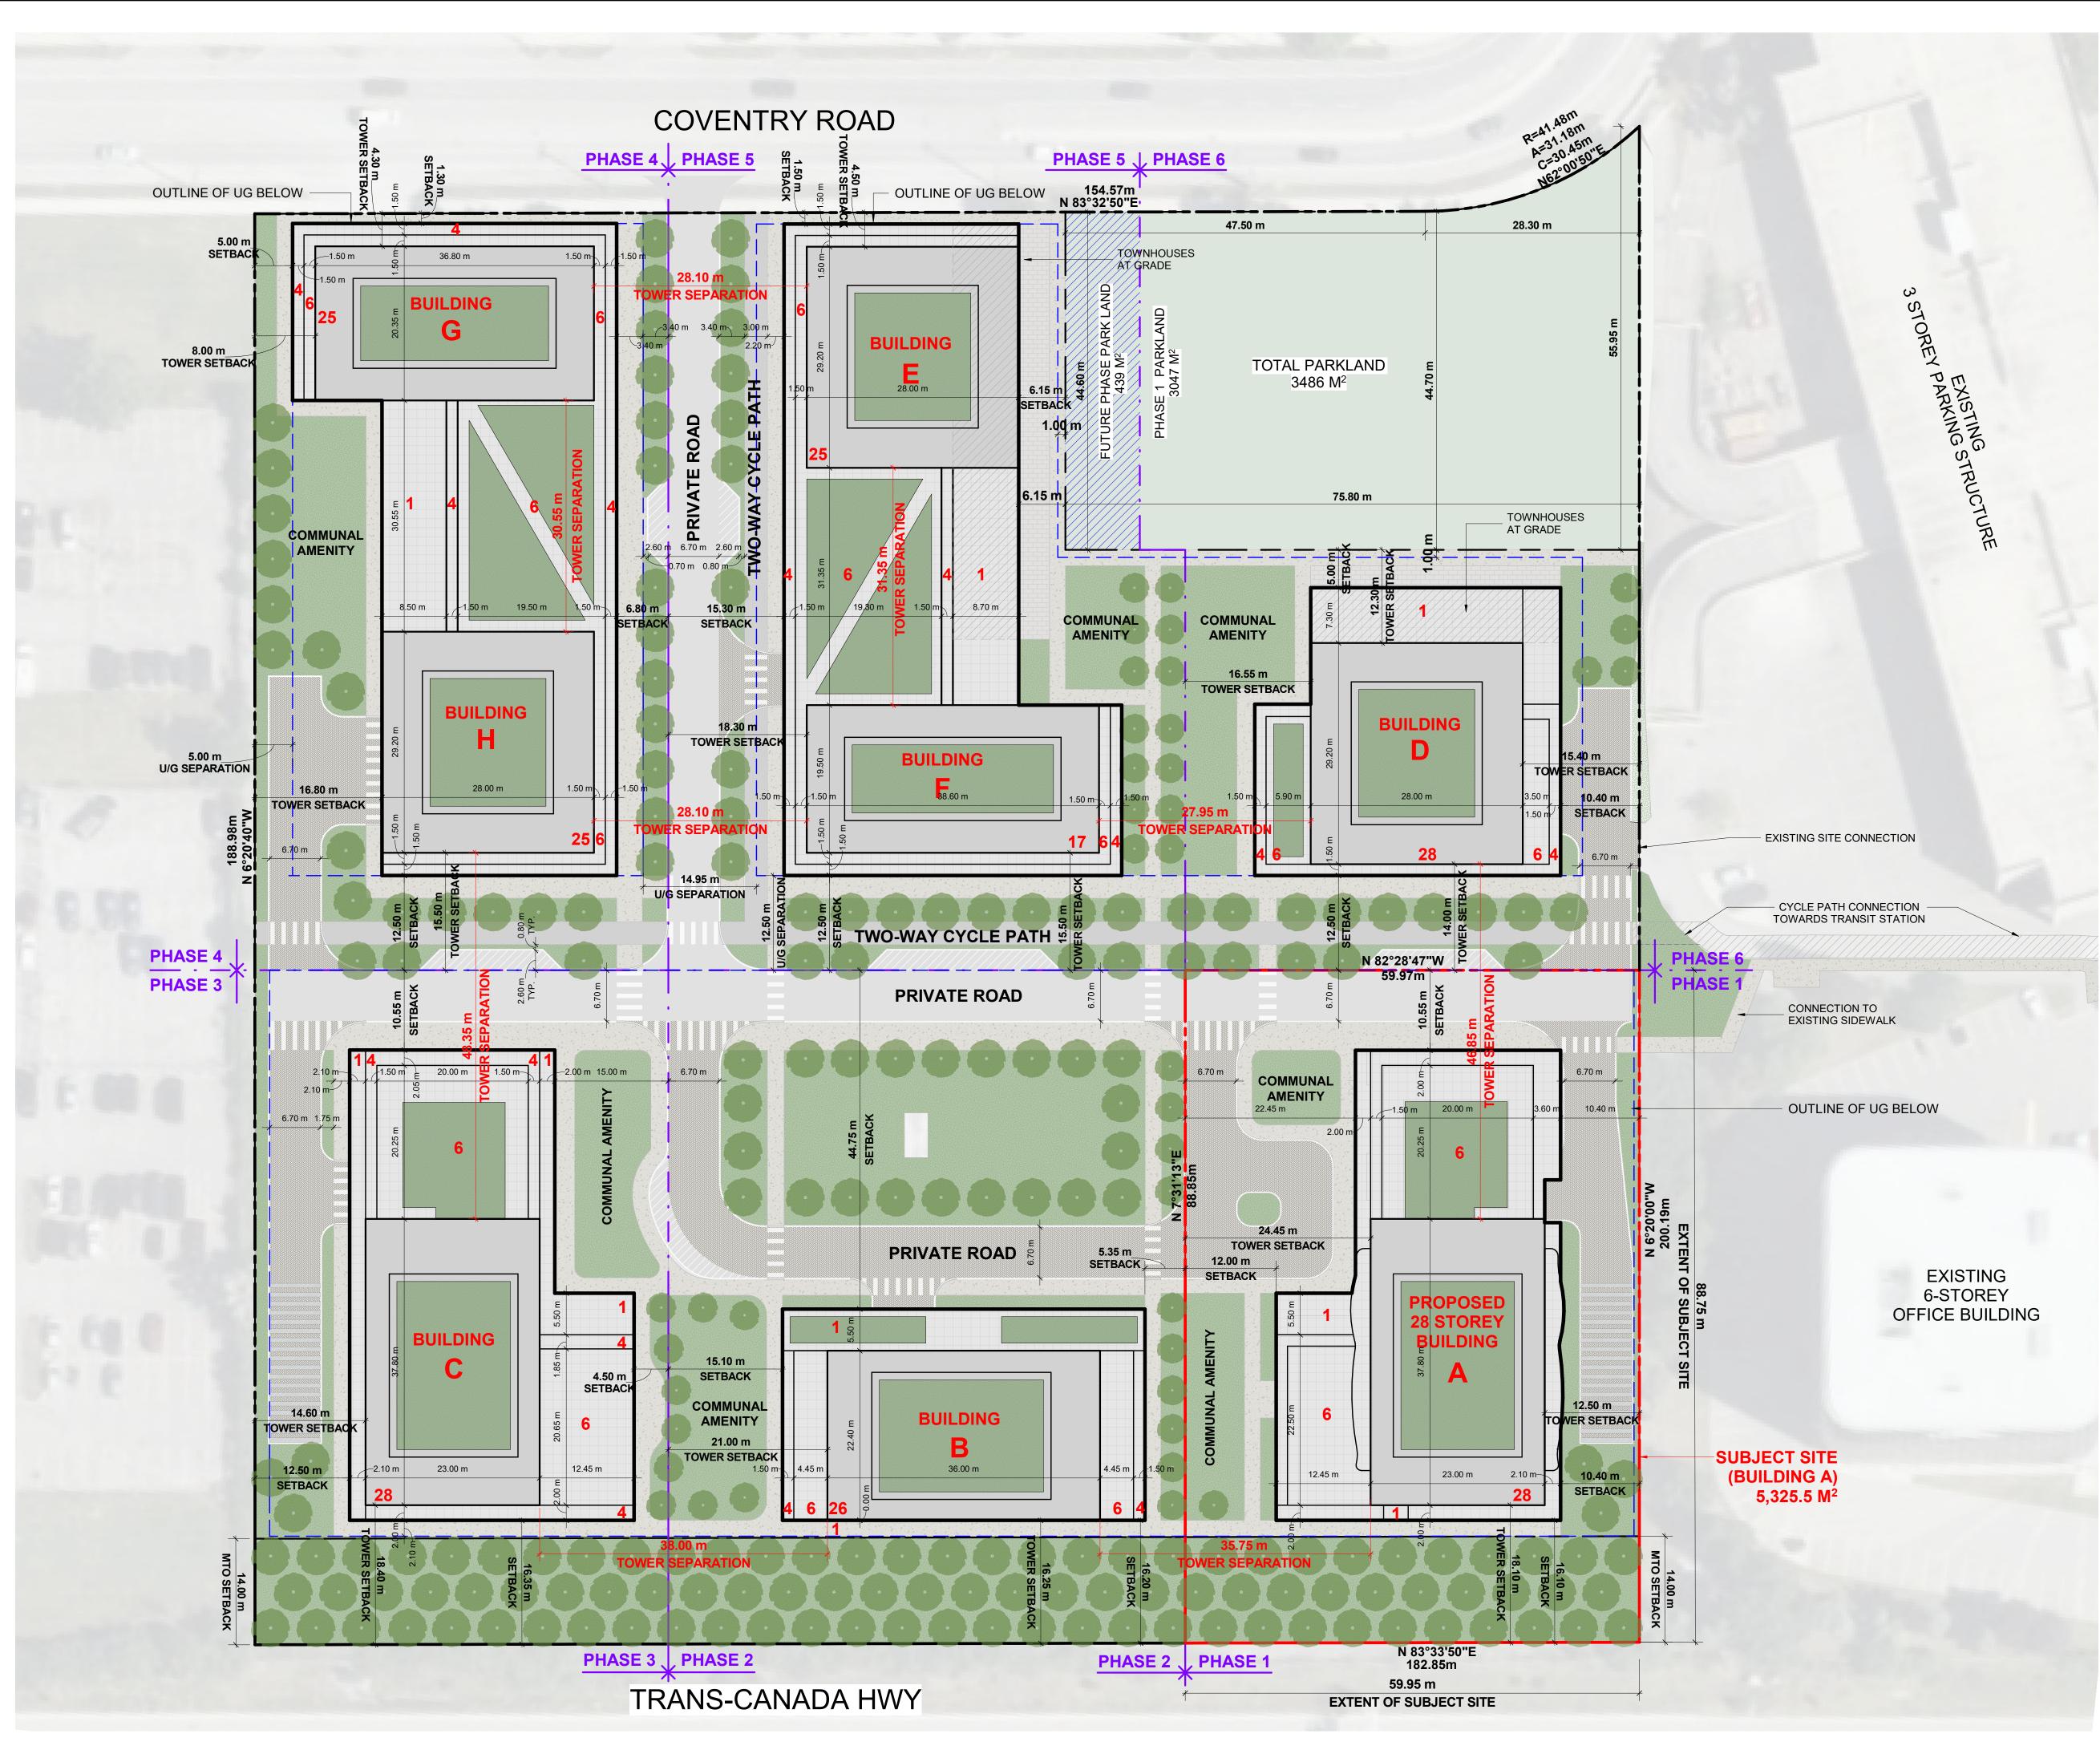


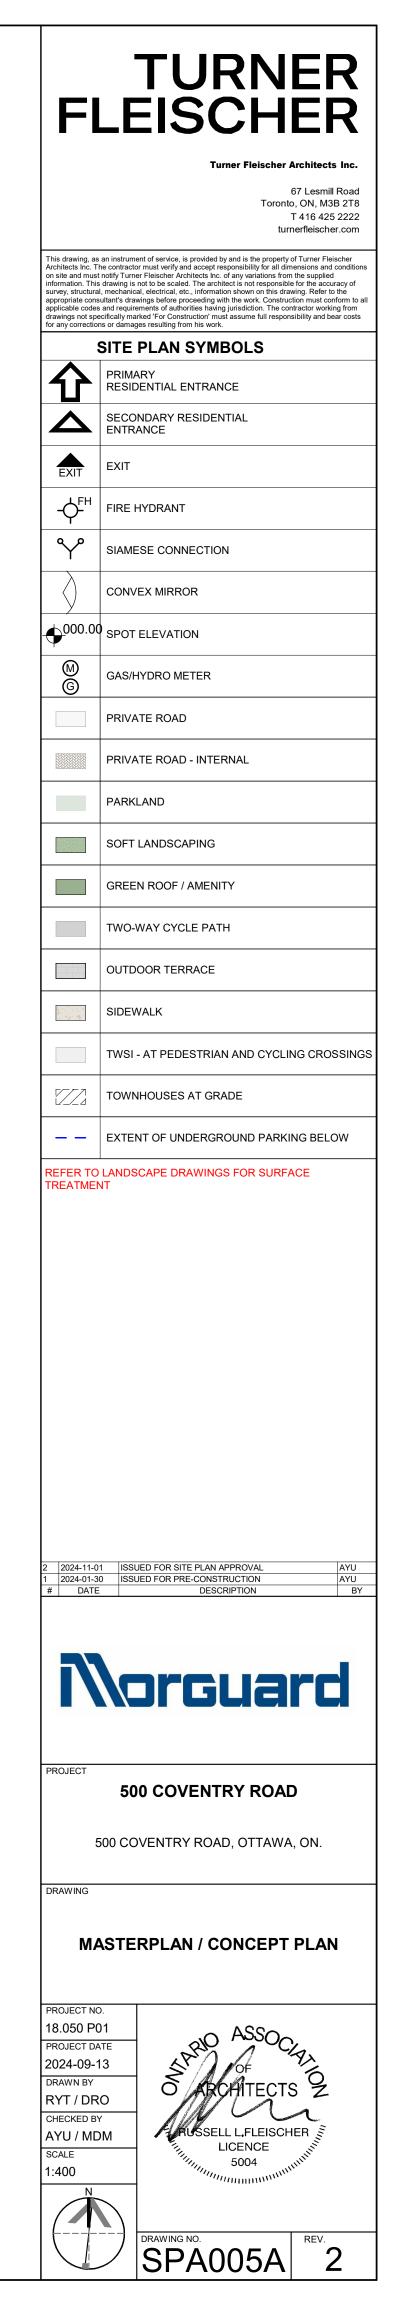

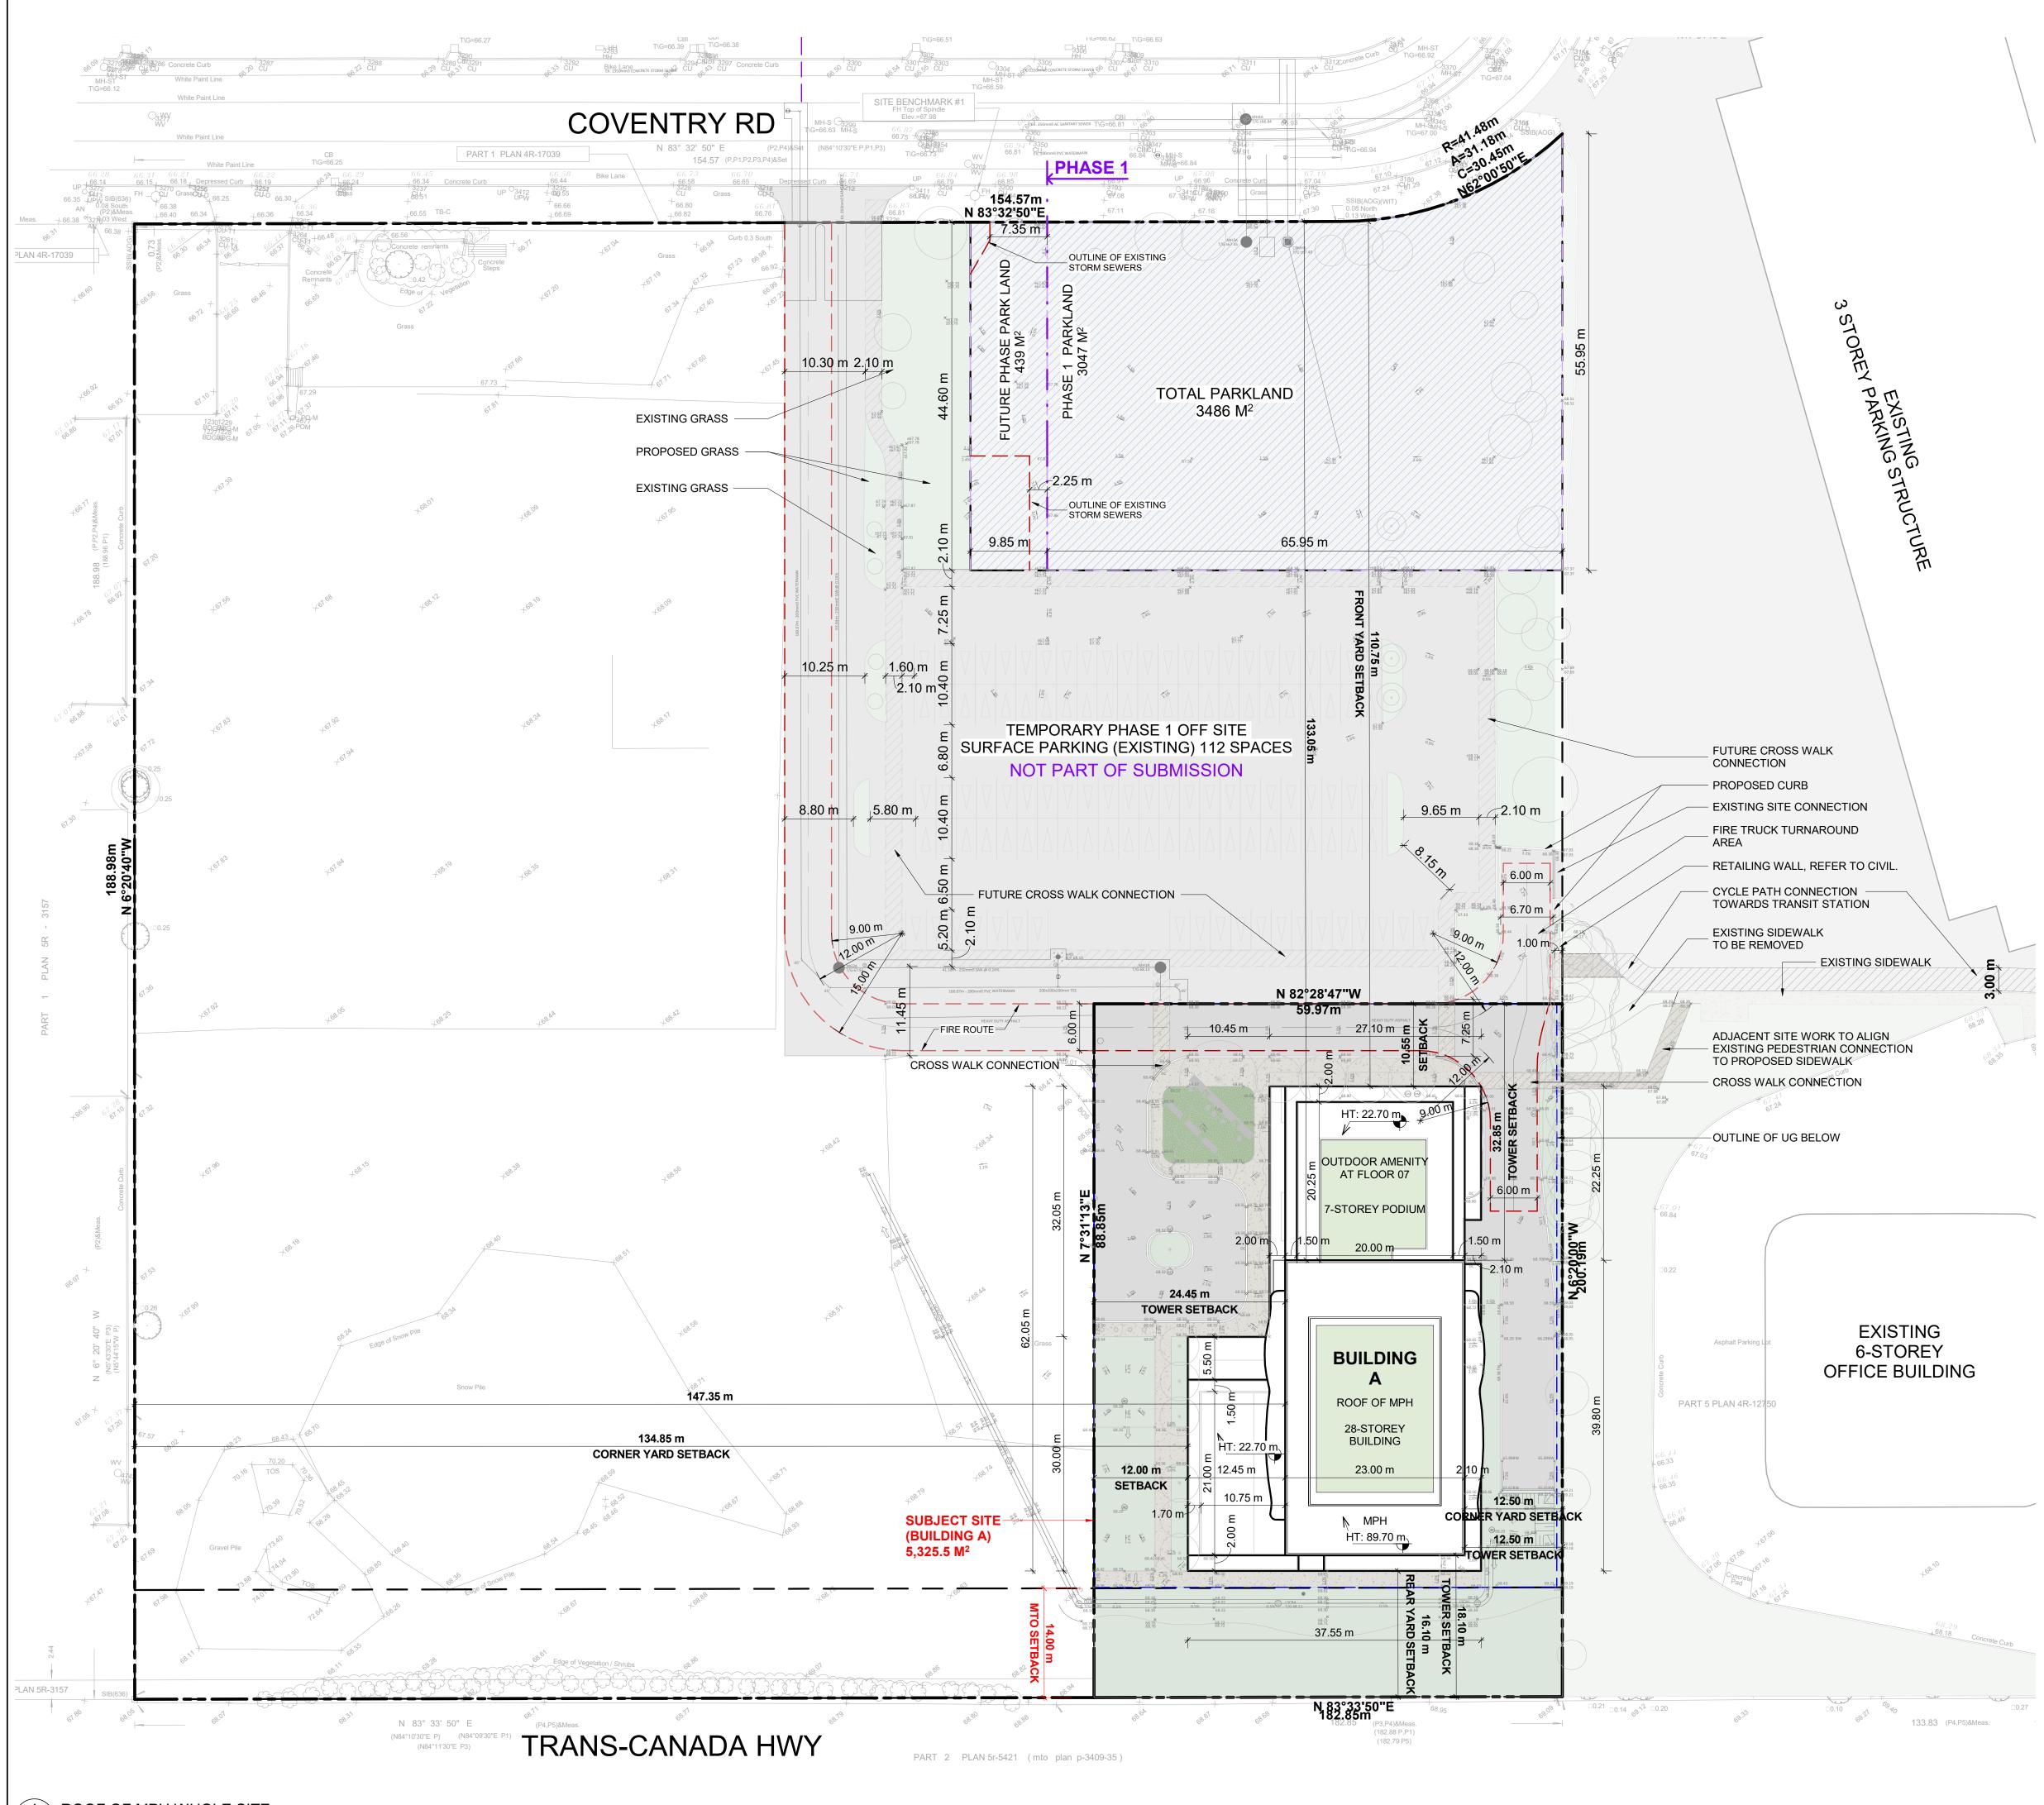


1 ROOF OF MPH WHOLE SITE SPA005B 1:400


AREA TYPE SITE AREA - BLDG A	m²	ft <sup>2</sup>		LE
TOTAL PARKLAND AREA	5,325		323.4 7,523	
TEMPORARY OFF SITE PARKING (PHASE 1) PHASE 1 SURFACE PARKING	6,85	7 73	751.1	
ZONING			This drawing	g, as an instrument o
BUILDING HEIGHT	REQUIRED 30 STOREY		on site and m information.	c. The contractor mu nust notify Turner FI This drawing is not t tural, mechanical, e
GRADE (GEODETIC ELEVATION - ASL)	90.0		applicable co drawings not	consultant's drawing odes and requirement t specifically marked actions or damages r
ALLOWABLE PROJECTION - AMENITY LEVEL DENSITY - MINIMUM 350 units/hectare	0.0		2.7M The site plan together with t	prepared by Turner F the current location o ted 19-05-2023 as pr
FRONT YARD SETBACK	3.0		.75M	SITE P
CORNER YARD SETBACK(East / West) REAR YARD SETBACK(GROUND TO 6th FLO	3.0M/3.0 OOR) 0.0		2.5M	PRIMAR
REAR YARD SETBACK (ABOVE 7th STOREY	() 12.0	DM 18	.10M	RESIDE
AMENITY AREA - TOTAL PER UNIT AMENITY AREA - 50% COMMUNAL PER UNIT	6.0 3.0		7.4M <sup>2</sup> 55M <sup>2</sup>	SECONE ENTRAN
AMENITY AREA - 2.0% OF LOT EXTERIOR AT GRADE COMMUNAL	117.15	M <sup>2</sup> 172	2.6M <sup>2</sup>	EXIT
VEHICLE PARKING - RESIDENTIAL (AREA 'Z'		DT	289	н
1.5/PER UNIT) VEHICLE PARKING - VISITOR ONLY (MAX. 30	REQUIRI	<u>-</u> D 30		FIRE HY
AFTER 12 UNITS)			Y^	SIAMES
BICYCLE PARKING - RESIDENTIAL - 0.5 PER AISLE & DRIVEWAY MINIMUM / MAXIMUM WI		65 7M	309 6.7M	CONVEX
GROSS BUILDING FLOOR AREA (OTTAWA ZO				
UG1	m²	ft²		.00 <sub>SPOT EI</sub>
FLOOR 01 FLOOR 02	4 000	6	4,419 <b>(</b> )	GAS/HY
FLOOR 03-05 1,339.6 m <sup>2</sup> x 3	1,339 3 4,018		3,257 REFER	TO LANDSC
FLOOR 06 FLOOR 07	1,224		3,176 TREATM	IENT
FLOOR 08 - FLOOR 28 725.2 m <sup>2</sup> x 21	15,229	.2 163	3,926	MINIMUN
TOTAL TYP. FLOOR PLATE	<b>22,443</b> 725		<b>1,582</b>	TYPICA
	120			
		UNIT	S	TYPICAL PA MIN 2.6 x 5.
1B 1B+D			58 82	
2B			77	×.
2B+D 3B			61 31	5200
TOTAL			309	
VEHICULAR PARKING SPACES REQUIRED- A				
VISITOR 0.1 SPACES PER UNIT AFT RESIDENTIAL N/A	TER 12 UNITS - MAX	30 30 0		6700 DRIVE AISLE
TOTAL		30		
VEHICULAR PARKING SPACES PROVIDED				2200
VISITOR 0.1 SPACES PER UNIT (309 RESIDENTIAL 0.56 SPACES PER UNIT (30	/	30 177		
TOTAL		177		
		207		TYPICA
		<b>207</b> 112 319		MIN 3.66 x 5
1.03 PER UNIT (309 UNITS)	)	112 319		MIN 3.66 x 5
TOTAL       1.03 PER UNIT (309 UNITS)         ACCESSIBLE PARKING SPACES REQUIRED -	)	112 319		MIN 3.66 x 5
TOTAL       1.03 PER UNIT (309 UNITS)         ACCESSIBLE PARKING SPACES REQUIRED -         TYPE 'A'         TYPE 'B'	)	112 319 IRFACE PARKI 3 4		MIN 3.66 x 5
TOTAL1.03 PER UNIT (309 UNITS)ACCESSIBLE PARKING SPACES REQUIRED -TYPE 'A'TYPE 'B'TOTAL	) (NOT INCLUDING SU	112 319 IRFACE PARKI 3 4 7	NG)	MIN 3.66 x 5
TOTAL       1.03 PER UNIT (309 UNITS)         ACCESSIBLE PARKING SPACES REQUIRED -         TYPE 'A'         TYPE 'B'         TOTAL         ACCESSIBLE PARKING SPACES PROVIDED -	) (NOT INCLUDING SU	112 319 IRFACE PARKI 3 4 7	NG)	MIN 3.66 x 5
TOTAL       1.03 PER UNIT (309 UNITS)         ACCESSIBLE PARKING SPACES REQUIRED -         TYPE 'A'         TYPE 'B'         ACCESSIBLE PARKING SPACES PROVIDED -         TYPE 'A'         TYPE 'A'         TYPE 'A'         TYPE 'B'         TOTAL         ACCESSIBLE PARKING SPACES PROVIDED -         TYPE 'A'         TYPE 'B'	) (NOT INCLUDING SU	112 319 IRFACE PARKI 3 4 7 IRFACE PARKI 3 5	NG)	MIN 3.66 x 5
TOTAL       1.03 PER UNIT (309 UNITS)         ACCESSIBLE PARKING SPACES REQUIRED -         TYPE 'A'         TYPE 'B'         ACCESSIBLE PARKING SPACES PROVIDED -         TYPE 'A'         TYPE 'A'         TYPE 'A'         TYPE 'B'         TOTAL         ACCESSIBLE PARKING SPACES PROVIDED -         TYPE 'A'         TYPE 'B'	) (NOT INCLUDING SU	112 319 IRFACE PARKI 3 4 7 IRFACE PARKI 3	NG)	MIN 3.66 x 5
TOTAL       1.03 PER UNIT (309 UNITS)         ACCESSIBLE PARKING SPACES REQUIRED -         TYPE 'A'         TOTAL         ACCESSIBLE PARKING SPACES PROVIDED -         TYPE 'A'         TYPE 'A'         TYPE 'A'         TYPE 'B'         ACCESSIBLE PARKING SPACES PROVIDED -         TYPE 'A'         TYPE 'B'         TYPE 'B'         TYPE 'B'	) (NOT INCLUDING SU	112 319 IRFACE PARKI 3 4 7 IRFACE PARKI 3 5	NG) NG) NG)	MIN 3.66 x 5
TOTAL       1.03 PER UNIT (309 UNITS)         ACCESSIBLE PARKING SPACES REQUIRED -         TYPE 'A'         TOTAL         ACCESSIBLE PARKING SPACES PROVIDED -         TYPE 'A'         TYPE 'A'         TYPE 'A'         TYPE 'A'         STANDARD PARKING SPACE         PARALLEL PARKING SPACE	) (NOT INCLUDING SU	112 319 IRFACE PARKI 3 4 7 IRFACE PARKI 3 5 <b>8</b> 2.6m X 5. 2.6m X 5.	NG) NG) NG) 2m 7m	MIN 3.66 x 5
TOTAL       1.03 PER UNIT (309 UNITS)         ACCESSIBLE PARKING SPACES REQUIRED -         TYPE 'A'         TYPE 'B'         ACCESSIBLE PARKING SPACES PROVIDED -         TYPE 'A'         TYPE 'A'         TYPE 'A'         STANDARD PARKING SPACE         PARALLEL PARKING SPACE         SMALL PARKING SPACE	) (NOT INCLUDING SU	112 319 IRFACE PARKI 3 4 7 IRFACE PARKI 3 5 8 8 2.6m X 5.	NG) NG) NG) 2m 7m 6m	MIN 3.66 x 5
TOTAL       1.03 PER UNIT (309 UNITS)         ACCESSIBLE PARKING SPACES REQUIRED -         TYPE 'A'         TYPE 'B'         ACCESSIBLE PARKING SPACES PROVIDED -         TYPE 'A'         TYPE 'B'         TOTAL         STANDARD PARKING SPACE         PARALLEL PARKING SPACE         SMALL PARKING SPACE         SMALL PARKING SPACE         ACCESSIBLE PARKING SPACE ' TYPE A '         ACCESSIBLE PARKING SPACE ' TYPE B '	) (NOT INCLUDING SU	112 319 IRFACE PARKI 3 4 7 IRFACE PARKI 3 5 8 2.6m X 5. 2.6m X 5. 2.6m X 6. 2.4m X 4. 3.4m X 5. 2.4m X 5.	NG) NG) NG) 2m 7m 6m 2m 2m	MIN 3.66 x 5
TOTAL       1.03 PER UNIT (309 UNITS)         ACCESSIBLE PARKING SPACES REQUIRED -         TYPE 'A'         TYPE 'B'         ACCESSIBLE PARKING SPACES PROVIDED -         TYPE 'A'         TYPE 'B'         ACCESSIBLE PARKING SPACES PROVIDED -         TYPE 'A'         TYPE 'B'         TOTAL         STANDARD PARKING SPACE         PARALLEL PARKING SPACE         SMALL PARKING SPACE         SMALL PARKING SPACE         ACCESSIBLE PARKING SPACE ' TYPE A '         ACCESSIBLE PARKING SPACE ' TYPE B '         LOADING SPACE	) (NOT INCLUDING SU	112 319 IRFACE PARKI 3 4 7 IRFACE PARKI 3 5 8 2.6m X 5. 2.6m X 5. 2.6m X 6. 2.4m X 4. 3.4m X 5.	NG) NG) 2m 7m 6m 2m 2m 2m 2m 2m 2m 2m 2m 2m 2m	MIN 3.66 x 5
TOTAL       1.03 PER UNIT (309 UNITS)         ACCESSIBLE PARKING SPACES REQUIRED -         TYPE 'A'         TYPE 'B'         ACCESSIBLE PARKING SPACES PROVIDED -         TYPE 'A'         TYPE 'B'         ACCESSIBLE PARKING SPACES PROVIDED -         TYPE 'A'         TYPE 'B'         TOTAL         STANDARD PARKING SPACE         PARALLEL PARKING SPACE         SMALL PARKING SPACE         SMALL PARKING SPACE         ACCESSIBLE PARKING SPACE ' TYPE A '         ACCESSIBLE PARKING SPACE ' TYPE A '         ACCESSIBLE PARKING SPACE ' TYPE B '         LOADING SPACE         BICYCLE PARKING SPACES REQUIRED         RESIDENTIAL       0.5 PER UNIT (309 UNITS)	) (NOT INCLUDING SU	112 319 IRFACE PARKI 3 4 7 IRFACE PARKI 3 5 8 2.6m X 5. 2.6m X 5. 2.6m X 6. 2.4m X 4. 3.4m X 5. 2.4m X 5. 3.5m X 7.	NG) NG) 2m 7m 6m 2m 2m 2m 2m 2m 2m 2m 2m 2m 2m	MIN 3.66 x 5
TOTAL       1.03 PER UNIT (309 UNITS)         ACCESSIBLE PARKING SPACES REQUIRED -         TYPE 'A'         TOTAL         ACCESSIBLE PARKING SPACES PROVIDED -         TYPE 'A'         TYPE 'A'         TYPE 'A'         TYPE 'A'         TYPE 'A'         TYPE 'A'         TYPE 'B'         TOTAL         STANDARD PARKING SPACES PROVIDED -         TYPE 'B'         TOTAL         STANDARD PARKING SPACE         PARALLEL PARKING SPACE         SMALL PARKING SPACE         SMALL PARKING SPACE         ACCESSIBLE PARKING SPACE ' TYPE A '         ACCESSIBLE PARKING SPACE ' TYPE A '         ACCESSIBLE PARKING SPACE ' TYPE B '         LOADING SPACE         BICYCLE PARKING SPACES REQUIRED         RESIDENTIAL       0.5 PER UNIT (309 UNITS)         TOTAL	) (NOT INCLUDING SU	112 319 IRFACE PARKI 3 4 7 IRFACE PARKI 3 5 8 2.6m X 5. 2.6m X 5. 2.6m X 6. 2.4m X 4. 3.4m X 5. 2.4m X 5. 3.5m X 7.	NG) NG) 2m 7m 6m 2m 2m 2m 2m 2m 2m 2m 2m 2m 2m	MIN 3.66 x 5
TOTAL       1.03 PER UNIT (309 UNITS)         ACCESSIBLE PARKING SPACES REQUIRED -         TYPE 'A'         TYPE 'B'         ACCESSIBLE PARKING SPACES PROVIDED -         TYPE 'A'         TYPE 'B'         ACCESSIBLE PARKING SPACES PROVIDED -         TYPE 'A'         TYPE 'B'         TOTAL         STANDARD PARKING SPACE         PARALLEL PARKING SPACE         SMALL PARKING SPACE         SMALL PARKING SPACE         ACCESSIBLE PARKING SPACE ' TYPE A '         ACCESSIBLE PARKING SPACE ' TYPE B '         LOADING SPACE         BICYCLE PARKING SPACES REQUIRED         BICYCLE PARKING SPACES PROVIDED	) (NOT INCLUDING SU	112 319 IRFACE PARKI 3 4 7 IRFACE PARKI 3 5 8 2.6m X 5. 2.6m X 5. 2.6m X 6. 2.4m X 4. 3.4m X 5. 2.4m X 5. 3.5m X 7.	NG) NG) 2m 7m 6m 2m 2m 2m 0m 2m 2m 0m 2 2 2024-1 1 2024-0 # DA	MIN 3.66 x 5
TOTAL       1.03 PER UNIT (309 UNITS)         ACCESSIBLE PARKING SPACES REQUIRED -         TYPE 'A'         TYPE 'B'         ACCESSIBLE PARKING SPACES PROVIDED -         TYPE 'A'         TYPE 'A'         TYPE 'A'         TYPE 'A'         TYPE 'A'         TYPE 'B'         TOTAL         STANDARD PARKING SPACES PROVIDED -         TYPE 'B'         TOTAL         STANDARD PARKING SPACE         PARALLEL PARKING SPACE         SMALL PARKING SPACE         SMALL PARKING SPACE         SMALL PARKING SPACE         SIBLE PARKING SPACE ' TYPE A '         ACCESSIBLE PARKING SPACE ' TYPE B '         LOADING SPACE         BICYCLE PARKING SPACES REQUIRED         RESIDENTIAL       0.5 PER UNIT (309 UNITS)         TOTAL         BICYCLE PARKING SPACES PROVIDED         RESIDENTIAL       INTERIOR         EXTERIOR	) (NOT INCLUDING SU	112 319 IRFACE PARKI 3 4 7 IRFACE PARKI 3 5 8 2.6m X 5. 2.6m X 5. 2.6m X 6. 2.4m X 4. 3.4m X 5. 2.4m X 5. 3.5m X 7. 155 155 309 0	NG) NG) 2m 7m 6m 2m 2m 2m 0m 2m 2m 0m 2 2 2024-1 1 2024-0 # DA	MIN 3.66 x 5
TOTAL       1.03 PER UNIT (309 UNITS)         ACCESSIBLE PARKING SPACES REQUIRED -         TYPE 'A'         TOTAL         ACCESSIBLE PARKING SPACES PROVIDED -         TYPE 'A'         TYPE 'A'         TYPE 'A'         TYPE 'A'         TYPE 'A'         TYPE 'B'         TOTAL         ACCESSIBLE PARKING SPACES PROVIDED -         TYPE 'B'         TOTAL         STANDARD PARKING SPACE         PARALLEL PARKING SPACE         SMALL PARKING SPACE         SMALL PARKING SPACE         SMALL PARKING SPACE         SIBLE PARKING SPACE ' TYPE A '         ACCESSIBLE PARKING SPACE ' TYPE B '         LOADING SPACE         BICYCLE PARKING SPACES REQUIRED         RESIDENTIAL       0.5 PER UNIT (309 UNITS)         TOTAL         BICYCLE PARKING SPACES PROVIDED         RESIDENTIAL       INTERIOR         EXTERIOR	) (NOT INCLUDING SU	112 319 IRFACE PARKI 3 4 7 IRFACE PARKI 3 5 8 2.6m X 5. 2.6m X 5. 2.6m X 6. 2.4m X 4. 3.4m X 5. 2.4m X 5. 3.5m X 7. 155 155	NG) NG) 2m 7m 6m 2m 2m 2m 0m 2m 2m 0m 2 2 2024-1 1 2024-0 # DA	MIN 3.66 x 5
TOTAL       1.03 PER UNIT (309 UNITS)         ACCESSIBLE PARKING SPACES REQUIRED -         TYPE 'A'         TYPE 'B'         ACCESSIBLE PARKING SPACES PROVIDED -         TYPE 'A'         TYPE 'B'         ACCESSIBLE PARKING SPACES PROVIDED -         TYPE 'B'         TOTAL         STANDARD PARKING SPACE         PARALLEL PARKING SPACE         SMALL PARKING SPACE         SMALL PARKING SPACE         SMALL PARKING SPACE         SIBLE PARKING SPACE         SIBLE PARKING SPACE         SIBLE PARKING SPACE         SIBLE PARKING SPACE         SIGYCLE PARKING SPACES REQUIRED         RESIDENTIAL       0.5 PER UNIT (309 UNITS)         TOTAL       INTERIOR         EXTERIOR       EXTERIOR         TOTAL       1.0 PER UNIT (309 UNITS)	) (NOT INCLUDING SU	112 319 IRFACE PARKI 3 4 7 IRFACE PARKI 3 5 8 2.6m X 5. 2.6m X 5. 2.6m X 6. 2.4m X 4. 3.4m X 5. 2.4m X 5. 3.5m X 7. 155 155 309 0	NG) NG) 2m 7m 6m 2m 2m 0m 2m 2m 0m 2 2 2 2024-1 1 2024-0 # DA	MIN 3.66 x 5
TOTAL       1.03 PER UNIT (309 UNITS)         ACCESSIBLE PARKING SPACES REQUIRED -         TYPE 'A'         TYPE 'B'         ACCESSIBLE PARKING SPACES PROVIDED -         TYPE 'A'         TYPE 'B'         TOTAL         ACCESSIBLE PARKING SPACES PROVIDED -         TYPE 'A'         TYPE 'B'         TOTAL         STANDARD PARKING SPACE         PARALLEL PARKING SPACE         SMALL PARKING SPACE         SMALL PARKING SPACE         SMALL PARKING SPACE         ACCESSIBLE PARKING SPACE ' TYPE A '         ACCESSIBLE PARKING SPACE ' TYPE A '         ACCESSIBLE PARKING SPACE ' TYPE B '         LOADING SPACE         BICYCLE PARKING SPACES REQUIRED         RESIDENTIAL       0.5 PER UNIT (309 UNITS)         TOTAL         BICYCLE PARKING SPACES PROVIDED         RESIDENTIAL       INTERIOR         EXTERIOR         TOTAL       1.0 PER UNIT (309 UNITS)	) (NOT INCLUDING SU (NOT INCLUDING SU INCLUDING SU INC	112 319 IRFACE PARKI 3 4 7 IRFACE PARKI 3 5 8 2.6m X 5. 2.6m X 6. 2.4m X 4. 3.4m X 5. 2.4m X 5. 2.4m X 5. 3.5m X 7. 155 155 309 0 309	NG) NG) 2m 7m 6m 2m 2m 0m 2 2024-1 1 2024-0 # DA	MIN 3.66 x 5
TOTAL       1.03 PER UNIT (309 UNITS)         ACCESSIBLE PARKING SPACES REQUIRED -         TYPE 'A'         TYPE 'B'         ACCESSIBLE PARKING SPACES PROVIDED -         TYPE 'A'         TYPE 'B'         ACCESSIBLE PARKING SPACES PROVIDED -         TYPE 'B'         TOTAL         STANDARD PARKING SPACE         PARALLEL PARKING SPACE         SMALL PARKING SPACE         SMALL PARKING SPACE         SMALL PARKING SPACE         STANDARD PARKING SPACE         BICYCLE PARKING SPACE         BICYCLE PARKING SPACES REQUIRED         RESIDENTIAL       0.5 PER UNIT (309 UNITS)         TOTAL         BICYCLE PARKING SPACES PROVIDED         RESIDENTIAL       1.0 PER UNIT (309 UNITS)         AMENITY AREA         GRADE EXTERIOR - COMMUNAL	) (NOT INCLUDING SU (NOT INCLUDING SU INCLUDING SU INC	112 319 IRFACE PARKI 3 4 7 IRFACE PARKI 3 5 8 2.6m X 5. 2.6m X 6. 2.4m X 4. 3.4m X 5. 2.4m X 5. 2.4m X 5. 3.5m X 7. 155 155 309 0 309 0 309	NG) NG) 2m 7m 6m 2m 2m 0m 2 2024-1 1 2024-0 # DA 0m 1,858	MIN 3.66 x 5
TOTAL       1.03 PER UNIT (309 UNITS)         ACCESSIBLE PARKING SPACES REQUIRED -         TYPE 'A'         TYPE 'B'         ACCESSIBLE PARKING SPACES PROVIDED -         TYPE 'A'         TYPE 'B'         ACCESSIBLE PARKING SPACES PROVIDED -         TYPE 'A'         TYPE 'B'         TOTAL         ACCESSIBLE PARKING SPACE         PARALLEL PARKING SPACE         SMALL PARKING SPACE         SMALL PARKING SPACE         SMALL PARKING SPACE         SIGUESIBLE PARKING SPACE ' TYPE A '         ACCESSIBLE PARKING SPACE ' TYPE A '         ACCESSIBLE PARKING SPACE ' TYPE B '         LOADING SPACE         BICYCLE PARKING SPACES REQUIRED         RESIDENTIAL       0.5 PER UNIT (309 UNITS)         TOTAL       1.0 PER UNIT (309 UNITS)         AMENITY AREA       AMENITY AREA         GRADE EXTERIOR - COMMUNAL       07F EXTERIOR - COMMUNAL	) (NOT INCLUDING SU (NOT INCLUDING SU (NOT INCLUDING SU 1000 100 1000 1	112         319         IRFACE PARKI         3         4         7         IRFACE PARKI         3         4         7         IRFACE PARKI         3         5         8         2.6m X 5.         2.6m X 6.         2.4m X 4.         3.4m X 5.         2.4m X 5.         3.5m X 7.         155         155         309         0         309         0         309         0         309         1         1	NG) NG) 2m 7m 6m 2m 2m 0m 2 2024-1 1 2024-0 # DA 1 2024-0 # DA 1 2024-0 # DA	MIN 3.66 x 5
TOTAL       1.03 PER UNIT (309 UNITS)         ACCESSIBLE PARKING SPACES REQUIRED -         TYPE 'A'         TYPE 'B'         ACCESSIBLE PARKING SPACES PROVIDED -         TYPE 'A'         TYPE 'B'         TOTAL         ACCESSIBLE PARKING SPACES PROVIDED -         TYPE 'A'         TYPE 'B'         TOTAL         STANDARD PARKING SPACE         PARALLEL PARKING SPACE         SMALL PARKING SPACE         SMALL PARKING SPACE         SMALL PARKING SPACE         SIDARDING SPACE         BICYCLE PARKING SPACES REQUIRED         RESIDENTIAL       0.5 PER UNIT (309 UNITS)         TOTAL         BICYCLE PARKING SPACES PROVIDED         RESIDENTIAL       INTERIOR         EXTERIOR         TOTAL         BICYCLE PARKING SPACES PROVIDED         RESIDENTIAL       INTERIOR         GRADE EXTERIOR - COMMUNAL         INTERIOR - COMMUNAL         O7F EXTERIOR - COMMUNAL         TOTAL COMMUNAL	) (NOT INCLUDING SU (NOT INCLUDING SU (NOT INCLUDING SU ) (NOT INCLUDING SU ) ) (NOT INCLUDING SU ) ) (NOT INCLUDING SU ) ) ) ) ) ) ) ) ) ) ) ) )	112 319 URFACE PARKI 3 4 7 URFACE PARKI 3 2.6m X 5. 2.6m X 5. 2.6m X 6. 2.4m X 4. 3.4m X 5. 2.4m X 5. 3.5m X 7. 155 155 309 0 309 0 309 0 309 0 309	NG) NG) 2m 7m 6m 2m 2m 2m 0m 2 2024-1 1 2024-0 # DA PROJECT 1,858 1,791 2,175 5,824 7,741	MIN 3.66 x 5
TOTAL       1.03 PER UNIT (309 UNITS)         ACCESSIBLE PARKING SPACES REQUIRED -         TYPE 'A'         TYPE 'B'         ACCESSIBLE PARKING SPACES PROVIDED -         TYPE 'A'         TYPE 'B'         TOTAL         ACCESSIBLE PARKING SPACES PROVIDED -         TYPE 'A'         TYPE 'B'         TOTAL         STANDARD PARKING SPACE         PARALLEL PARKING SPACE         SMALL PARKING SPACE         SMALL PARKING SPACE         SMALL PARKING SPACE         STANDARD PARKING SPACE         STANDARD PARKING SPACE         BICYCLE PARKING SPACE         BICYCLE PARKING SPACES REQUIRED         RESIDENTIAL       0.5 PER UNIT (309 UNITS)         TOTAL       1.0 PER UNIT (309 UNITS)         RESIDENTIAL       INTERIOR         EXTERIOR       1.0 PER UNIT (309 UNITS)         AMENITY AREA       AMENITY AREA         GRADE EXTERIOR - COMMUNAL       07F EXTERIOR - COMMUNAL         D7F EXTERIOR - COMMUNAL       07F EXTERIOR - COMMUNAL         BALCONIES / TERRACE - PRIVATE       DIVATE	) (NOT INCLUDING SU (NOT INCLUDING SU (NOT INCLUDING SU	112         319         IRFACE PARKI         3         4         7         IRFACE PARKI         3         4         7         IRFACE PARKI         3         2.6m X 5.         2.6m X 5.         2.6m X 6.         2.4m X 4.         3.4m X 5.         2.4m X 5.         3.5m X 7.         155         309         0         309         0         309         0         309         1         2       37	NG) NG) 2m 7m 6m 2m 2m 0m 2 2024-1 1 2024-0 # DA 0m 2 2024-1 1 2024-0 # DA 1,858 1,791 2,175 5,824	MIN 3.66 x 5
TOTAL       1.03 PER UNIT (309 UNITS)         ACCESSIBLE PARKING SPACES REQUIRED -         TYPE 'A'         TOTAL         ACCESSIBLE PARKING SPACES PROVIDED -         TYPE 'A'         TYPE 'B'         TOTAL         ACCESSIBLE PARKING SPACES PROVIDED -         TYPE 'B'         TOTAL         STANDARD PARKING SPACE         PARALLEL PARKING SPACE         SMALL PARKING SPACE         SMALL PARKING SPACE         ACCESSIBLE PARKING SPACE ' TYPE A '         ACCESSIBLE PARKING SPACE ' TYPE A '         ACCESSIBLE PARKING SPACE ' TYPE B '         LOADING SPACE         BICYCLE PARKING SPACES REQUIRED         RESIDENTIAL       0.5 PER UNIT (309 UNITS)         TOTAL       1.0 PER UNIT (309 UNITS)         AMENITY AREA       EXTERIOR         GRADE EXTERIOR - COMMUNAL       07F EXTERIOR - COMMUNAL         07F EXTERIOR - COMMUNAL       07F EXTERIOR - COMMUNAL         BALCONIES / TERRACE - PRIVATE       TOTAL         REQUIRED (309 UNITS X 6 m²) = 1,854 sq. m.	) (NOT INCLUDING SU (NOT INCLUDING SU (NOT INCLUDING SU	112         319         IRFACE PARKI         3         4         7         IRFACE PARKI         3         4         7         IRFACE PARKI         3         2.6m X 5.         2.6m X 5.         2.6m X 6.         2.4m X 4.         3.4m X 5.         2.4m X 5.         3.5m X 7.         155         309         0         309         0         309         0         309         1         2       37	NG) NG) 2m 7m 6m 2m 2m 0m 2 2024-1 1 2024-0 # DA 0m 2 2024-1 1 2024-0 # DA 0 PROJECT 1,858 1,791 2,175 5,824 7,741 B,565 DRAWING	MIN 3.66 x 5
TOTAL       1.03 PER UNIT (309 UNITS)         ACCESSIBLE PARKING SPACES REQUIRED -         TYPE 'A'         TYPE 'B'         TOTAL         ACCESSIBLE PARKING SPACES PROVIDED -         TYPE 'A'         TYPE 'B'         TOTAL         ACCESSIBLE PARKING SPACES PROVIDED -         TYPE 'B'         TOTAL         STANDARD PARKING SPACE         PARALLEL PARKING SPACE         SMALL PARKING SPACE         SMALL PARKING SPACE         ACCESSIBLE PARKING SPACE ' TYPE A '         ACCESSIBLE PARKING SPACE ' TYPE B '         LOADING SPACE         BICYCLE PARKING SPACES REQUIRED         RESIDENTIAL       0.5 PER UNIT (309 UNITS)         TOTAL         BICYCLE PARKING SPACES PROVIDED         RESIDENTIAL       INTERIOR         EXTERIOR         TOTAL         BICYCLE PARKING SPACES PROVIDED         RESIDENTIAL       INTERIOR         GRADE EXTERIOR - COMMUNAL         OTF EXTERIOR - COMMUNAL         OTF EXTERIOR - COMMUNAL         BALCONIES / TERRACE - PRIVATE         TOTAL         REQUIRED (309 UNITS X 6 m²) = 1,854 sq. m.	) (NOT INCLUDING SU (NOT INCLUDING SU (NOT INCLUDING SU	112         319         IRFACE PARKI         3         4         7         IRFACE PARKI         3         4         7         IRFACE PARKI         3         2.6m X 5.         2.6m X 5.         2.6m X 6.         2.4m X 4.         3.4m X 5.         2.4m X 5.         3.5m X 7.         155         309         0         309         0         309         0         309         1         2       37	NG) NG) 2m 7m 6m 2m 2m 0m 2 2024-1 1 2024-0 # DA 0m 2 2024-1 1 2024-0 # DA 0 PROJECT 1,858 1,791 2,175 5,824 7,741 B,565 DRAWING	MIN 3.66 x 5
TOTAL       1.03 PER UNIT (309 UNITS)         ACCESSIBLE PARKING SPACES REQUIRED -         TYPE 'A'         TYPE 'B'         TOTAL         ACCESSIBLE PARKING SPACES PROVIDED -         TYPE 'A'         TYPE 'B'         TYPE 'B'         TOTAL         STANDARD PARKING SPACE         PARALLEL PARKING SPACE         SMALL PARKING SPACE         SMALL PARKING SPACE         SMALL PARKING SPACE         SIGYCLE PARKING SPACE         BICYCLE PARKING SPACES REQUIRED         RESIDENTIAL       0.5 PER UNIT (309 UNITS)         TOTAL         BICYCLE PARKING SPACES PROVIDED         RESIDENTIAL       INTERIOR         EXTERIOR         GRADE EXTERIOR - COMMUNAL         INTERIOR - COMMUNAL         O7F EXTERIOR - COMMUNAL         BALCONIES / TERRACE - PRIVATE         TOTAL         REQUIRED (309 UNITS X 6 m²) = 1,854 sq. m.         REQUIRED COMMUNAL @ 50% = 927 sq. m.	) (NOT INCLUDING SU (NOT INCLUDING SU (NOT INCLUDING SU	112         319         IRFACE PARKI         3         4         7         IRFACE PARKI         3         4         7         IRFACE PARKI         3         2.6m X 5.         2.6m X 5.         2.6m X 6.         2.4m X 4.         3.4m X 5.         2.4m X 5.         3.5m X 7.         155         309         0         309         0         309         0         309         1         2       37	NG) NG) 2m 7m 6m 2m 2m 0m 2 2024-1 1 2024-0 # DA 0m 2 2024-1 1 2024-0 # DA 0 PROJECT 1,858 1,791 2,175 5,824 7,741 B,565 DRAWING	MIN 3.66 x 5
TOTAL       1.03 PER UNIT (309 UNITS)         ACCESSIBLE PARKING SPACES REQUIRED -         TYPE 'A'         TYPE 'B'         TOTAL         ACCESSIBLE PARKING SPACES PROVIDED -         TYPE 'A'         TYPE 'B'         TOTAL         ACCESSIBLE PARKING SPACES PROVIDED -         TYPE 'A'         TYPE 'B'         TOTAL         STANDARD PARKING SPACE         PARALLEL PARKING SPACE         SMALL PARKING SPACE         SMALL PARKING SPACE         SMALL PARKING SPACE         SIBLE PARKING SPACE ' TYPE A '         ACCESSIBLE PARKING SPACE ' TYPE B '         LOADING SPACE         BICYCLE PARKING SPACES REQUIRED         RESIDENTIAL       0.5 PER UNIT (309 UNITS)         TOTAL       0.5 PER UNIT (309 UNITS)         TOTAL       1.0 PER UNIT (309 UNITS)         AMENITY AREA       EXTERIOR         GRADE EXTERIOR - COMMUNAL       07F EXTERIOR - COMMUNAL         07F EXTERIOR - COMMUNAL       07F EXTERIOR - COMMUNAL         BALCONIES / TERRACE - PRIVATE       TOTAL         REQUIRED (309 UNITS X 6 m²) = 1,854 sq. m.       REQUIRED COMMUNAL @ 50% = 927 sq. m.	) (NOT INCLUDING SU (NOT INCLUDING SU (NOT INCLUDING SU 1 1 1 1 1 1 1 1 1 1 1 1 1	112 319 IRFACE PARKI 3 4 7 IRFACE PARKI 3 5 8 2.6m X 5. 2.6m X 6. 2.4m X 4. 3.4m X 5. 2.6m X 5. 2.6m X 6. 2.4m X 4. 3.4m X 5. 2.4m X 5. 3.5m X 7. 155 155 155 309 0 0 309 0 0 0 0 0 0 0 0 0 0 0 0 0	NG) NG) 2m 7m 6m 2m 2m 0m 2 2024-1 1 2024-0 # DA 0m 2 2024-1 1 2024-0 # DA 0m 2 2024-1 1 2024-0 # DA 0 0 0 0 0 0 0 0 0 0 0 0 0	MIN 3.66 x 5 0 0 0 0 0 0 0 0 0 0 0 0 0
TOTAL       1.03 PER UNIT (309 UNITS)         ACCESSIBLE PARKING SPACES REQUIRED -         TYPE 'A'         TYPE 'B'         ACCESSIBLE PARKING SPACES PROVIDED -         TYPE 'A'         TYPE 'B'         TOTAL         ACCESSIBLE PARKING SPACES PROVIDED -         TYPE 'A'         TYPE 'B'         TOTAL         STANDARD PARKING SPACE         PARALLEL PARKING SPACE         SMALL PARKING SPACE         SMALL PARKING SPACE         SMALL PARKING SPACE         SIBLE PARKING SPACE ' TYPE A '         ACCESSIBLE PARKING SPACE ' TYPE B '         LOADING SPACE         BICYCLE PARKING SPACES REQUIRED         RESIDENTIAL       0.5 PER UNIT (309 UNITS)         TOTAL       0.5 PER UNIT (309 UNITS)         TOTAL       1.0 PER UNIT (309 UNITS)         AMENITY AREA       EXTERIOR         GRADE EXTERIOR - COMMUNAL       INTERIOR - COMMUNAL         INTERIOR - COMMUNAL       OTF EXTERIOR - COMMUNAL         TOTAL       BALCONIES / TERRACE - PRIVATE         TOTAL       REQUIRED (309 UNITS X 6 m²) = 1,854 sq. m.         REQUIRED COMMUNAL @ 50% = 927 sq. m.       SITE COVERAGE	) (NOT INCLUDING SU (NOT INCLUDING SU (NOT INCLUDING SU 1 1 1 1 1 1 1 1 1 1 1 1 1	112 319 IRFACE PARKI 3 4 7 IRFACE PARKI 3 5 8 2.6m X 5. 2.6m X 6. 2.4m X 4. 3.4m X 5. 2.4m X 5. 3.5m X 7. 155 155 155 155 309 0 309 10 10 10 10 10 10 10 10 10 10	NG) NG) 2m 7m 6m 2m 2m 0m 2 2024-1 1 2024-0 # DA 0m 2 2024-1 1 2024-0 # DA 0m 2 2024-1 1 2024-0 # DA 0 0 1 2024-0 # DA 0 0 1 2024-0 # DA 0 0 1 2024-1 1 2024-0 # DA 0 0 0 0 0 0 0 0 0 0 0 0 0	MIN 3.66 x 5
TOTAL       1.03 PER UNIT (309 UNITS)         ACCESSIBLE PARKING SPACES REQUIRED -         TYPE 'A'         TYPE 'B'         ACCESSIBLE PARKING SPACES PROVIDED -         TYPE 'A'         TYPE 'B'         TOTAL         ACCESSIBLE PARKING SPACES PROVIDED -         TYPE 'B'         TOTAL         STANDARD PARKING SPACE         PARALLEL PARKING SPACE         SMALL PARKING SPACE         SMALL PARKING SPACE         SMALL PARKING SPACE         SIDENTIAL         0.5 PER UNIT (309 UNITS)         TOTAL         BICYCLE PARKING SPACES REQUIRED         RESIDENTIAL       0.5 PER UNIT (309 UNITS)         TOTAL       1.0 PER UNIT (309 UNITS)         TOTAL       1.0 PER UNIT (309 UNITS)         AMENITY AREA       EXTERIOR         GRADE EXTERIOR - COMMUNAL       1.0 PER UNIT (309 UNITS)         AMENITY AREA       INTERIOR - COMMUNAL         07F EXTERIOR - COMMUNAL       07F EXTERIOR - COMMUNAL         BALCONIES / TERRACE - PRIVATE       TOTAL         REQUIRED (309 UNITS X 6 m²) = 1,854 sq. m.       REQUIRED COMMUNAL @ 50% = 927 sq. m.         SITE COVERAGE       BUILDING FOOTPRINT         DRIVING SURFACE       LANDSCAPE AREA <td>) (NOT INCLUDING SU (NOT INCLUDING SU (NOT INCLUDING SU 1000</td> <td><math display="block"> \begin{array}{c ccccccccccccccccccccccccccccccccccc</math></td> <td>NG) NG) 2m 7m 6m 2m 2m 7m 6m 2m 2m 0m 2 2024-1 1 2024-0 # DA PROJECT 1,858 1,791 2,175 5,824 7,741 B,565 PROJECT 4.1% 3,7% 2024-05 PROJECT</td> <td>MIN 3.66 x 5</td>	) (NOT INCLUDING SU (NOT INCLUDING SU (NOT INCLUDING SU 1000	$ \begin{array}{c ccccccccccccccccccccccccccccccccccc$	NG) NG) 2m 7m 6m 2m 2m 7m 6m 2m 2m 0m 2 2024-1 1 2024-0 # DA PROJECT 1,858 1,791 2,175 5,824 7,741 B,565 PROJECT 4.1% 3,7% 2024-05 PROJECT	MIN 3.66 x 5
TOTAL       1.03 PER UNIT (309 UNITS)         ACCESSIBLE PARKING SPACES REQUIRED -         TYPE 'A'         TYPE 'B'         ACCESSIBLE PARKING SPACES PROVIDED -         TYPE 'A'         TYPE 'B'         ACCESSIBLE PARKING SPACES PROVIDED -         TYPE 'A'         TYPE 'B'         TOTAL         ACCESSIBLE PARKING SPACE         SMALL PARKING SPACE         BICYCLE PARKING SPACE ' TYPE A '         ACCESSIBLE PARKING SPACE SEQUIRED         RESIDENTIAL       0.5 PER UNIT (309 UNITS)         TOTAL       0.5 PER UNIT (309 UNITS)         TOTAL       1.0 PER UNIT (309 UNITS)         AMENITY AREA       EXTERIOR         GRADE EXTERIOR - COMMUNAL       INTERIOR         INTERIOR - COMMUNAL       07F EXTERIOR - COMMUNAL         OTF EXTERIOR - COMMUNAL       DALCONIES / TERRACE - PRIVATE         TOTAL       1.0 PER UNIT (309 UNITS)         AMENITY AREA       EQUIRED (309 UNITS X 6 m²) = 1,854 sq. m.         REQUIRED COMMUNAL @ 50% = 927 sq. m.       SITE COVERAGE         BUILDING FOOTPRINT       DRIVING SURFACE	) (NOT INCLUDING SU (NOT INCLUDING SU (NOT INCLUDING SU 1 1 1 1 1 1 1 1 1 1 1 1 1	$ \begin{array}{c ccccccccccccccccccccccccccccccccccc$	NG) NG) 2m 7m 6m 2m 2m 7m 6m 2m 2m 0m 2 2024-1 1 2024-0 # D PROJECT 1,858 1,791 2,175 5,824 7,741 3,565 PROJECT 18.050 SIT PROJECT 18.050 RYT / D	MIN 3.66 x 5
TOTAL       1.03 PER UNIT (309 UNITS)         ACCESSIBLE PARKING SPACES REQUIRED -         TYPE 'A'         TYPE 'B'         ACCESSIBLE PARKING SPACES PROVIDED -         TYPE 'A'         TYPE 'B'         TOTAL         ACCESSIBLE PARKING SPACES PROVIDED -         TYPE 'A'         TYPE 'B'         TOTAL         ACCESSIBLE PARKING SPACE         SMALL PARKING SPACE         SMALL PARKING SPACE         SMALL PARKING SPACE         SMALL PARKING SPACE         SIBLE PARKING SPACE ' TYPE A '         ACCESSIBLE PARKING SPACE SEQUIRED         RESIDENTIAL       0.5 PER UNIT (309 UNITS)         TOTAL       0.5 PER UNIT (309 UNITS)         TOTAL       1.0 PER UNIT (309 UNITS)         AMENITY AREA       EXTERIOR         GRADE EXTERIOR - COMMUNAL       1.0 PER UNIT (309 UNITS)         AMENITY AREA       INTERIOR - COMMUNAL         D7F EXTERIOR - COMMUNAL       D7F EXTERIOR - COMMUNAL         BALCONIES / TERRACE - PRIVATE       TOTAL         REQUIRED (309 UNITS X 6 m²) = 1,854 sq. m.       REQUIRED COMMUNAL @ 50% = 927 sq. m.         SITE COVERAGE       EANDSCAPE AREA       TOTAL BUILDING A	) (NOT INCLUDING SU (NOT INCLUDING SU (NOT INCLUDING SU 1000	$ \begin{array}{c} 112\\319\\ \hline \\                                  $	NG) NG) 2m 7m 6m 2m 2m 7m 6m 2m 2m 0m 2 2024.1 1 2024.0 # DA PROJECT 1,858 1,791 2,175 5,824 7,741 3,565 PROJECT 18.050 SIT PROJECT 18.050 PROJECT 10.050 PROJECT	MIN 3.66 x 5
TOTAL       1.03 PER UNIT (309 UNITS)         ACCESSIBLE PARKING SPACES REQUIRED -         TYPE 'A'         TOTAL         ACCESSIBLE PARKING SPACES PROVIDED -         TYPE 'A'         TYPE 'B'         TOTAL         ACCESSIBLE PARKING SPACE         PARALLEL PARKING SPACE         PARALLEL PARKING SPACE         SMALL PARKING SPACE         SMALL PARKING SPACE         SMALL PARKING SPACE         SIDE PARKING SPACE         SIDE PARKING SPACE ' TYPE B '         LOADING SPACE         BICYCLE PARKING SPACES REQUIRED         RESIDENTIAL       0.5 PER UNIT (309 UNITS)         TOTAL       0.5 PER UNIT (309 UNITS)         TOTAL       1.0 PER UNIT (309 UNITS)         AMENITY AREA       EXTERIOR         GRADE EXTERIOR - COMMUNAL       INTERIOR - COMMUNAL         INTERIOR - COMMUNAL       07F EXTERIOR - COMMUNAL         OTFAL       1.0 PER UNIT (309 UNITS)         AMENITY AREA       INTERIOR - COMMUNAL         BALCONIES / TERRACE - PRIVATE       INTERIOR         BALCONIES / TERRACE - PRIVATE       INTERIOR         BALCONIES / TERRACE - PRIVATE       INTERIOR         BUILDING FOOTPRINT       DRIVING SURFACE         LA	) (NOT INCLUDING SU (NOT INCLUDING SU (NOT INCLUDING SU 1000	112 319 IRFACE PARKI 3 4 7 IRFACE PARKI 3 5 8 2.6m X 5. 2.6m X 6. 2.4m X 4. 3.4m X 5. 2.4m X 5. 2.4m X 5. 3.5m X 7. 155 155 155 155 309 0 0 309 0 0 309 0 0 0 0 0 0 0 0 0 0 0 0 0	NG) NG) 2m 7m 6m 2m 2m 7m 6m 2m 2m 7m 6m 2m 2m 7m 6m 2m 2m 7m 6m 2m 2m 7m 6m 2m 2m 7m 6m 2m 2m 7m 6m 2m 2m 7m 6m 2m 2m 7m 6m 2m 2m 7m 6m 2m 2m 7m 6m 2m 2m 7m 6m 2m 2m 7m 6m 2m 7m 6m 2m 7m 6m 2m 7m 6m 2m 7m 6m 2m 7m 6m 2m 7m 6m 2m 7m 6m 2m 7m 7m 6m 2m 7m 7m 6m 2m 7m 7m 7m 7m 7m 7m 7m 7m 7m 7	MIN 3.66 x 5
ACCESSIBLE PARKING SPACES REQUIRED - TYPE 'A' TYPE 'B' ACCESSIBLE PARKING SPACES PROVIDED - TYPE 'A' TYPE 'B' TOTAL STANDARD PARKING SPACE PARALLEL PARKING SPACE SMALL PARKING SPACE SMALL PARKING SPACE ACCESSIBLE PARKING SPACE ' TYPE A ' ACCESSIBLE PARKING SPACE ' TYPE A ' ACCESSIBLE PARKING SPACE ' TYPE B ' LOADING SPACE BICYCLE PARKING SPACES REQUIRED RESIDENTIAL 0.5 PER UNIT (309 UNITS) TOTAL BICYCLE PARKING SPACES PROVIDED RESIDENTIAL INTERIOR EXTERIOR	) (NOT INCLUDING SU (NOT INCLUDING SU (NOT INCLUDING SU 1000	112         319         IRFACE PARKI         3         4         7         IRFACE PARKI         3         4         7         IRFACE PARKI         3         5         2.6m X 5.         2.6m X 6.         2.4m X 4.         3.4m X 5.         2.4m X 5.         3.5m X 7.         155         309         0         309         0         309         0         309         0         309         0         309         0         309         0         309         0         309         0         309         0         309         0         309         0         309         0         CO       CUBIC YA         T         T         0         CUBIC YA         1         <	NG) NG) 2m 7m 6m 2m 2m 7m 6m 2m 2m 2m 0m 2 2024-1 1 2024-0 # DA 0m 2 2024-1 1 2024-0 # DA 0m 2 2024-1 1 2024-0 # DA 0m 2 2024-1 1 2024-0 # DA 0 0 0 0 0 0 0 0 0 0 0 0 0	1-01       ISSUED         3400         TYPE         3400         TYPE         1-01         ISSUED         1-01         ISSUED         1-01         ISSUED         1-01         ISSUED         1-01         ISSUED         1-01         ISSUED         500 <t< td=""></t<>

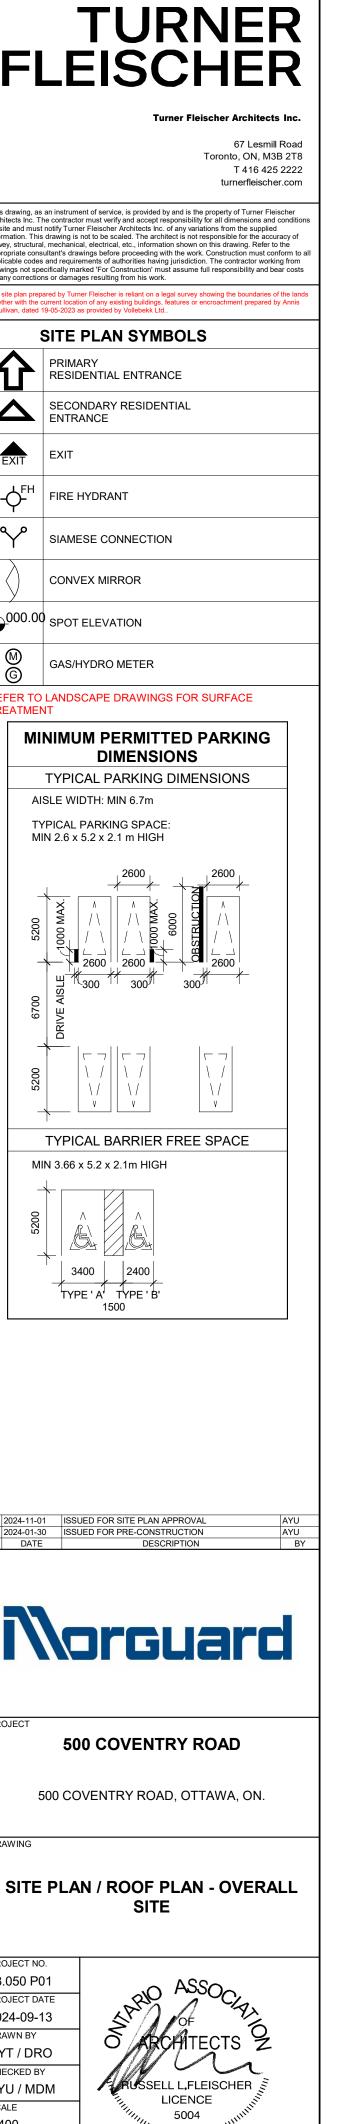

DRAWING NO. SPA005B 2

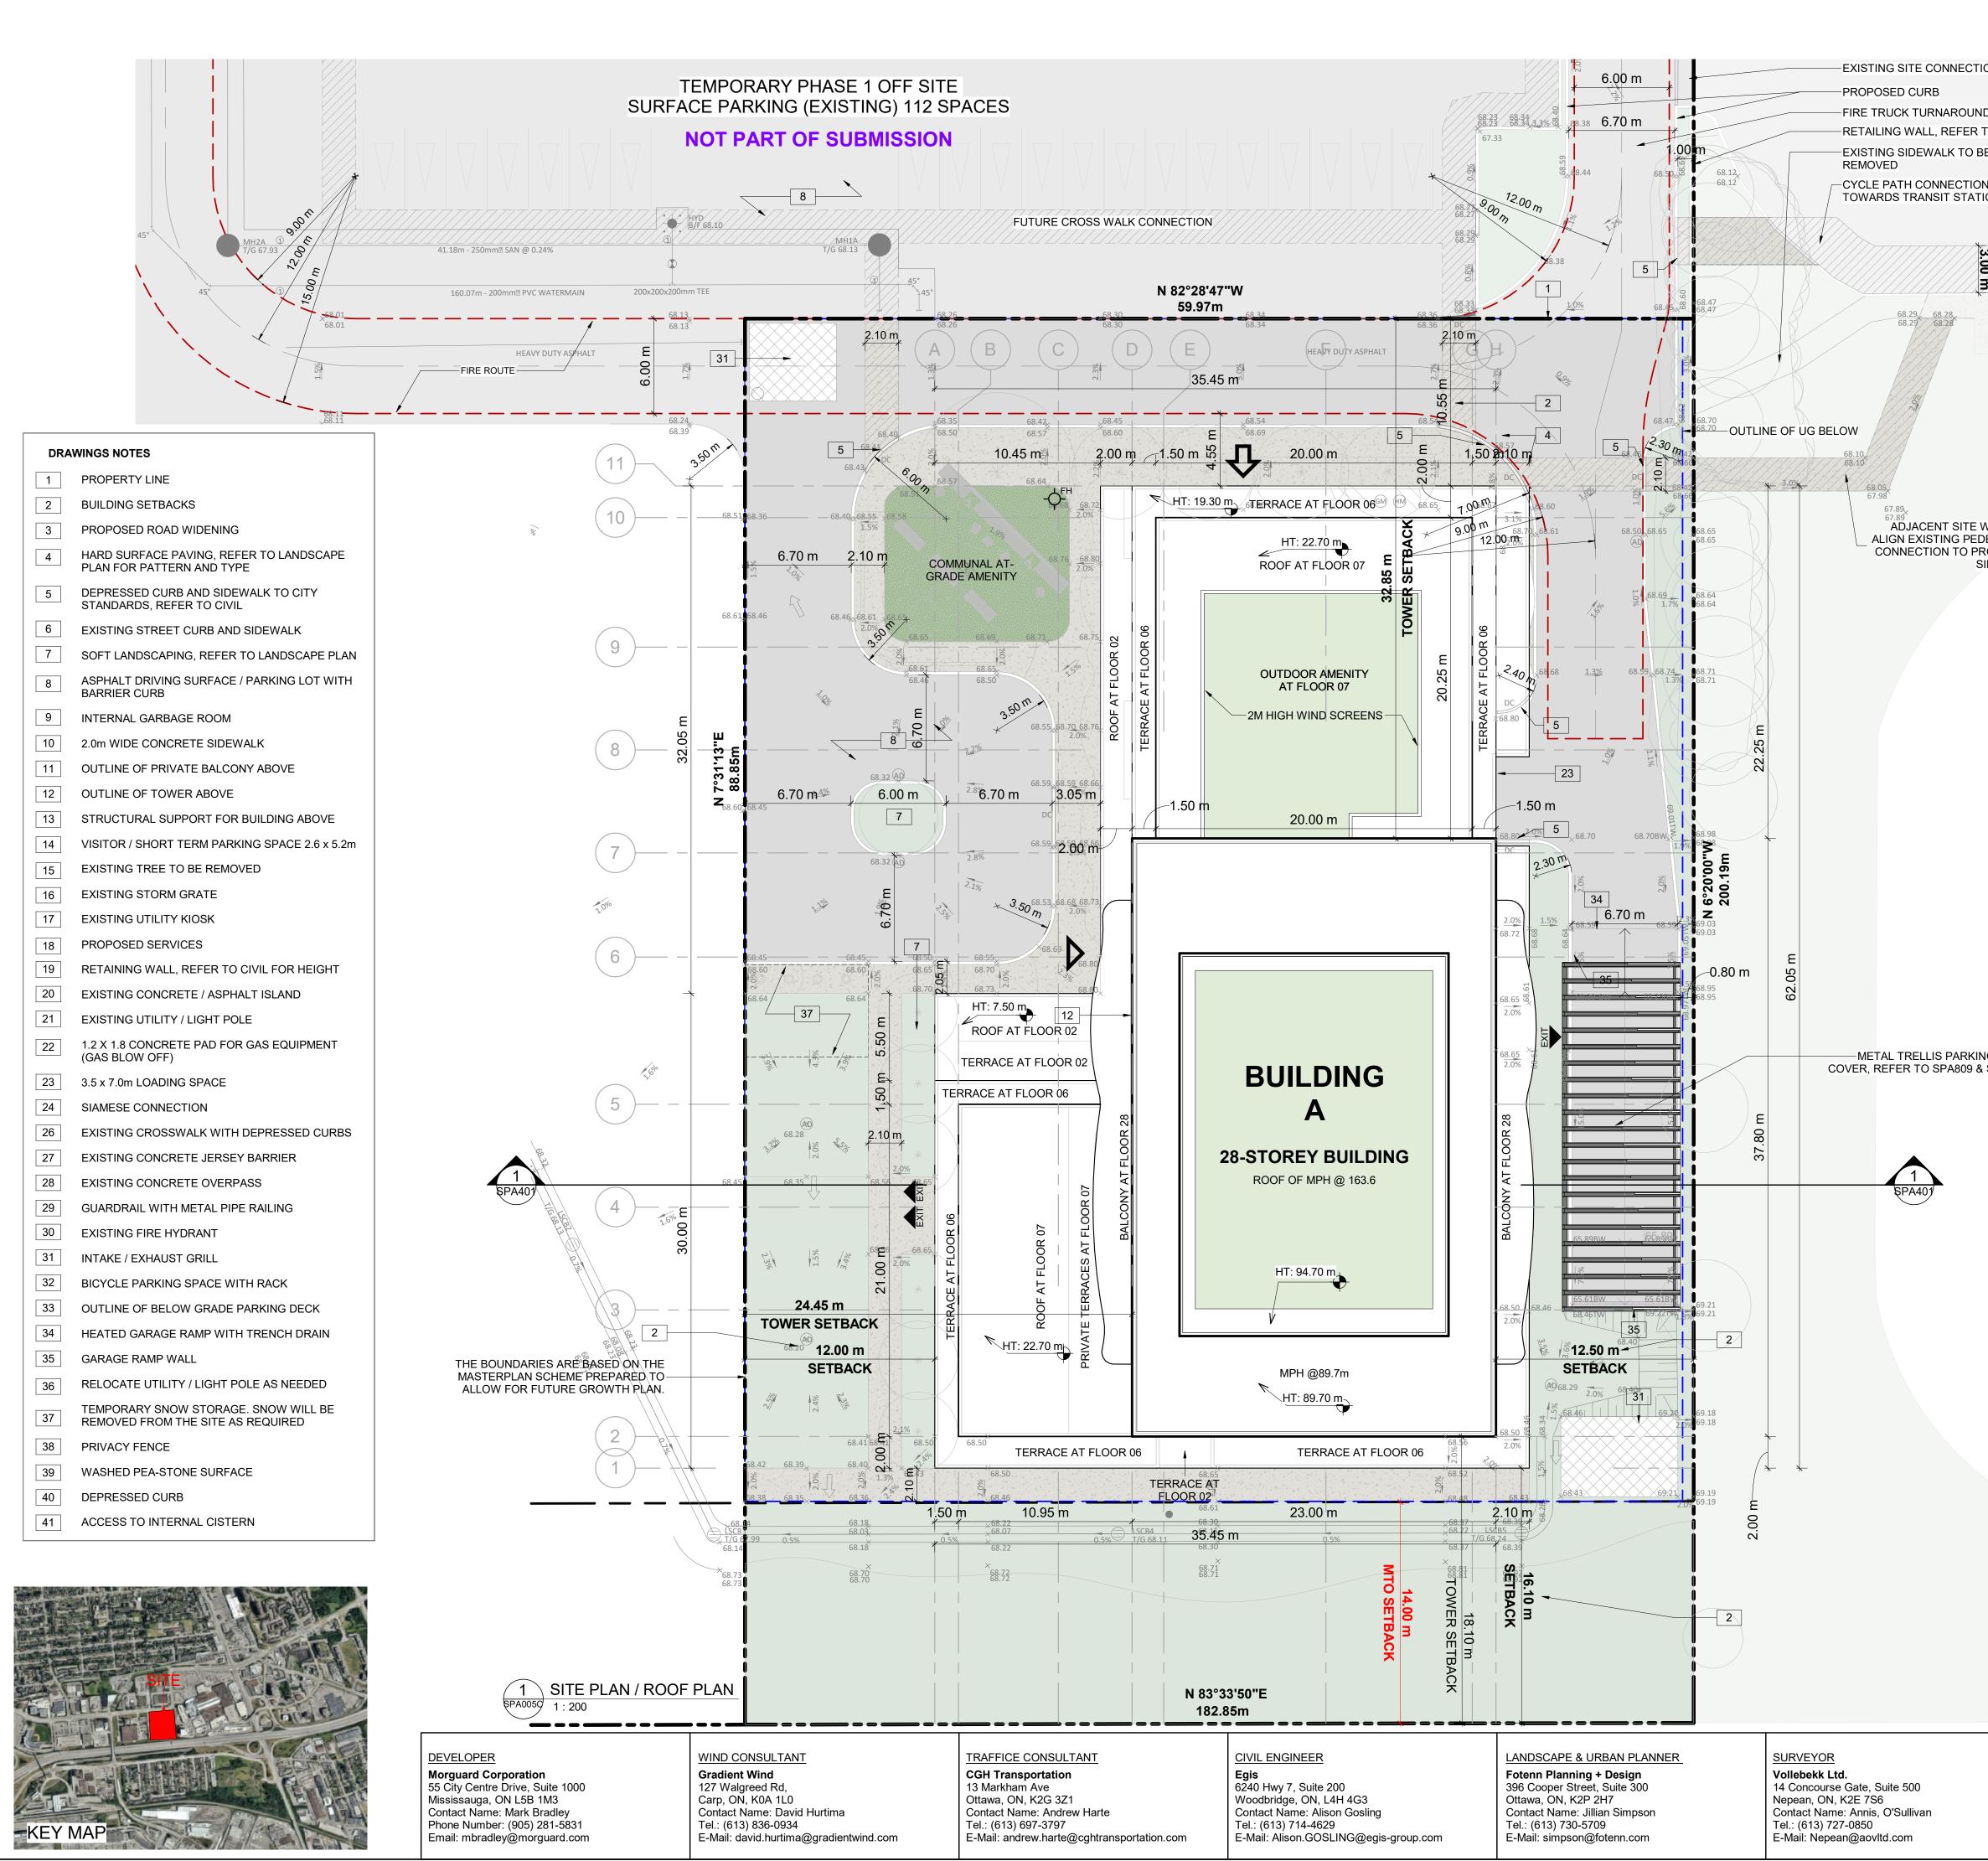

	<b>PROJECT INFORMATION</b> Zoning By-law 2008-250 Consolidation NET OVERALL SITE AREA BREAKDOWN	TD3		-	TURNER
	AREA TYPE	m²	ft²	╎┣∟	EISCHER
TION	SITE AREA - BLDG A TOTAL PARKLAND AREA	5,325.5 3,486.0	57,323.4 37,523		Turner Fleischer Architects Inc.
ND AREA			0.,020		67 Lesmill Road
R TO CIVIL.	TEMPORARY OFF SITE PARKING (PHASE 1) PHASE 1 SURFACE PARKING	6,851.7	73,751.1		Toronto, ON, M3B 2T8 T 416 425 2222
BE	ZONING	0,031.7	73,731.1	This drawing, as an inc	turnerfleischer.com
ON	BUILDING HEIGHT	REQUIRED 30 STOREYS /	PROVIDED 28 STOREYS /	Architects Inc. The con on site and must notify information. This drawi	trument of service, is provided by and is the property of Turner Fleischer tractor must verify and accept responsibility for all dimensions and conditions Turner Fleischer Architects Inc. of any variations from the supplied ng is not to be scaled. The architect is not responsible for the accuracy of
TION		90.0M	89.7M	survey, structural, mech appropriate consultant's applicable codes and re	hanical, electrical, etc., information shown on this drawing. Refer to the s drawings before proceeding with the work. Construction must conform to all equirements of authorities having jurisdiction. The contractor working from
	GRADE (GEODETIC ELEVATION - ASL) ALLOWABLE PROJECTION - AMENITY LEVEL	0.0M	68.80M 22.7M	for any corrections or d	ly marked 'For Construction' must assume full responsibility and bear costs amages resulting from his work. y Turner Fleischer is reliant on a legal survey showing the boundaries of the lands
<u></u>	DENSITY - MINIMUM 350 units/hectare	206 UNITS	309 UNITS	together with the current	location of any existing buildings, features or encroachment prepared by Annis 2023 as provided by Vollebekk Ltd
3.00 m	FRONT YARD SETBACK CORNER YARD SETBACK (East / West)	3.0M 3.0M/3.0M	110.75M 134.85M/12.5M	SIT	E PLAN SYMBOLS
₽////	REAR YARD SETBACK (GROUND TO 6th FLOOR)	0.0M	16.10M		IMARY SIDENTIAL ENTRANCE
	REAR YARD SETBACK (ABOVE 7th STOREY) AMENITY AREA - TOTAL PER UNIT	12.0M 6.0M <sup>2</sup>	18.10M 17.4M <sup>2</sup>		CONDARY RESIDENTIAL
- 6	AMENITY AREA - 50% COMMUNAL PER UNIT	3.0M <sup>2</sup>	4.55M <sup>2</sup>		ITRANCE
	AMENITY AREA - 2.0% OF LOT EXTERIOR AT GRADE COMMUNAL	117.15M <sup>2</sup>	172.6M <sup>2</sup>	EXIT EX	IT
	VEHICLE PARKING - RESIDENTIAL (AREA 'Z' - MAX 1.5/PER UNIT)	NOT REQUIRED	289		RE HYDRANT
	VEHICLE PARKING - VISITOR ONLY (MAX. 30,	30	30	$\nabla$	
	AFTER 12 UNITS)	405	000		AMESE CONNECTION
	BICYCLE PARKING - RESIDENTIAL - 0.5 PER UNIT AISLE & DRIVEWAY MINIMUM / MAXIMUM WIDTH	165 6.0M/6.7M	309 6.7M		
	GROSS BUILDING FLOOR AREA (OTTAWA ZONING D	•			
	UG1	m²	ft²	⊕ <sup>000.00</sup> sP	OT ELEVATION
E WORK TO EDESTRIAN	FLOOR 01			M GA	S/HYDRO METER
PROPOSED SIDEWALK	FLOOR 02           FLOOR 03-05         1,339.6 m² x 3	1,339.6 4,018.8	14,419 43,257	<u> </u>	
	FLOOR 05-05 1,359.0 III x 3	1,224.1	43,237 13,176	REFER TO LAN	IDSCAPE DRAWINGS FOR SURFACE
	FLOOR 07           FLOOR 08 - FLOOR 28         725.2 m² x 21	631.4 15,229.2	6,796 163,926	MININ	MUM PERMITTED PARKING
	TOTAL	22,443.7	<b>241,582</b>		
	TYP. FLOOR PLATE	725.2	7,806		PICAL PARKING DIMENSIONS WIDTH: MIN 6.7m
	UNIT STATISTICS				AL PARKING SPACE:
	1B		UNITS 58	MIN 2.	6 x 5.2 x 2.1 m HIGH
	1B+D		82		
	2B 2B+D		77 61		
	3B		31	5200 ,	2 / /   / / 1000 MAX / /   	TOTAL		309		
	VEHICULAR PARKING SPACES REQUIRED- AREA 'Z' VISITOR 0.1 SPACES PER UNIT AFTER 12 U		<u>,</u>	AISI F	300 3002 3002
	VISITOR 0.1 SPACES PER UNIT AFTER 12 U RESIDENTIAL N/A	UNITS - MAX 30	30 0	6700 DRIVE AI	
	TOTAL		30		
	VEHICULAR PARKING SPACES PROVIDED			5200	
	VISITOR 0.1 SPACES PER UNIT (309 UNITS RESIDENTIAL 0.56 SPACES PER UNIT (309 UNIT	/	30 177		
	TOTAL	3)	207	TY	PICAL BARRIER FREE SPACE
	EXISTING SURFACE PARKING LOTTOTAL1.03 PER UNIT (309 UNITS)	_	112 319	MIN 3.	66 x 5.2 x 2.1m HIGH
			019		
	ACCESSIBLE PARKING SPACES REQUIRED - (NOT IN	NCLUDING SURF		5200	
	TYPE 'A' TYPE 'B'		3		
ING RAMP & SPA810.	TOTAL		7		
	ACCESSIBLE PARKING SPACES PROVIDED - (NOT IN		CE PARKING)		TYPE'A' TYPE'B' 1500
	TYPE 'A' TYPE 'B'		3		
	TOTAL		8		
	STANDARD PARKING SPACE PARALLEL PARKING SPACE		2.6m X 5.2m 2.6m X 6.7m		
	SMALL PARKING SPACE		2.4m X 4.6m		
	ACCESSIBLE PARKING SPACE ' TYPE A '		3.4m X 5.2m		
	ACCESSIBLE PARKING SPACE ' TYPE B ' LOADING SPACE		2.4m X 5.2m <b>3.5m X 7.0m</b>	2 2024-11-01	ISSUED FOR SITE PLAN APPROVAL AYU
	BICYCLE PARKING SPACES REQUIRED			1 2024-01-30 # DATE	ISSUED FOR PRE-CONSTRUCTION AYU DESCRIPTION BY
	RESIDENTIAL0.5 PER UNIT (309 UNITS)TOTAL		155 <b>155</b>		
	BICYCLE PARKING SPACES PROVIDED		100		
	RESIDENTIAL INTERIOR		309		orguard
	EXTERIOR TOTAL 1.0 PER UNIT (309 UNITS)		0 <b>309</b>		JI GUdi L
	AMENITY AREA				
		m²	ft²	PROJECT	500 COVENTRY ROAD
	GRADE EXTERIOR - COMMUNAL INTERIOR - COMMUNAL	172.6 1,095.4	1,858 11,791		
	07F EXTERIOR - COMMUNAL	202.1	2,175	500	COVENTRY ROAD, OTTAWA, ON.
	TOTAL COMMUNAL BALCONIES / TERRACE - PRIVATE	<b>1,470.1</b> 3,506.2	<b>15,824</b> 37,741		
	TOTAL	4,976.3	53,565	DRAWING	
	REQUIRED (309 UNITS X 6 m²) = 1,854 sq. m.				
	REQUIRED COMMUNAL @ 50% = 927 sq. m.			S	ITE PLAN / ROOF PLAN
	SITE COVERAGE				
		m²	%	PROJECT NO.	
	BUILDING FOOTPRINT DRIVING SURFACE	1,815.4 1,260.5	34.1% 23.7%	18.050 P01 PROJECT DATE	- ASSOC
	LANDSCAPE AREA	2,249.6	42.2%	2024-09-13	Strand of The
	TOTAL BUILDING A	5,325.5	100%	DRAWN BY RYT / DRO	
	REFUGE REQUIREMENT (309 UNITS)			CHECKED BY	
	COMF GARBAGE	PACTED RATIO 0.053 yd <sup>3</sup> /UNIT	CUBIC YARDS 17	SCALE	LICENCE 1
	RECYCLING GMP	0.018 yd <sup>3</sup> /UNIT	6	1:200	

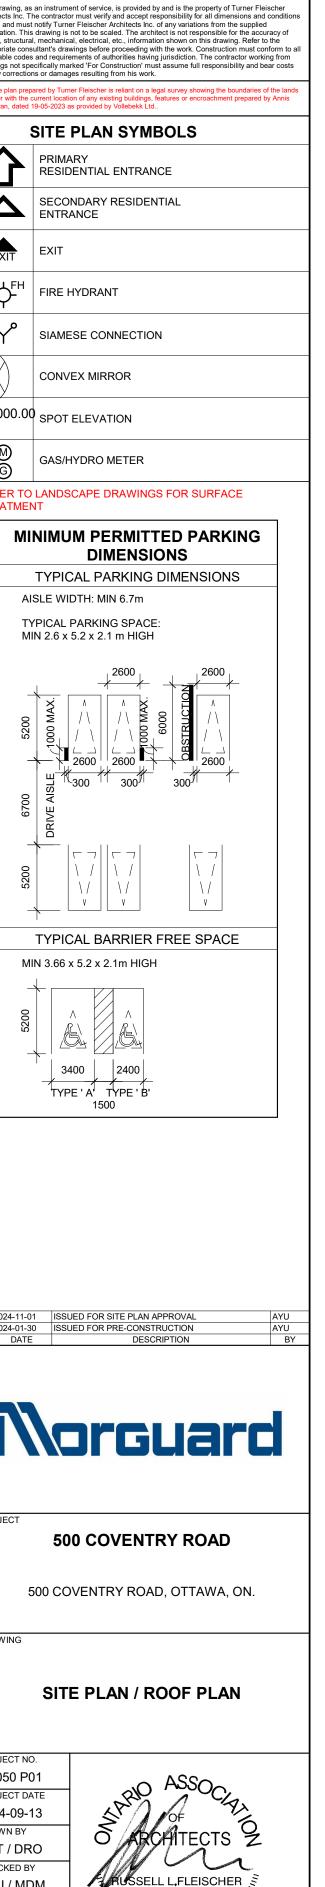

SPA005C 2


7 BINS

0.038 yd3/UNIT


240L PER 50 UNITS


COMPOST


**RECYCLING FIBER** 

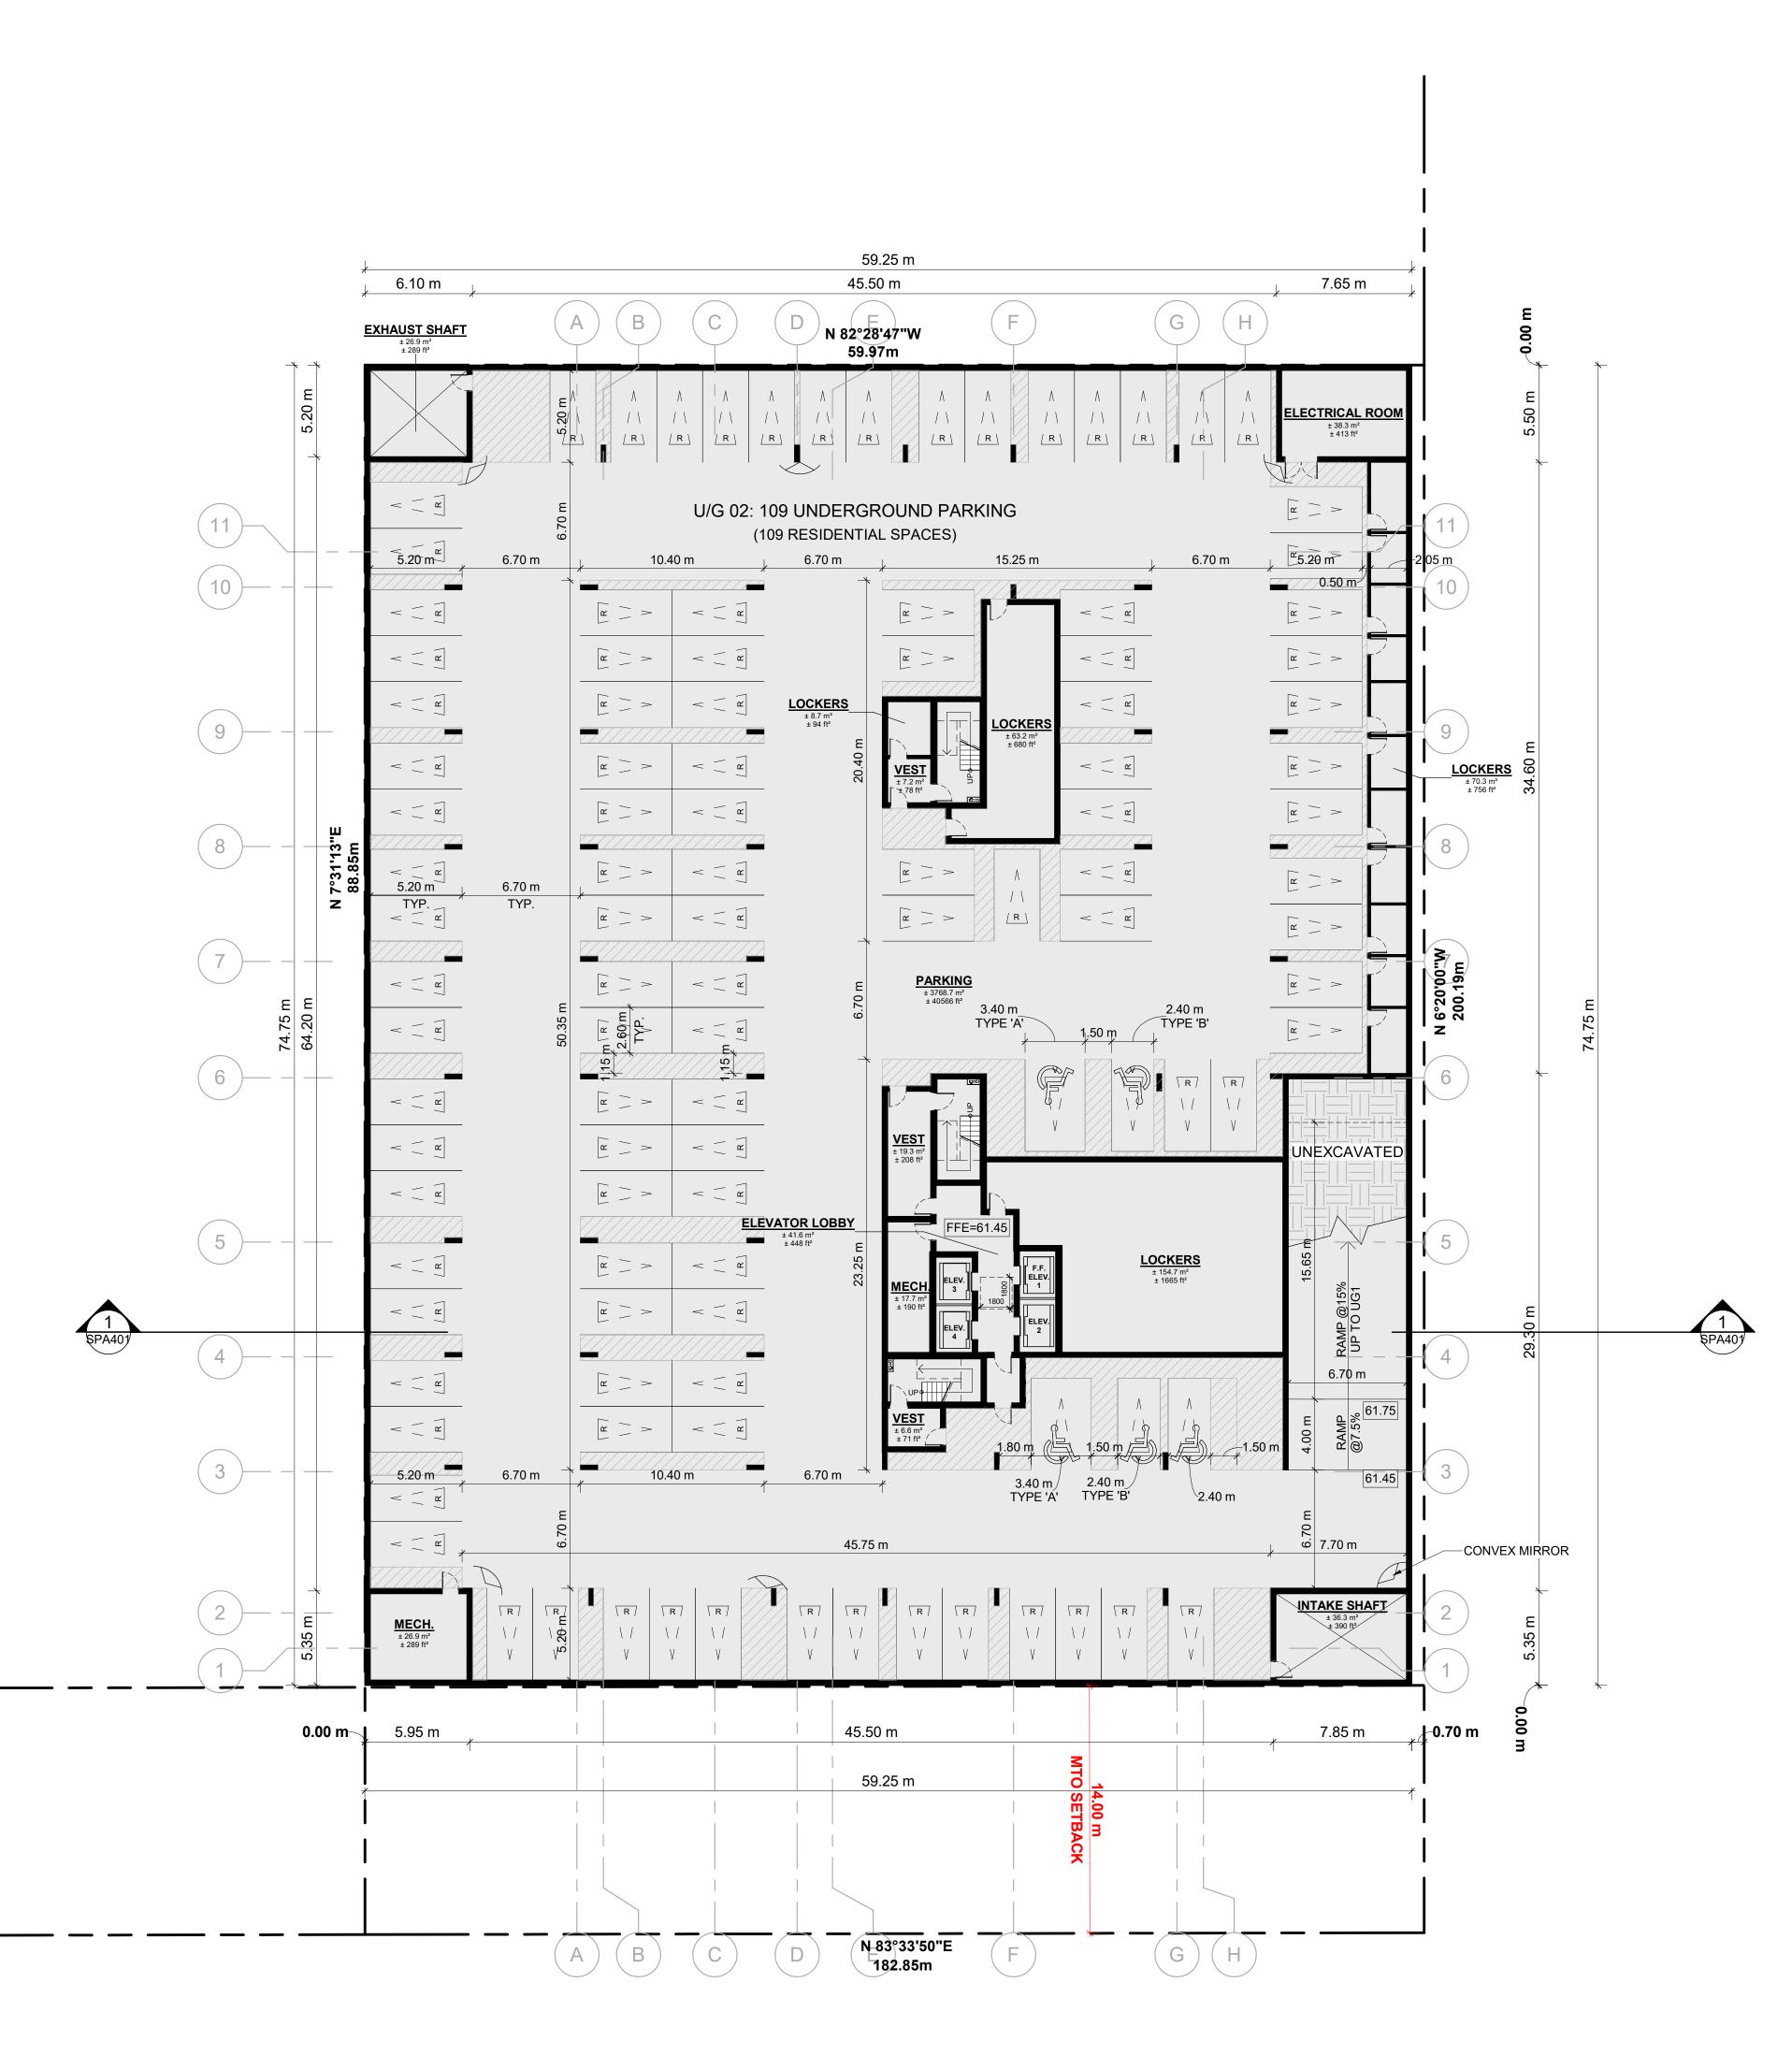




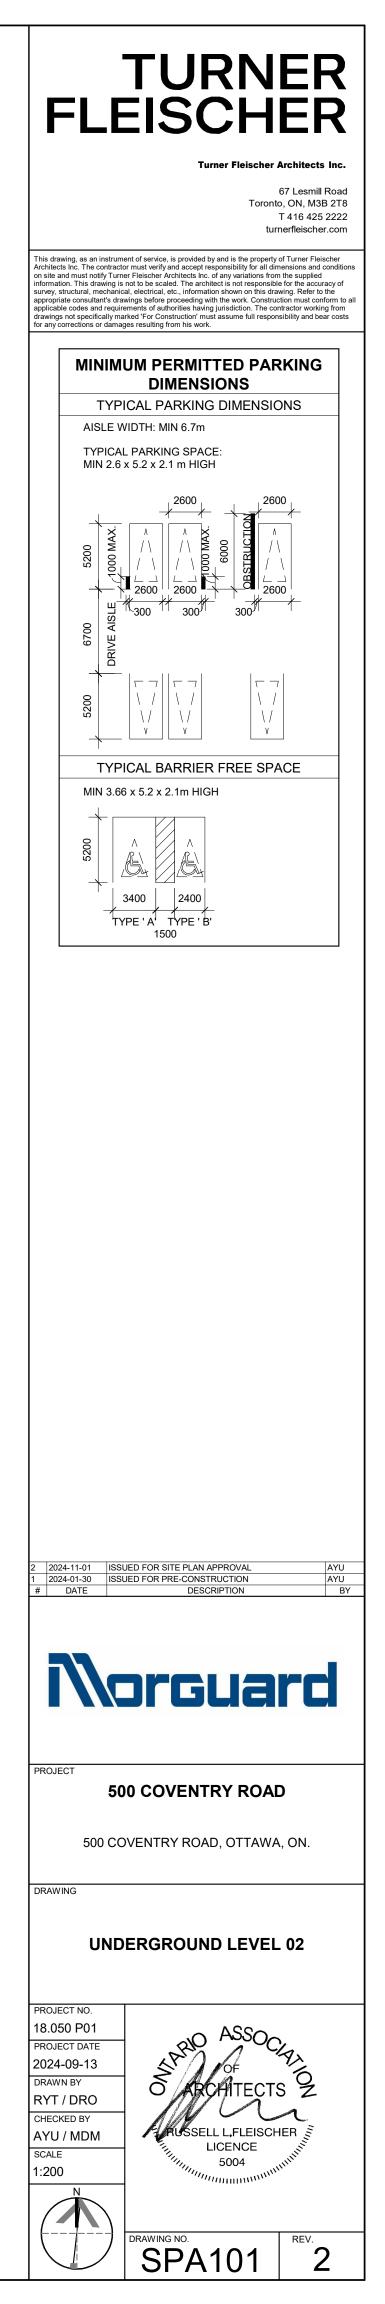

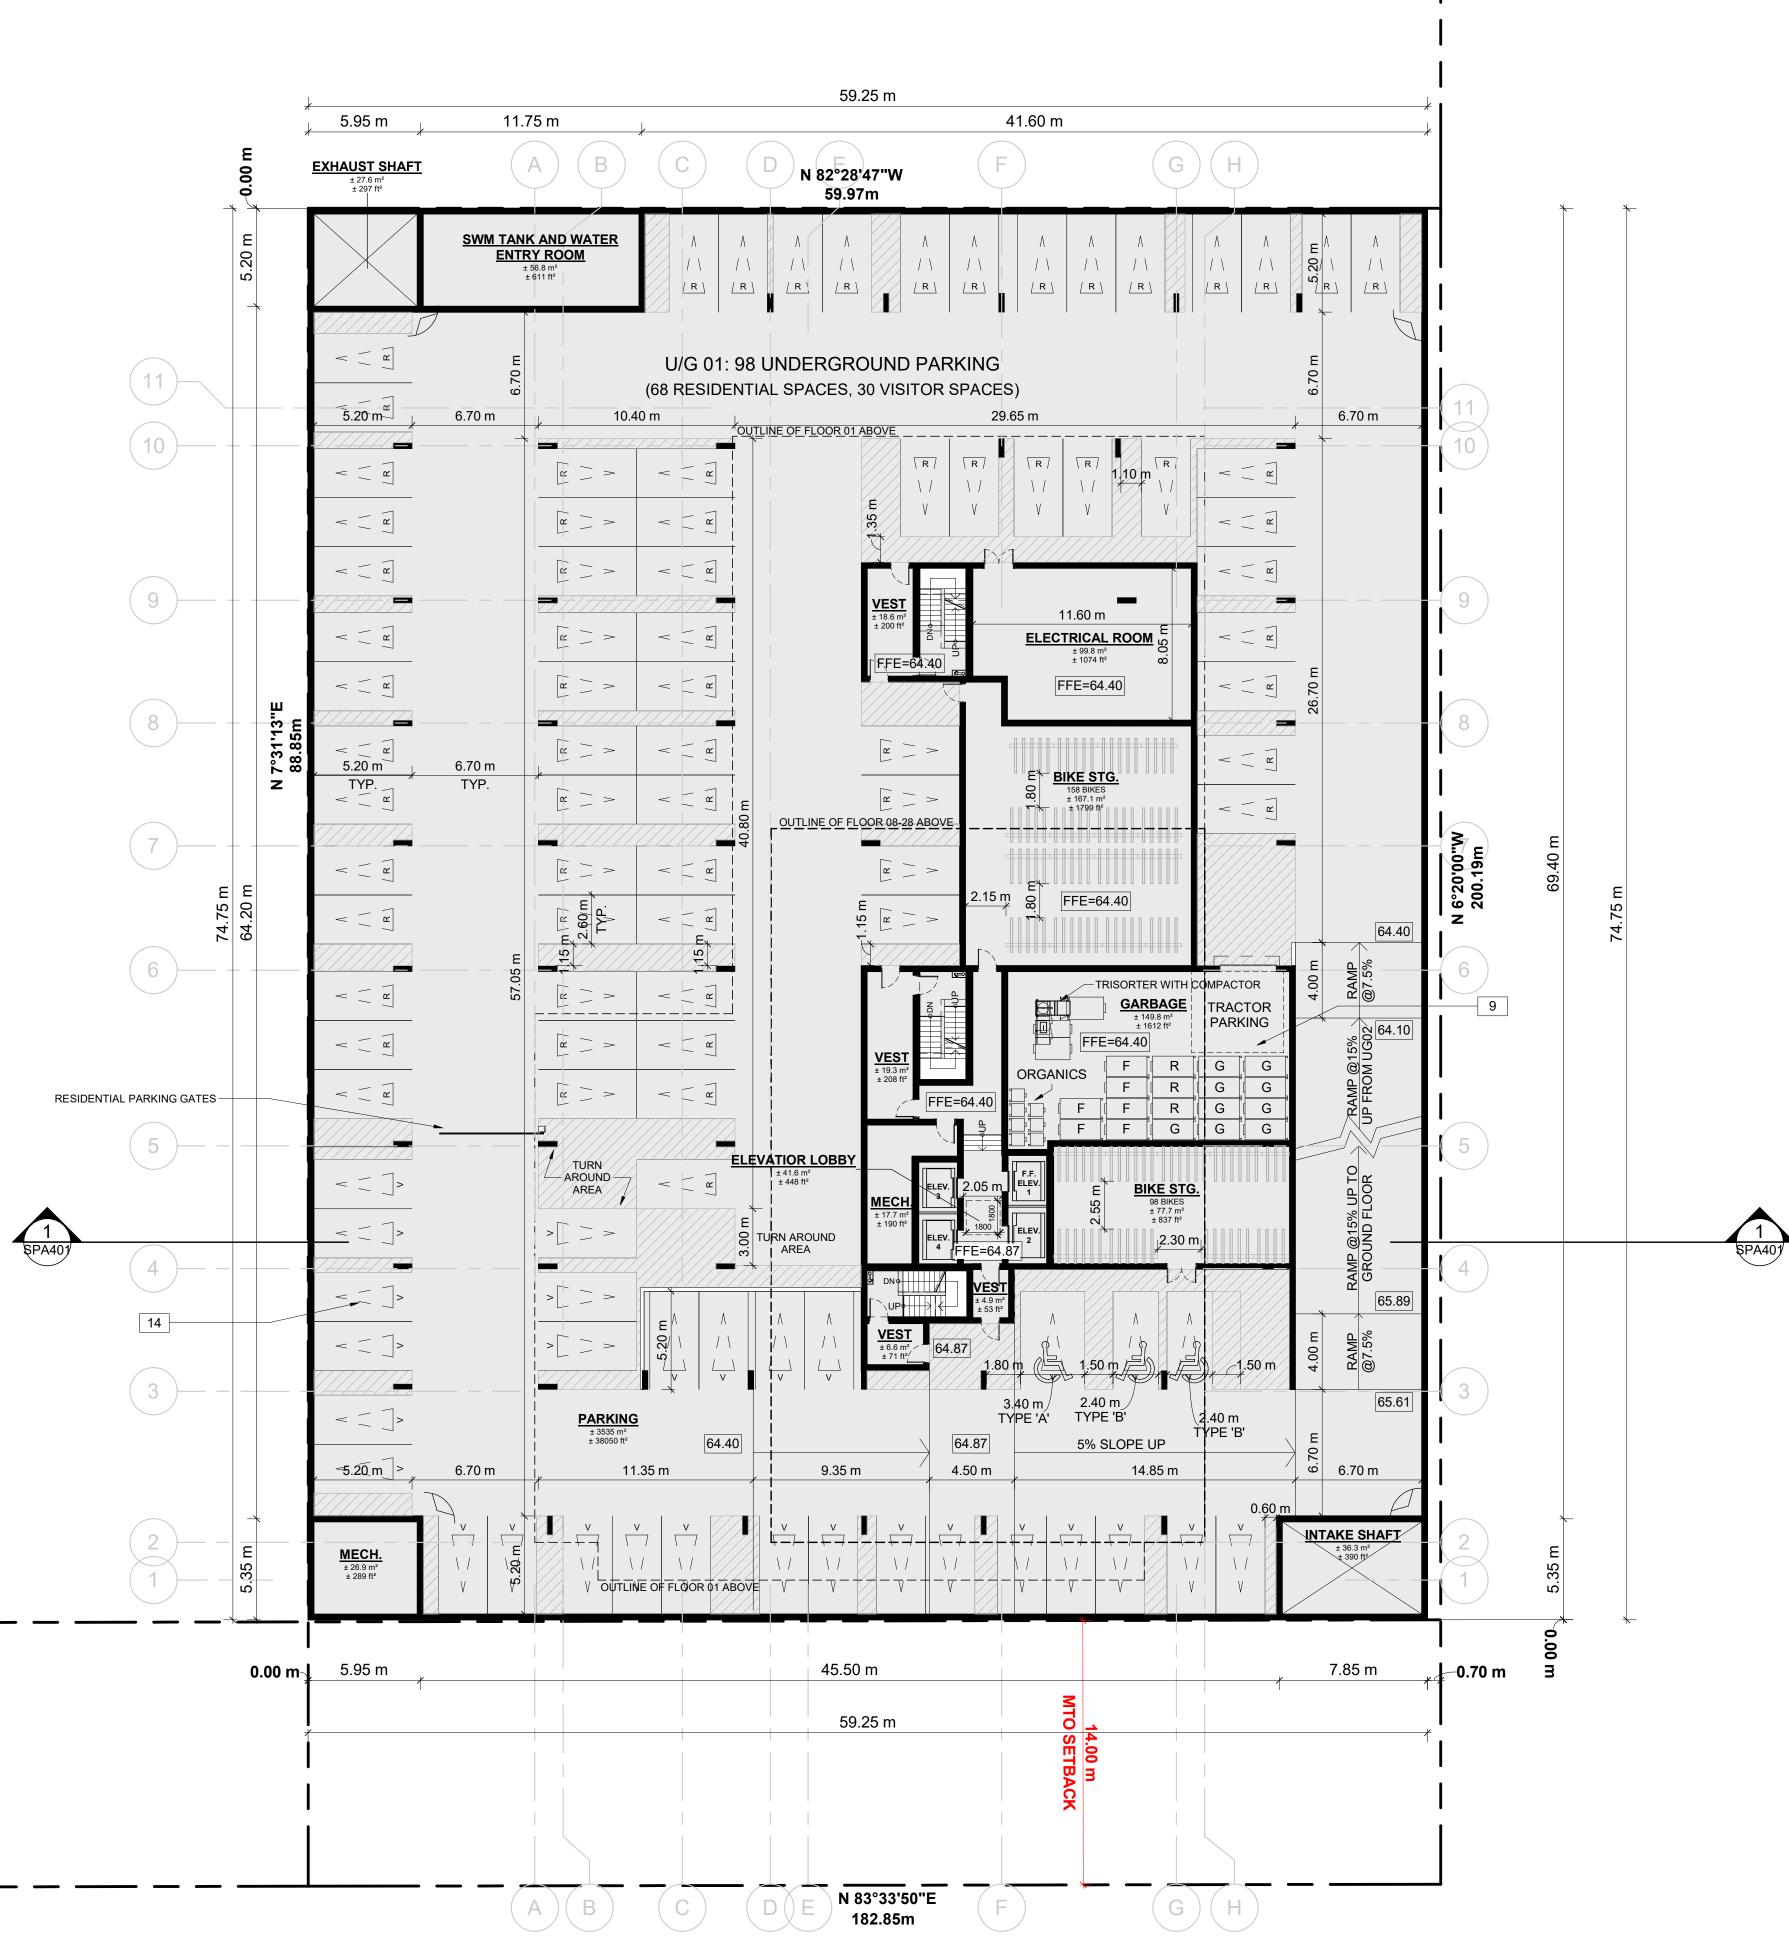


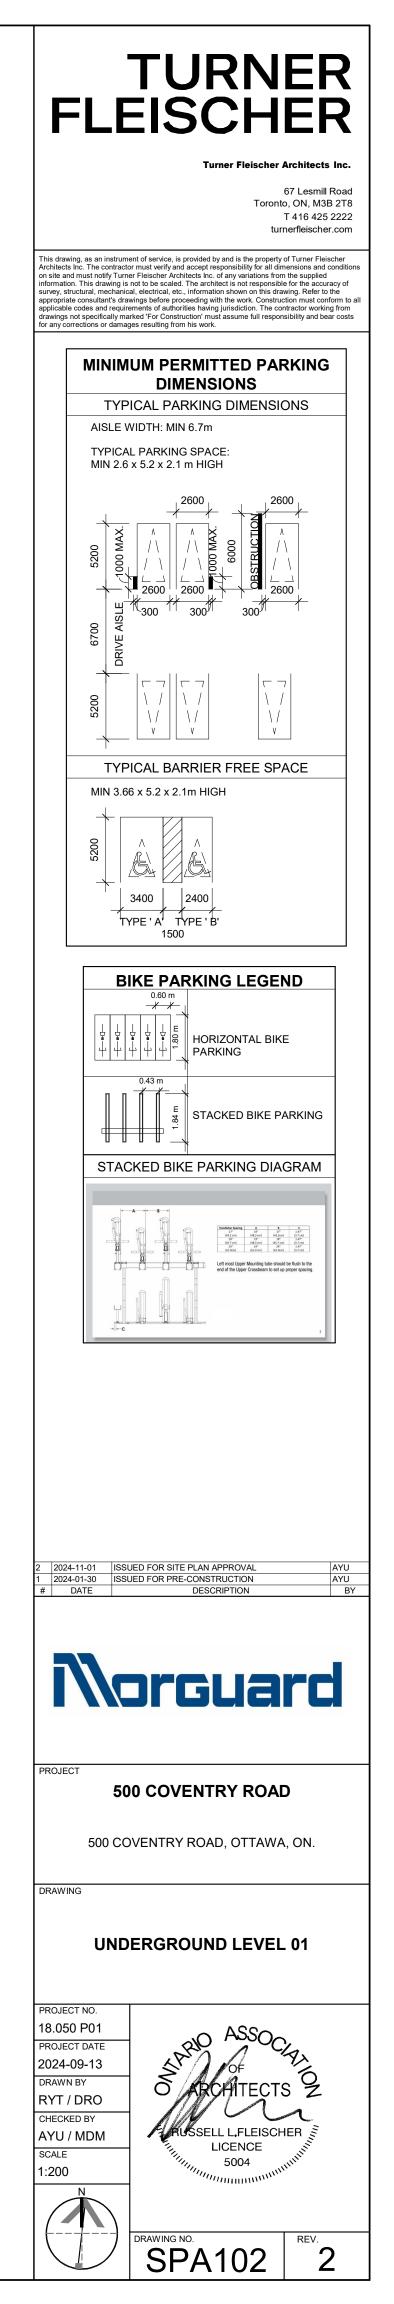

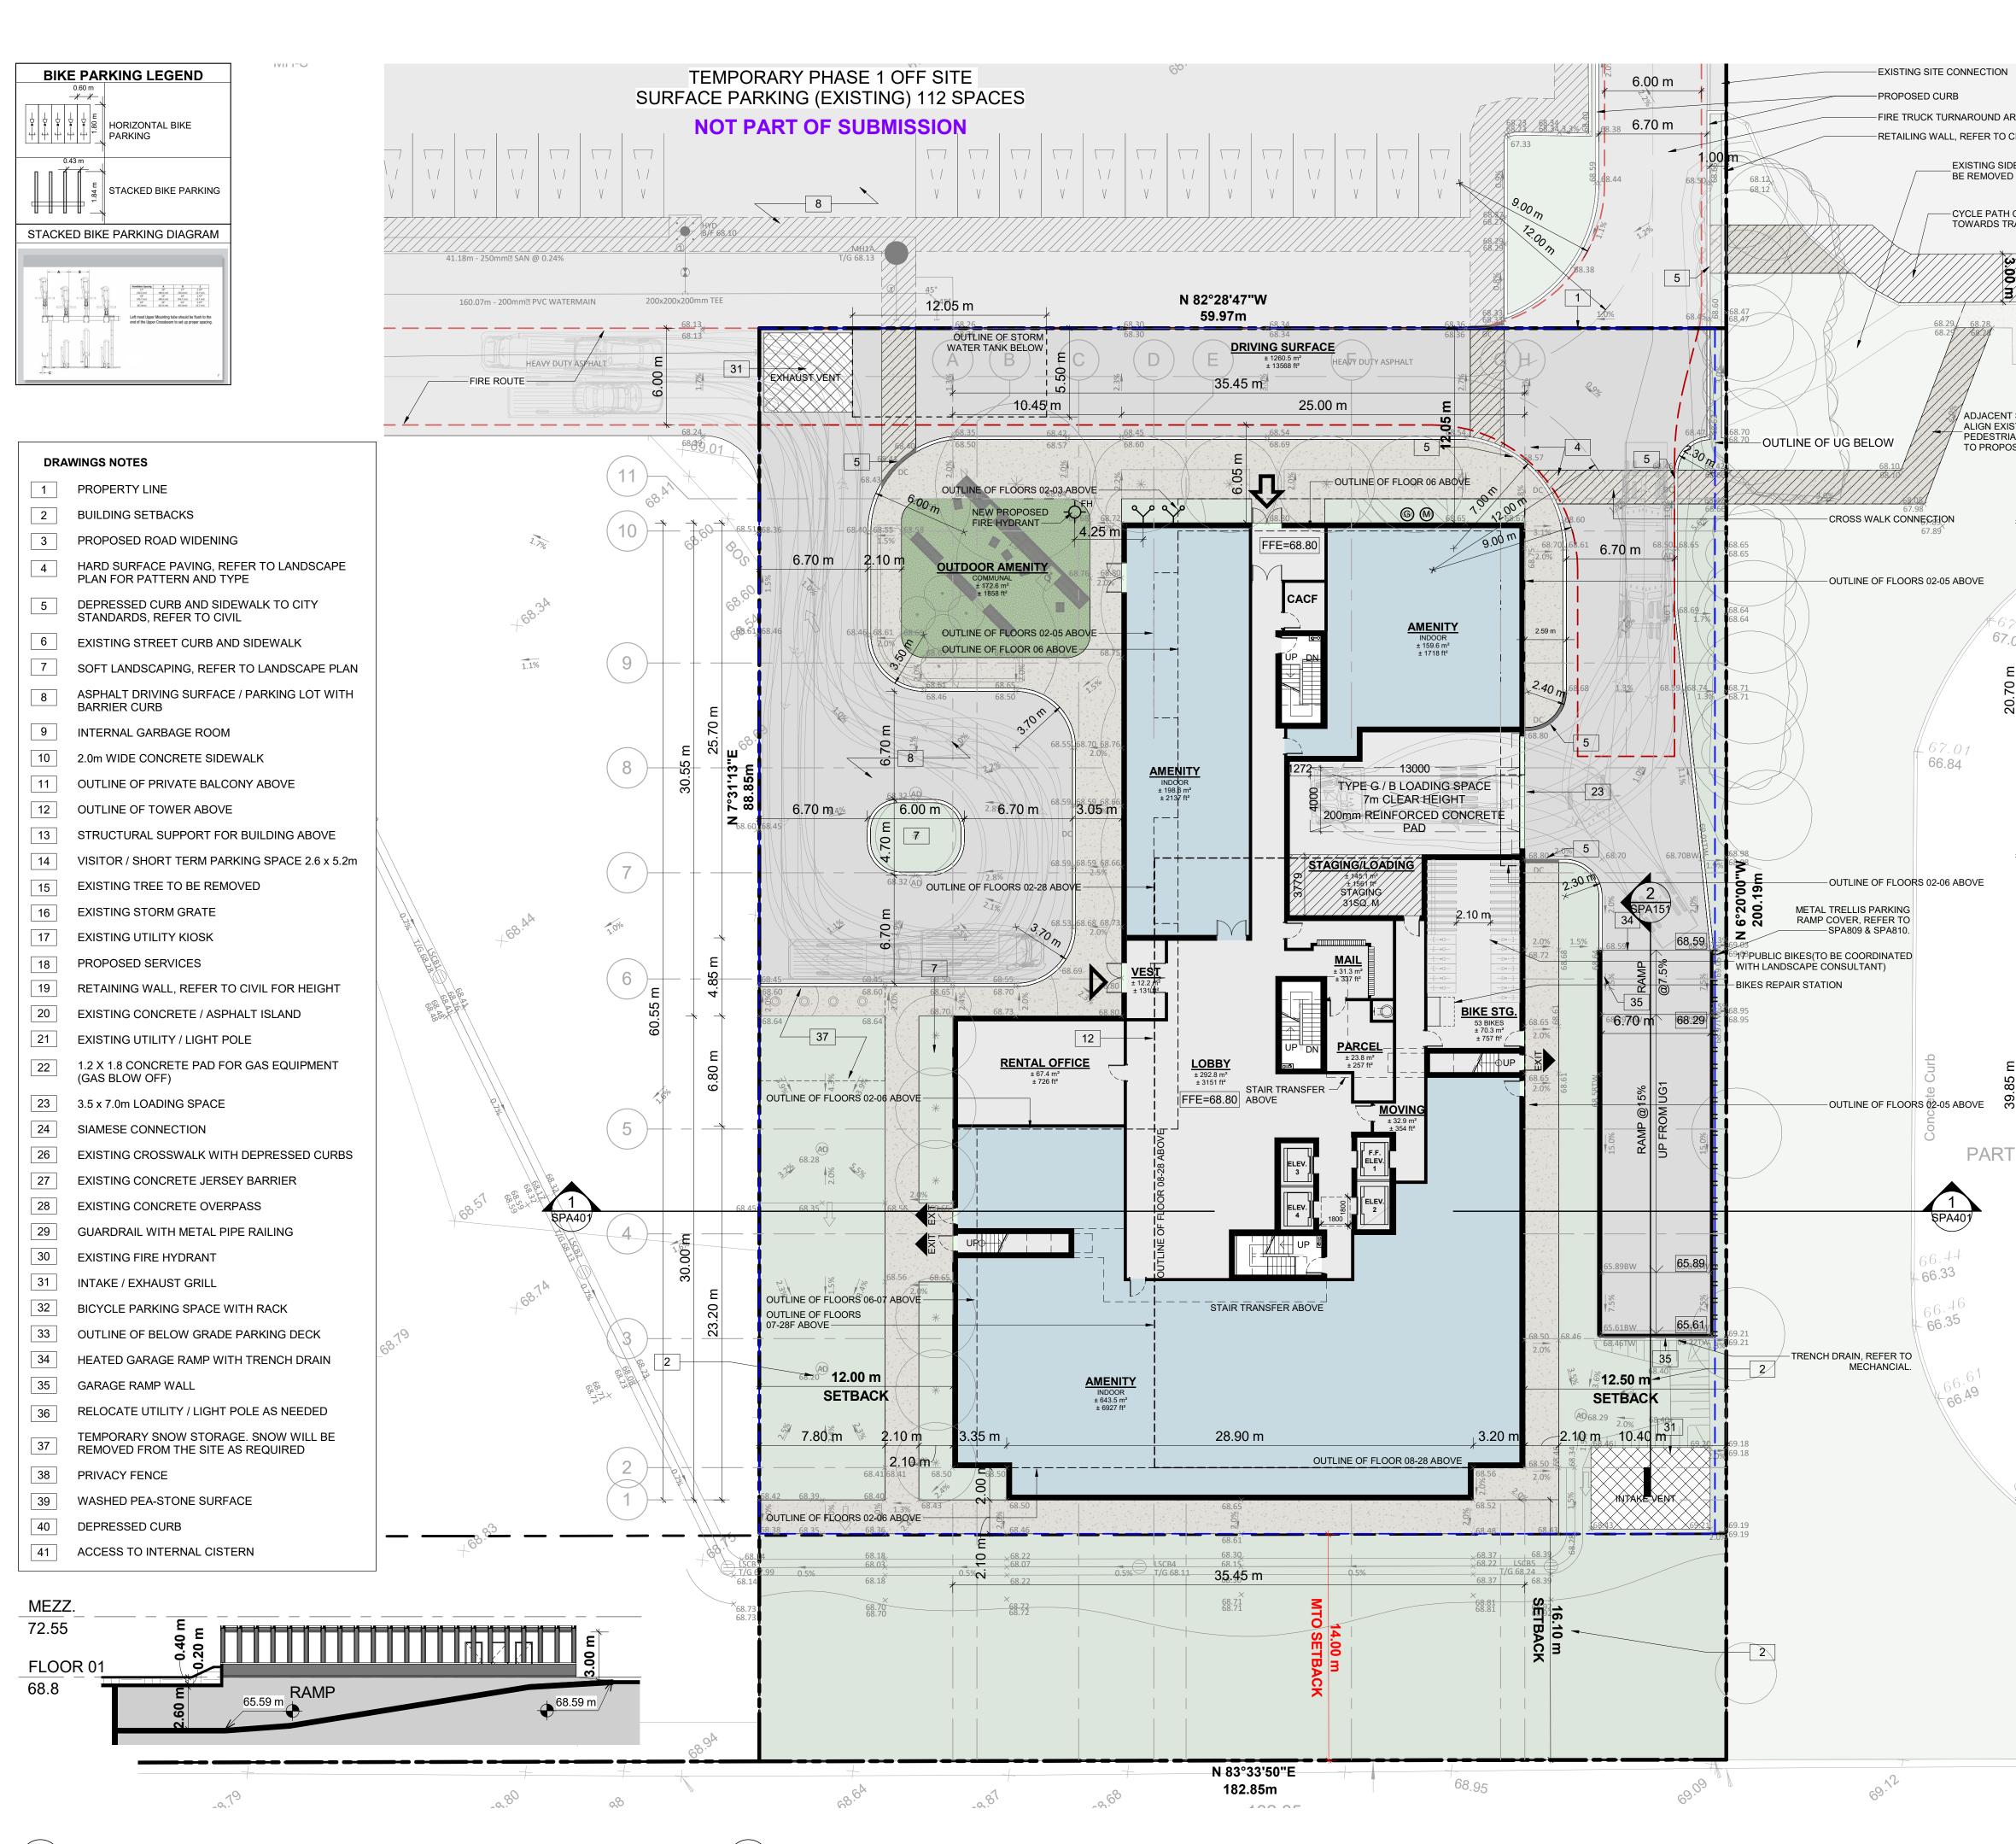

2 RAMP SECTION SPA151 1 : 200

I	NET OVERALL SITE AREA BREAKDOWN	TD3		
	AREA TYPE SITE AREA - BLDG A	m² 5,325.5	ft² 57,323.4	FLEIJUHER
ΕA	TOTAL PARKLAND AREA	3,486.0	37,523	Turner Fleischer Architects Inc. 67 Lesmill Road
EA VIL.	TEMPORARY OFF SITE PARKING (PHASE 1) PHASE 1 SURFACE PARKING	£ 0E4 7	72 754 4	Toronto, ON, M3B 2T8 T 416 425 2222
WALK TO	PHASE 1 SURFACE PARKING ZONING	6,851.7	73,751.1	turnerfleischer.com
	BUILDING HEIGHT	REQUIRED 30 STOREYS /	PROVIDED 28 STOREYS /	Architects Inc. The contractor must verify and accept responsibility for all dimensions and condition on site and must notify Turner Fleischer Architects Inc. of any variations from the supplied information. This drawing is not to be scaled. The architect is not responsible for the accuracy of survey, structural, mechanical, electrical, etc., information shown on this drawing. Refer to the
ONNECTION	GRADE (GEODETIC ELEVATION - ASL)	90.0M	89.7M 68.80M	appropriate consultant's drawings before proceeding with the work. Construction must conform to a applicable codes and requirements of authorities having jurisdiction. The contractor working from drawings not specifically marked 'For Construction' must assume full responsibility and bear costs for any corrections or damages resulting from his work.
	ALLOWABLE PROJECTION - AMENITY LEVEL DENSITY - MINIMUM 350 units/hectare	0.0M 206 UNITS	22.7M 309 UNITS	SITE PLAN SYMBOLS
	FRONT YARD SETBACK CORNER YARD SETBACK (East / West)	3.0M 3.0M/3.0M	110.75M 134.85M/12.5M	PRIMARY RESIDENTIAL ENTRANCE
<u>///////</u>	REAR YARD SETBACK (GROUND TO 6th FLOOR)	0.0M	16.10M	SECONDARY RESIDENTIAL ENTRANCE
	REAR YARD SETBACK (ABOVE 7th STOREY)AMENITY AREA - TOTAL PER UNIT	12.0M 6.0M <sup>2</sup>	18.10M 17.4M <sup>2</sup>	
- 6	AMENITY AREA - 50% COMMUNAL PER UNIT AMENITY AREA - 2.0% OF LOT EXTERIOR AT	3.0M <sup>2</sup> 117.15M <sup>2</sup>	4.55M <sup>2</sup> 172.6M <sup>2</sup>	EXIT
	GRADE COMMUNAL VEHICLE PARKING - RESIDENTIAL (AREA 'Z' - MAX	NOT	289	
TE WORK TO NG	1.5/PER UNIT) VEHICLE PARKING - VISITOR ONLY (MAX. 30,	REQUIRED 30	30	SIAMESE CONNECTION
CONNECTION D SIDEWALK	AFTER 12 UNITS)			
	BICYCLE PARKING - RESIDENTIAL - 0.5 PER UNIT AISLE & DRIVEWAY MINIMUM / MAXIMUM WIDTH	165 6.0M/6.7M	309 6.7M	000.00 SPOT ELEVATION
	GROSS BUILDING FLOOR AREA (OTTAWA ZONING D	EFINITION)	ft²	
- +	UG1	111-	11-	GAS/HYDRO METER
	FLOOR 01 FLOOR 02	1,339.6	14,419	REFER TO LANDSCAPE DRAWINGS FOR SURFACE TREATMENT
	FLOOR 03-05         1,339.6 m² x 3           FLOOR 06	4,018.8 1,224.1	43,257 13,176	MINIMUM PERMITTED PARKING
1 ~	FLOOR 07           FLOOR 08 - FLOOR 28         725.2 m² x 21	631.4 15,229.2	6,796	DIMENSIONS TYPICAL PARKING DIMENSIONS
}	TOTAL	22,443.7	163,926 <b>241,582</b>	AISLE WIDTH: MIN 6.7m
		725.2	7,806	TYPICAL PARKING SPACE: MIN 2.6 x 5.2 x 2.1 m HIGH
	UNIT STATISTICS		UNITS	2600
	1B 1B+D		58 82	
	2B 2B+D		77 61	
	3B		31	
	TOTAL VEHICULAR PARKING SPACES REQUIRED- AREA 'Z'		309	A A A A A A A A A A A A A A A A A A A
_	VISITOR 0.1 SPACES PER UNIT AFTER 12 U		30	
	RESIDENTIAL N/A		0 <b>30</b>	
	VEHICULAR PARKING SPACES PROVIDED			
	VISITOR 0.1 SPACES PER UNIT (309 UNITS	,	30	TYPICAL BARRIER FREE SPACE
	RESIDENTIAL0.56 SPACES PER UNIT (309 UNITTOTAL	S)	177 <b>207</b>	MIN 3.66 x 5.2 x 2.1m HIGH
E	EXISTING SURFACE PARKING LOTTOTAL1.03 PER UNIT (309 UNITS)		112 319	
Asghali				
<i>u</i>	ACCESSIBLE PARKING SPACES REQUIRED - (NOT IN TYPE 'A'		3	3400 2400
	TYPE 'B'		Ű	TYPE'A' TYPE'B' 1500
	TOTAL		4 7	
	TOTAL ACCESSIBLE PARKING SPACES PROVIDED - (NOT IN	ICLUDING SURFA	4 7	
			4 7	
5 PLAN	ACCESSIBLE PARKING SPACES PROVIDED - (NOT IN TYPE 'A'		4 7 ACE PARKING) 3	
5 PLAN	ACCESSIBLE PARKING SPACES PROVIDED - (NOT IN TYPE 'A' TYPE 'B'		4 7 ACE PARKING) 3 5	
5 PLAN	ACCESSIBLE PARKING SPACES PROVIDED - (NOT IN TYPE 'A' TYPE 'B' TOTAL STANDARD PARKING SPACE PARALLEL PARKING SPACE		4 7 ACE PARKING) 3 5 8 2.6m X 5.2m 2.6m X 6.7m	
5 PLAN	ACCESSIBLE PARKING SPACES PROVIDED - (NOT IN TYPE 'A' TYPE 'B' TOTAL STANDARD PARKING SPACE		4 7 ACE PARKING) 3 5 8 2.6m X 5.2m	
5 PLAN	ACCESSIBLE PARKING SPACES PROVIDED - (NOT IN TYPE 'A' TYPE 'B' TOTAL STANDARD PARKING SPACE PARALLEL PARKING SPACE SMALL PARKING SPACE		4 7 ACE PARKING) 3 5 8 2.6m X 5.2m 2.6m X 5.2m 2.6m X 6.7m 2.4m X 4.6m	
5 PLAN	ACCESSIBLE PARKING SPACES PROVIDED - (NOT IN TYPE 'A' TYPE 'B' TOTAL STANDARD PARKING SPACE PARALLEL PARKING SPACE SMALL PARKING SPACE ACCESSIBLE PARKING SPACE ' TYPE A ' ACCESSIBLE PARKING SPACE ' TYPE B ' LOADING SPACE BICYCLE PARKING SPACES REQUIRED		4 7 ACE PARKING) 3 5 8 2.6m X 5.2m 2.6m X 5.2m 2.6m X 6.7m 2.4m X 4.6m 3.4m X 5.2m 2.4m X 5.2m 3.5m X 7.0m	2     2024-11-01     ISSUED FOR SITE PLAN APPROVAL     AYU       1     2024-01-30     ISSUED FOR PRE-CONSTRUCTION     AYU       #     DATE     DESCRIPTION     BY
5 PLAN	ACCESSIBLE PARKING SPACES PROVIDED - (NOT IN TYPE 'A' TYPE 'B' TOTAL STANDARD PARKING SPACE PARALLEL PARKING SPACE SMALL PARKING SPACE ACCESSIBLE PARKING SPACE ' TYPE A ' ACCESSIBLE PARKING SPACE ' TYPE B ' LOADING SPACE		4 7 ACE PARKING) 3 5 8 2.6m X 5.2m 2.6m X 6.7m 2.4m X 4.6m 3.4m X 5.2m 2.4m X 5.2m	2       2024-11-01       ISSUED FOR SITE PLAN APPROVAL       AYU         1       2024-01-30       ISSUED FOR PRE-CONSTRUCTION       AYU
5 PLAN	ACCESSIBLE PARKING SPACES PROVIDED - (NOT IN TYPE 'A' TYPE 'B' TOTAL STANDARD PARKING SPACE PARALLEL PARKING SPACE SMALL PARKING SPACE ACCESSIBLE PARKING SPACE ' TYPE A ' ACCESSIBLE PARKING SPACE ' TYPE B ' LOADING SPACE BICYCLE PARKING SPACES REQUIRED RESIDENTIAL 0.5 PER UNIT (309 UNITS) TOTAL BICYCLE PARKING SPACES PROVIDED		4 7 ACE PARKING) 3 5 8 2.6m X 5.2m 2.6m X 5.2m 2.6m X 6.7m 2.4m X 4.6m 3.4m X 5.2m 2.4m X 5.2m <b>3.5m X 7.0m</b> 155 155	2 2024-11-01 ISSUED FOR SITE PLAN APPROVAL AYU 1 2024-01-30 ISSUED FOR PRE-CONSTRUCTION AYU # DATE DESCRIPTION BY
5 PLAN	ACCESSIBLE PARKING SPACES PROVIDED - (NOT IN TYPE 'A' TYPE 'B' TOTAL STANDARD PARKING SPACE PARALLEL PARKING SPACE SMALL PARKING SPACE ACCESSIBLE PARKING SPACE ' TYPE A ' ACCESSIBLE PARKING SPACE ' TYPE B ' LOADING SPACE BICYCLE PARKING SPACES REQUIRED RESIDENTIAL 0.5 PER UNIT (309 UNITS) TOTAL BICYCLE PARKING SPACES PROVIDED RESIDENTIAL INTERIOR EXTERIOR		4 7 ACE PARKING) 3 5 8 2.6m X 5.2m 2.6m X 5.2m 2.6m X 6.7m 2.4m X 4.6m 3.4m X 5.2m 2.4m X 5.2m 3.5m X 7.0m 155 155 309 0	2 2024-11-01 ISSUED FOR SITE PLAN APPROVAL AYU 1 2024-01-30 ISSUED FOR PRE-CONSTRUCTION AYU # DATE DESCRIPTION BY
5 PLAN	ACCESSIBLE PARKING SPACES PROVIDED - (NOT IN TYPE 'A' TYPE 'B' TOTAL STANDARD PARKING SPACE PARALLEL PARKING SPACE SMALL PARKING SPACE ACCESSIBLE PARKING SPACE ' TYPE A ' ACCESSIBLE PARKING SPACE ' TYPE B ' LOADING SPACE BICYCLE PARKING SPACES REQUIRED RESIDENTIAL 0.5 PER UNIT (309 UNITS) TOTAL BICYCLE PARKING SPACES PROVIDED RESIDENTIAL INTERIOR		4 7 ACE PARKING) 3 5 8 2.6m X 5.2m 2.6m X 5.2m 2.6m X 6.7m 2.4m X 4.6m 3.4m X 5.2m 2.4m X 5.2m 3.5m X 7.0m 155 155 309	2       2024-11-01       ISSUED FOR SITE PLAN APPROVAL       AYU         1       2024-01-30       ISSUED FOR PRE-CONSTRUCTION       AYU
5 PLAN	ACCESSIBLE PARKING SPACES PROVIDED - (NOT IN TYPE 'A' TYPE 'B' TOTAL STANDARD PARKING SPACE PARALLEL PARKING SPACE SMALL PARKING SPACE ACCESSIBLE PARKING SPACE ' TYPE A ' ACCESSIBLE PARKING SPACE ' TYPE B ' LOADING SPACE BICYCLE PARKING SPACES REQUIRED RESIDENTIAL 0.5 PER UNIT (309 UNITS) TOTAL BICYCLE PARKING SPACES PROVIDED RESIDENTIAL INTERIOR EXTERIOR		4 7 ACE PARKING) 3 5 8 2.6m X 5.2m 2.6m X 5.2m 2.6m X 6.7m 2.4m X 4.6m 3.4m X 5.2m 2.4m X 5.2m 3.5m X 7.0m 155 155 309 0	2       2024-11-01       ISSUED FOR SITE PLAN APPROVAL       AYU         1       2024-01-30       ISSUED FOR PRE-CONSTRUCTION       AYU         #       DATE       DESCRIPTION       BY
5 PLAN	ACCESSIBLE PARKING SPACES PROVIDED - (NOT IN TYPE 'A' TYPE 'B' TOTAL STANDARD PARKING SPACE PARALLEL PARKING SPACE SMALL PARKING SPACE ACCESSIBLE PARKING SPACE ' TYPE A ' ACCESSIBLE PARKING SPACE ' TYPE B ' LOADING SPACE BICYCLE PARKING SPACES REQUIRED RESIDENTIAL 0.5 PER UNIT (309 UNITS) TOTAL BICYCLE PARKING SPACES PROVIDED RESIDENTIAL INTERIOR EXTERIOR TOTAL 1.0 PER UNIT (309 UNITS) AMENITY AREA		4 7 ACE PARKING) 3 5 8 2.6m X 5.2m 2.6m X 5.2m 2.4m X 4.6m 3.4m X 5.2m 2.4m X 5.2m 3.5m X 7.0m 155 155 309 0 309	2 2024-11-01 ISSUED FOR SITE PLAN APPROVAL AYU 1 2024-01-30 ISSUED FOR PRE-CONSTRUCTION AYU # DATE DESCRIPTION BY
5 PLAN	ACCESSIBLE PARKING SPACES PROVIDED - (NOT IN TYPE 'A' TYPE 'B' TOTAL STANDARD PARKING SPACE PARALLEL PARKING SPACE SMALL PARKING SPACE ACCESSIBLE PARKING SPACE ' TYPE A ' ACCESSIBLE PARKING SPACE ' TYPE B ' LOADING SPACE BICYCLE PARKING SPACES REQUIRED RESIDENTIAL 0.5 PER UNIT (309 UNITS) TOTAL BICYCLE PARKING SPACES PROVIDED RESIDENTIAL INTERIOR EXTERIOR TOTAL 1.0 PER UNIT (309 UNITS) AMENITY AREA GRADE EXTERIOR - COMMUNAL INTERIOR - COMMUNAL	m <sup>2</sup> 172.6 1,095.4	4 7 ACE PARKING) 3 5 8 2.6m X 5.2m 2.6m X 5.2m 2.6m X 6.7m 2.4m X 4.6m 3.4m X 5.2m 3.4m X 5.2m 3.5m X 7.0m 155 155 309 0 309 0 309 0 309 1,858 11,791	2       2024-11-01       ISSUED FOR SITE PLAN APPROVAL       AYU         1       2024-01-30       ISSUED FOR PRE-CONSTRUCTION       AYU         #       DATE       DESCRIPTION       BY         ISSUED FOR SITE PLAN APPROVAL         #       DATE       DESCRIPTION       BY         ISSUED FOR SITE PLAN APPROVAL         #       DATE       DESCRIPTION       BY
5 PLAN	ACCESSIBLE PARKING SPACES PROVIDED - (NOT IN TYPE 'A' TYPE 'B' TOTAL STANDARD PARKING SPACE PARALLEL PARKING SPACE SMALL PARKING SPACE ACCESSIBLE PARKING SPACE ' TYPE A ' ACCESSIBLE PARKING SPACE ' TYPE B ' LOADING SPACE BICYCLE PARKING SPACES REQUIRED RESIDENTIAL 0.5 PER UNIT (309 UNITS) TOTAL BICYCLE PARKING SPACES PROVIDED RESIDENTIAL INTERIOR EXTERIOR TOTAL 1.0 PER UNIT (309 UNITS) AMENITY AREA GRADE EXTERIOR - COMMUNAL	m <sup>2</sup> 172.6	4 7 ACE PARKING) 3 5 8 2.6m X 5.2m 2.6m X 6.7m 2.4m X 4.6m 3.4m X 5.2m 2.4m X 5.2m 3.5m X 7.0m 155 155 309 0 309 0 309 1,858	2       2024-11-01       ISSUED FOR SITE PLAN APPROVAL       AYU         1       2024-01-30       ISSUED FOR PRE-CONSTRUCTION       AYU         #       DATE       DESCRIPTION       BY         ISSUED FOR SITE PLAN APPROVAL         #       DATE       DESCRIPTION       BY         ISSUED FOR SITE PLAN APPROVAL         #       DATE       DESCRIPTION       BY
5 PLAN	ACCESSIBLE PARKING SPACES PROVIDED - (NOT IN TYPE 'A' TYPE 'B' TOTAL STANDARD PARKING SPACE PARALLEL PARKING SPACE SMALL PARKING SPACE ACCESSIBLE PARKING SPACE ' TYPE A ' ACCESSIBLE PARKING SPACE ' TYPE B ' LOADING SPACE BICYCLE PARKING SPACES REQUIRED RESIDENTIAL 0.5 PER UNIT (309 UNITS) TOTAL BICYCLE PARKING SPACES PROVIDED RESIDENTIAL INTERIOR EXTERIOR TOTAL 1.0 PER UNIT (309 UNITS) AMENITY AREA GRADE EXTERIOR - COMMUNAL INTERIOR - COMMUNAL OTF EXTERIOR - COMMUNAL TOTAL COMMUNAL BALCONIES / TERRACE - PRIVATE	m <sup>2</sup> 172.6 1,095.4 202.1 <b>1,470.1</b> 3,506.2	4 7 ACE PARKING) 3 5 8 2.6m X 5.2m 2.6m X 6.7m 2.4m X 4.6m 3.4m X 5.2m 2.4m X 5.2m 3.5m X 7.0m 155 155 309 0 309 0 309 0 309 0 309 0 309 155 155 155 155 155 155 155 15	2       2024-11-01       ISSUED FOR SITE PLAN APPROVAL       AYU         1       2024-01-30       ISSUED FOR PRE-CONSTRUCTION       AYU         #       DATE       DESCRIPTION       BY         INTERCEMENTION         # DESCRIPTION         INTERCEMENTED         PROJECT         500 COVENTRY ROAD
5 PLAN	ACCESSIBLE PARKING SPACES PROVIDED - (NOT IN TYPE 'A' TYPE 'B' TOTAL STANDARD PARKING SPACE PARALLEL PARKING SPACE SMALL PARKING SPACE ACCESSIBLE PARKING SPACE ' TYPE A ' ACCESSIBLE PARKING SPACE ' TYPE B ' LOADING SPACE BICYCLE PARKING SPACES REQUIRED RESIDENTIAL 0.5 PER UNIT (309 UNITS) TOTAL BICYCLE PARKING SPACES PROVIDED RESIDENTIAL INTERIOR EXTERIOR TOTAL 1.0 PER UNIT (309 UNITS) AMENITY AREA GRADE EXTERIOR - COMMUNAL INTERIOR - COMMUNAL TOTAL COMMUNAL	m² 172.6 1,095.4 202.1 1,470.1	4 7 ACE PARKING) 3 5 8 2.6m X 5.2m 2.6m X 6.7m 2.4m X 4.6m 3.4m X 5.2m 2.4m X 5.2m 3.5m X 7.0m 155 155 309 0 309 0 309 0 309 0 309 155 155 155 155 155 155 155 15	2       2024-11-01       ISSUED FOR SITE PLAN APPROVAL       AYU         1       2024-01-30       ISSUED FOR PRE-CONSTRUCTION       AYU         #       DATE       DESCRIPTION       BY         INTERCONSTRUCTION         #       DATE       DESCRIPTION       BY         INTERCONSTRUCTION         PROJECT         S00 COVENTRY ROAD, OTTAWA, ON.
5 PLAN	ACCESSIBLE PARKING SPACES PROVIDED - (NOT IN TYPE 'A' TYPE 'B' TOTAL STANDARD PARKING SPACE PARALLEL PARKING SPACE SMALL PARKING SPACE ACCESSIBLE PARKING SPACE ' TYPE A ' ACCESSIBLE PARKING SPACE ' TYPE B ' LOADING SPACE BICYCLE PARKING SPACES REQUIRED RESIDENTIAL 0.5 PER UNIT (309 UNITS) TOTAL BICYCLE PARKING SPACES PROVIDED RESIDENTIAL INTERIOR EXTERIOR TOTAL 1.0 PER UNIT (309 UNITS) AMENITY AREA GRADE EXTERIOR - COMMUNAL INTERIOR - COMMUNAL O7F EXTERIOR - COMMUNAL TOTAL BALCONIES / TERRACE - PRIVATE TOTAL	m <sup>2</sup> 172.6 1,095.4 202.1 <b>1,470.1</b> 3,506.2	4 7 ACE PARKING) 3 5 8 2.6m X 5.2m 2.6m X 6.7m 2.4m X 4.6m 3.4m X 5.2m 2.4m X 5.2m 3.5m X 7.0m 155 155 309 0 309 0 309 0 309 0 309 0 309 155 155 155 155 155 155 155 15	2       2024-11-01       ISSUED FOR SITE PLAN APPROVAL       AYU         1       2024-01-30       ISSUED FOR PRE-CONSTRUCTION       AYU         #       DATE       DESCRIPTION       BY         INTERCONSTRUCTION         #       DATE       DESCRIPTION       BY         INTERCONSTRUCTION         PROJECT         S00 COVENTRY ROAD, OTTAWA, ON.
5 PLAN	ACCESSIBLE PARKING SPACES PROVIDED - (NOT IN TYPE 'A' TYPE 'B' TOTAL STANDARD PARKING SPACE PARALLEL PARKING SPACE SMALL PARKING SPACE ACCESSIBLE PARKING SPACE ' TYPE A ' ACCESSIBLE PARKING SPACE ' TYPE B ' LOADING SPACE BICYCLE PARKING SPACES REQUIRED RESIDENTIAL 0.5 PER UNIT (309 UNITS) TOTAL BICYCLE PARKING SPACES PROVIDED RESIDENTIAL INTERIOR EXTERIOR TOTAL 1.0 PER UNIT (309 UNITS) AMENITY AREA GRADE EXTERIOR - COMMUNAL INTERIOR - COMMUNAL O7F EXTERIOR - COMMUNAL TOTAL 5 / TERRACE - PRIVATE TOTAL BALCONIES / TERRACE - PRIVATE TOTAL REQUIRED (309 UNITS X 6 m²) = 1,854 sq. m.	m <sup>2</sup> 172.6 1,095.4 202.1 <b>1,470.1</b> 3,506.2	4 7 ACE PARKING) 3 5 8 2.6m X 5.2m 2.6m X 6.7m 2.4m X 4.6m 3.4m X 5.2m 2.4m X 5.2m 3.5m X 7.0m 155 155 309 0 309 0 309 0 309 0 309 0 309 155 155 155 155 155 155 155 15	2       2024-11-01       ISSUED FOR SITE PLAN APPROVAL       AYU         1       2024-01-30       ISSUED FOR PRE-CONSTRUCTION       AYU         #       DATE       DESCRIPTION       BY         OPOJECT         PROJECT         S00 COVENTRY ROAD, OTTAWA, ON.         DRAWING
5 PLAN	ACCESSIBLE PARKING SPACES PROVIDED - (NOT IN TYPE 'A' TYPE 'B' TOTAL STANDARD PARKING SPACE PARALLEL PARKING SPACE SMALL PARKING SPACE ACCESSIBLE PARKING SPACE ' TYPE A ' ACCESSIBLE PARKING SPACE ' TYPE B ' LOADING SPACE BICYCLE PARKING SPACES REQUIRED RESIDENTIAL 0.5 PER UNIT (309 UNITS) TOTAL BICYCLE PARKING SPACES PROVIDED RESIDENTIAL INTERIOR EXTERIOR TOTAL 1.0 PER UNIT (309 UNITS) AMENITY AREA GRADE EXTERIOR - COMMUNAL INTERIOR - COMMUNAL 07F EXTERIOR - COMMUNAL D7F EXTERIOR - COMMUNAL BALCONIES / TERRACE - PRIVATE TOTAL REQUIRED (309 UNITS X 6 m <sup>2</sup> ) = 1,854 sq. m. REQUIRED COMMUNAL @ 50% = 927 sq. m.	m² 172.6 1,095.4 202.1 1,470.1 3,506.2 4,976.3	4 7 ACE PARKING) 3 5 8 2.6m X 5.2m 2.6m X 5.2m 2.6m X 6.7m 2.4m X 4.6m 3.4m X 5.2m 2.4m X 5.2m 3.5m X 7.0m 155 155 309 0 309 30 309 30 30 30 30 30 30 30 30 30 30 30 30 30	2       2024-11-01       ISSUED FOR SITE PLAN APPROVAL       AYU         1       2024-01-30       ISSUED FOR PRE-CONSTRUCTION       AYU         #       DATE       DESCRIPTION       BY         INTERCEMENTION DESCRIPTION         INTERCEMENTION         PROJECT         DOD COVENTRY ROAD         500 COVENTRY ROAD, OTTAWA, ON.         DRAWING         FLOOR 01
5 PLAN	ACCESSIBLE PARKING SPACES PROVIDED - (NOT IN TYPE 'A' TYPE 'B' TOTAL STANDARD PARKING SPACE PARALLEL PARKING SPACE SMALL PARKING SPACE ACCESSIBLE PARKING SPACE ' TYPE A ' ACCESSIBLE PARKING SPACE ' TYPE B ' LOADING SPACE BICYCLE PARKING SPACES REQUIRED RESIDENTIAL 0.5 PER UNIT (309 UNITS) TOTAL BICYCLE PARKING SPACES PROVIDED RESIDENTIAL INTERIOR EXTERIOR TOTAL 1.0 PER UNIT (309 UNITS) AMENITY AREA GRADE EXTERIOR - COMMUNAL INTERIOR - COMMUNAL O7F EXTERIOR - COMMUNAL TOTAL COMMUNAL BALCONIES / TERRACE - PRIVATE TOTAL REQUIRED (309 UNITS X 6 m <sup>2</sup> ) = 1,854 sq. m. REQUIRED COMMUNAL @ 50% = 927 sq. m. SITE COVERAGE BUILDING FOOTPRINT DRIVING SURFACE	m <sup>2</sup> 172.6 1,095.4 202.1 1,470.1 3,506.2 4,976.3 m <sup>2</sup> 1,815.4 1,260.5	4 7 ACE PARKING) 3 5 8 2.6m X 5.2m 2.6m X 5.2m 2.6m X 6.7m 2.4m X 4.6m 3.4m X 5.2m 2.4m X 5.2m 3.5m X 7.0m 155 155 309 0 309 0 309 0 309 0 309 0 309 0 309 0 309 0 309 0 309 0 309 0 309 0 309 0 309	2       2024-11-01       ISSUED FOR SITE PLAN APPROVAL       AYU         1       2024-01-30       ISSUED FOR PRE-CONSTRUCTION       AYU         #       DATE       DESCRIPTION       BY         INTERCEMENTION DESCRIPTION         INTERCEMENTION         PROJECT         DOD COVENTRY ROAD         500 COVENTRY ROAD, OTTAWA, ON.         DRAWING         FLOOR 01
5 PLAN	ACCESSIBLE PARKING SPACES PROVIDED - (NOT IN TYPE 'A' TYPE 'B' TOTAL STANDARD PARKING SPACE PARALLEL PARKING SPACE SMALL PARKING SPACE ACCESSIBLE PARKING SPACE ' TYPE A ' ACCESSIBLE PARKING SPACE ' TYPE B ' LOADING SPACE BICYCLE PARKING SPACES REQUIRED RESIDENTIAL 0.5 PER UNIT (309 UNITS) TOTAL BICYCLE PARKING SPACES PROVIDED RESIDENTIAL INTERIOR EXTERIOR TOTAL 1.0 PER UNIT (309 UNITS) AMENITY AREA GRADE EXTERIOR - COMMUNAL INTERIOR - COMMUNAL 07F EXTERIOR - COMMUNAL TOTAL COMMUNAL BALCONIES / TERRACE - PRIVATE TOTAL REQUIRED (309 UNITS X 6 m²) = 1,854 sq. m. REQUIRED COMMUNAL @ 50% = 927 sq. m. SITE COVERAGE BUILDING FOOTPRINT	m² 172.6 1,095.4 202.1 1,470.1 3,506.2 4,976.3 m² 1,815.4	4 7 ACE PARKING) 3 5 8 2.6m X 5.2m 2.6m X 5.2m 2.6m X 6.7m 2.4m X 4.6m 3.4m X 5.2m 2.4m X 5.2m 3.5m X 7.0m 155 155 309 0 309 309	2       2024-11-01       ISSUED FOR SITE PLAN APPROVAL       AYU         1       2024-01-30       ISSUED FOR SITE PLAN APPROVAL       AYU         1       2024-01-30       ISSUED FOR PRE-CONSTRUCTION       AYU         #       DATE       DESCRIPTION       BY         OPOJECT         PROJECT         DO COVENTRY ROAD, OTTAWA, ON.         DRAWING         FLOOR 01         PROJECT NO.       18.050 P01         PROJECT NO.
5 PLAN	ACCESSIBLE PARKING SPACES PROVIDED - (NOT IN TYPE 'A' TYPE 'B' TOTAL STANDARD PARKING SPACE PARALLEL PARKING SPACE SMALL PARKING SPACE ACCESSIBLE PARKING SPACE ' TYPE A ' ACCESSIBLE PARKING SPACE ' TYPE B ' LOADING SPACE BICYCLE PARKING SPACES REQUIRED RESIDENTIAL 0.5 PER UNIT (309 UNITS) TOTAL BICYCLE PARKING SPACES PROVIDED RESIDENTIAL INTERIOR EXTERIOR TOTAL 1.0 PER UNIT (309 UNITS) AMENITY AREA GRADE EXTERIOR - COMMUNAL INTERIOR - COMMUNAL 07F EXTERIOR - COMMUNAL TOTAL COMMUNAL BALCONIES / TERRACE - PRIVATE TOTAL REQUIRED (309 UNITS X 6 m²) = 1,854 sq. m. REQUIRED COMMUNAL @ 50% = 927 sq. m. SITE COVERAGE BUILDING FOOTPRINT DRIVING SURFACE LANDSCAPE AREA	m <sup>2</sup> 172.6 1,095.4 202.1 1,470.1 3,506.2 4,976.3 m <sup>2</sup> 1,815.4 1,260.5 2,249.6	4 7 ACE PARKING) 3 5 8 2.6m X 5.2m 2.6m X 6.7m 2.4m X 4.6m 3.4m X 5.2m 2.4m X 5.2m 3.5m X 7.0m 155 155 309 0 309 30 309 0 309 0 309 0 309 0 309 30 30 30 30 30 30 30 30 30 30	2       2024-11-01       ISSUED FOR SITE PLAN APPROVAL       AYU         1       2024-01-30       ISSUED FOR PRE-CONSTRUCTION       AYU         #       DATE       DESCRIPTION       BY         INCOMPRE-CONSTRUCTION
5 PLAN	ACCESSIBLE PARKING SPACES PROVIDED - (NOT IN TYPE 'A' TYPE 'B' TOTAL STANDARD PARKING SPACE PARALLEL PARKING SPACE SMALL PARKING SPACE ACCESSIBLE PARKING SPACE ' TYPE A ' ACCESSIBLE PARKING SPACE ' TYPE B ' LOADING SPACE BICYCLE PARKING SPACES REQUIRED RESIDENTIAL 0.5 PER UNIT (309 UNITS) TOTAL BICYCLE PARKING SPACES PROVIDED RESIDENTIAL INTERIOR EXTERIOR TOTAL 1.0 PER UNIT (309 UNITS) AMENITY AREA GRADE EXTERIOR - COMMUNAL INTERIOR - COMMUNAL 07F EXTERIOR - COMMUNAL O7F EXTERIOR - COMMUNAL TOTAL COMMUNAL BALCONIES / TERRACE - PRIVATE TOTAL REQUIRED (309 UNITS X 6 m²) = 1,854 sq. m. REQUIRED COMMUNAL @ 50% = 927 sq. m. SITE COVERAGE BUILDING FOOTPRINT DRIVING SURFACE LANDSCAPE AREA TOTAL BUILDING A REFUGE REQUIREMENT (309 UNITS)	m <sup>2</sup> 172.6 1,095.4 202.1 1,470.1 3,506.2 4,976.3 m <sup>2</sup> 1,815.4 1,260.5 2,249.6 5,325.5	4 7 ACE PARKING) 3 5 8 2.6m X 5.2m 2.6m X 5.2m 2.6m X 6.7m 2.4m X 4.6m 3.4m X 5.2m 2.4m X 5.2m 3.5m X 7.0m 155 155 309 0 309 30 30 30 30 30 30 30 30 30 30 30 30 30	2       2024-11-01       ISSUED FOR SITE PLAN APPROVAL       AYU         1       2024-01-30       ISSUED FOR PRE-CONSTRUCTION       AYU         #       DATE       DESCRIPTION       BY         INCONCECTION       AYU         #       DATE       DESCRIPTION       BY         INCONCECTION         PROJECT         PROJECT         DO COVENTRY ROAD, OTTAWA, ON.         DRAWING         FLOOR 01         PROJECT NO.         18.050 P01       PROJECT TATE         PROJECT TATE         2024-09-13         DRAWINBY       RYT / DRO         CHECKED BY         ASSOUT
	ACCESSIBLE PARKING SPACES PROVIDED - (NOT IN TYPE 'A' TYPE 'B' TOTAL STANDARD PARKING SPACE PARALLEL PARKING SPACE SMALL PARKING SPACE ACCESSIBLE PARKING SPACE ' TYPE A ' ACCESSIBLE PARKING SPACE ' TYPE B ' LOADING SPACE BICYCLE PARKING SPACES REQUIRED RESIDENTIAL 0.5 PER UNIT (309 UNITS) TOTAL BICYCLE PARKING SPACES PROVIDED RESIDENTIAL INTERIOR EXTERIOR TOTAL 1.0 PER UNIT (309 UNITS) AMENITY AREA GRADE EXTERIOR - COMMUNAL INTERIOR - COMMUNAL INTERIOR - COMMUNAL O7F EXTERIOR - COMMUNAL TOTAL BALCONIES / TERRACE - PRIVATE TOTAL REQUIRED (309 UNITS X 6 m²) = 1,854 sq. m. REQUIRED COMMUNAL @ 50% = 927 sq. m. SITE COVERAGE BUILDING FOOTPRINT DRIVING SURFACE LANDSCAPE AREA TOTAL BUILDING A REFUGE REQUIREMENT (309 UNITS)	m² 172.6 1,095.4 202.1 1,095.4 202.1 1,470.1 3,506.2 4,976.3 1,815.4 1,260.5 2,249.6 5,325.5 PACTED RATIO 0.053 yd³/UNIT 0.018 yd³/UNIT	4 7 ACE PARKING) 3 5 8 2.6m X 5.2m 2.6m X 5.2m 2.6m X 6.7m 2.4m X 4.6m 3.4m X 5.2m 3.4m X 5.2m 3.5m X 7.0m 155 155 309 0 309 30 30 30 30 30 30 30 30 30 30 30 30 30	2       2024-11-01       ISSUED FOR SITE PLAN APPROVAL       AYU         1       2024-01-30       ISSUED FOR PRE-CONSTRUCTION       AYU         #       DATE       DESCRIPTION       BY         INCOMPRESSION CONSTRUCTION
5 PLAN	ACCESSIBLE PARKING SPACES PROVIDED - (NOT IN TYPE 'A' TYPE 'B' TOTAL STANDARD PARKING SPACE PARALLEL PARKING SPACE SMALL PARKING SPACE SMALL PARKING SPACE SMALL PARKING SPACE ' TYPE A ' ACCESSIBLE PARKING SPACE ' TYPE B ' LOADING SPACE BICYCLE PARKING SPACES REQUIRED RESIDENTIAL 0.5 PER UNIT (309 UNITS) TOTAL BICYCLE PARKING SPACES PROVIDED RESIDENTIAL INTERIOR EXTERIOR TOTAL 1.0 PER UNIT (309 UNITS) AMENITY AREA GRADE EXTERIOR - COMMUNAL INTERIOR - COMMUNAL 07F EXTERIOR - COMMUNAL TOTAL COMMUNAL BALCONIES / TERRACE - PRIVATE TOTAL REQUIRED (309 UNITS X 6 m²) = 1,854 sq. m. REQUIRED COMMUNAL @ 50% = 927 sq. m. SITE COVERAGE BUILDING FOOTPRINT DRIVING SURFACE LANDSCAPE AREA TOTAL BUILDING A REFUGE REQUIREMENT (309 UNITS)	m <sup>2</sup> 172.6 1,095.4 202.1 1,470.1 3,506.2 4,976.3	4 7 ACE PARKING) 3 5 8 2.6m X 5.2m 2.6m X 5.2m 2.6m X 6.7m 2.4m X 4.6m 3.4m X 5.2m 2.4m X 5.2m 3.5m X 7.0m 155 155 309 0 309 30 30 30 30 30 30 30 30 30 30 30 30 30	2       2024-11-01       ISSUED FOR SITE PLAN APPROVAL       AYU         1       2024-01-30       ISSUED FOR PRE-CONSTRUCTION       AYU         #       DATE       DESCRIPTION       BY         INCONCECTION       AYU         #       DATE       DESCRIPTION       BY         INCONCECTION         PROJECT         PROJECT         DO COVENTRY ROAD, OTTAWA, ON.         DRAWING         FLOOR 01         PROJECT NO.         18.050 P01       PROJECT TATE         PROJECT TATE         2024-09-13         DRAWINBY       RYT / DRO         CHECKED BY         ASSOUT

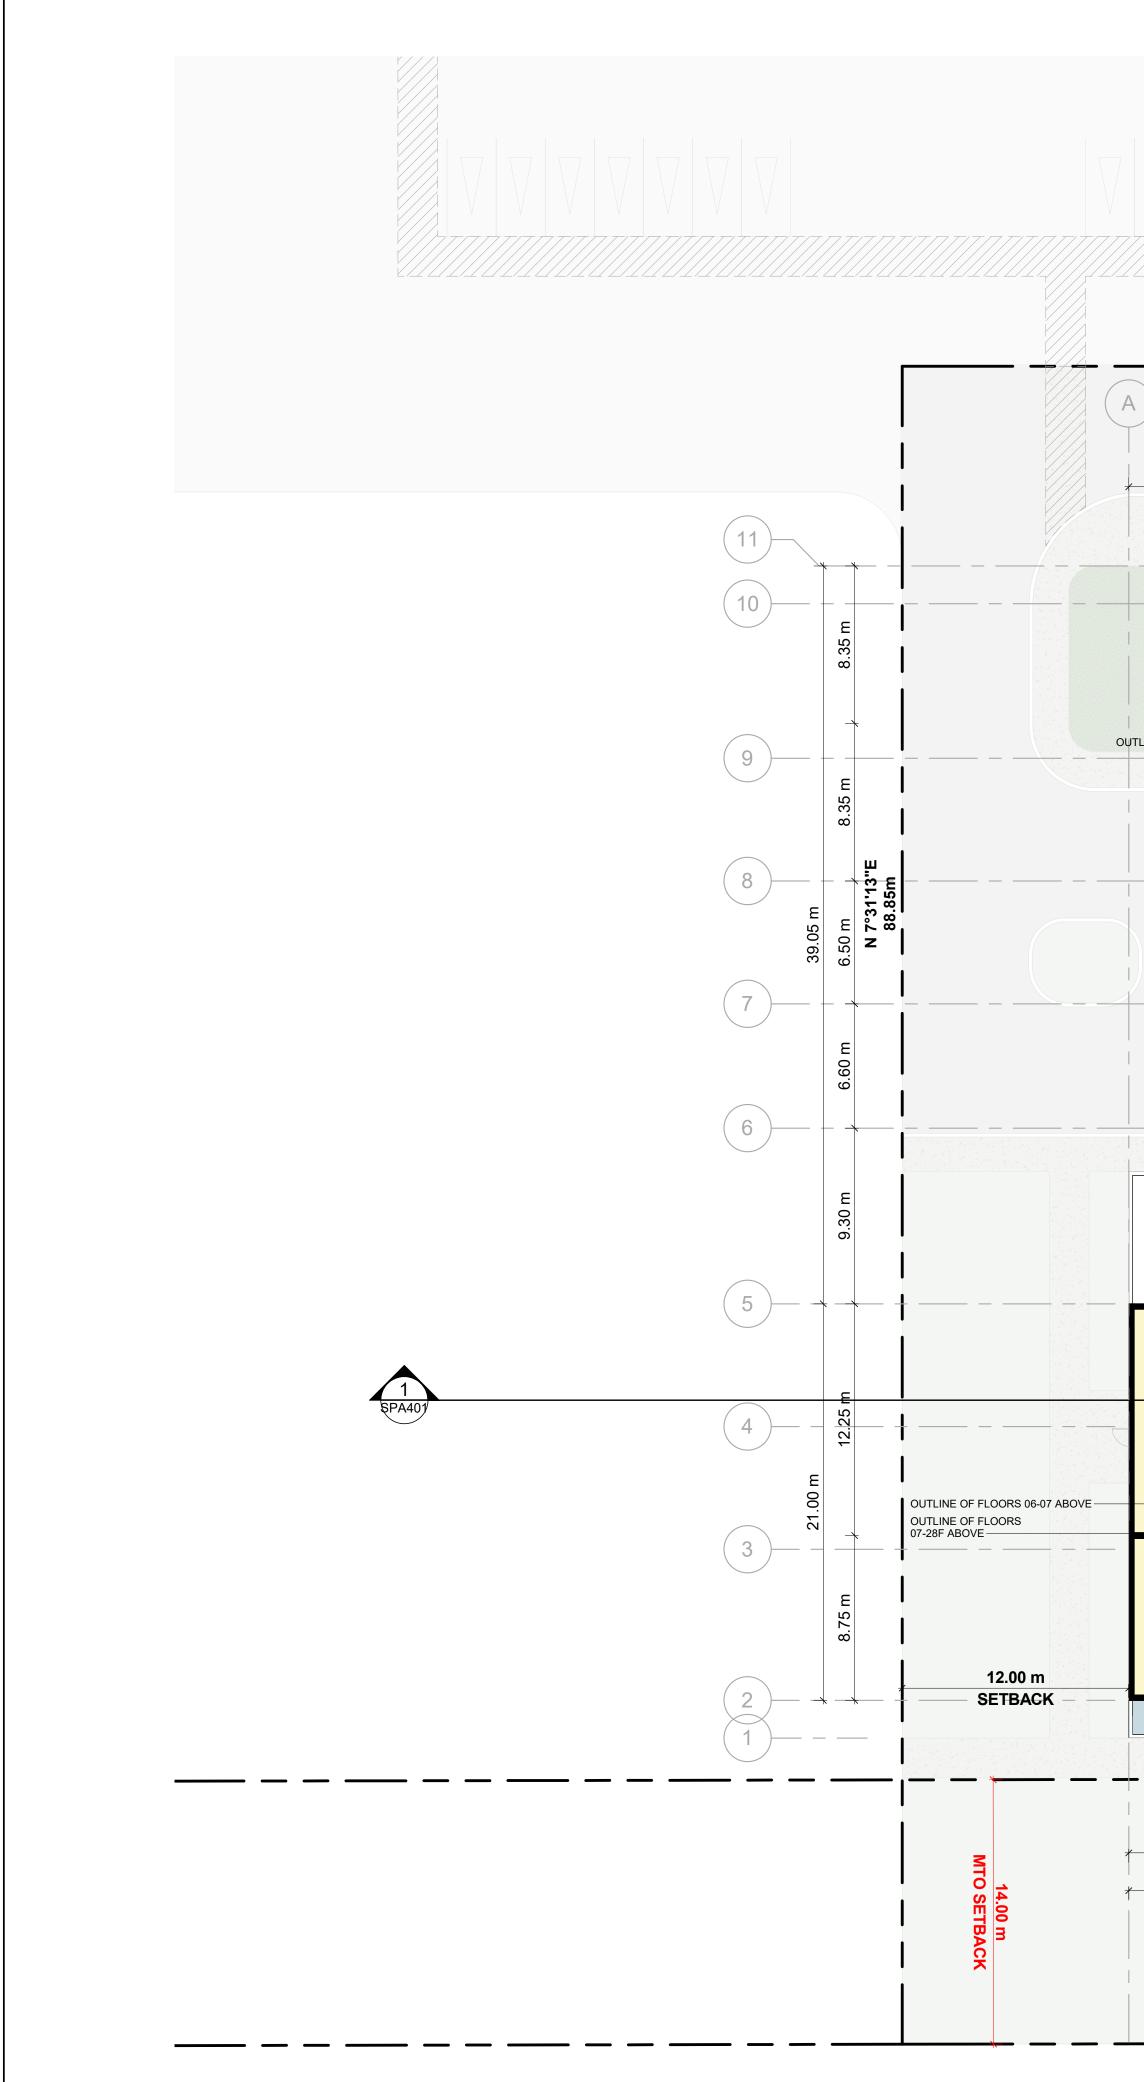

#### N 82°28'47"W 59.97m (C)В (D)( E ( F ЕŊ 10.55 I SETBA 10.45 m 25.00 m 12.25 m 10.75 m -2.10 m 2.00 m OUTLINE OF FLOOR 06 ABOVE + 4 -\_\_\_'\_\_ \_\_\_\_\_ 20 2B+D(BF) ± 90 m<sup>2</sup> ± 968 ft<sup>2</sup> **3B(BF)** ± 103.7 m<sup>2</sup> ± 1117 ft<sup>2</sup> 10 OUTLINE OF FLOOR 06 ABOVE 1B+D(BF) ± 66.5 m<sup>2</sup> ± 716 ft<sup>2</sup> 1B+D(BF) ± 67.8 m<sup>2</sup> ± 730 ft<sup>2</sup> ഗ –1.50 m **<u>1B</u>** ± 58.3 m<sup>2</sup> ± 628 ft<sup>2</sup> **1B+D** ± 63 m<sup>2</sup> ± 678 ft<sup>2</sup> 50 9 1B+D(BF) ± 63.8 m<sup>2</sup> ± 687 ft<sup>2</sup> 1B+D(BF) ± 67.1 m<sup>2</sup> ± 722 ft<sup>2</sup> Γī $\mathbf{\times}$ 02 PRIVACY SCRENS-00 2B+D(BF) ± 82.9 m<sup>2</sup> ± 892 ft<sup>2</sup> **1B+D** ± 64 m<sup>2</sup> ± 689 ft<sup>2</sup> E RÓOF .30 S S TERRACE F.F. 6.50 m **1B+D** ± 61.8 m<sup>2</sup> ± 666 ft<sup>2</sup> **3B(BF)** ± 100.5 m<sup>2</sup> ± 1082 ft<sup>2</sup> 2B+D(BF) ± 99.5 m<sup>2</sup> ± 1011 ft<sup>2</sup> €HUF 1B+D(BF) ± 64 m<sup>2</sup> ± 689 ft<sup>2</sup> 50 9 2B(BF) ± 76.2 m<sup>2</sup> ± 821 ft<sup>2</sup> 2B(BF) ± 70.1 m<sup>2</sup> ± 755 ft<sup>2</sup> 2B+D(BF) ± 88.3 m<sup>2</sup> ± 950 ft<sup>2</sup> **1B** ± 52.1 m<sup>2</sup> ± 561 ft<sup>2</sup> 8 12.50 m SETBACK TERRACE PRIVACY SCRENS 8 Ś 9.80 m 11.50 m 7.80 m 6.40 m **町**6 35.45 m .10 m "BACK

N 83°33'50"E 182.85m














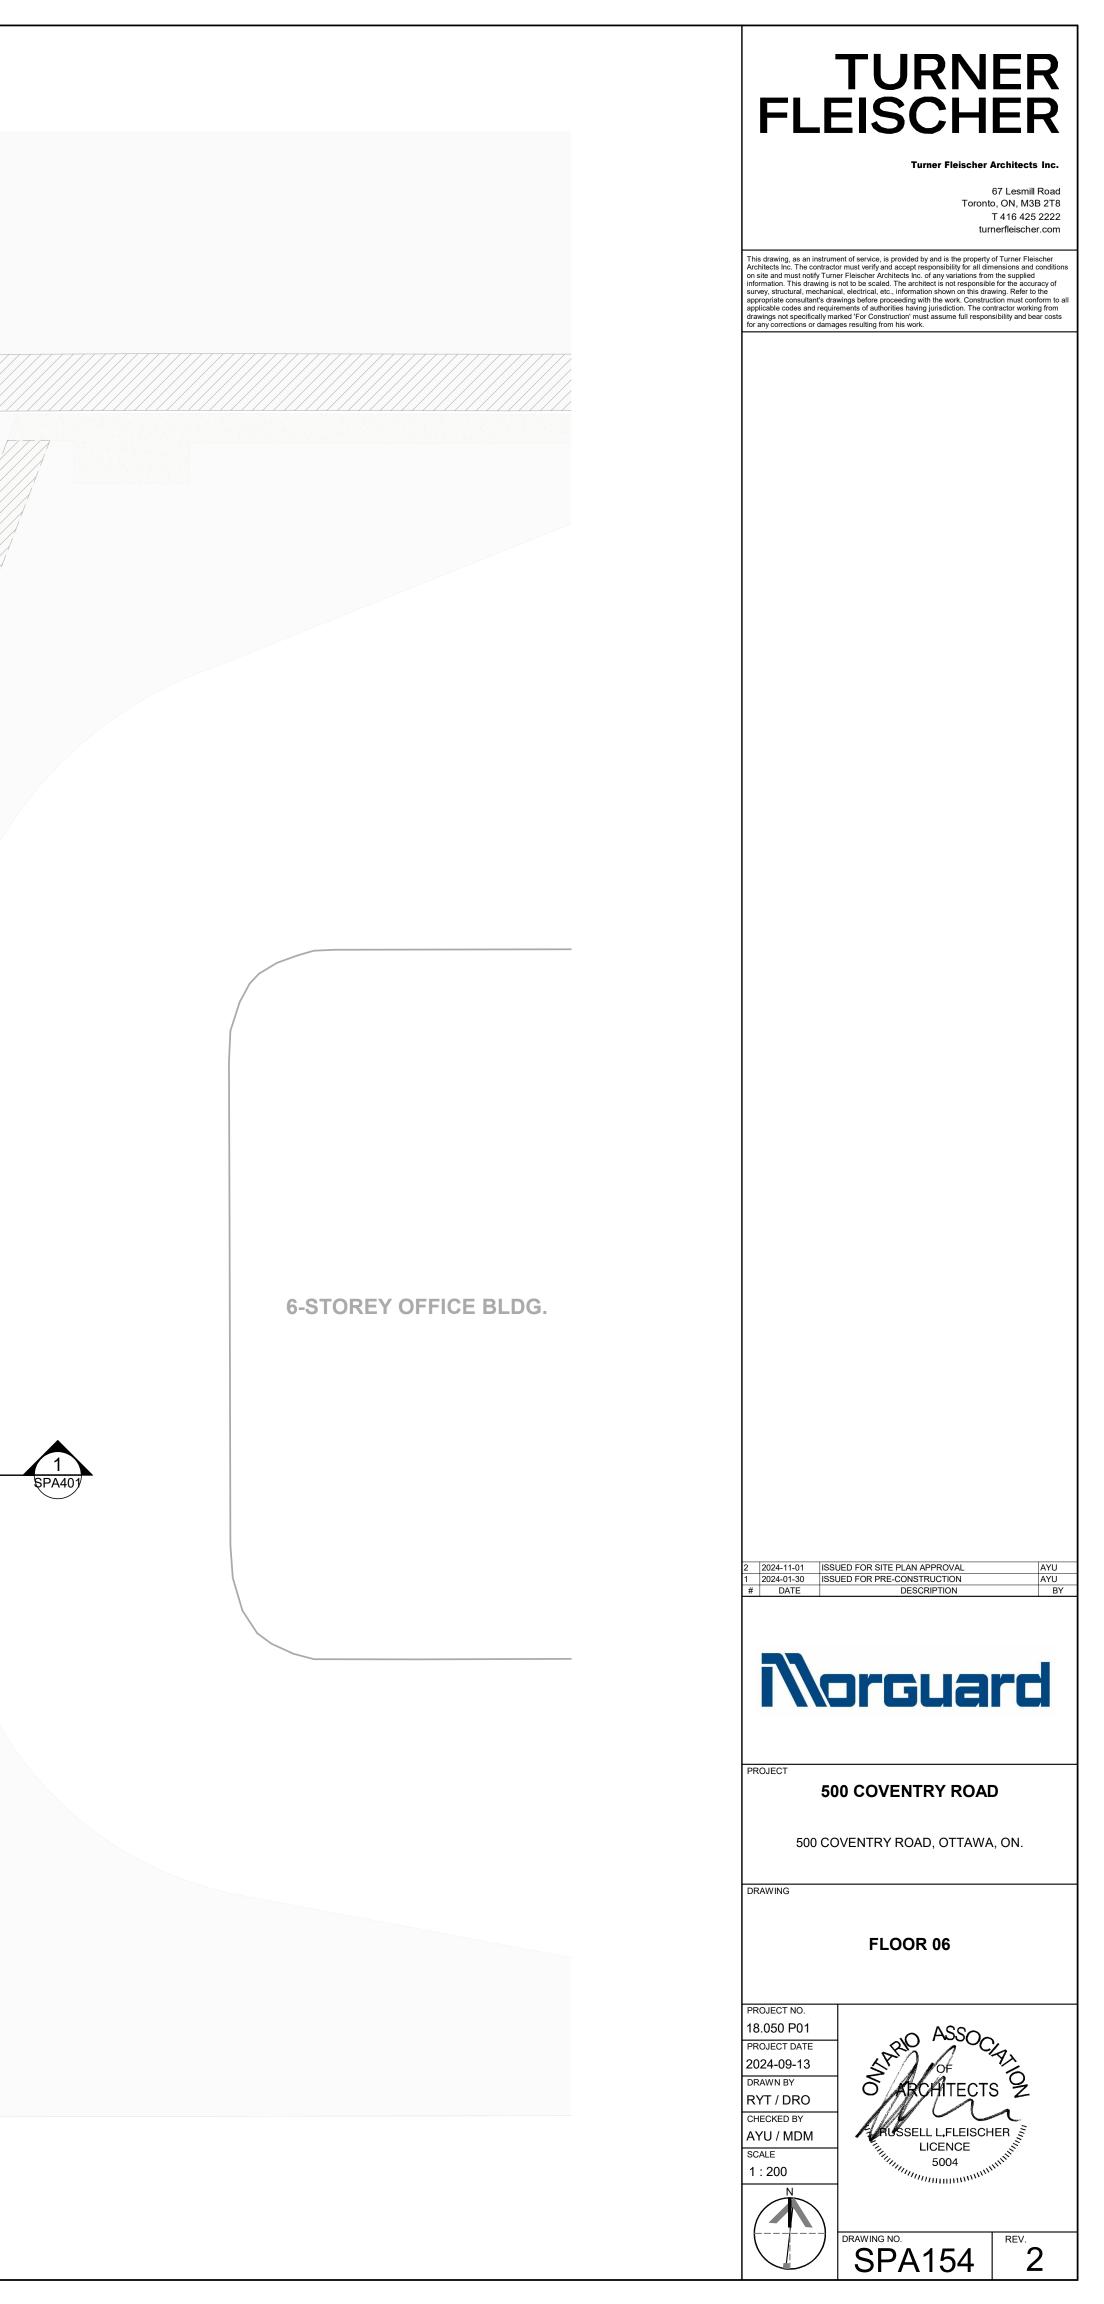


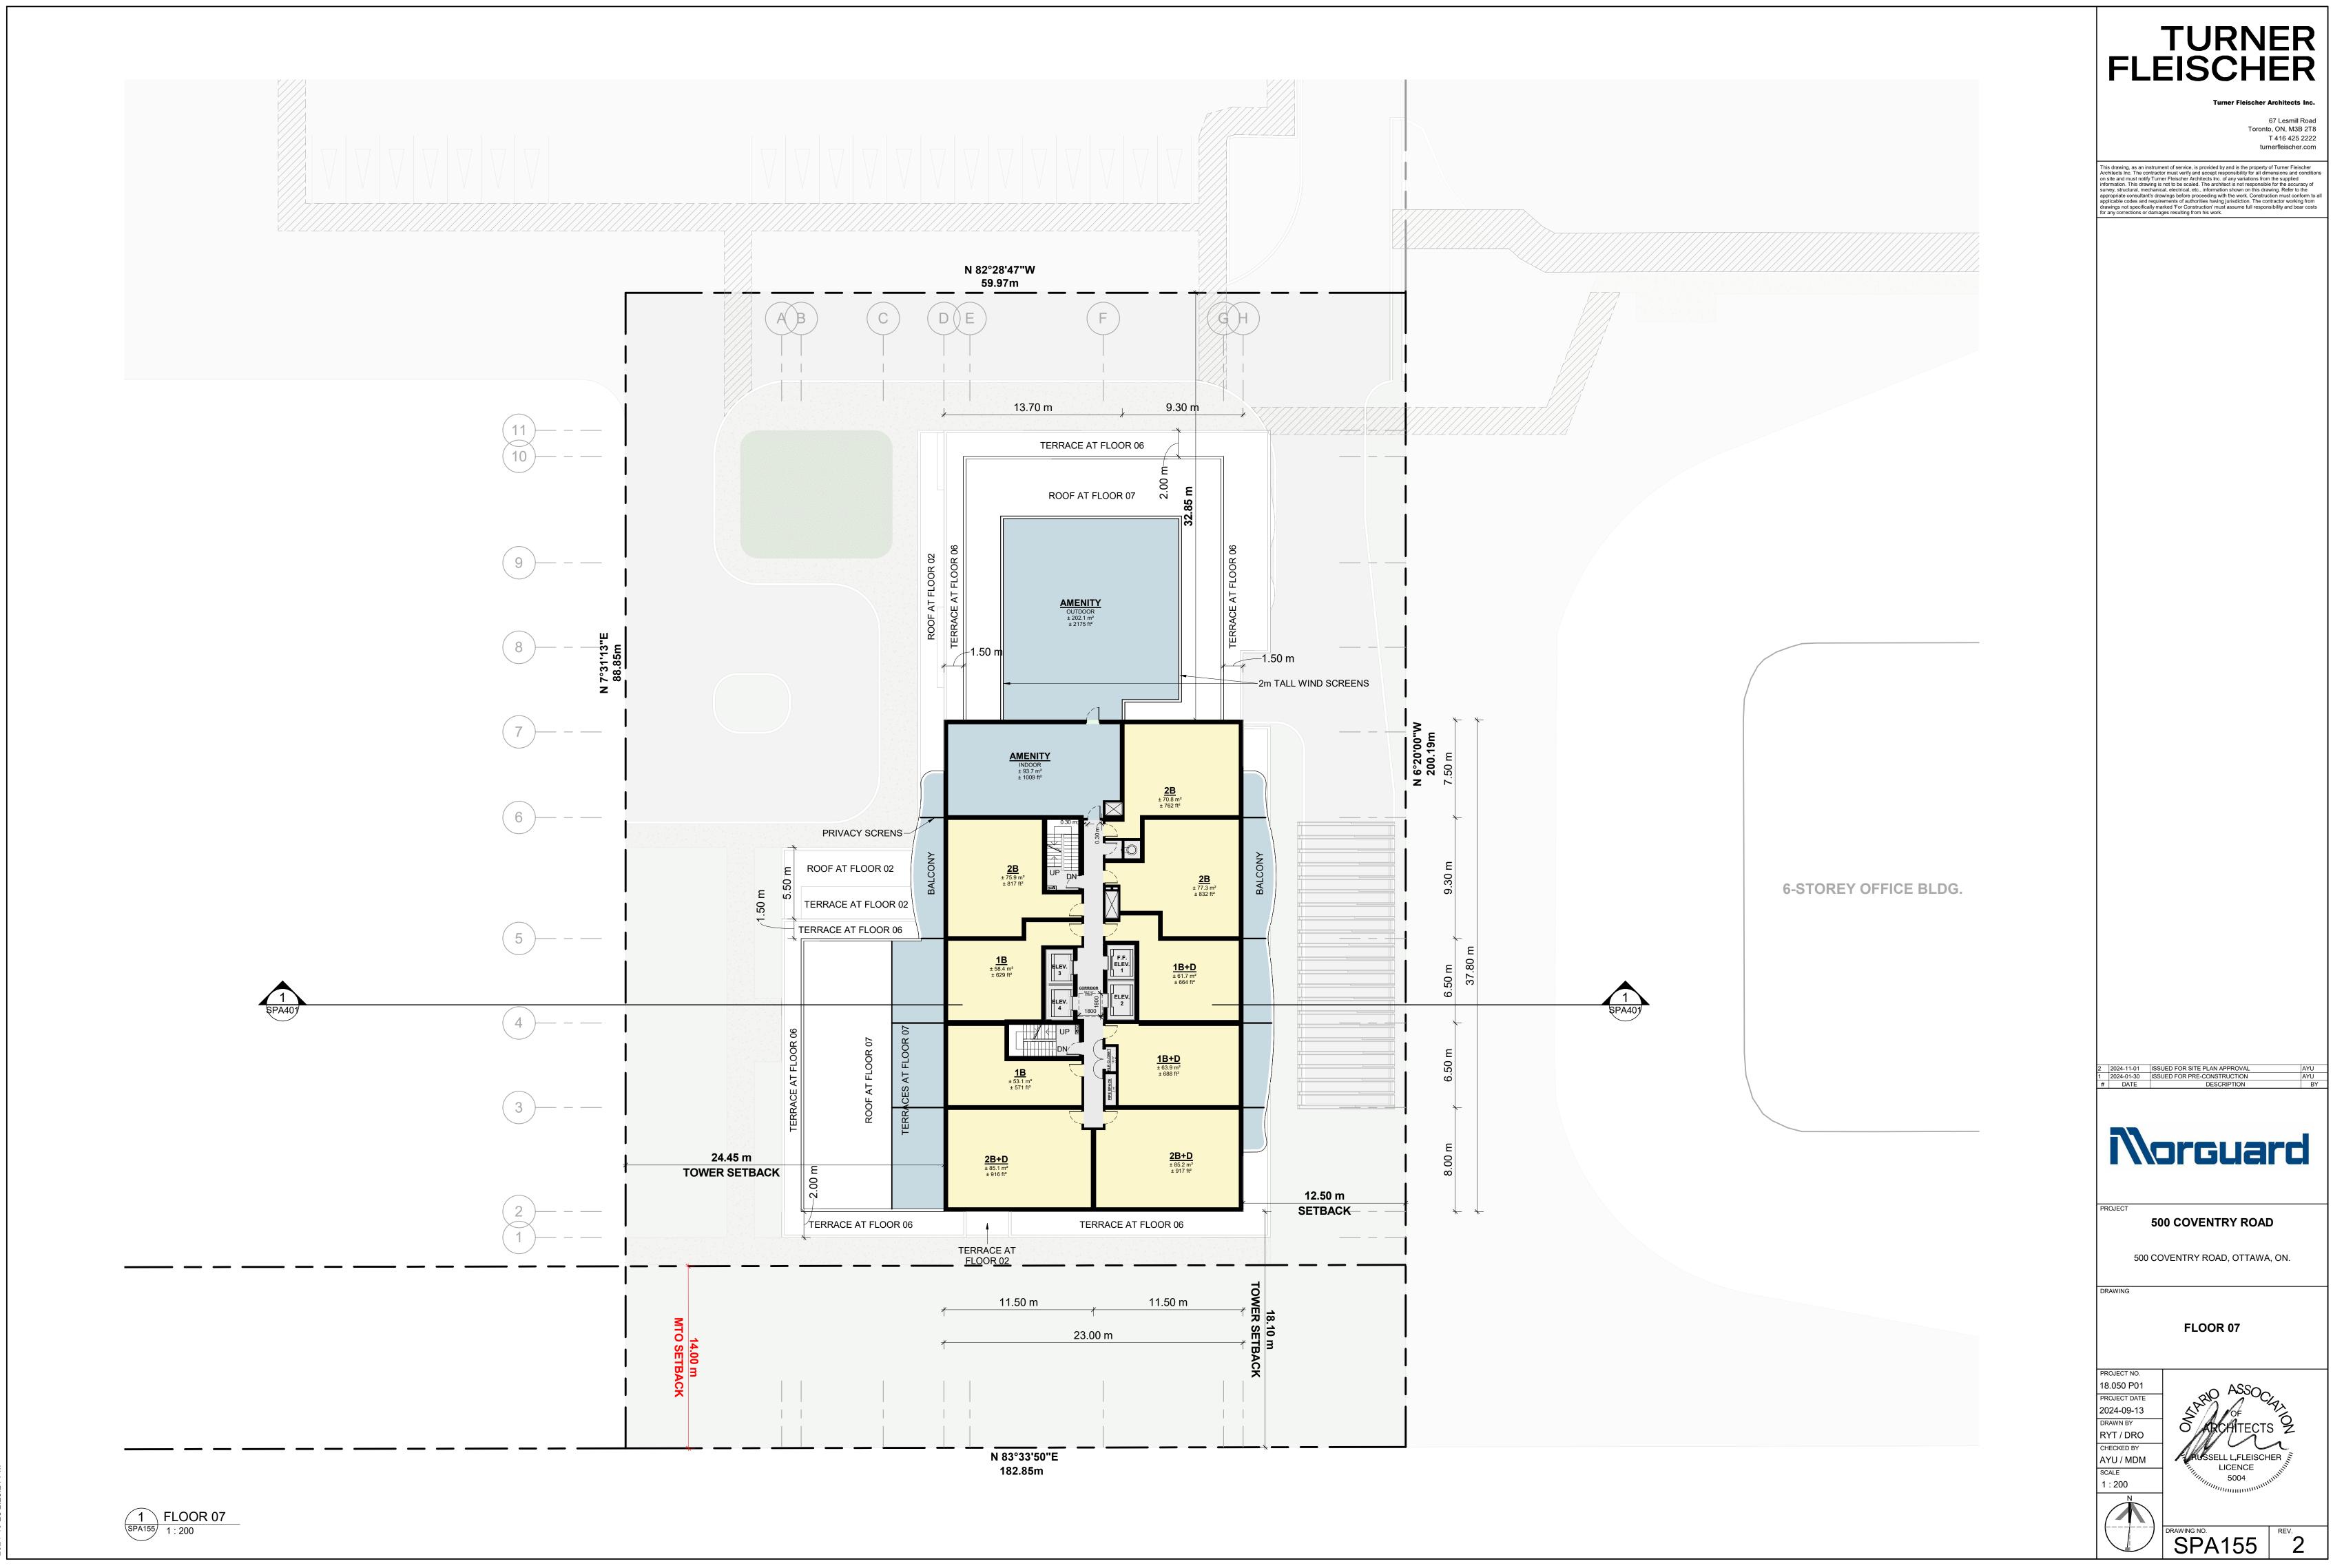



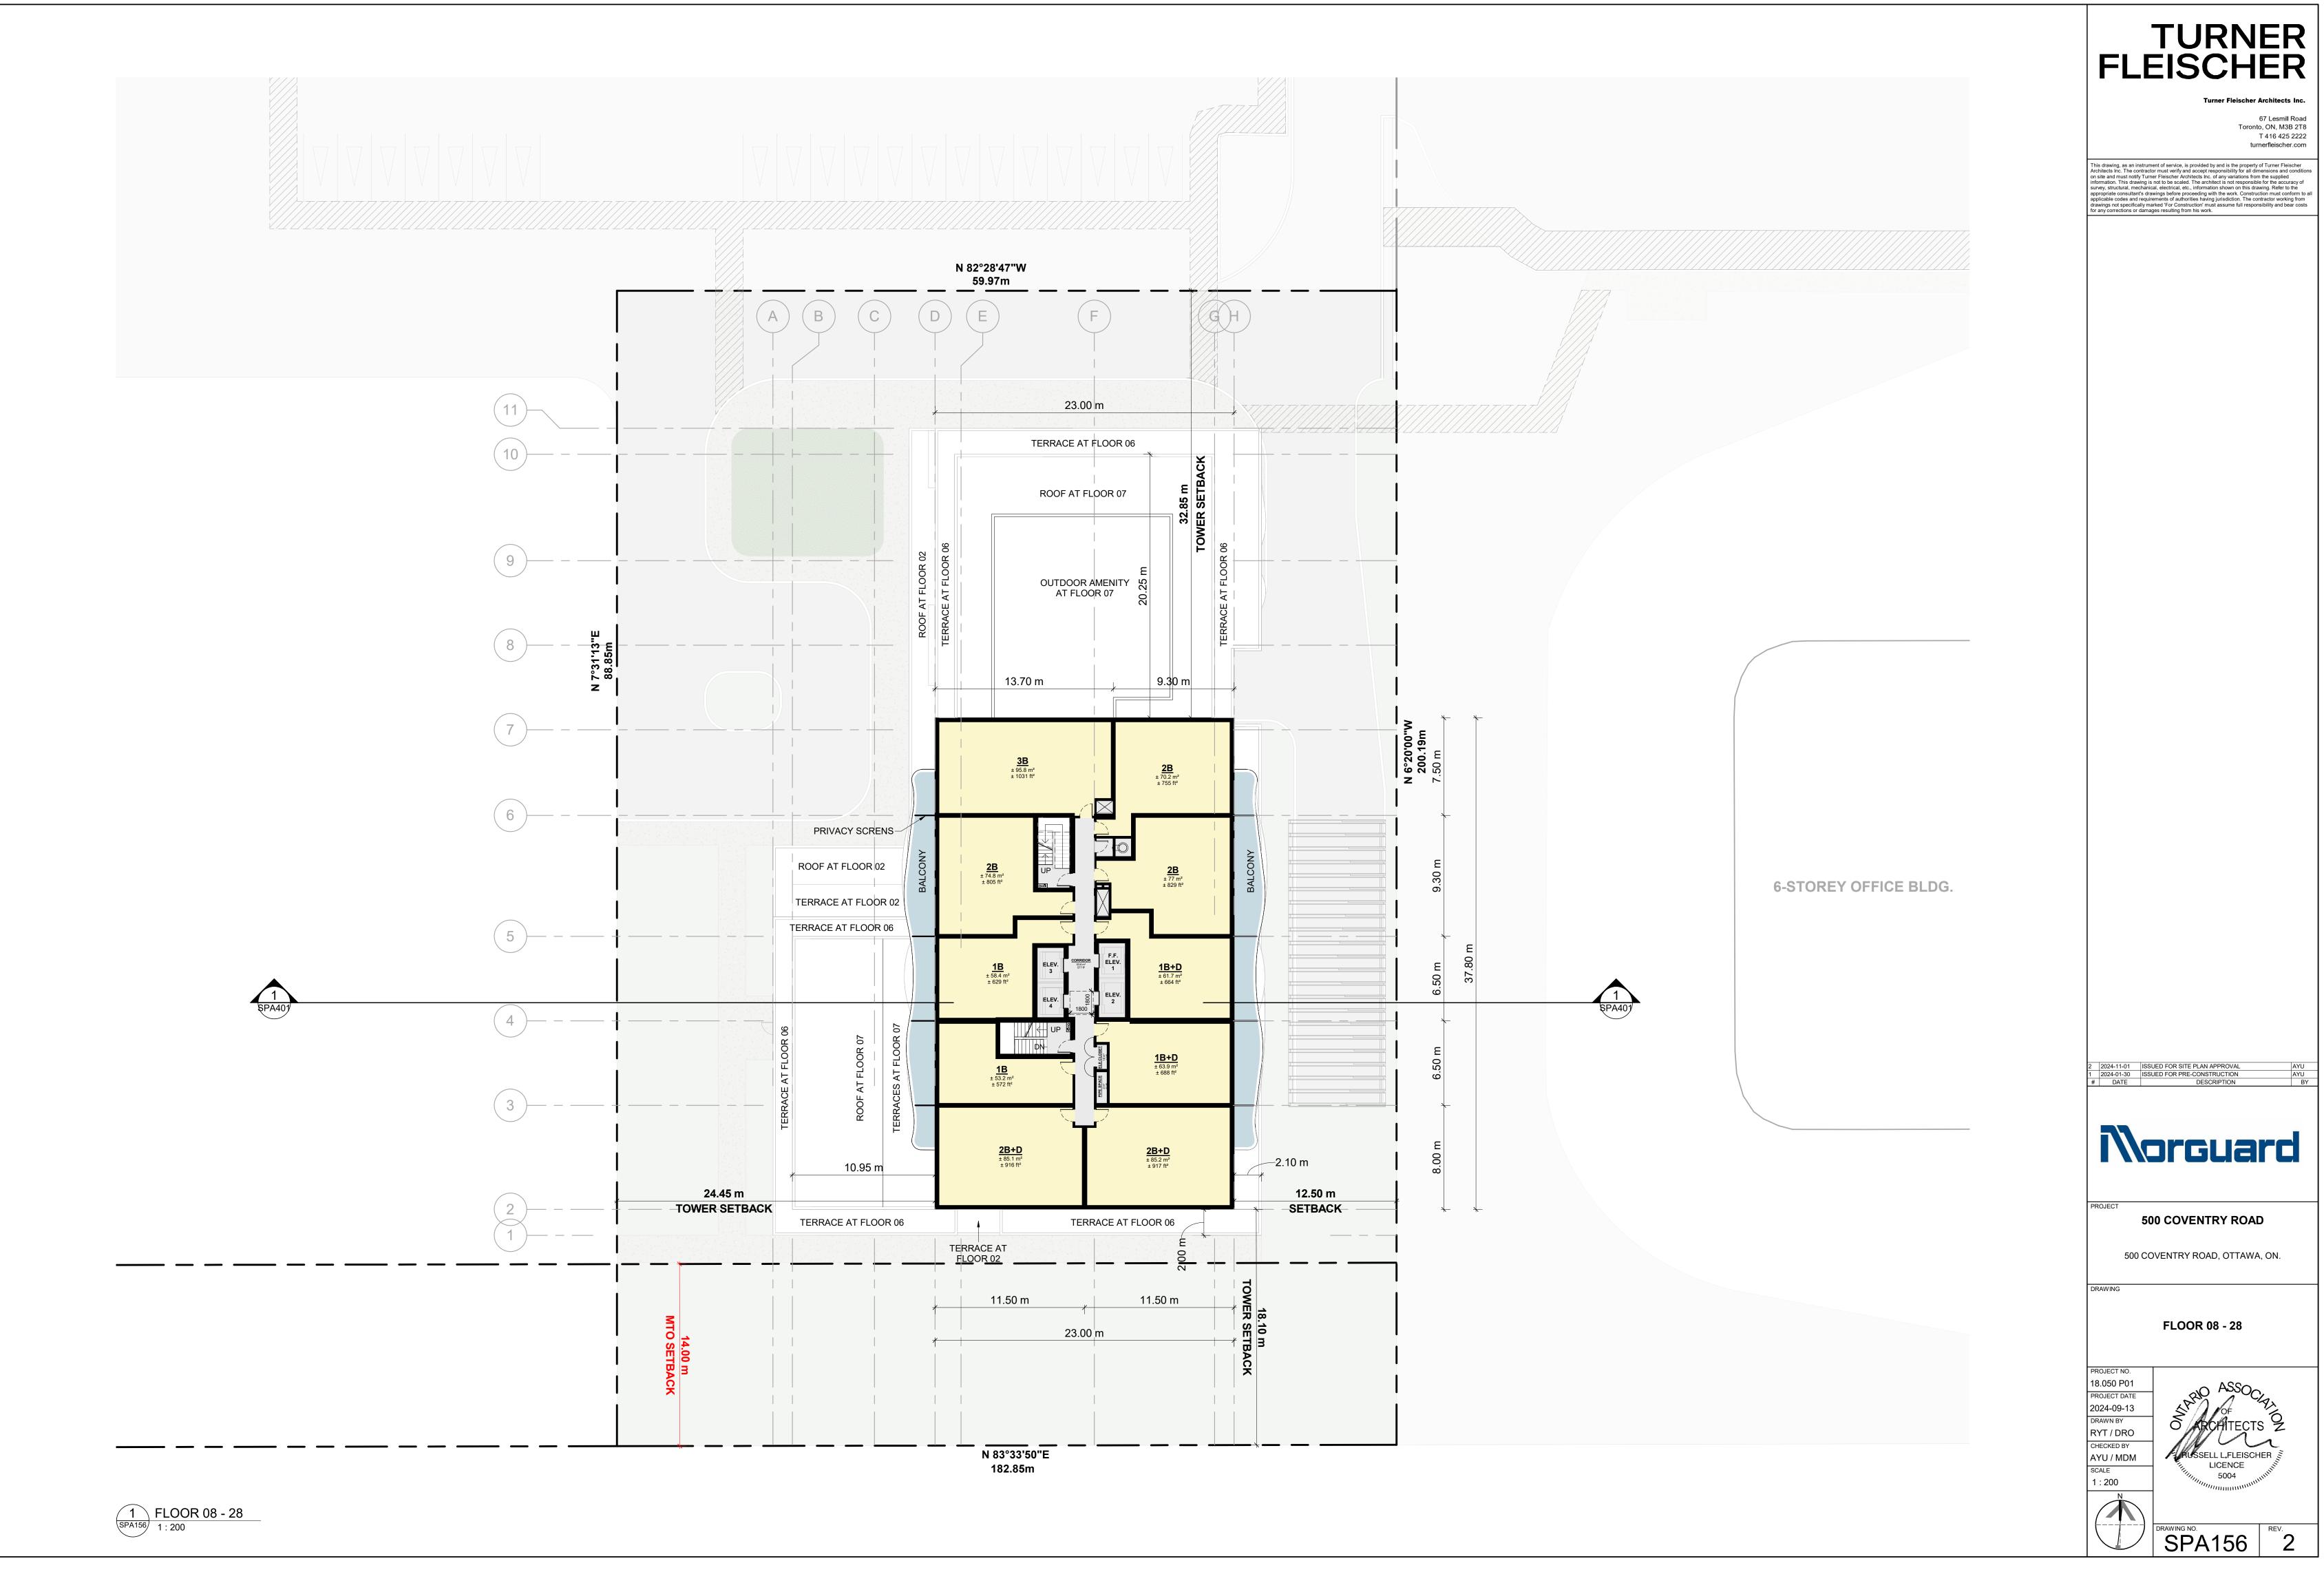



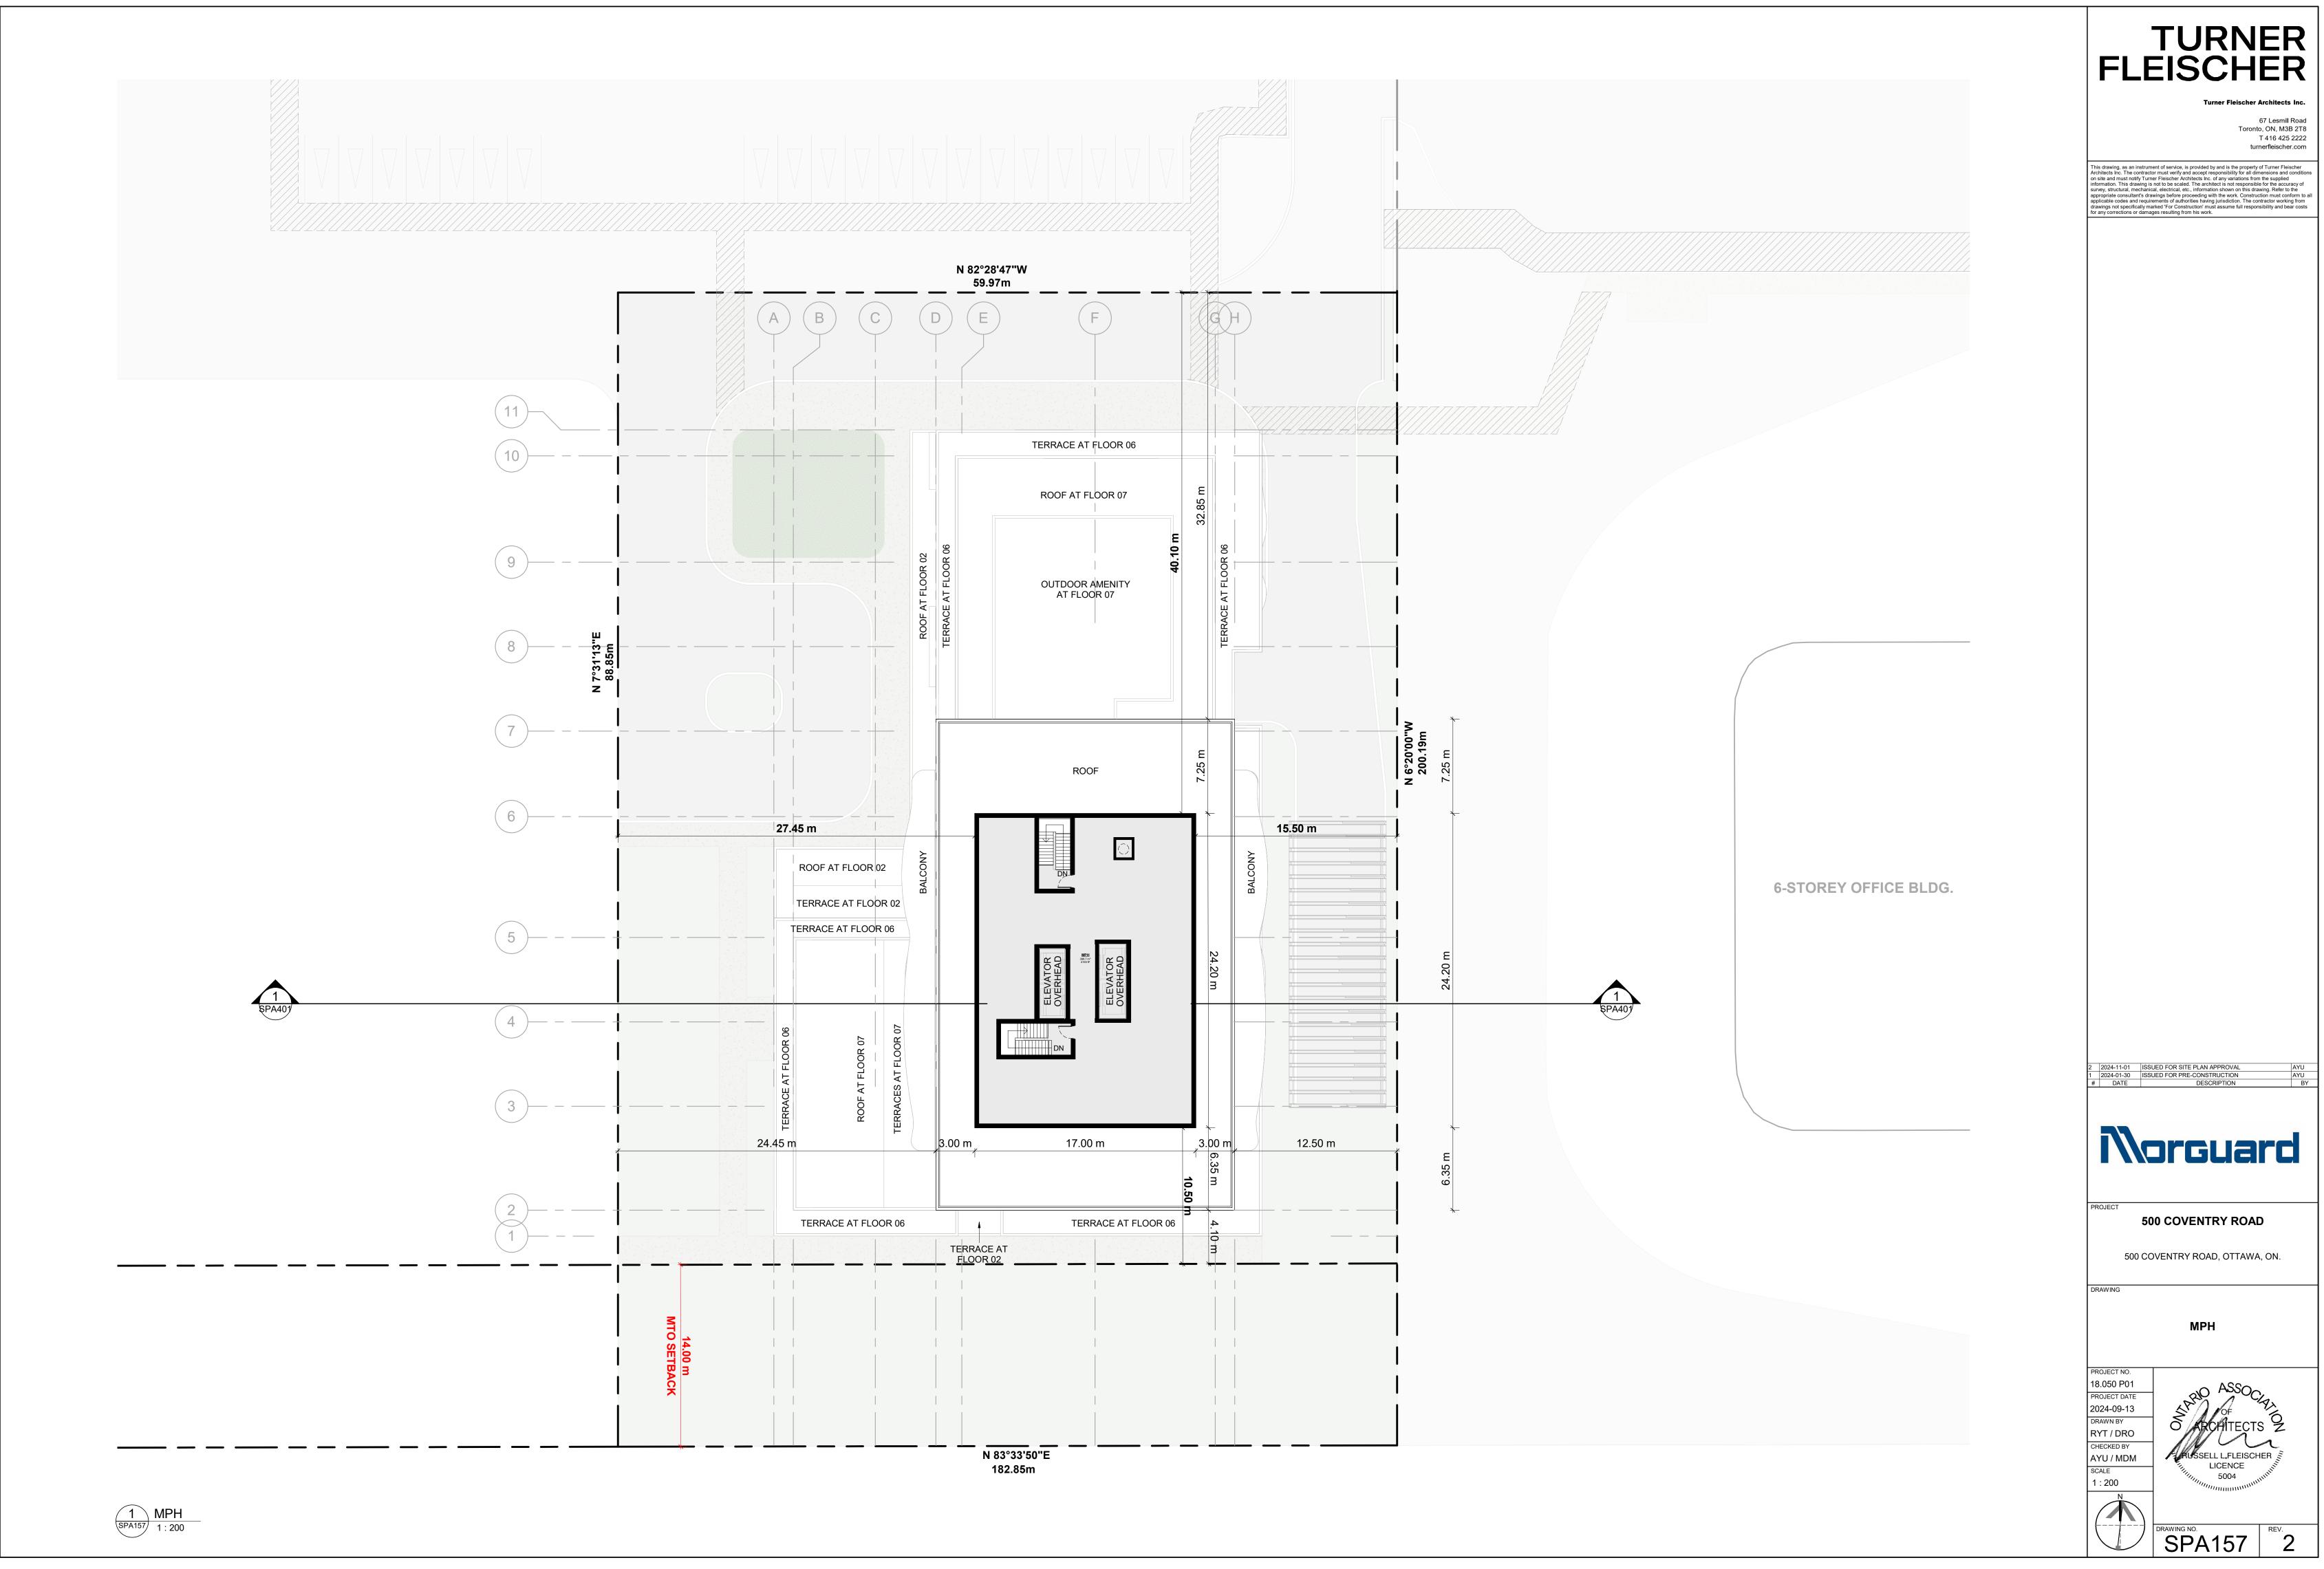






## **BLDG A**



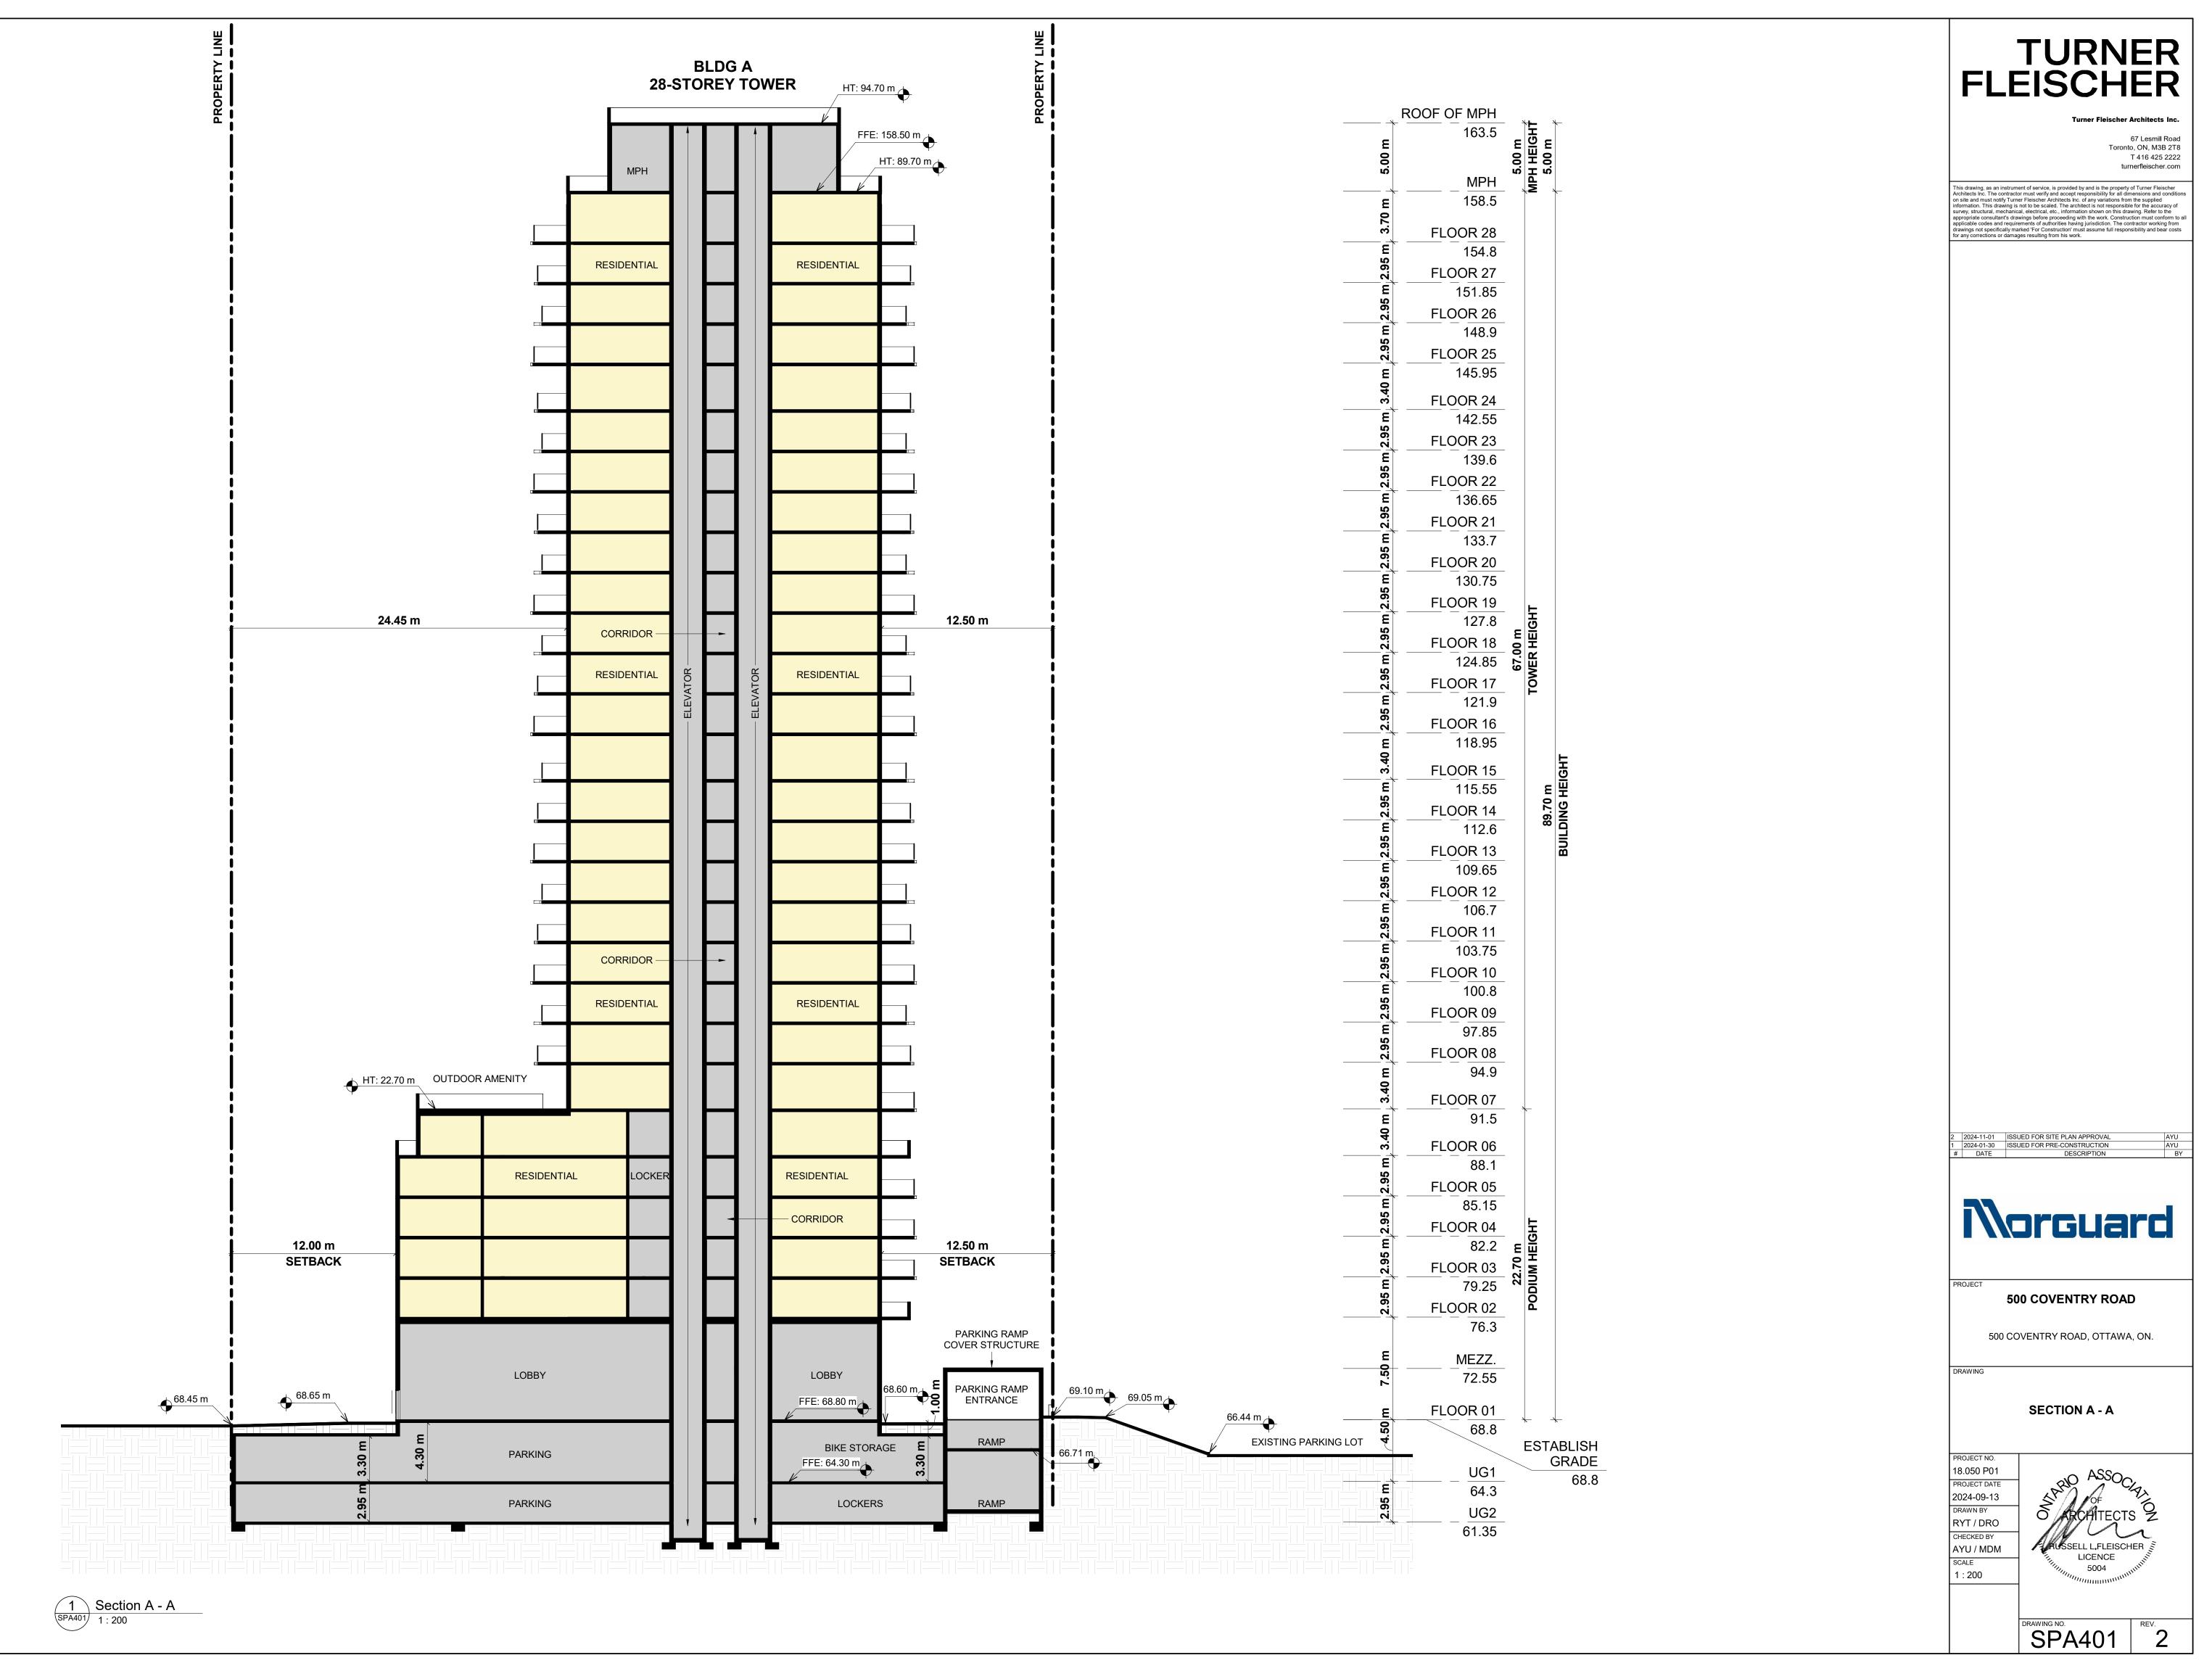



VIEW FROM TRANS-CANADA HWY LOOKING NORTH WEST



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 1
 2024-11-01
 ISSUED FOR SITE PLAN APPROVAL

 #
 DATE
 DESCRIPTION

## 500 COVENTRY ROAD

500 COVENTRY ROAD, OTTAWA, ON.

RAWING

#### **3D PERSPECTIVES**

PROJECT NO. 18.050 P01 PROJECT DATE 2024-09-13 DRAWN BY EHS CHECKED BY AYU SCALE



DRAWING NO. SPA801

T REV.



VIEW FROM TRANS-CANADA HWY LOOKING NORTH EAST



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 2024-11-01
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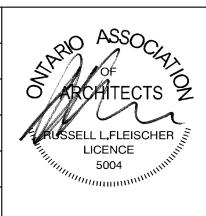
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 DATE
 DESCRIPTION

#### 500 COVENTRY ROAD

500 COVENTRY ROAD, OTTAWA, ON.

#### **3D PERSPECTIVES**

PROJECT NO. 18.050 P01 PROJECT DATE 2024-09-13 DRAWN B EHS CHECKED BY SCALE



DRAWING NO. SPA802



VIEW FROM TRANS-CANADA HWY LOOKING NORTH



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1 2024-11-01 ISSUED FOR SITE PLAN APPROVAL # DATE DESCRIPTION


#### 500 COVENTRY ROAD

500 COVENTRY ROAD, OTTAWA, ON.

RAWING

#### **3D PERSPECTIVE**

PROJECT NO. 18.050 P01 PROJECT DATE 2024-09-13 DRAWN BY EHS CHECKED BY AYU SCALE

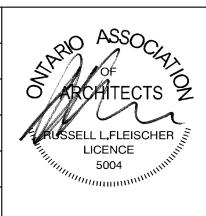

DRAWING NO. SPA803



VIEW LOOKING SOUTH WEST FROM EXISTING BUS STOP



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 2024-11-01
 ISSUED FOR SITE PLAN APPROVAL

 #
 DATE
 DESCRIPTION


## 500 COVENTRY ROAD

500 COVENTRY ROAD, OTTAWA, ON.

RAWING

#### **3D PERSPECTIVES**

PROJECT NO. 18.050 P01 PROJECT DATE 2024-09-13 DRAWN BY EHS CHECKED BY AYU SCALE

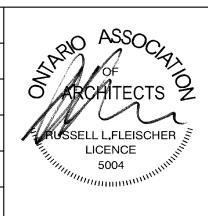


DRAWING NO. SPA804

T REV.



**VIEW LOOKING EAST FROM PHASE 2** 

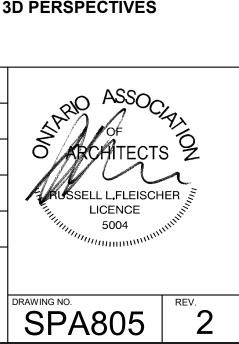


2024-09-13 DRAWN BY EHS CHECKED BY

SCALE



VIEW LOOKING WEST FROM EXISTING 6-STOREY OFFICE BUILDING

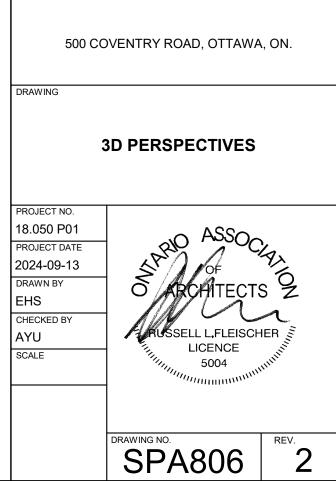

 2
 2024-11-01
 ISSUED FOR SITE PLAN APPROVAL

 1
 2024-01-30
 ISSUED FOR PRE-CONSTRUCTION

 #
 DATE
 DESCRIPTION

500 COVENTRY ROAD







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VIEW LOOKING TOWARDS MAIN ENTRANCE AND DROP-OFF AREA



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 2024-11-01
 ISSUED FOR SITE PLAN APPROVAL

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 DATE
 DESCRIPTION


## 500 COVENTRY ROAD

500 COVENTRY ROAD, OTTAWA, ON.

RAWING

#### **3D PERSPECTIVES**

PROJECT NO. 18.050 P01 PROJECT DATE 2024-09-13 DRAWN BY EHS CHECKED BY AYU SCALE

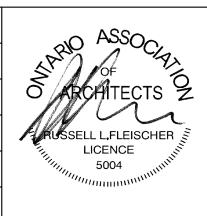

DRAWING NO. REV.



VIEW FROM TRANS-CANADA HWY LOOKING NORTH EAST



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 2024-11-01
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 DATE
 DESCRIPTION


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500 COVENTRY ROAD, OTTAWA, ON.

RAWING

#### **3D PERSPECTIVES**

PROJECT NO. 18.050 P01 PROJECT DATE 2024-09-13 DRAWN BY EHS CHECKED BY AYU SCALE

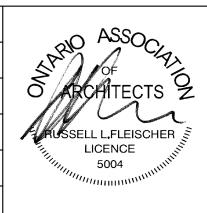

DRAWING NO. SPA808



VIEW LOOKING SOUTH WEST TOWARDS THE PARKING RAMP COVER STRUCTURE



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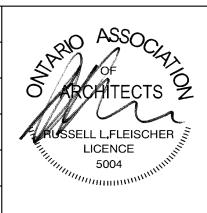
#### 500 COVENTRY ROAD

500 COVENTRY ROAD, OTTAWA, ON.

DRAWING

#### **3D PERSPECTIVES - PARKING RAMP**

PROJECT NO. 18.050 P01 PROJECT DATE 2024-09-13 DRAWN BY EHS CHECKED BY AYU SCALE



DRAWING NO. SPA809

T REV.



VIEW LOOKING WEST TOWARDS THE PARKING RAMP COVER STRUCTURE



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 ISSUED FOR SITE PLAN APPROVAL

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 DATE
 DESCRIPTION

#### 500 COVENTRY ROAD


500 COVENTRY ROAD, OTTAWA, ON.

DRAWING

PROJECT

#### **3D PERSPECTIVES - PARKING RAMP**

PROJECT NO. 18.050 P01 PROJECT DATE 2024-09-13 DRAWN BY EHS CHECKED BY AYU SCALE

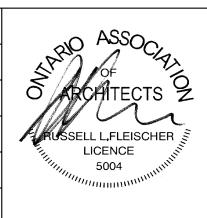



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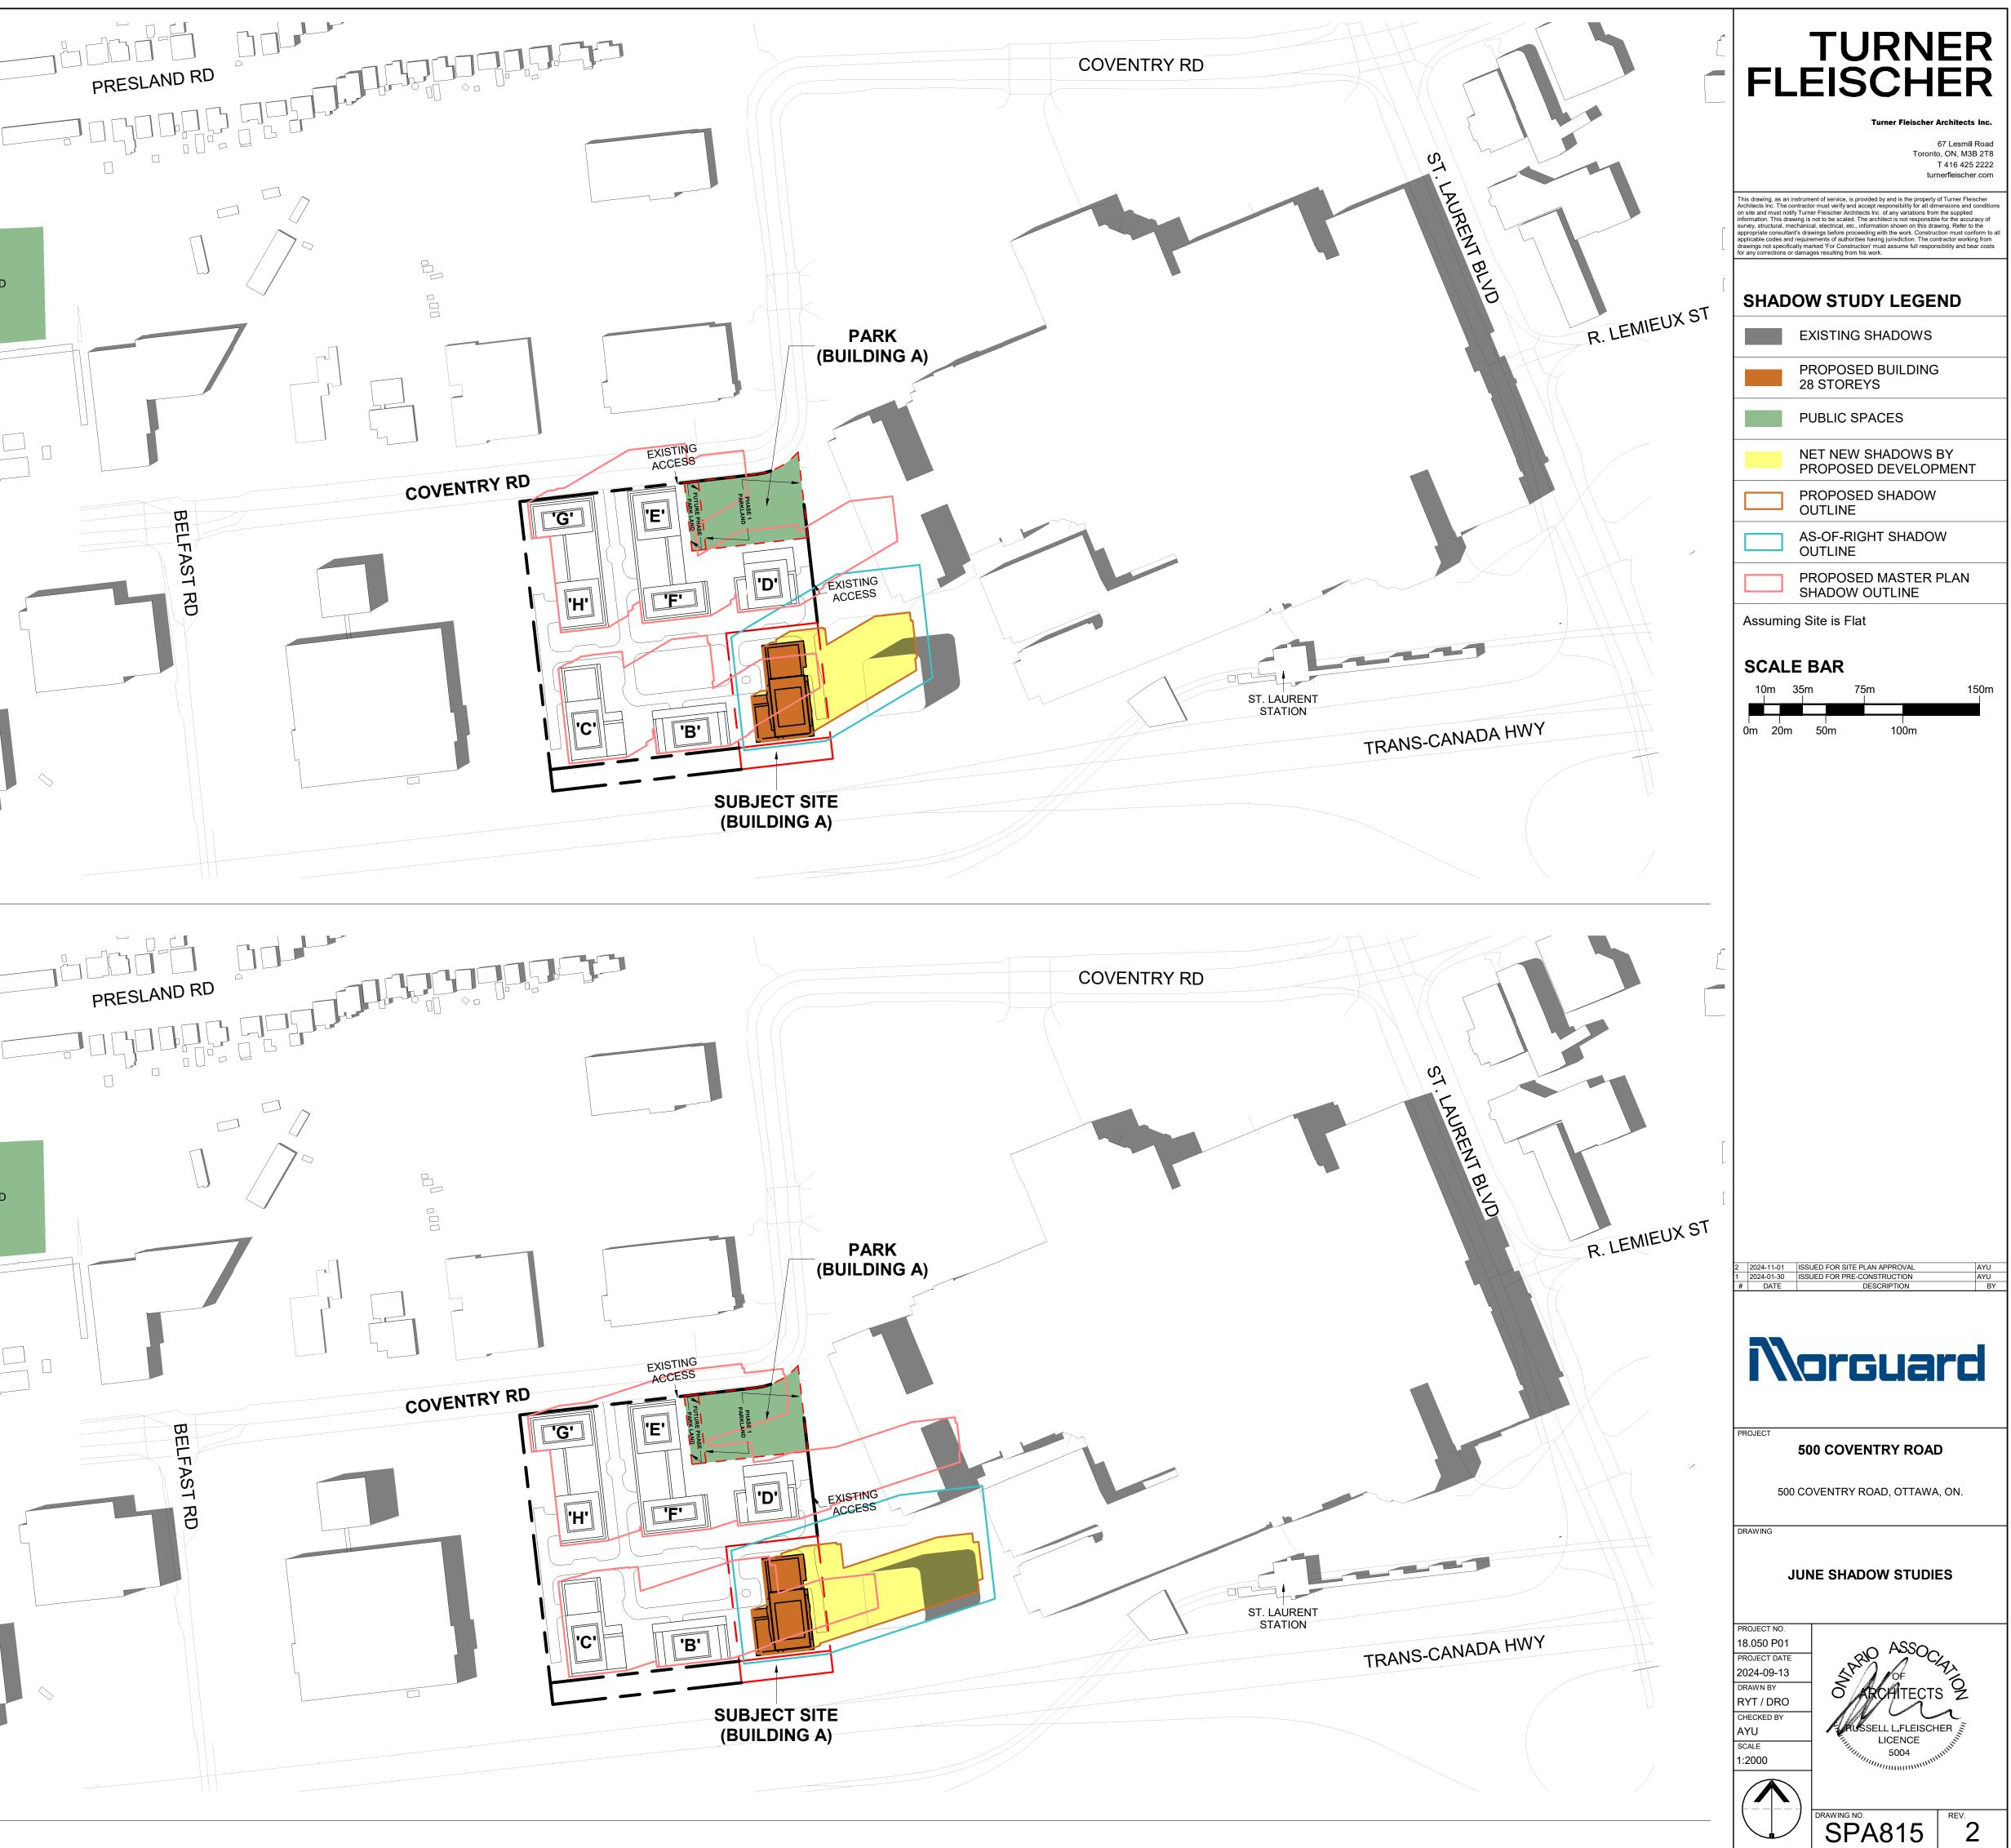








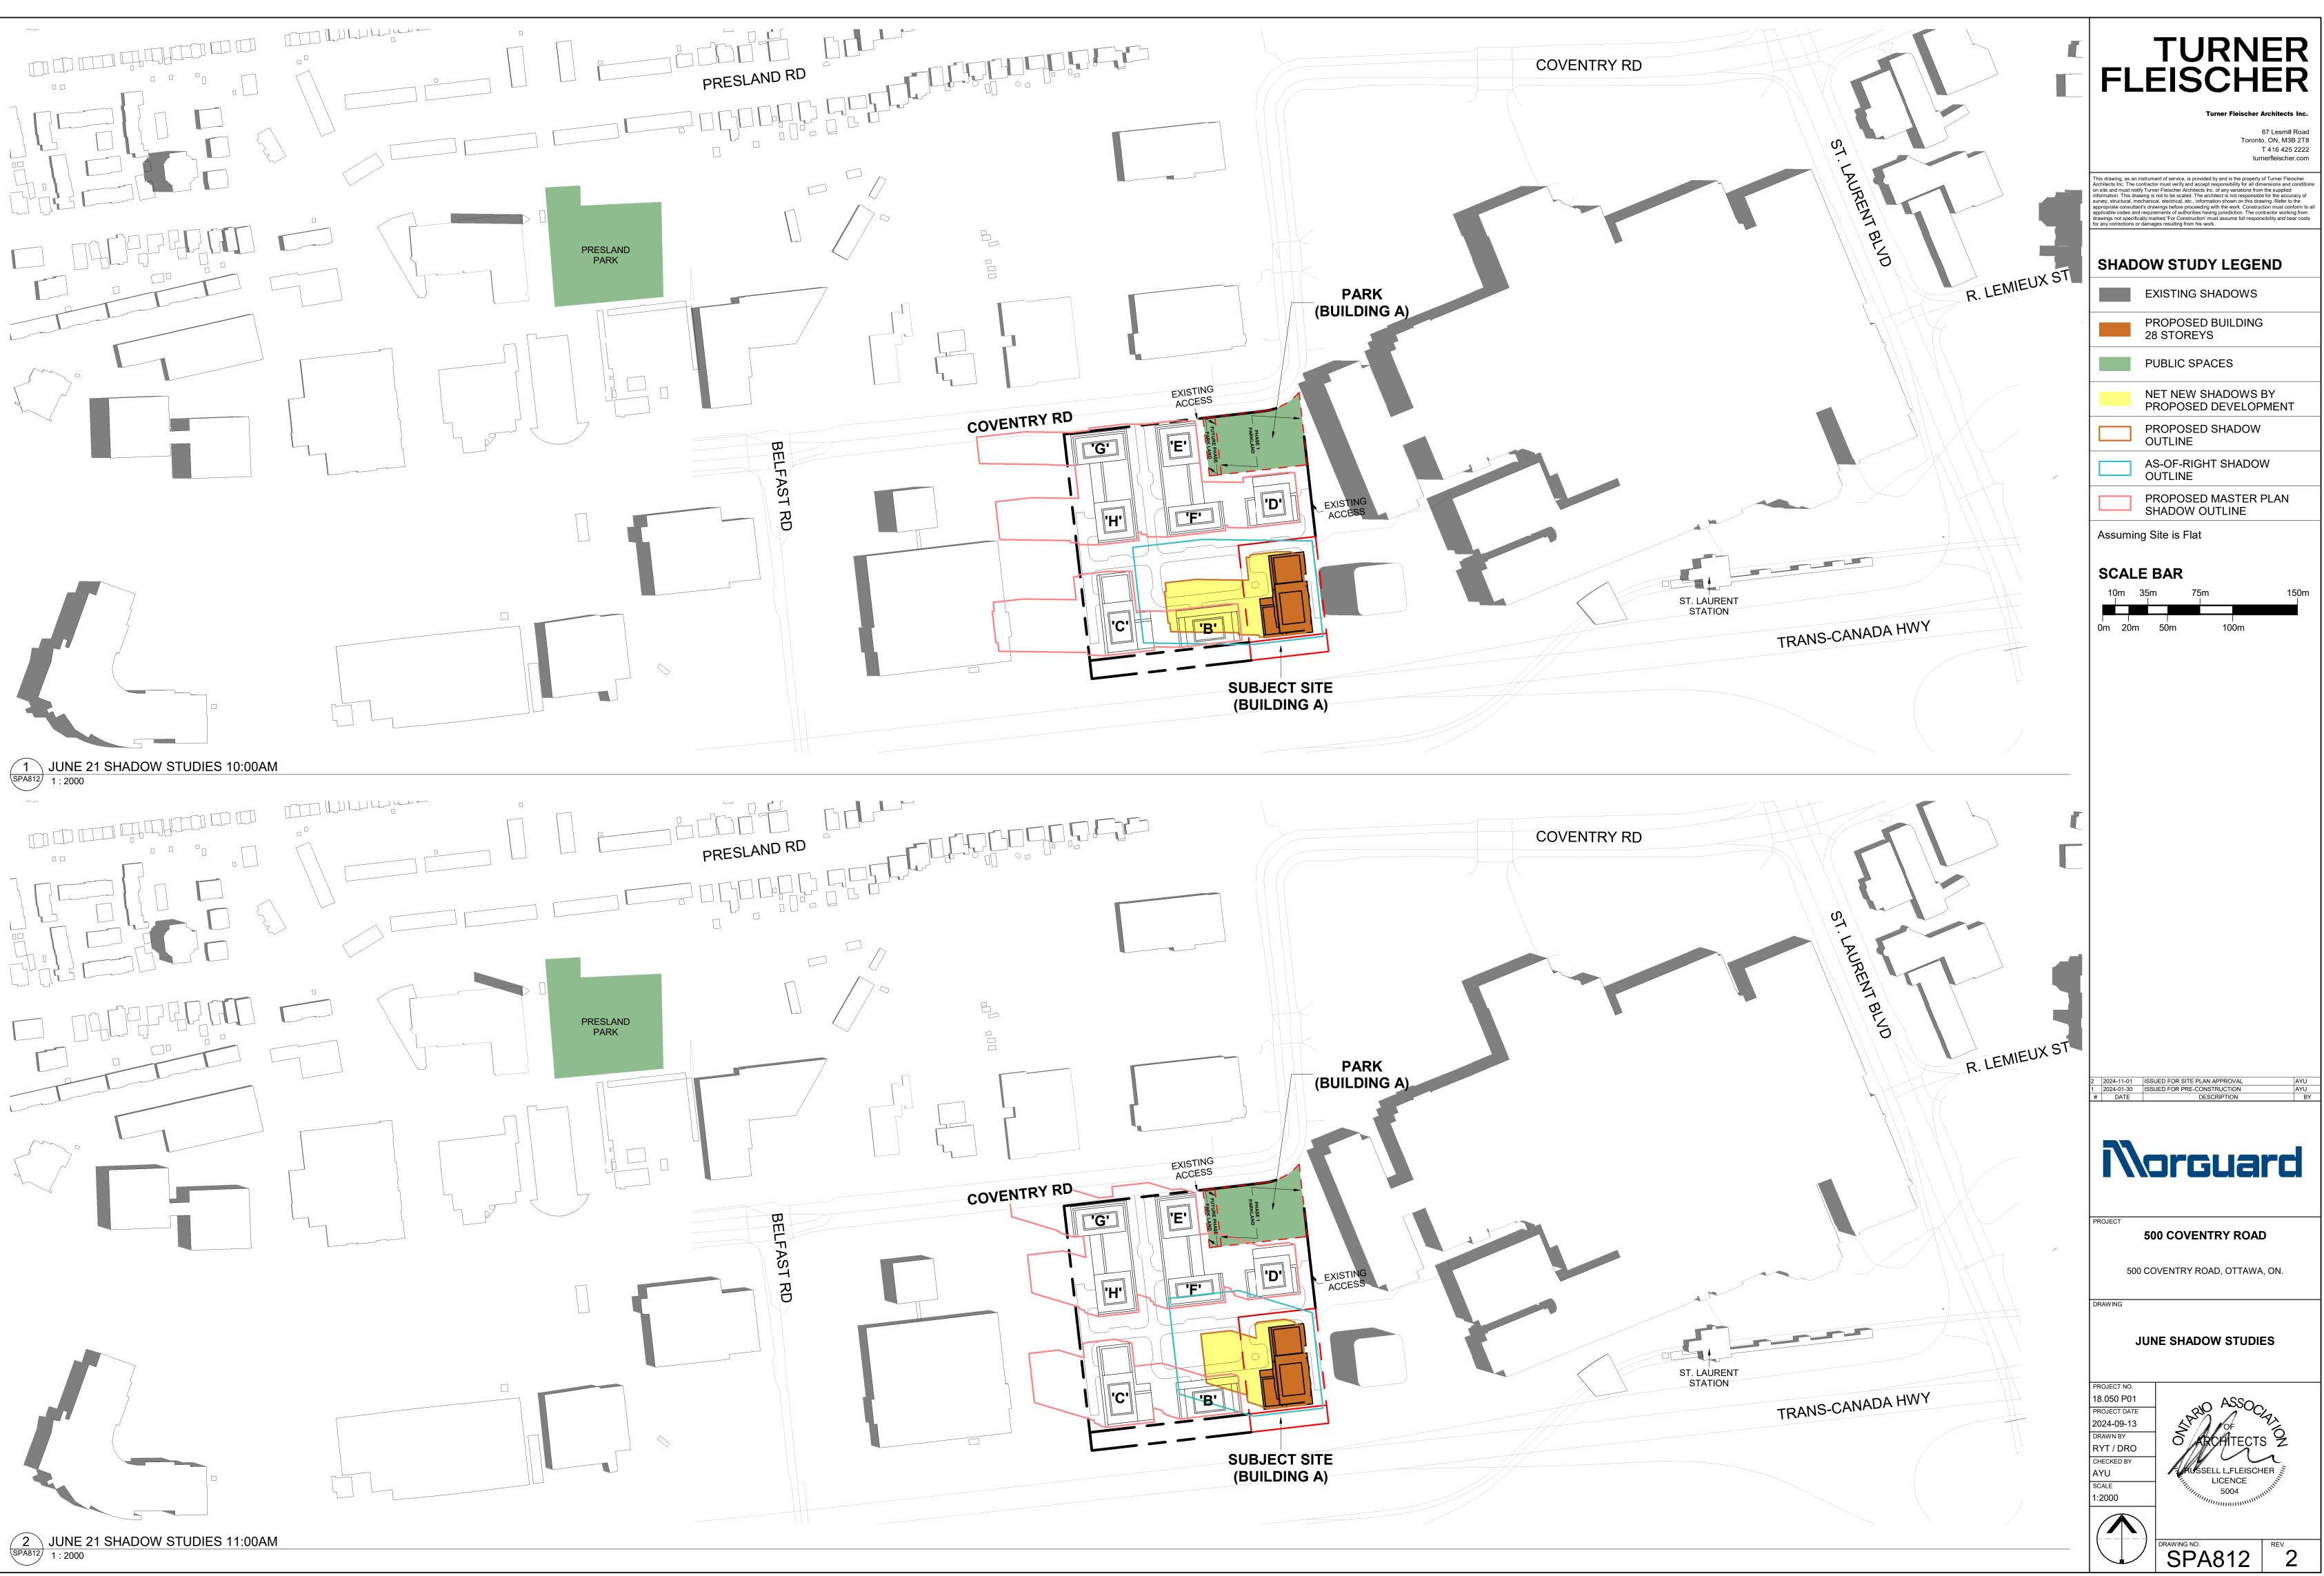


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#### 500 COVENTRY ROAD

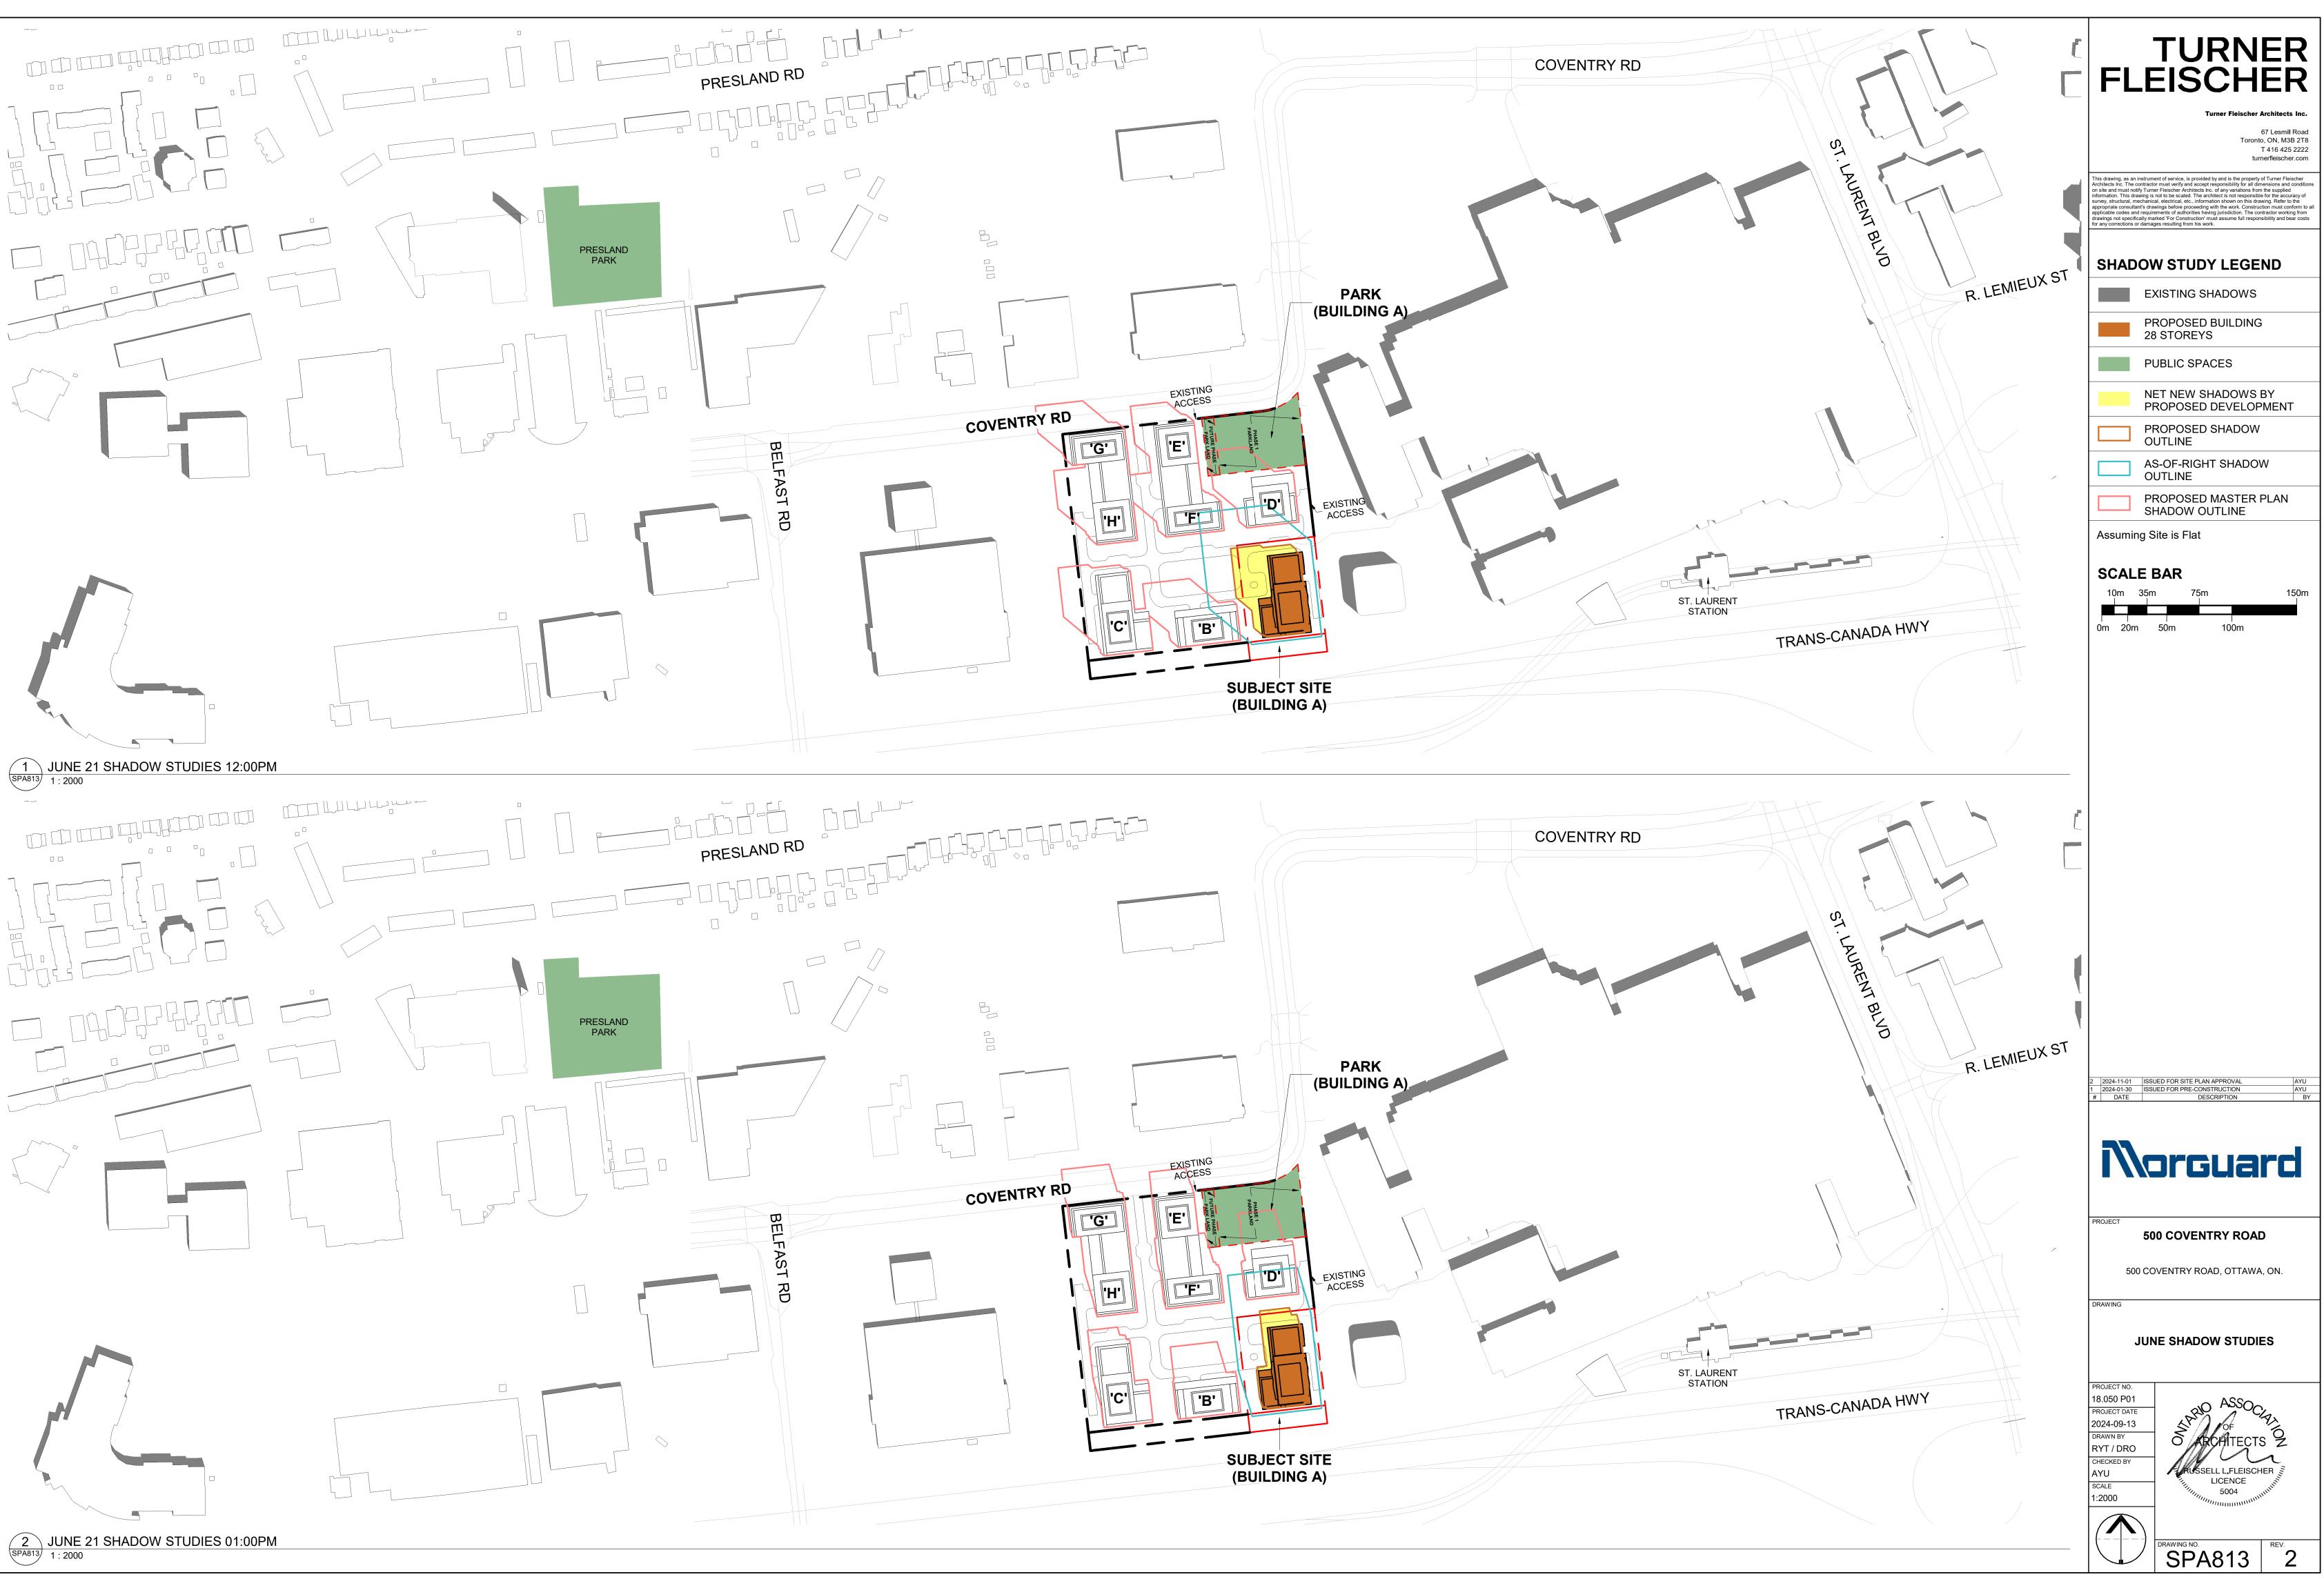
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ORAWING

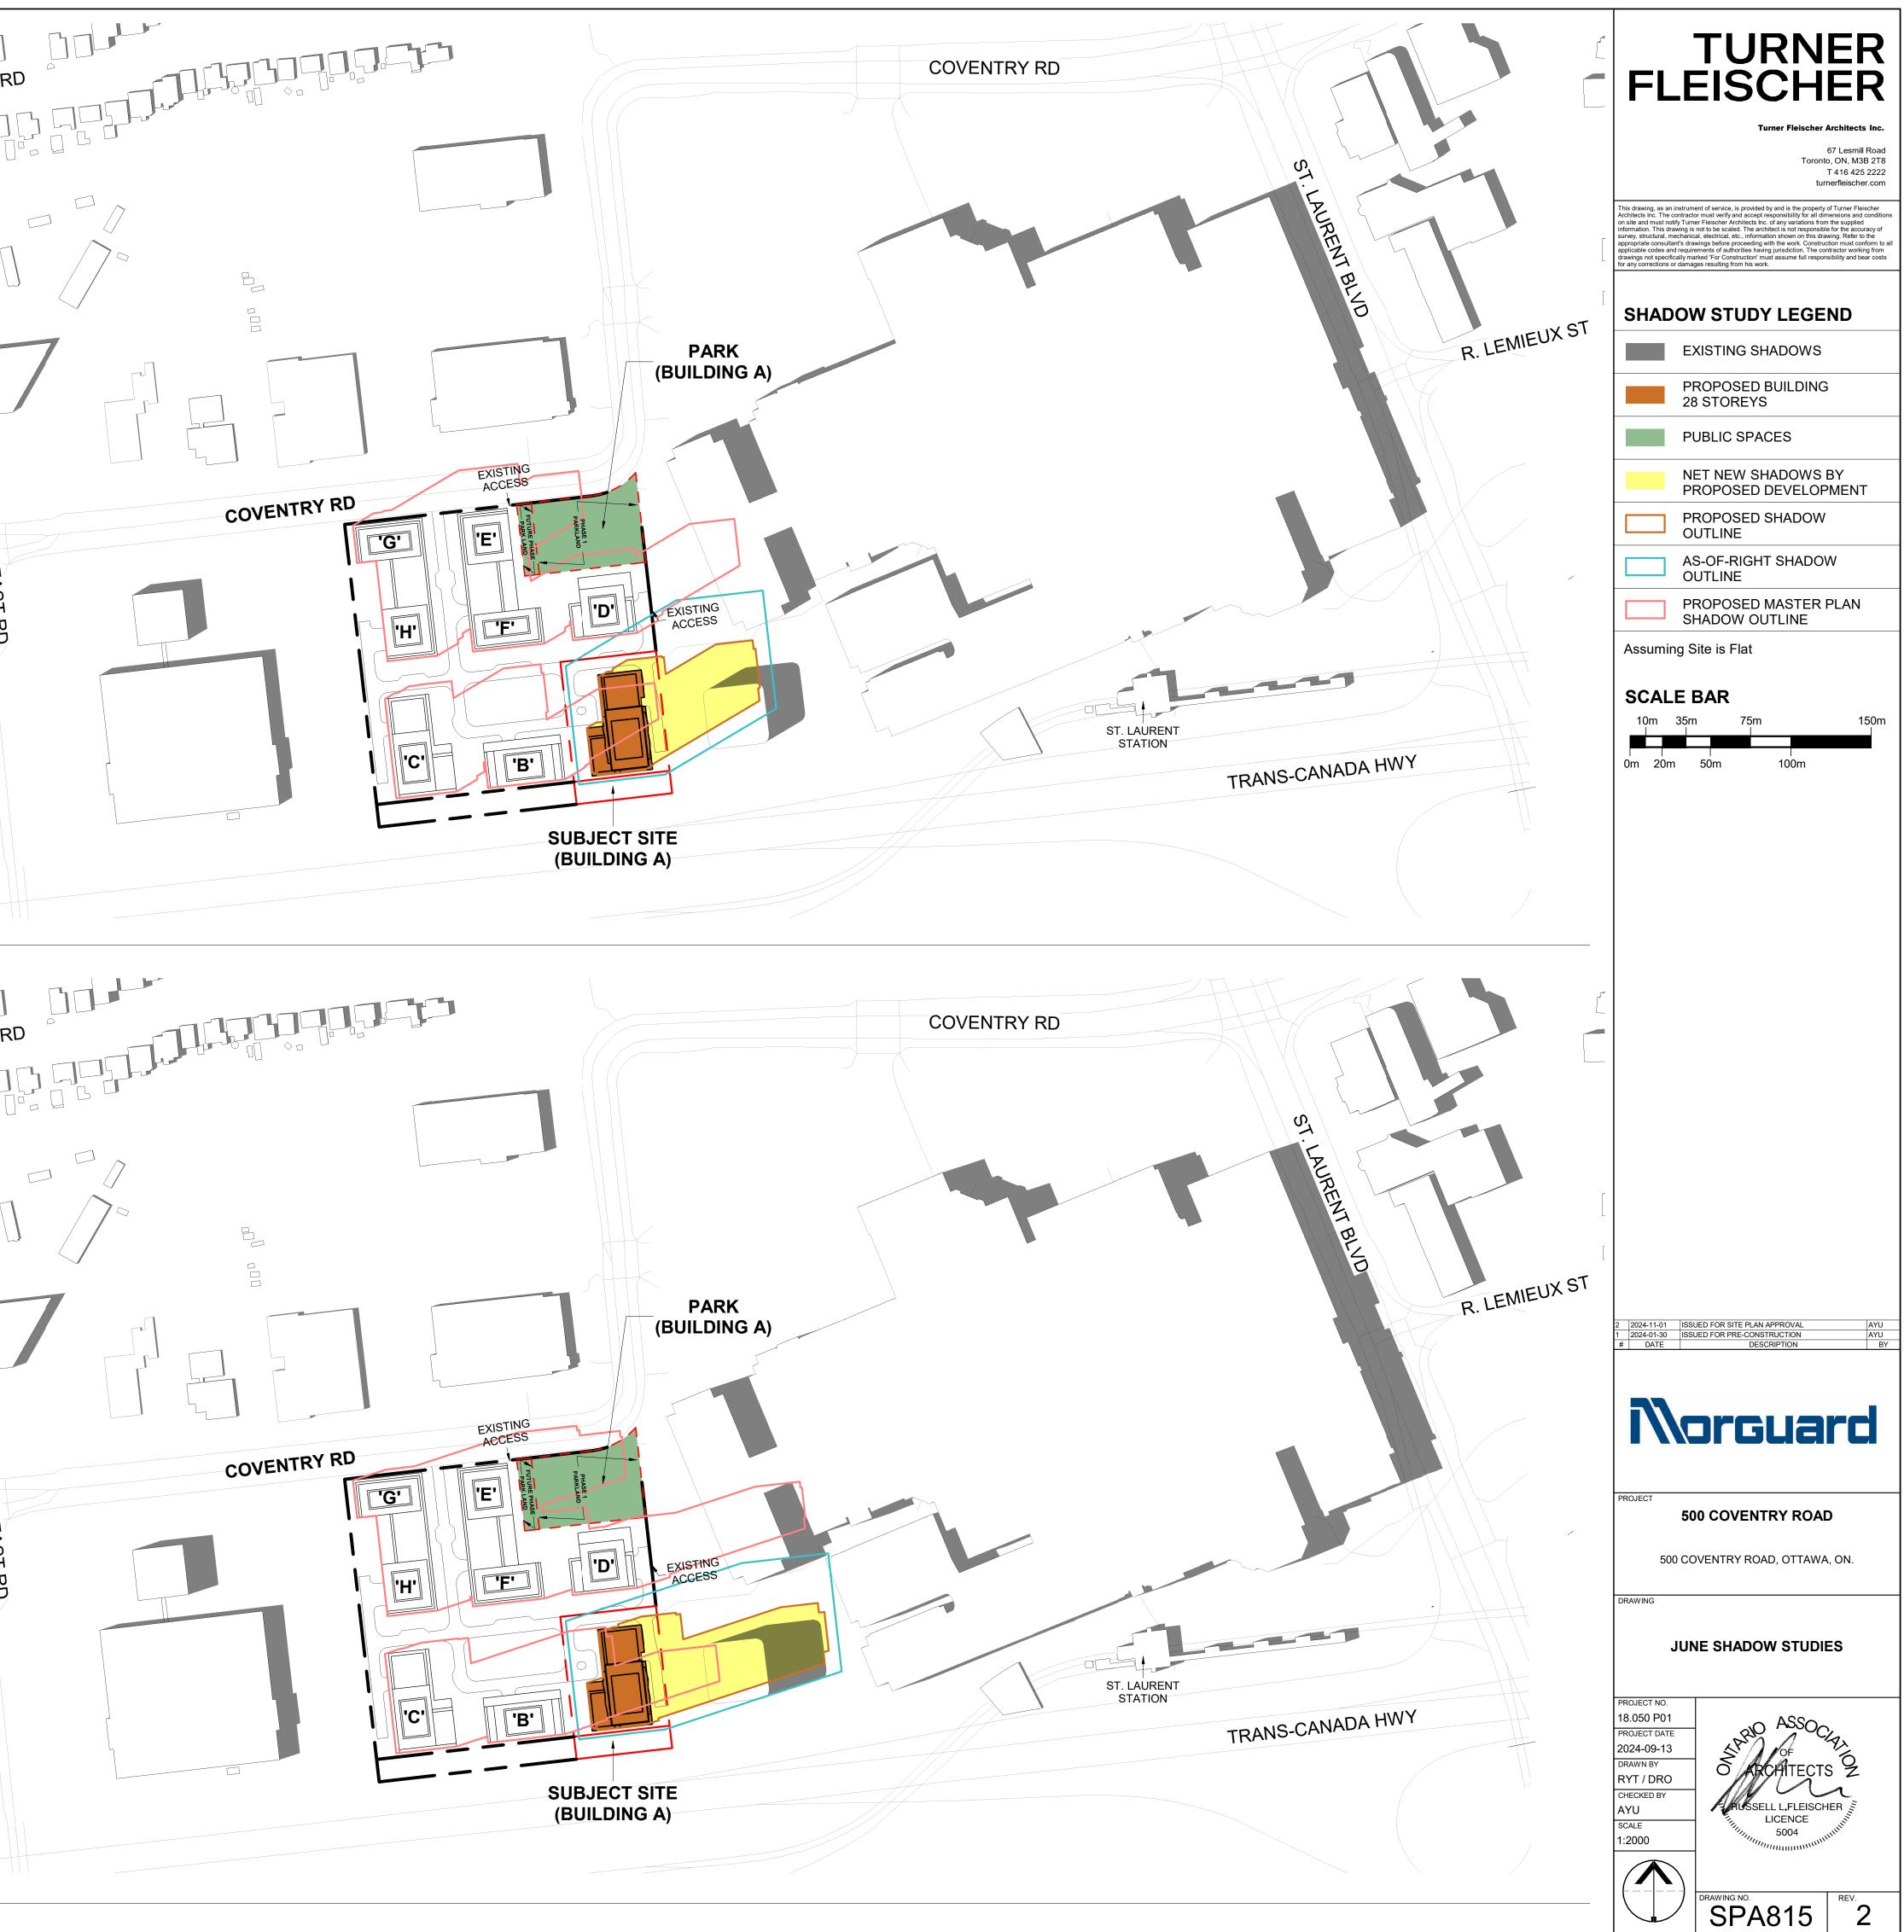
#### JUNE SHADOW STUDIES

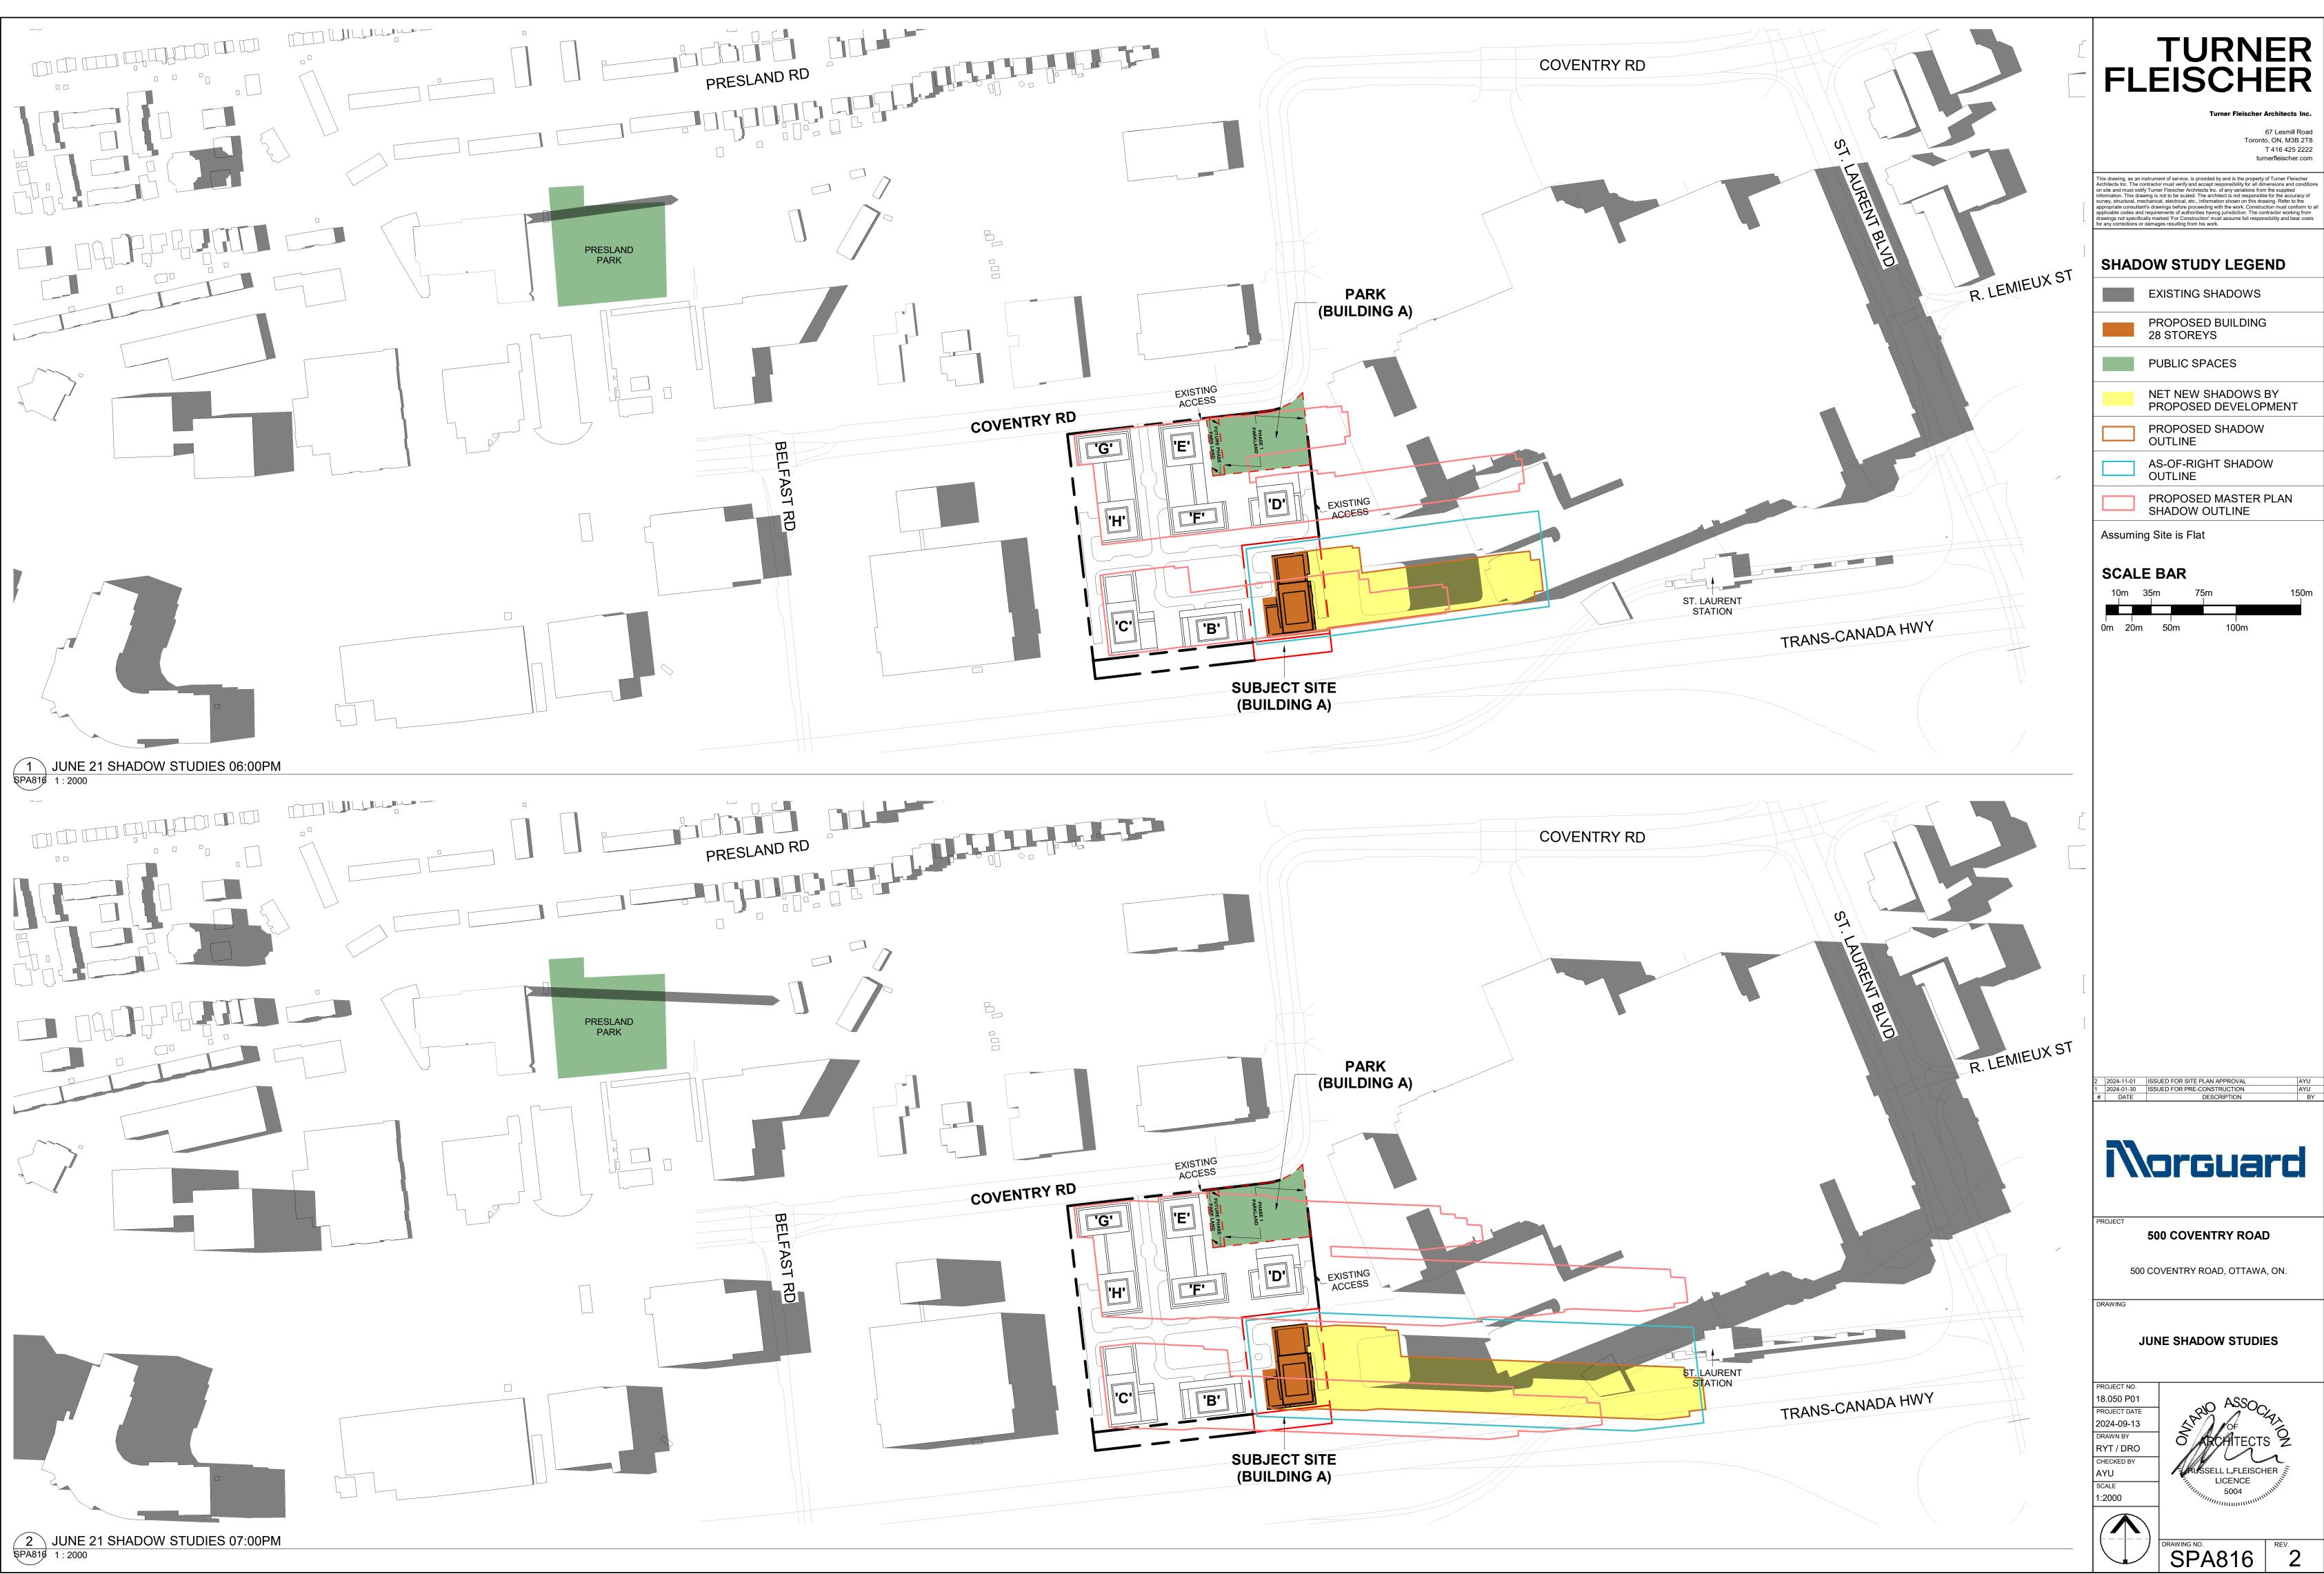PROJECT NO. 18.050 P01 PROJECT DATE 2024-09-13 DRAWN BY RYT / DRO CHECKED BY AYU SCALE 1:2000

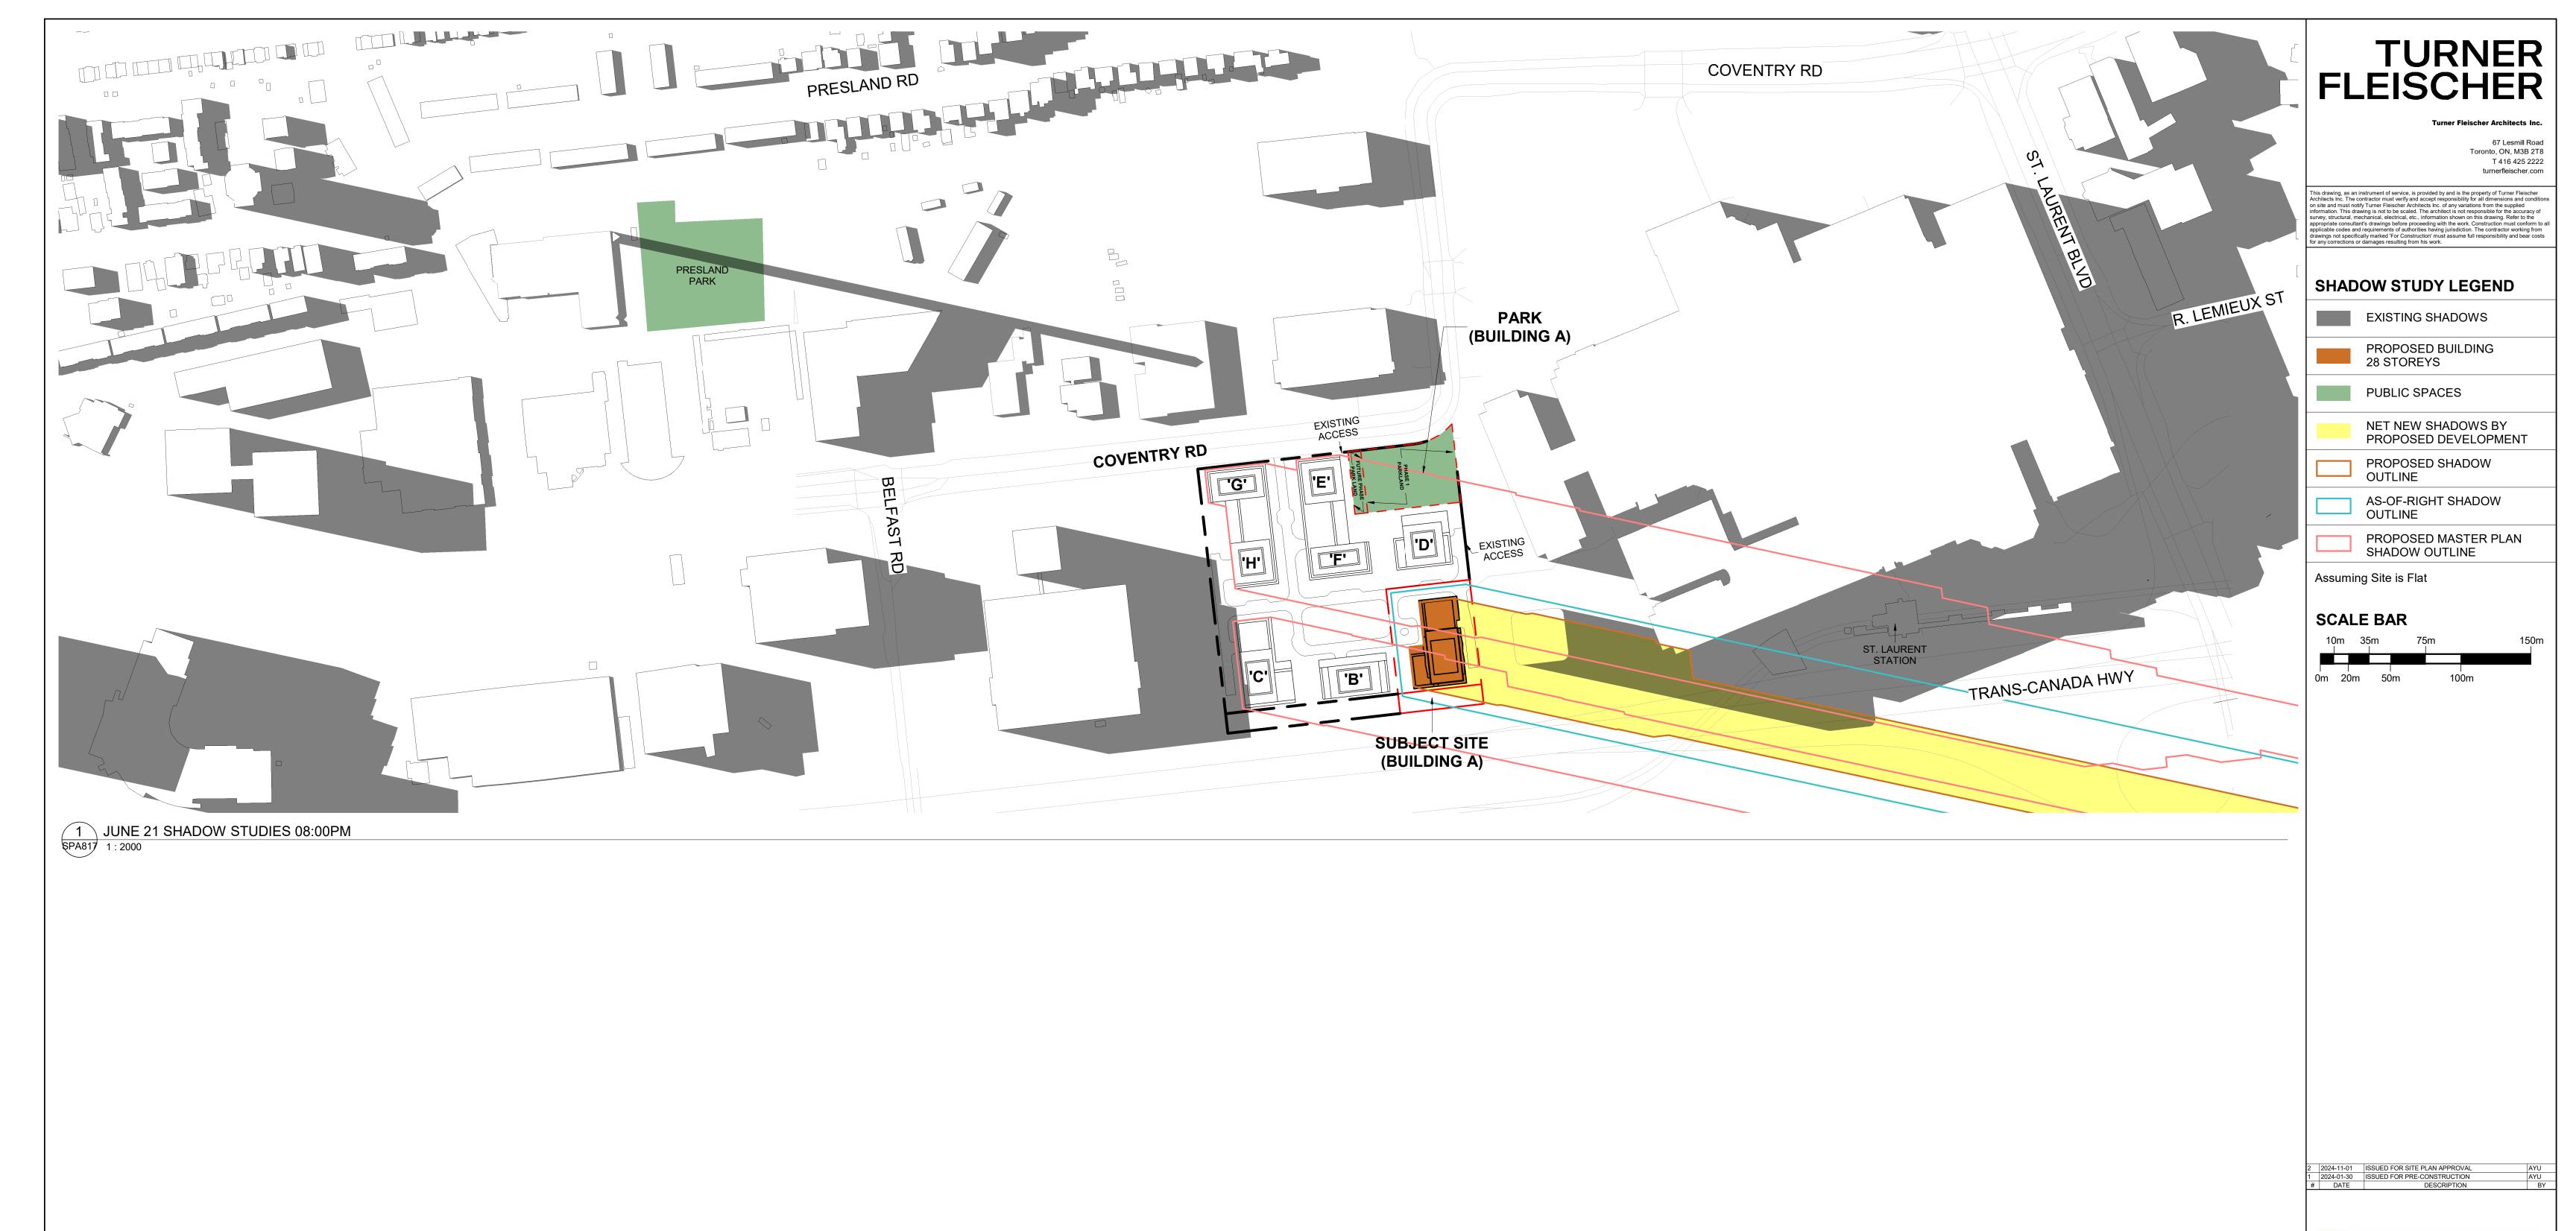



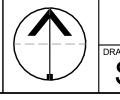

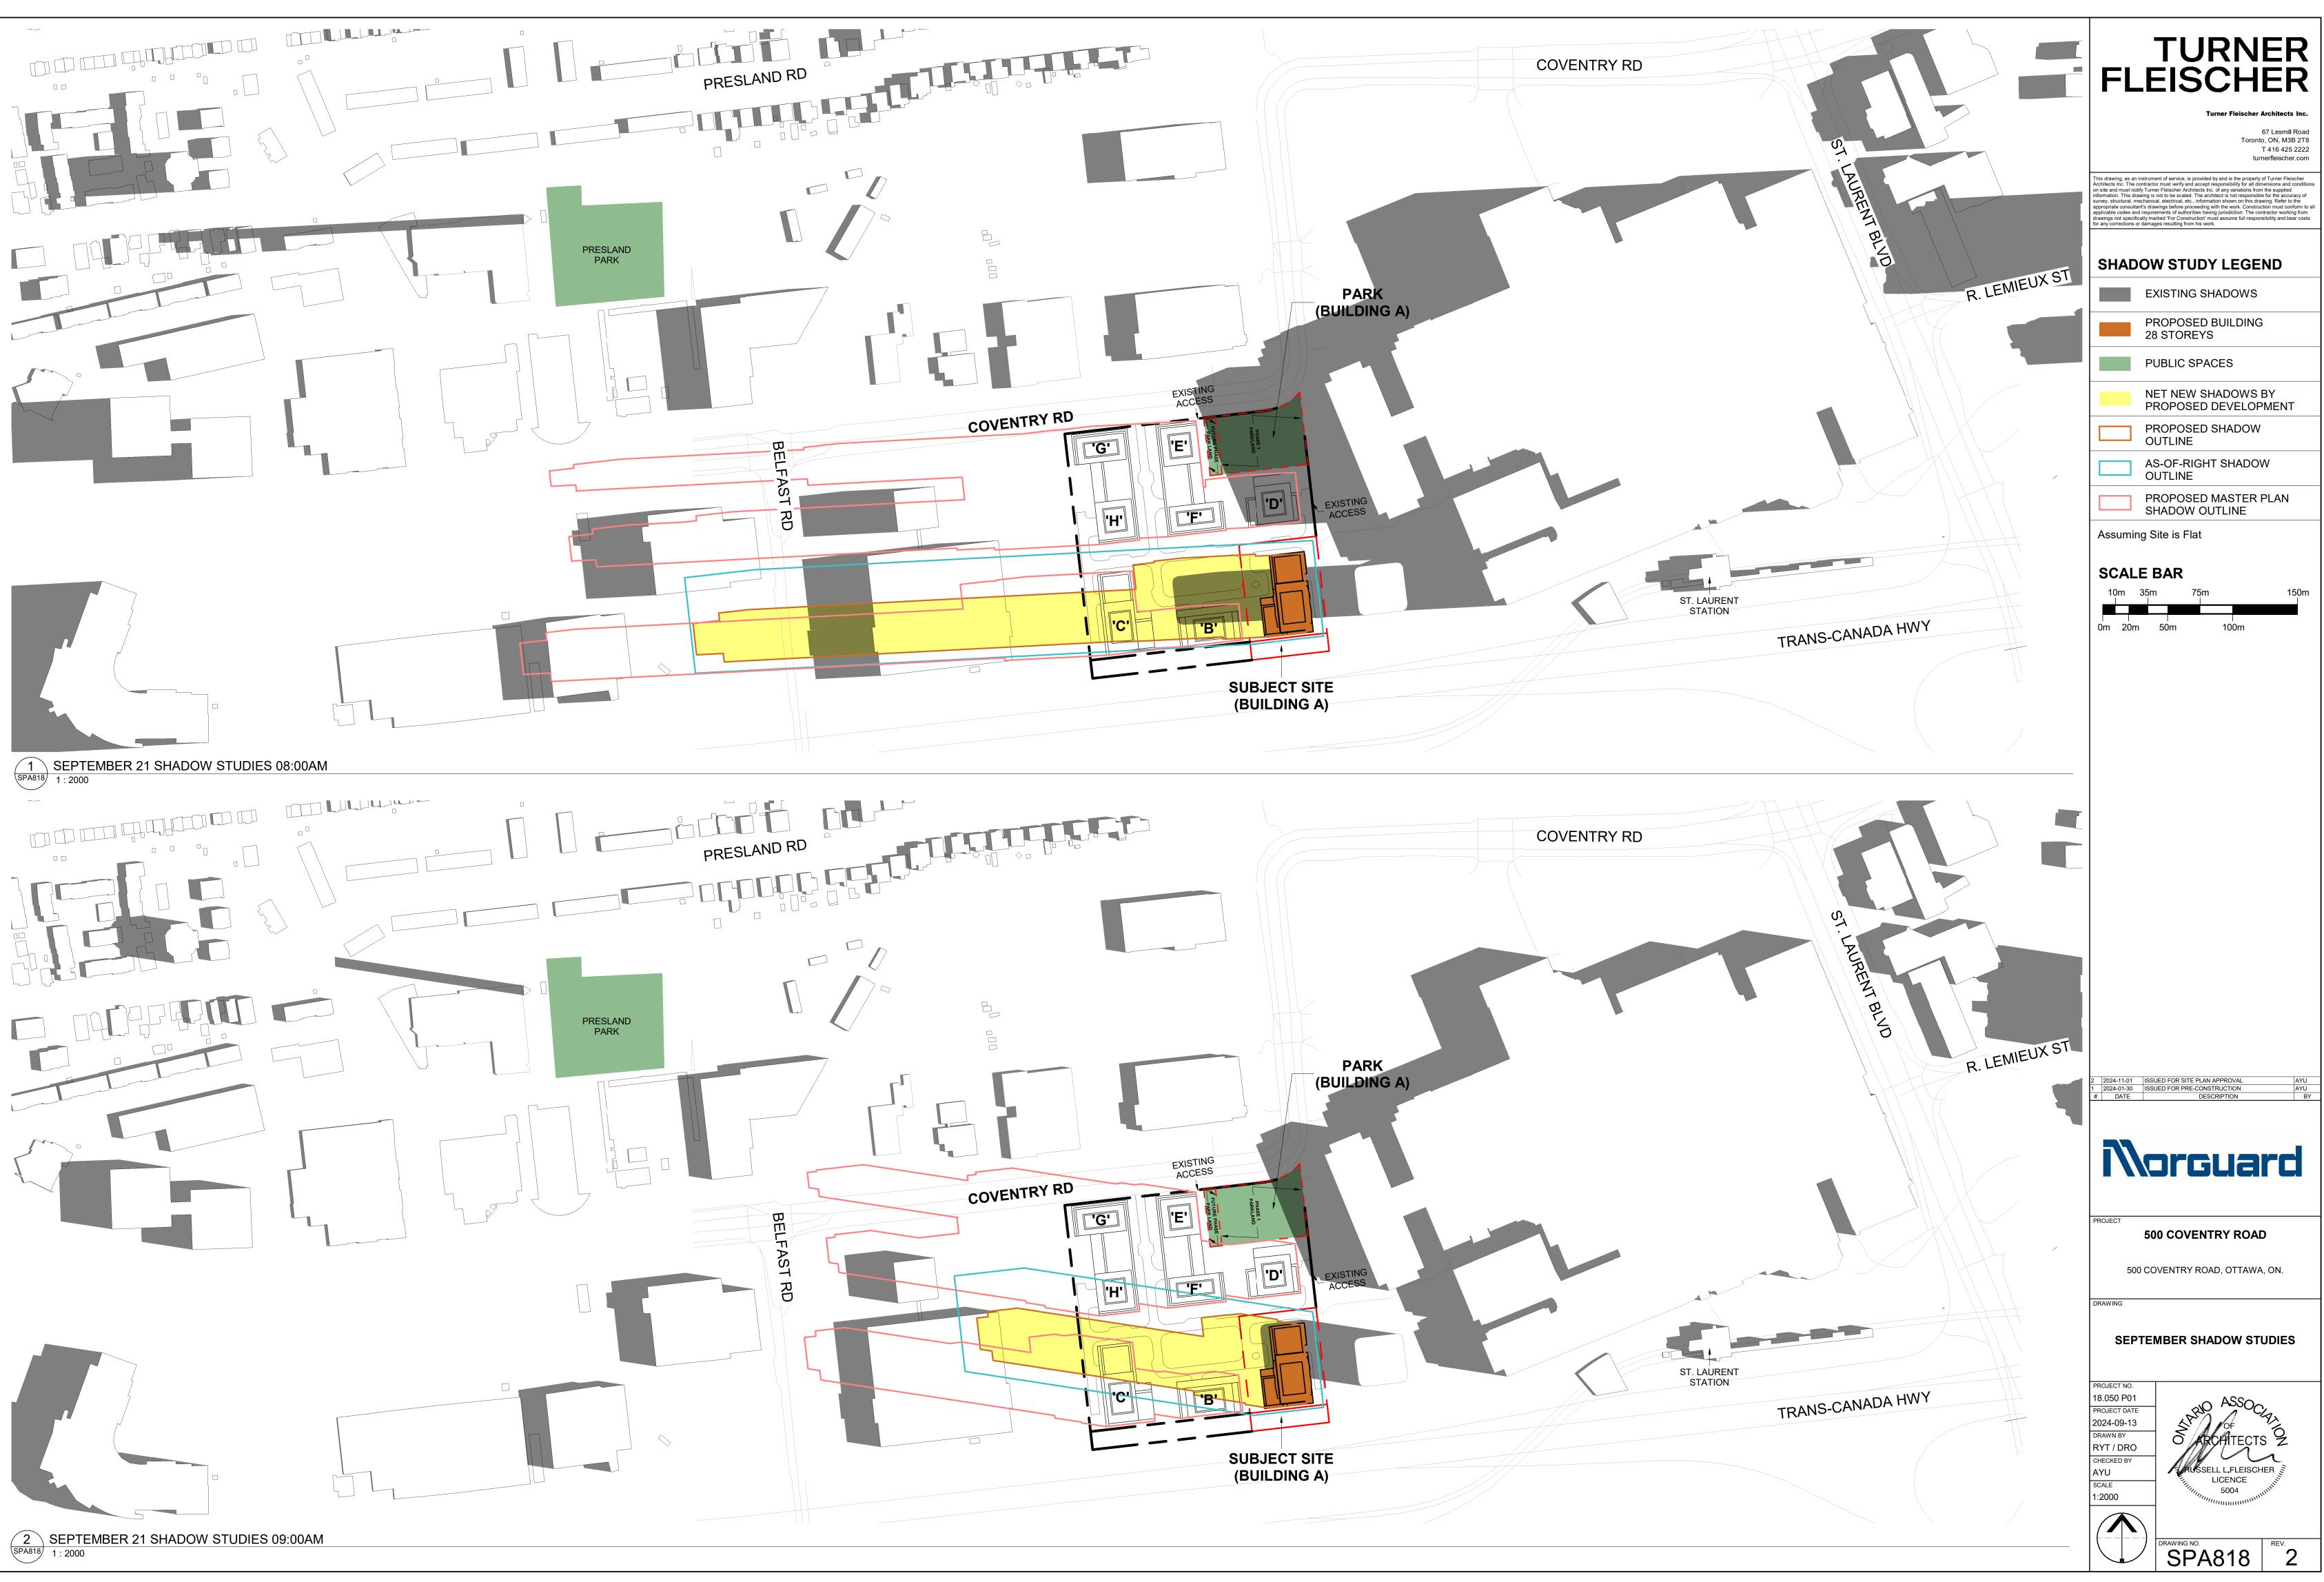





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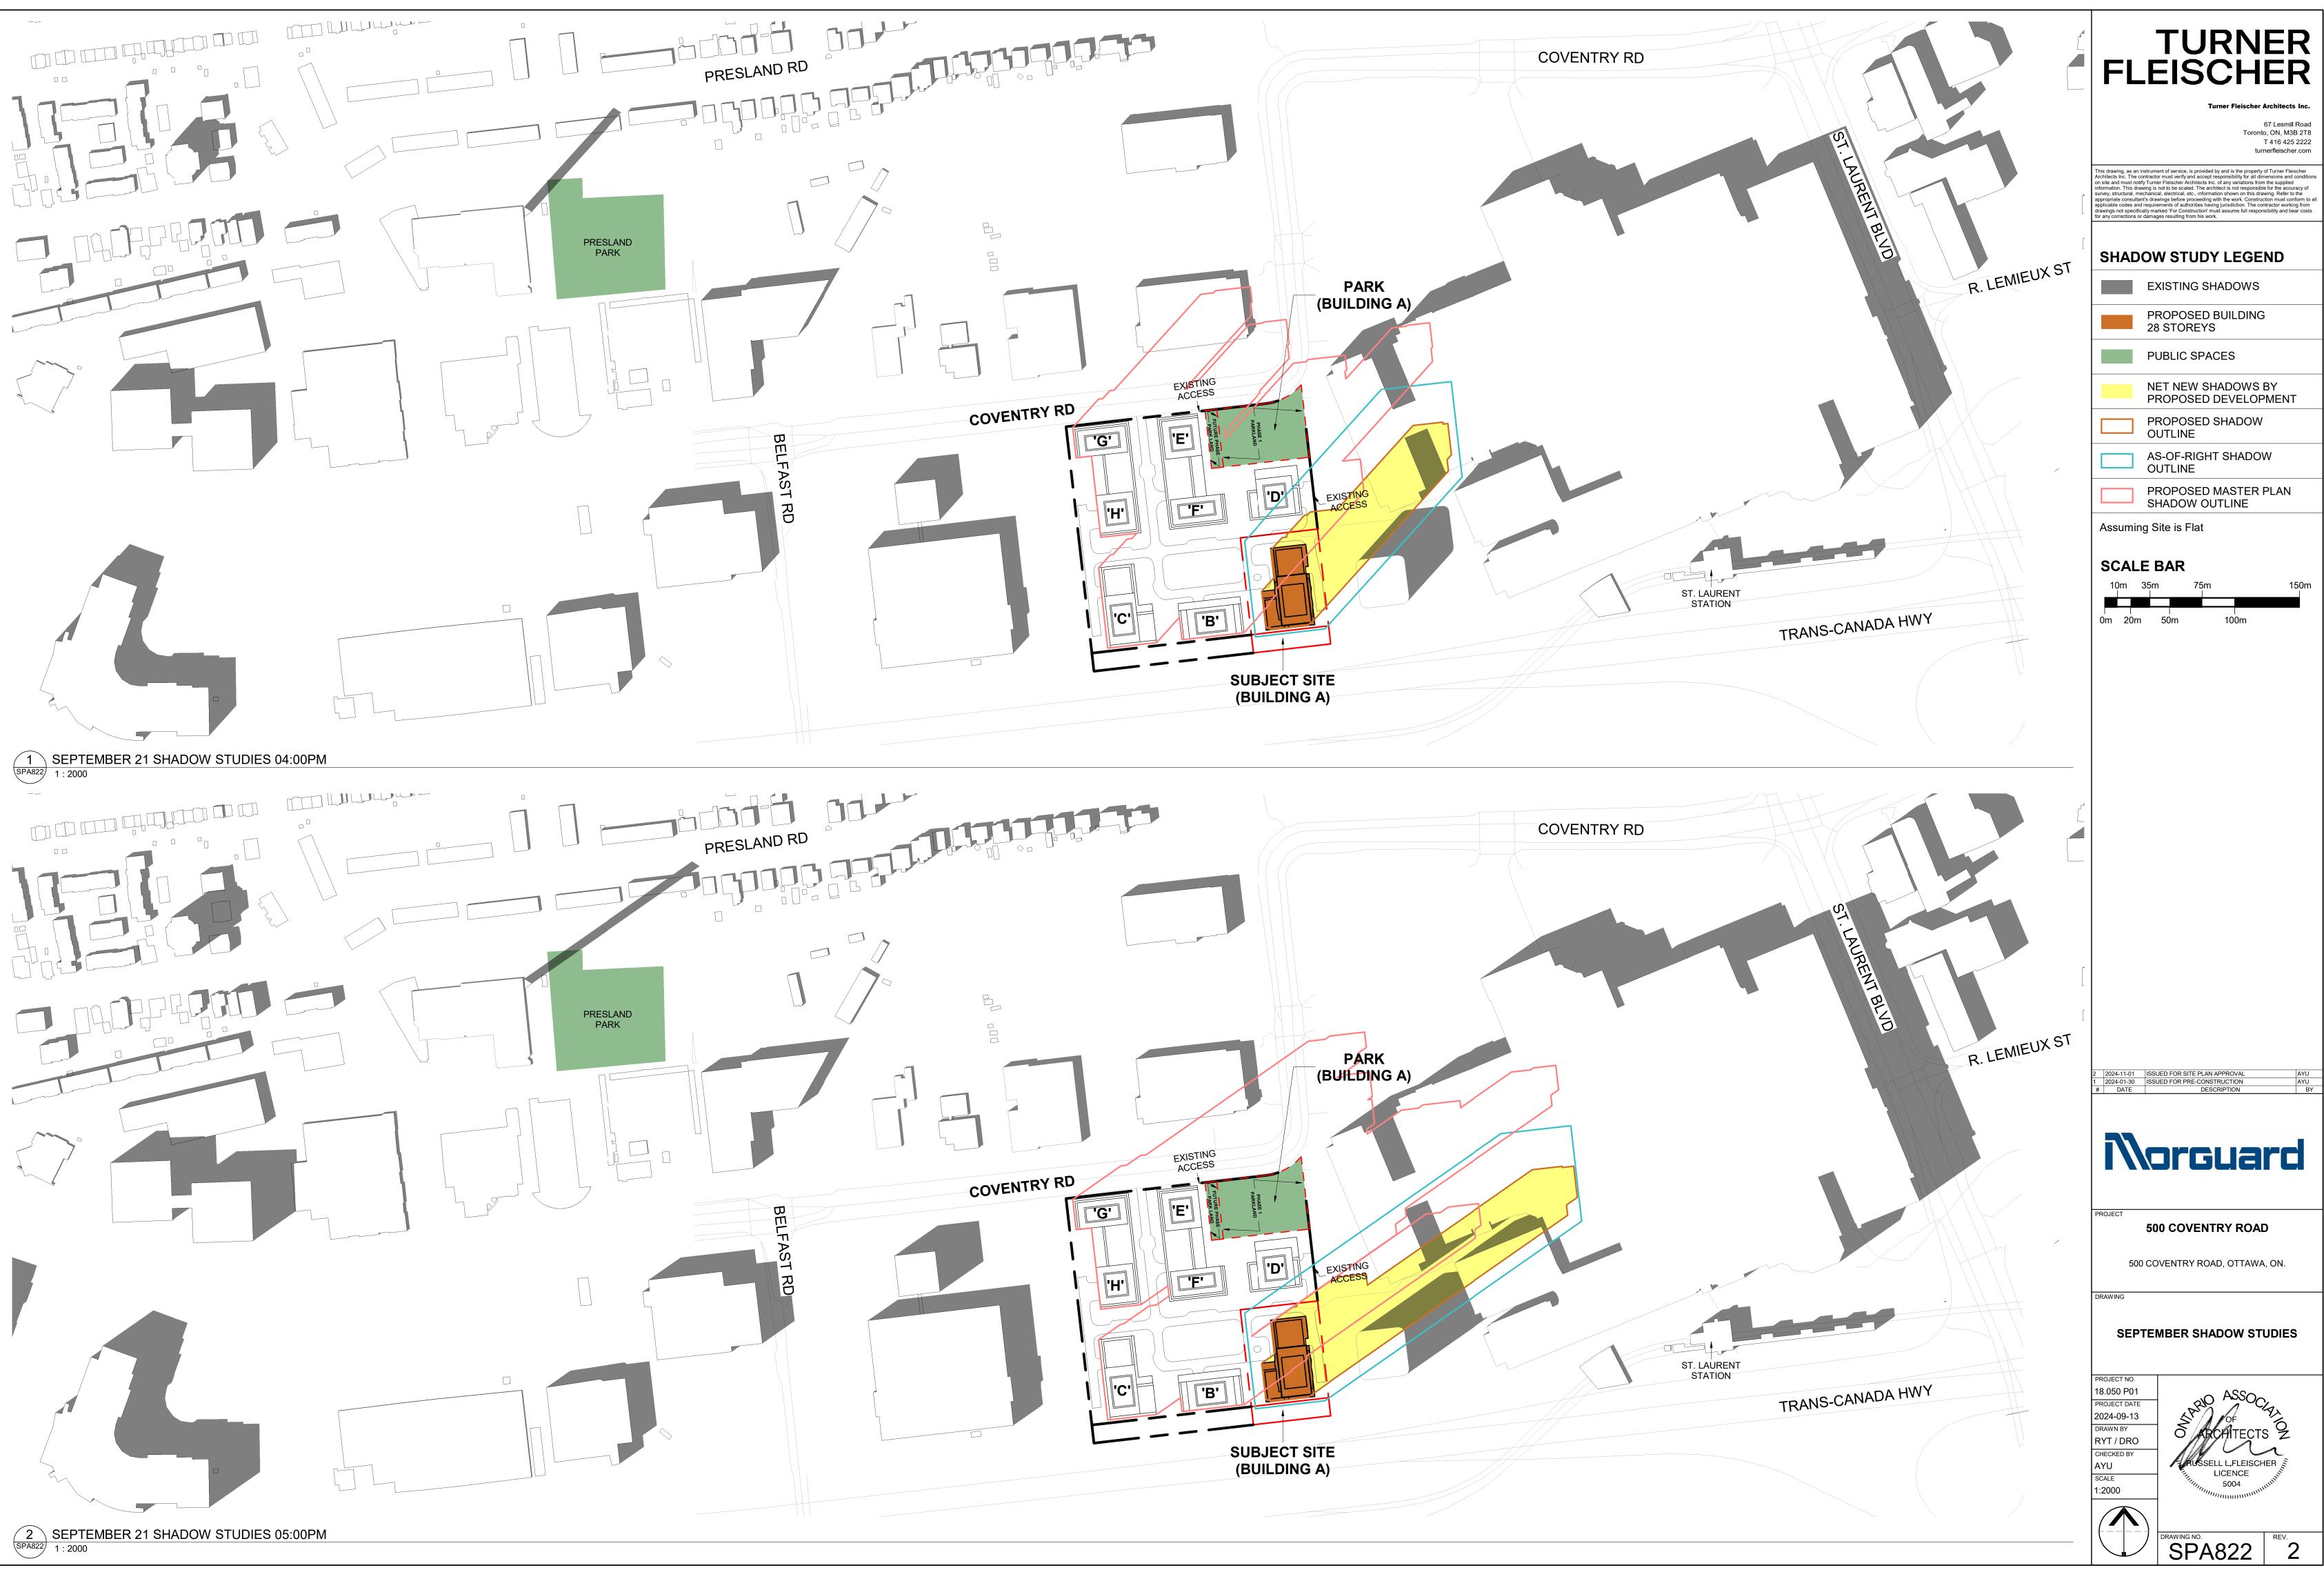





PRESLAND RD PRESLAND PARK Ū 1 SEPTEMBER 21 SHADOW STUDIES 02:00PM SPA821 1:2000 PRESLAND RD PRESLAND PARK 

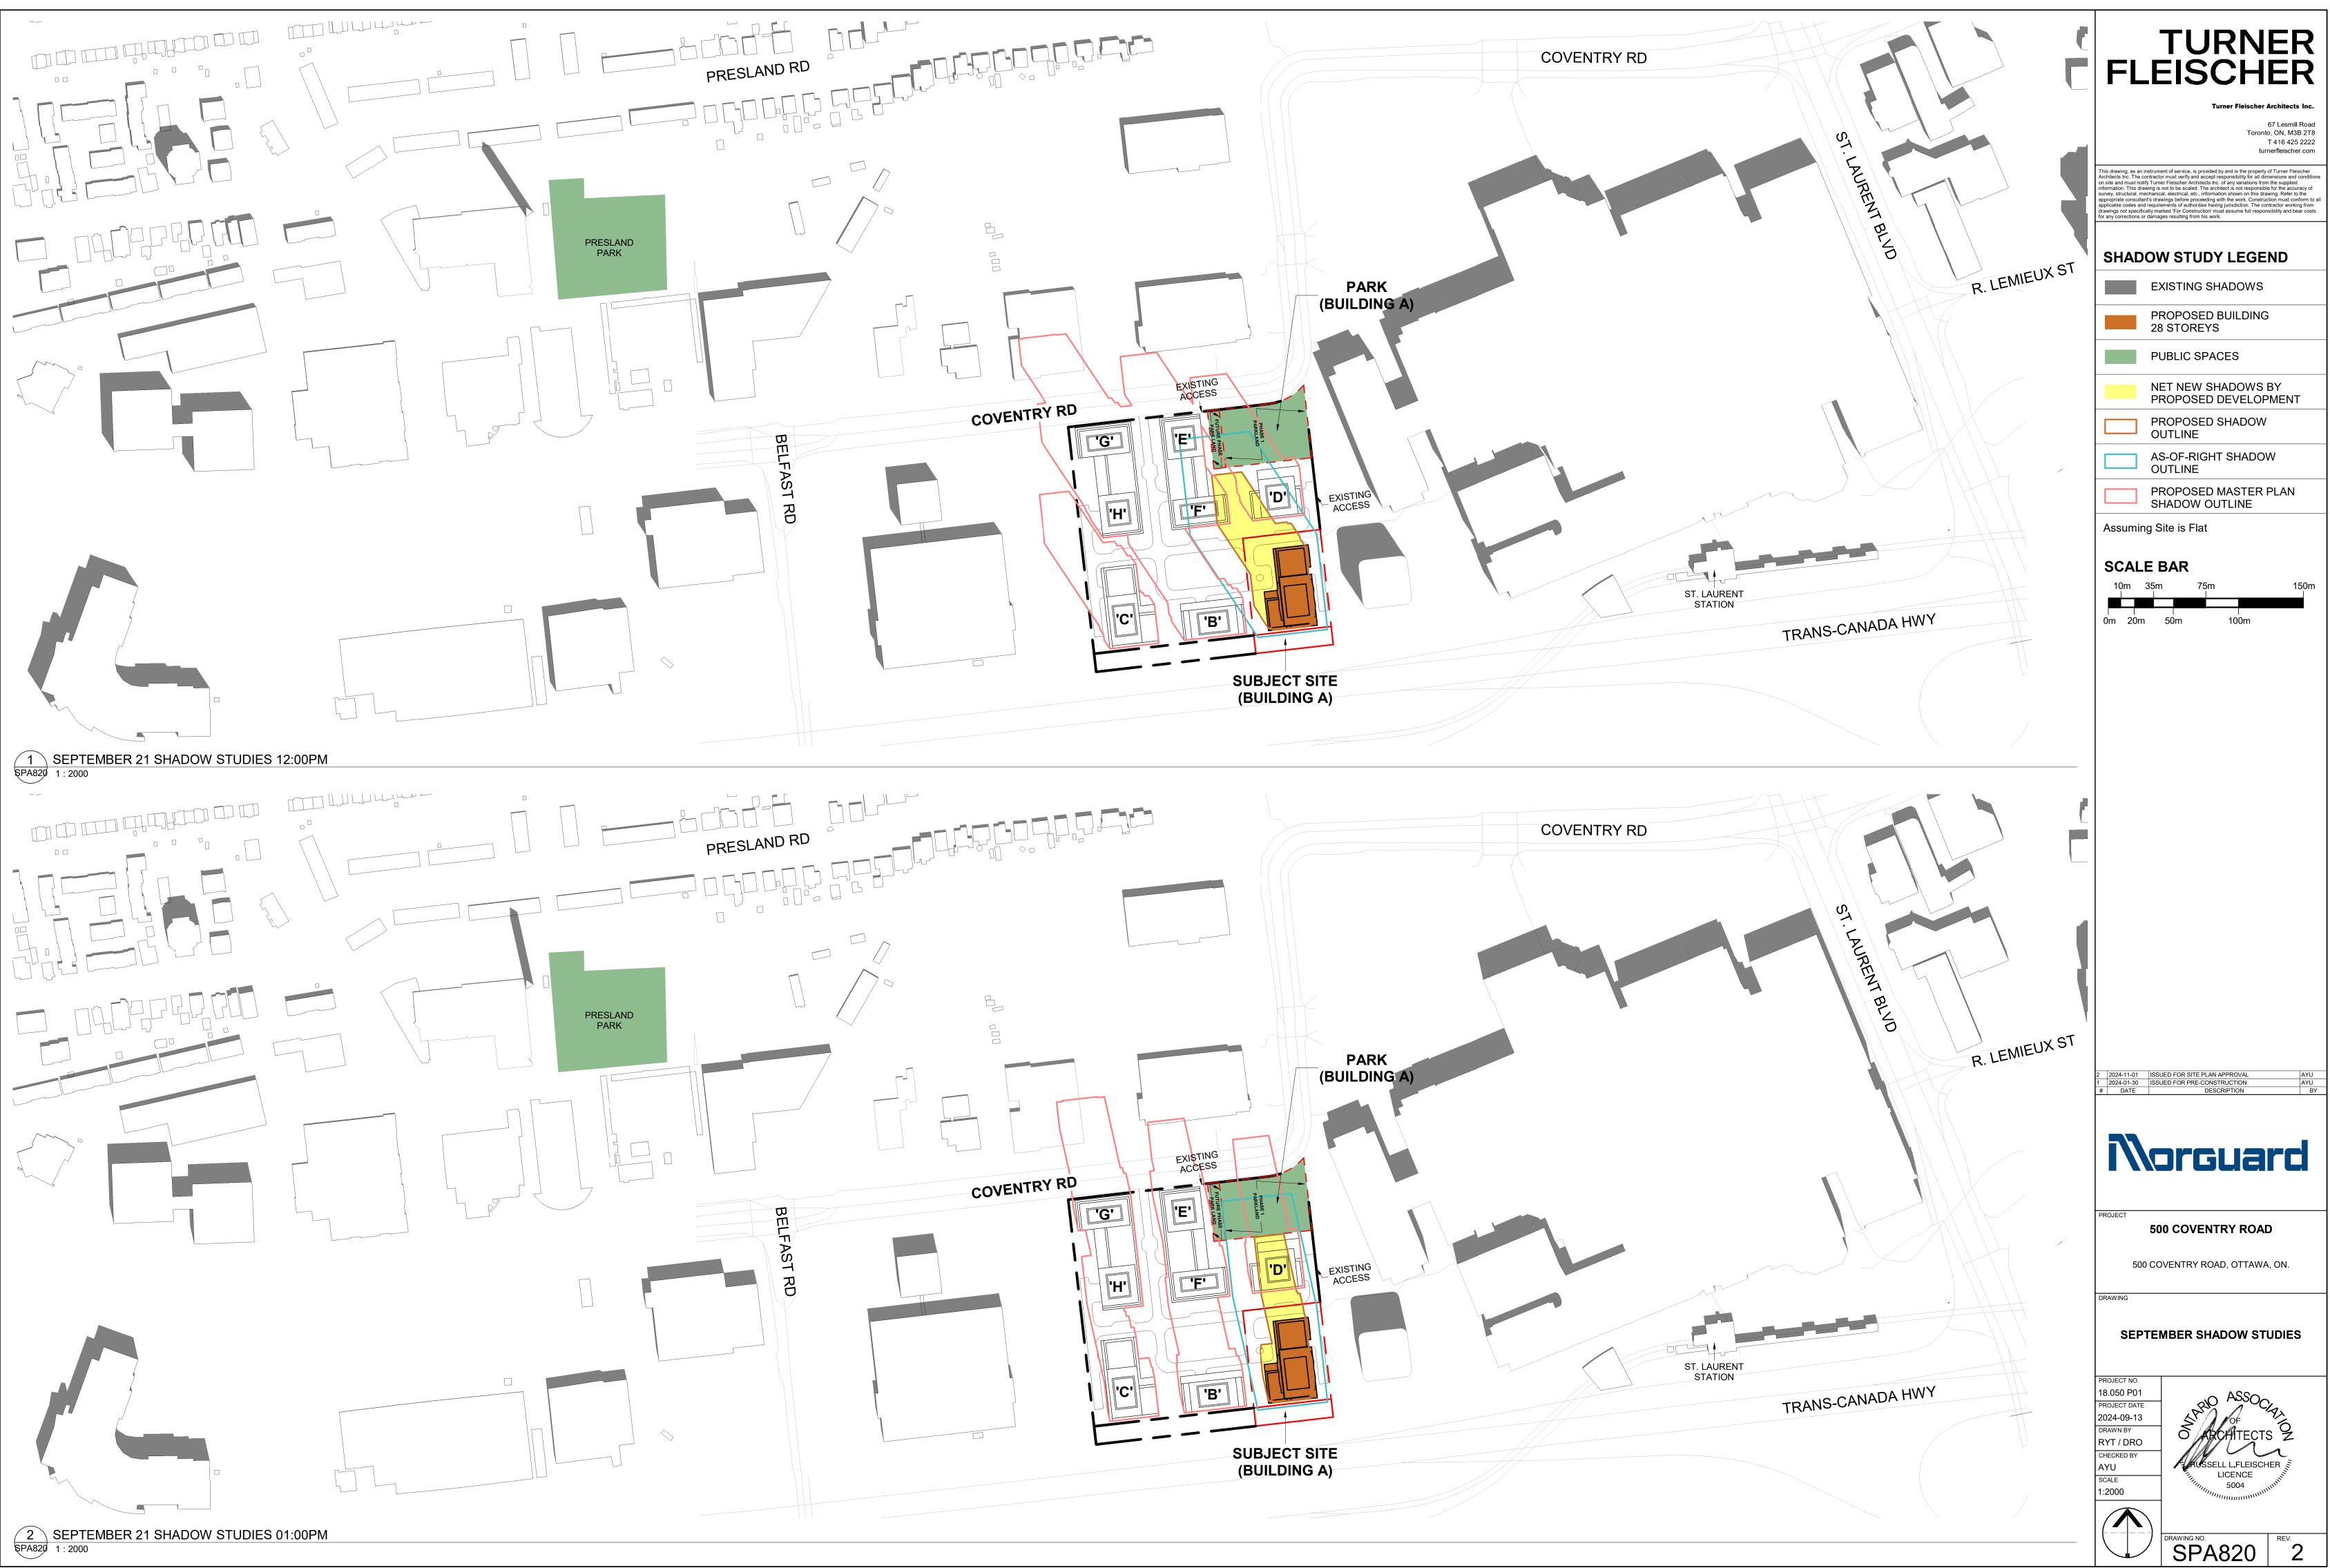


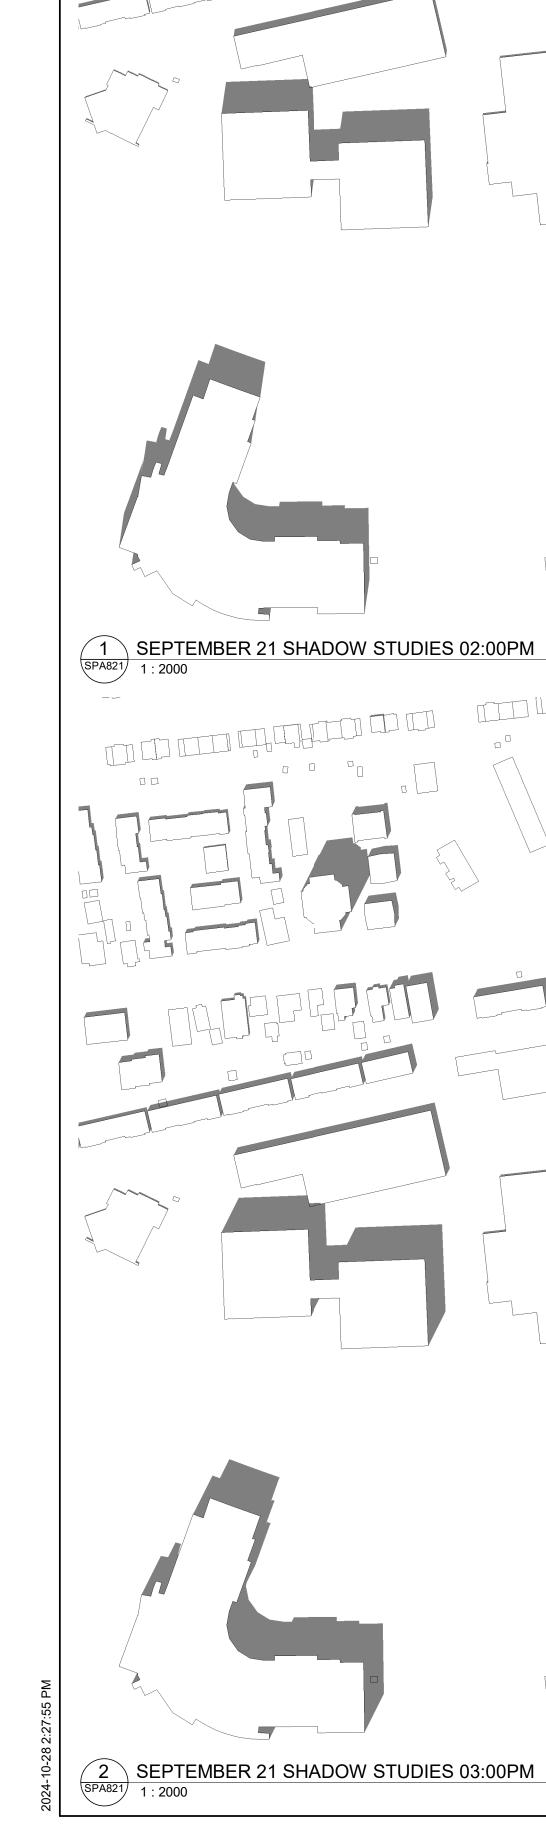








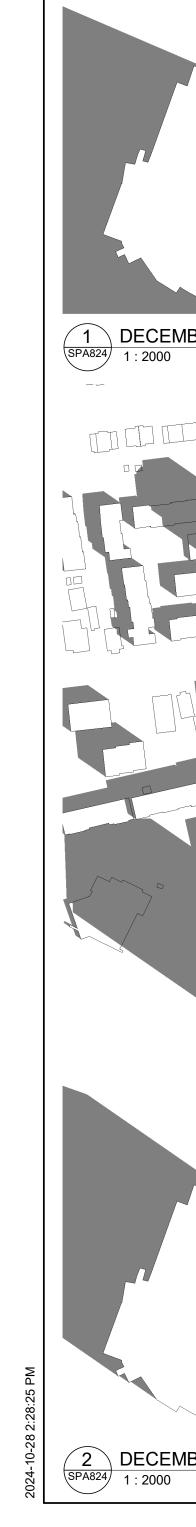

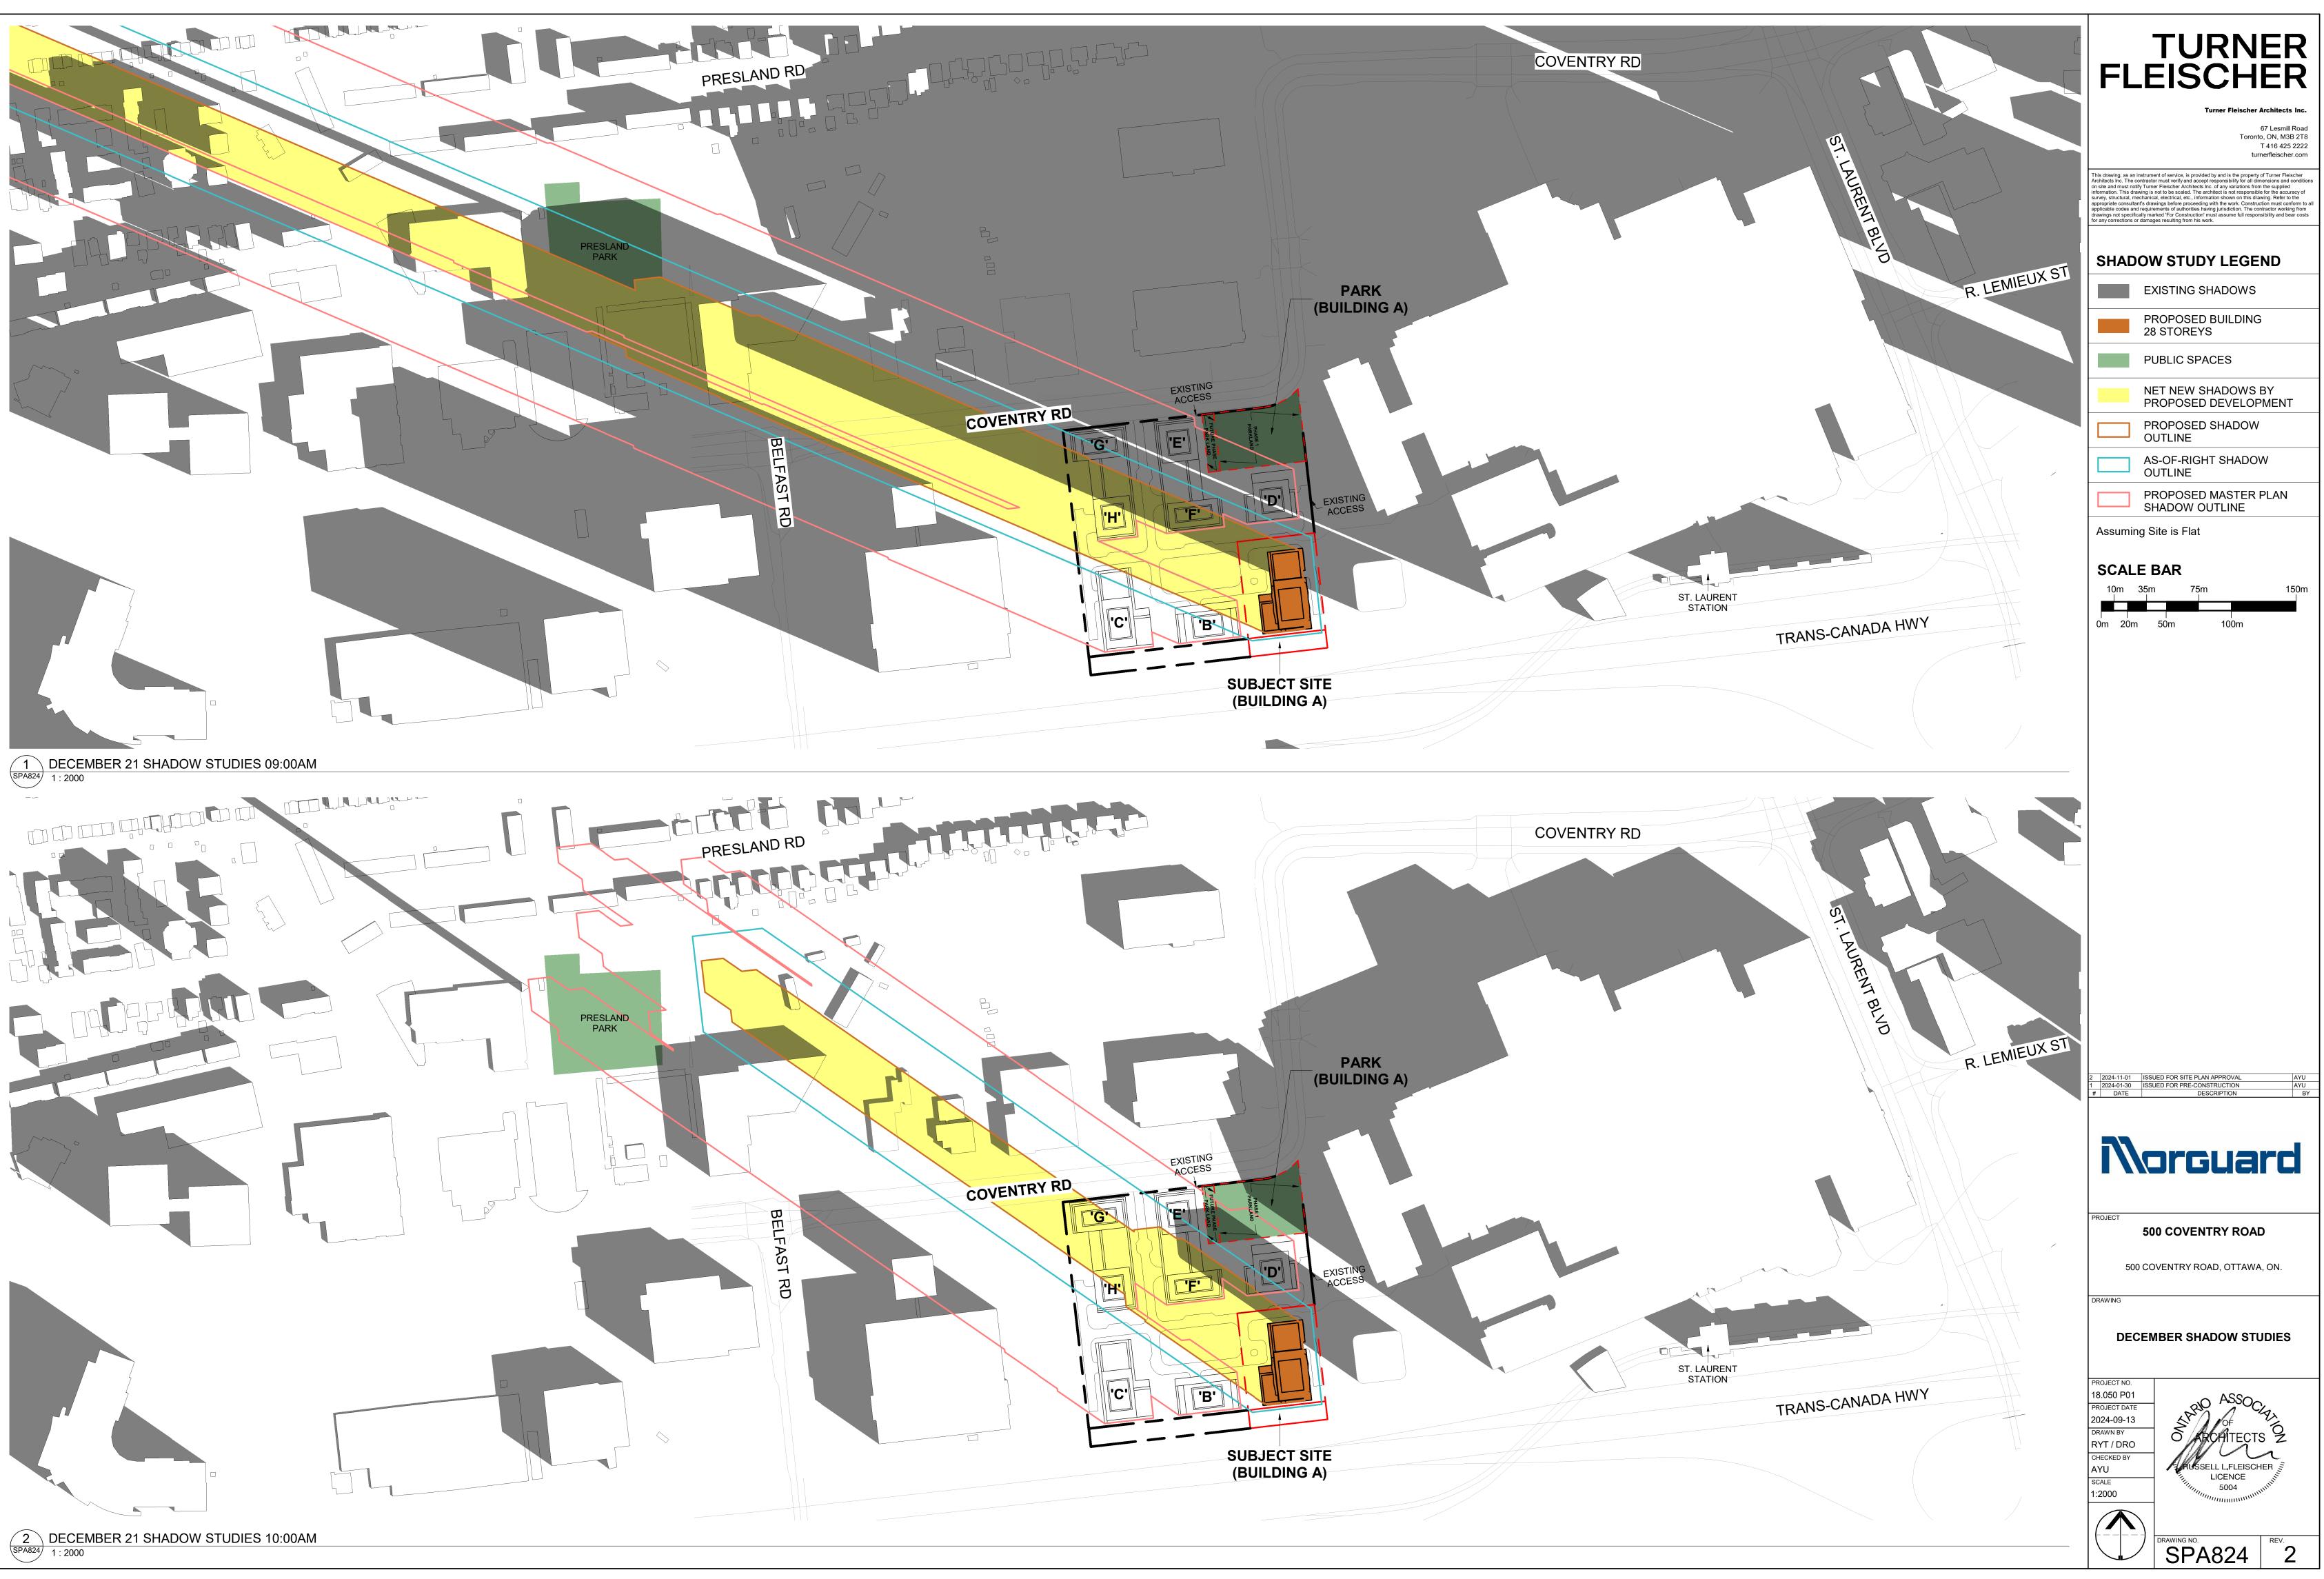

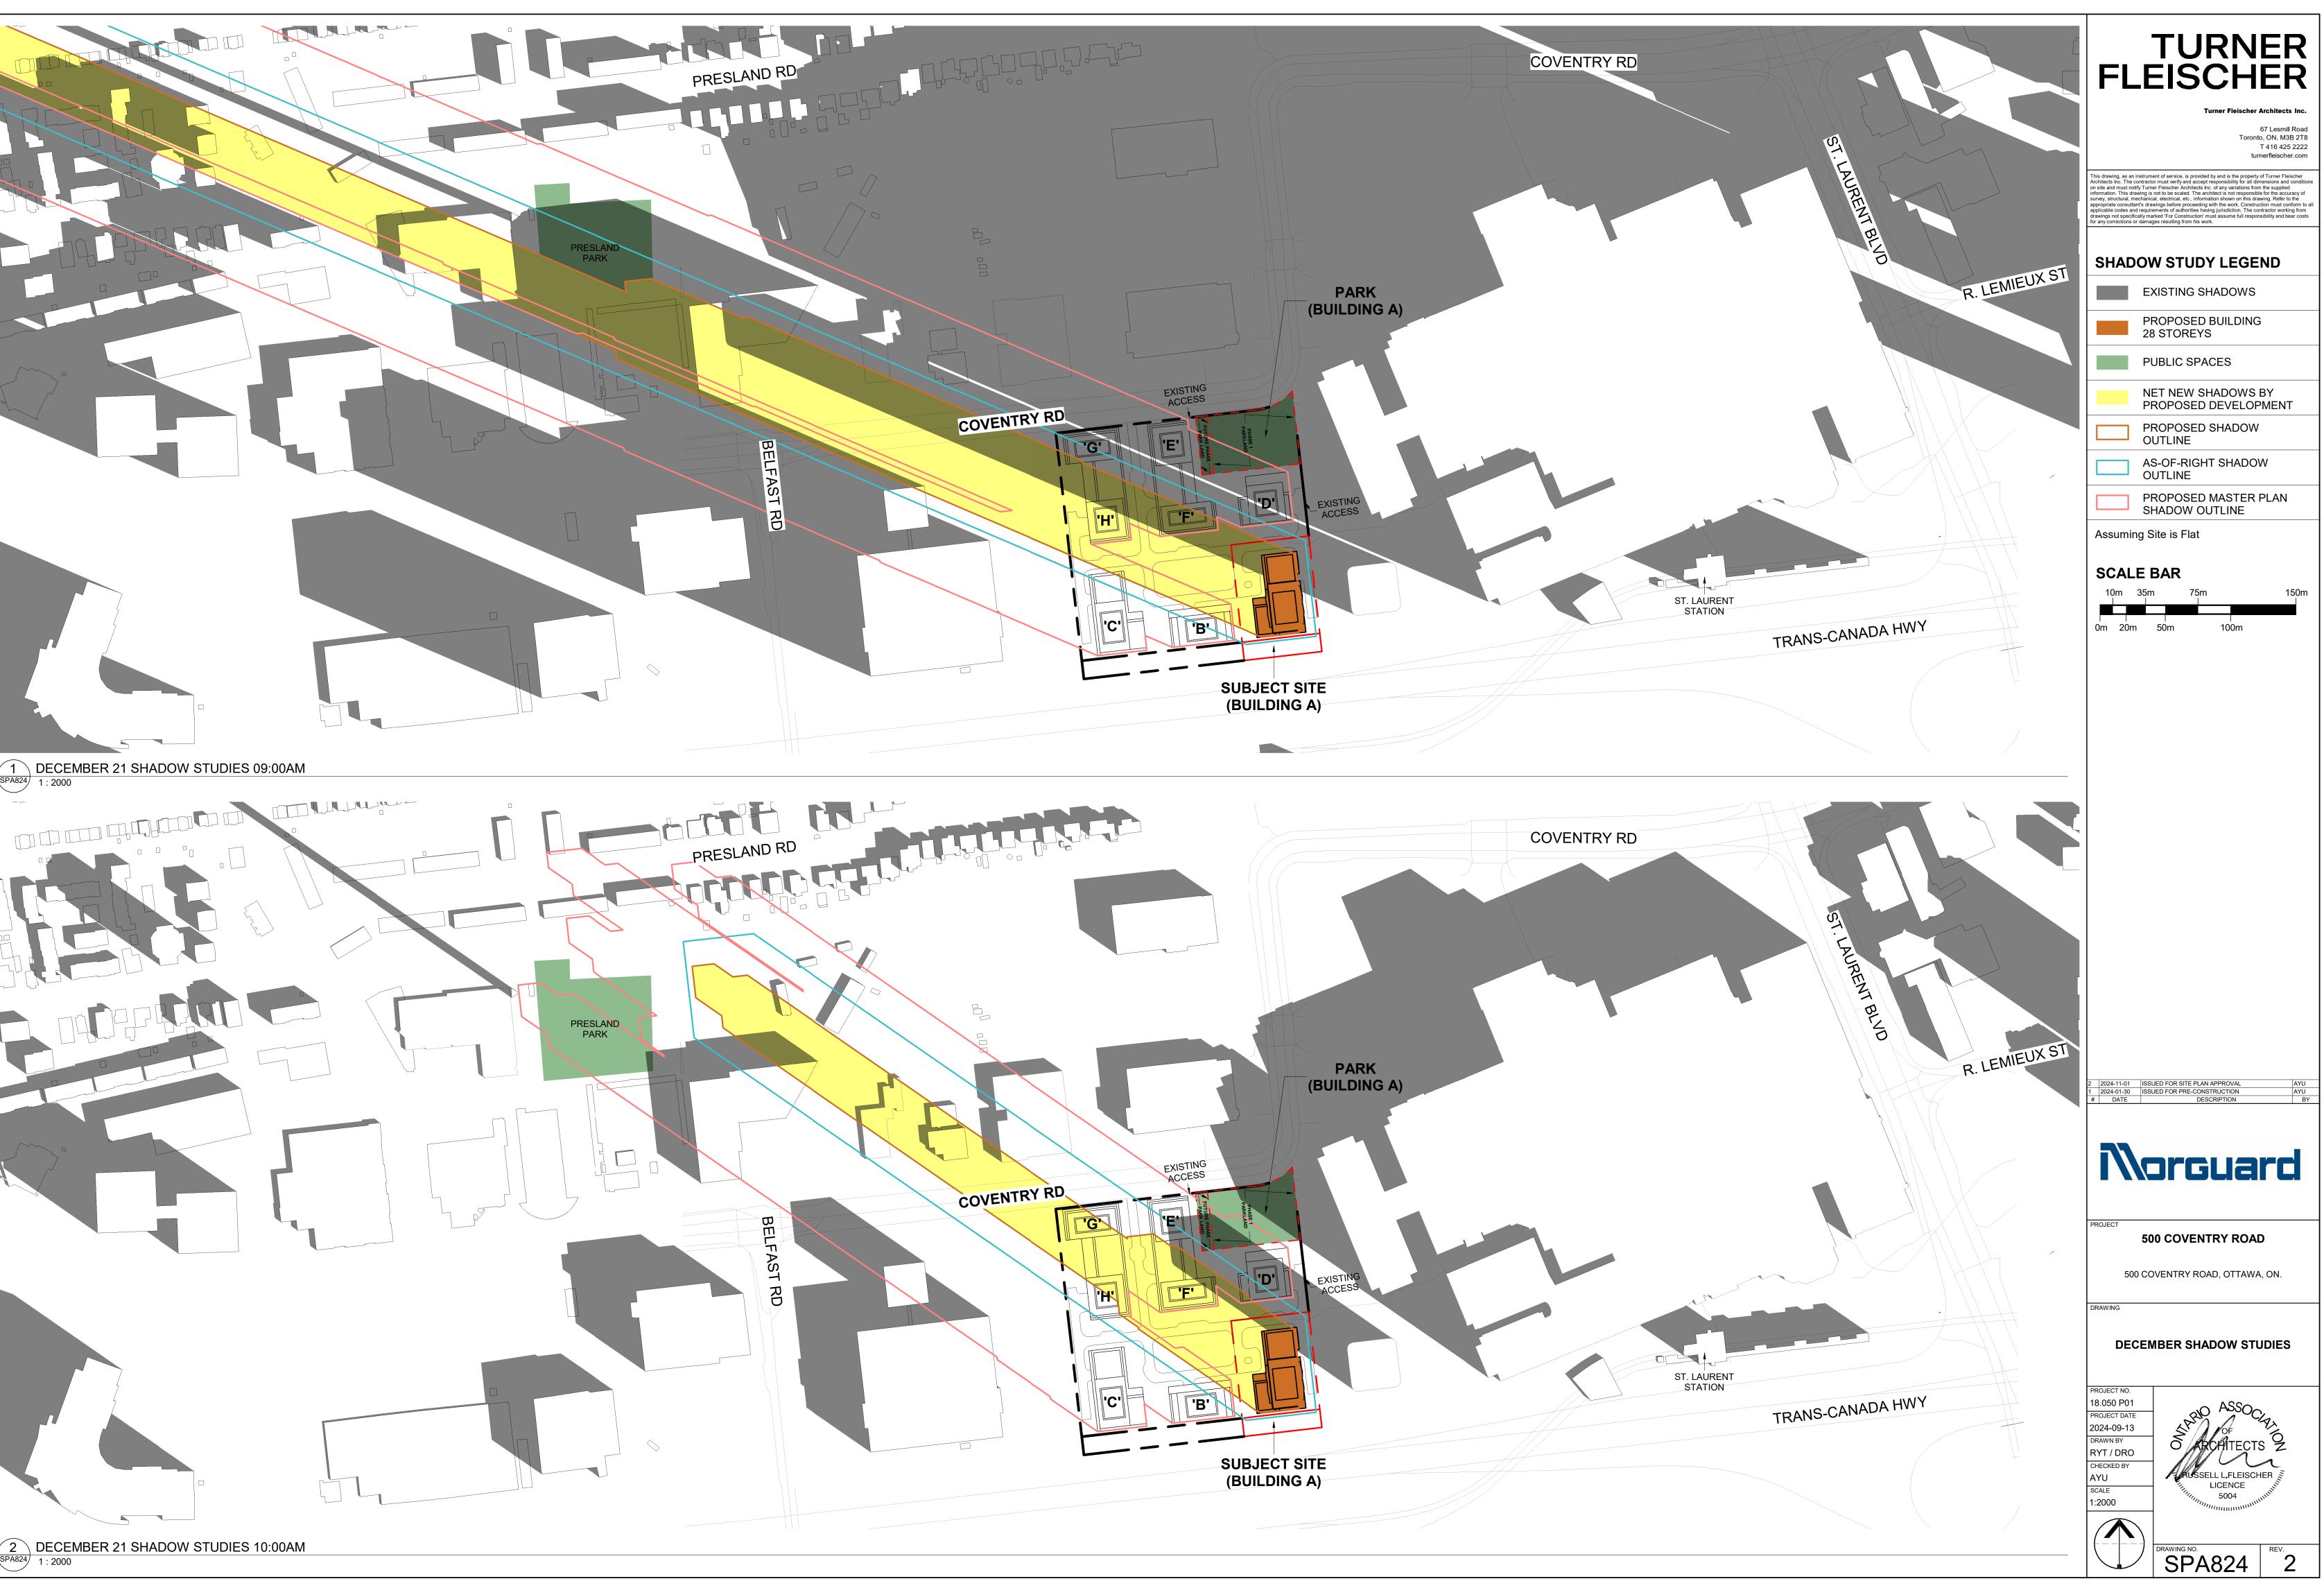

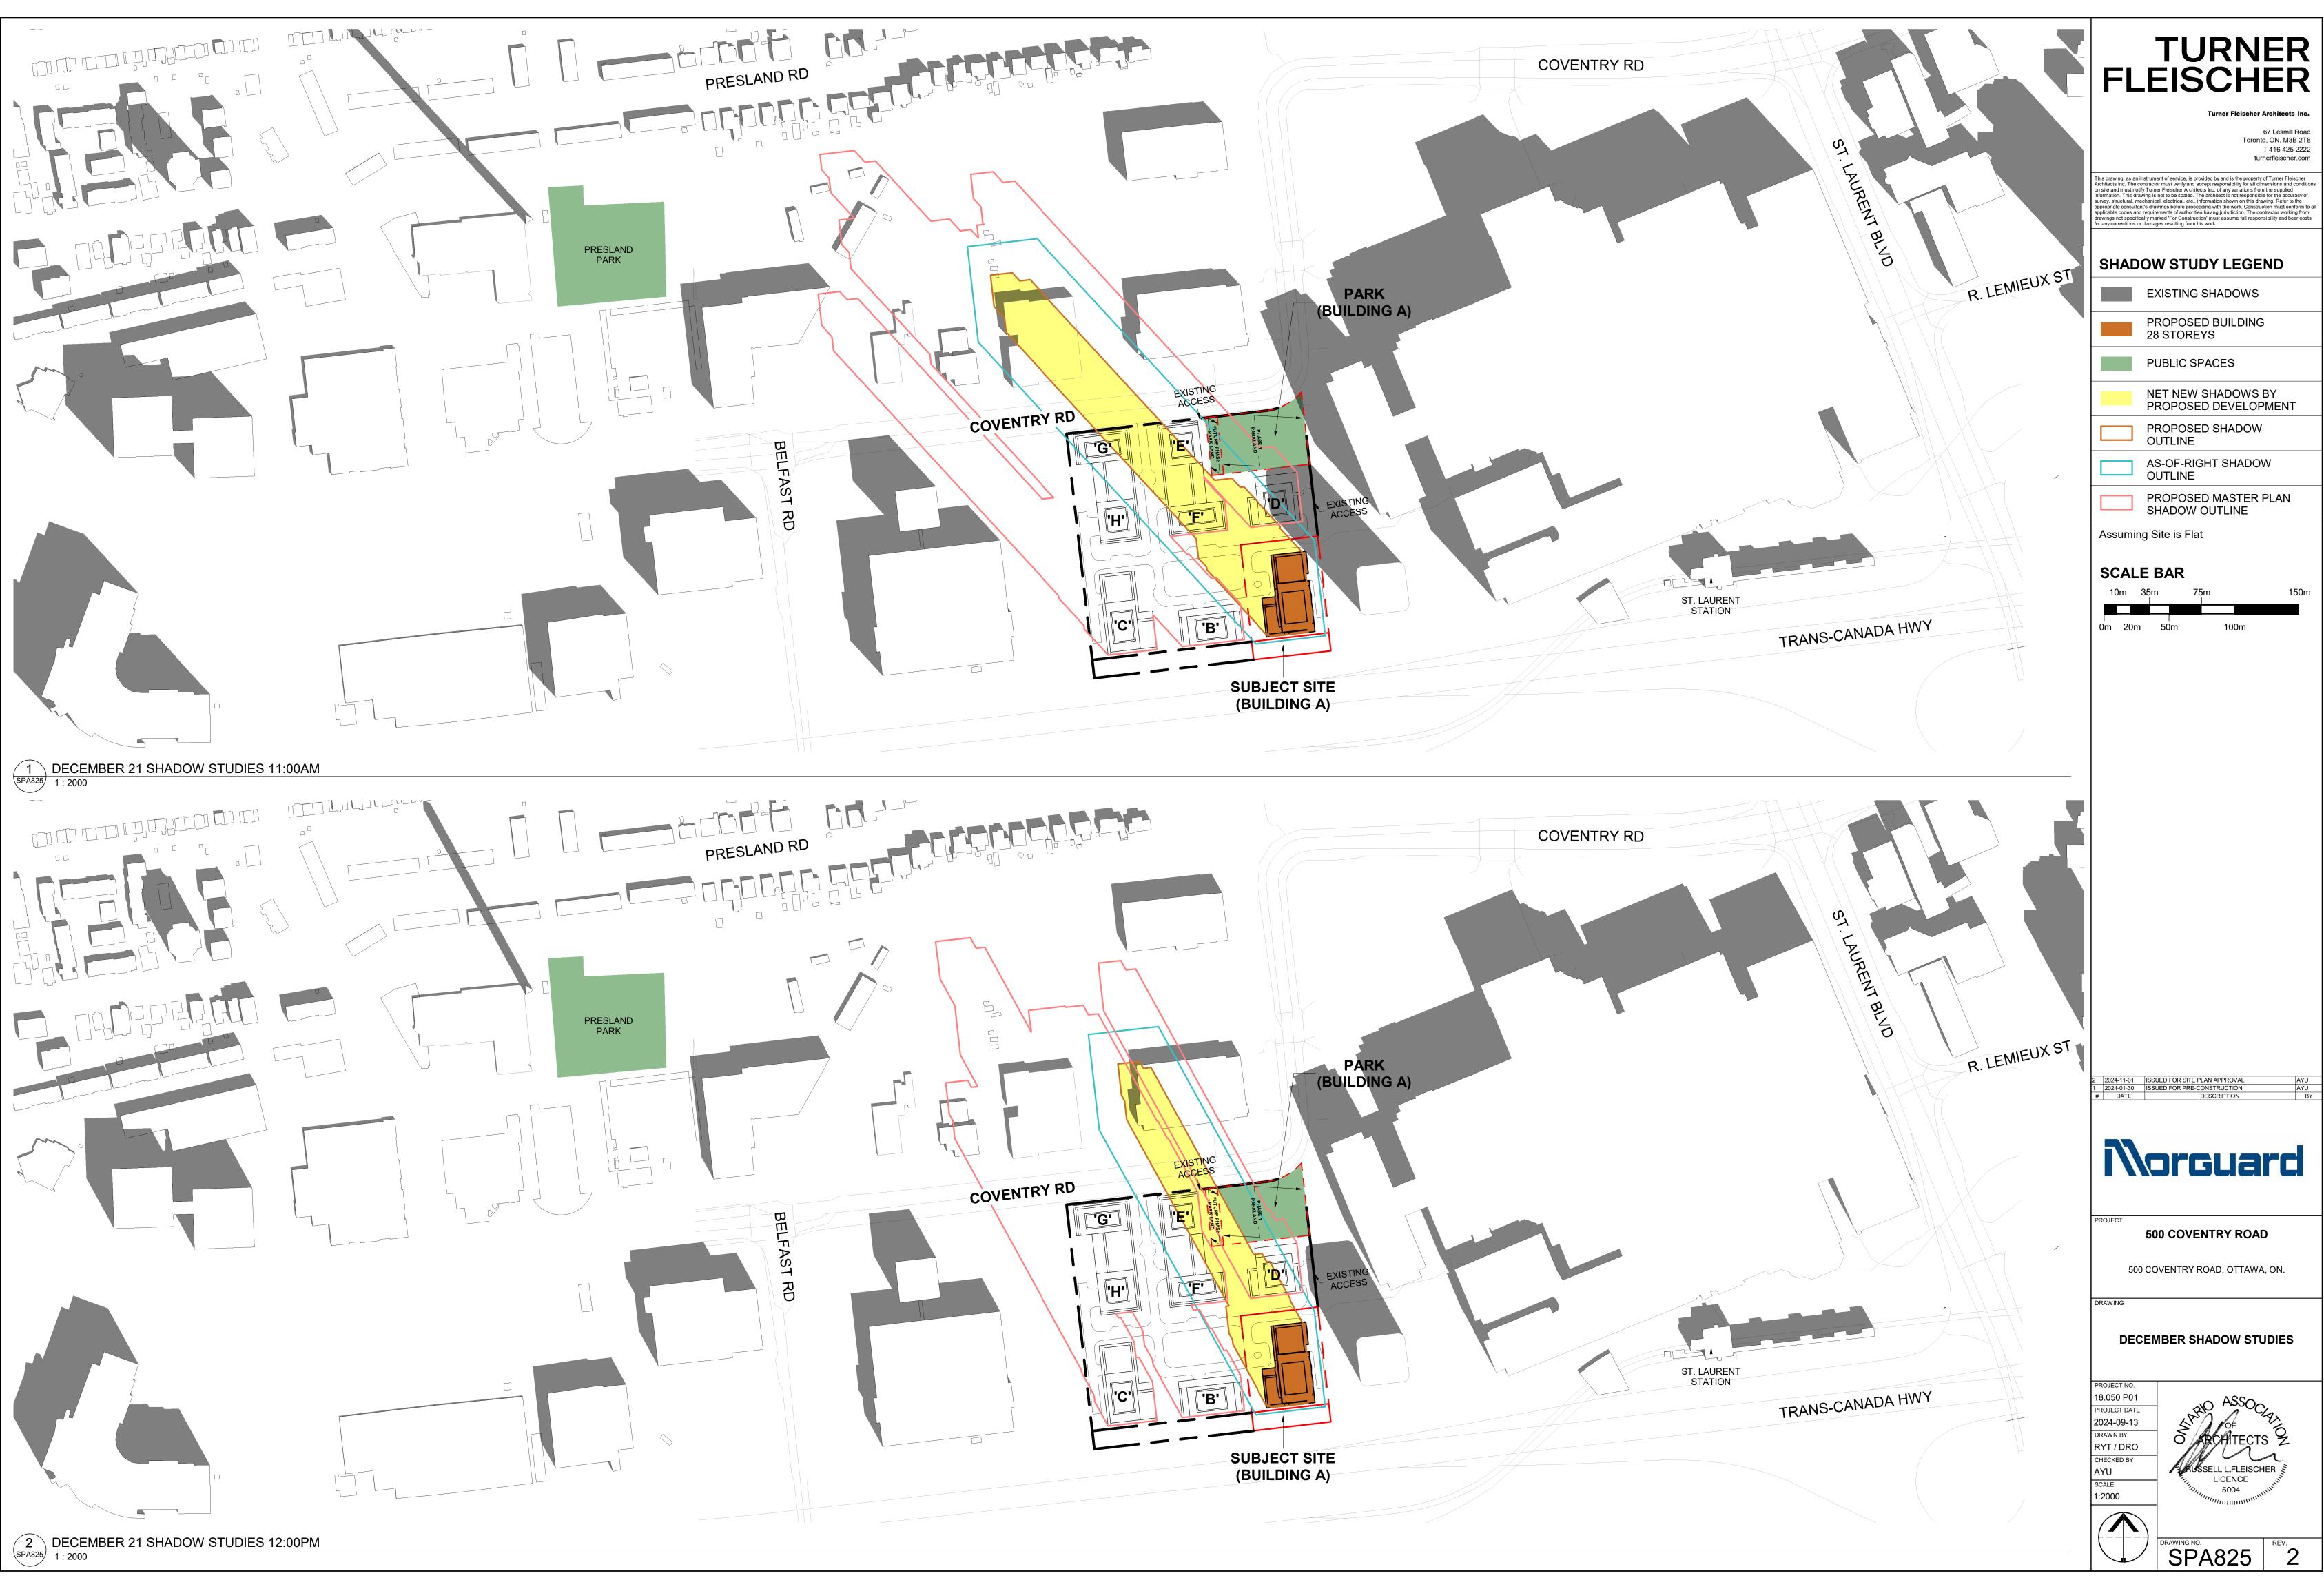

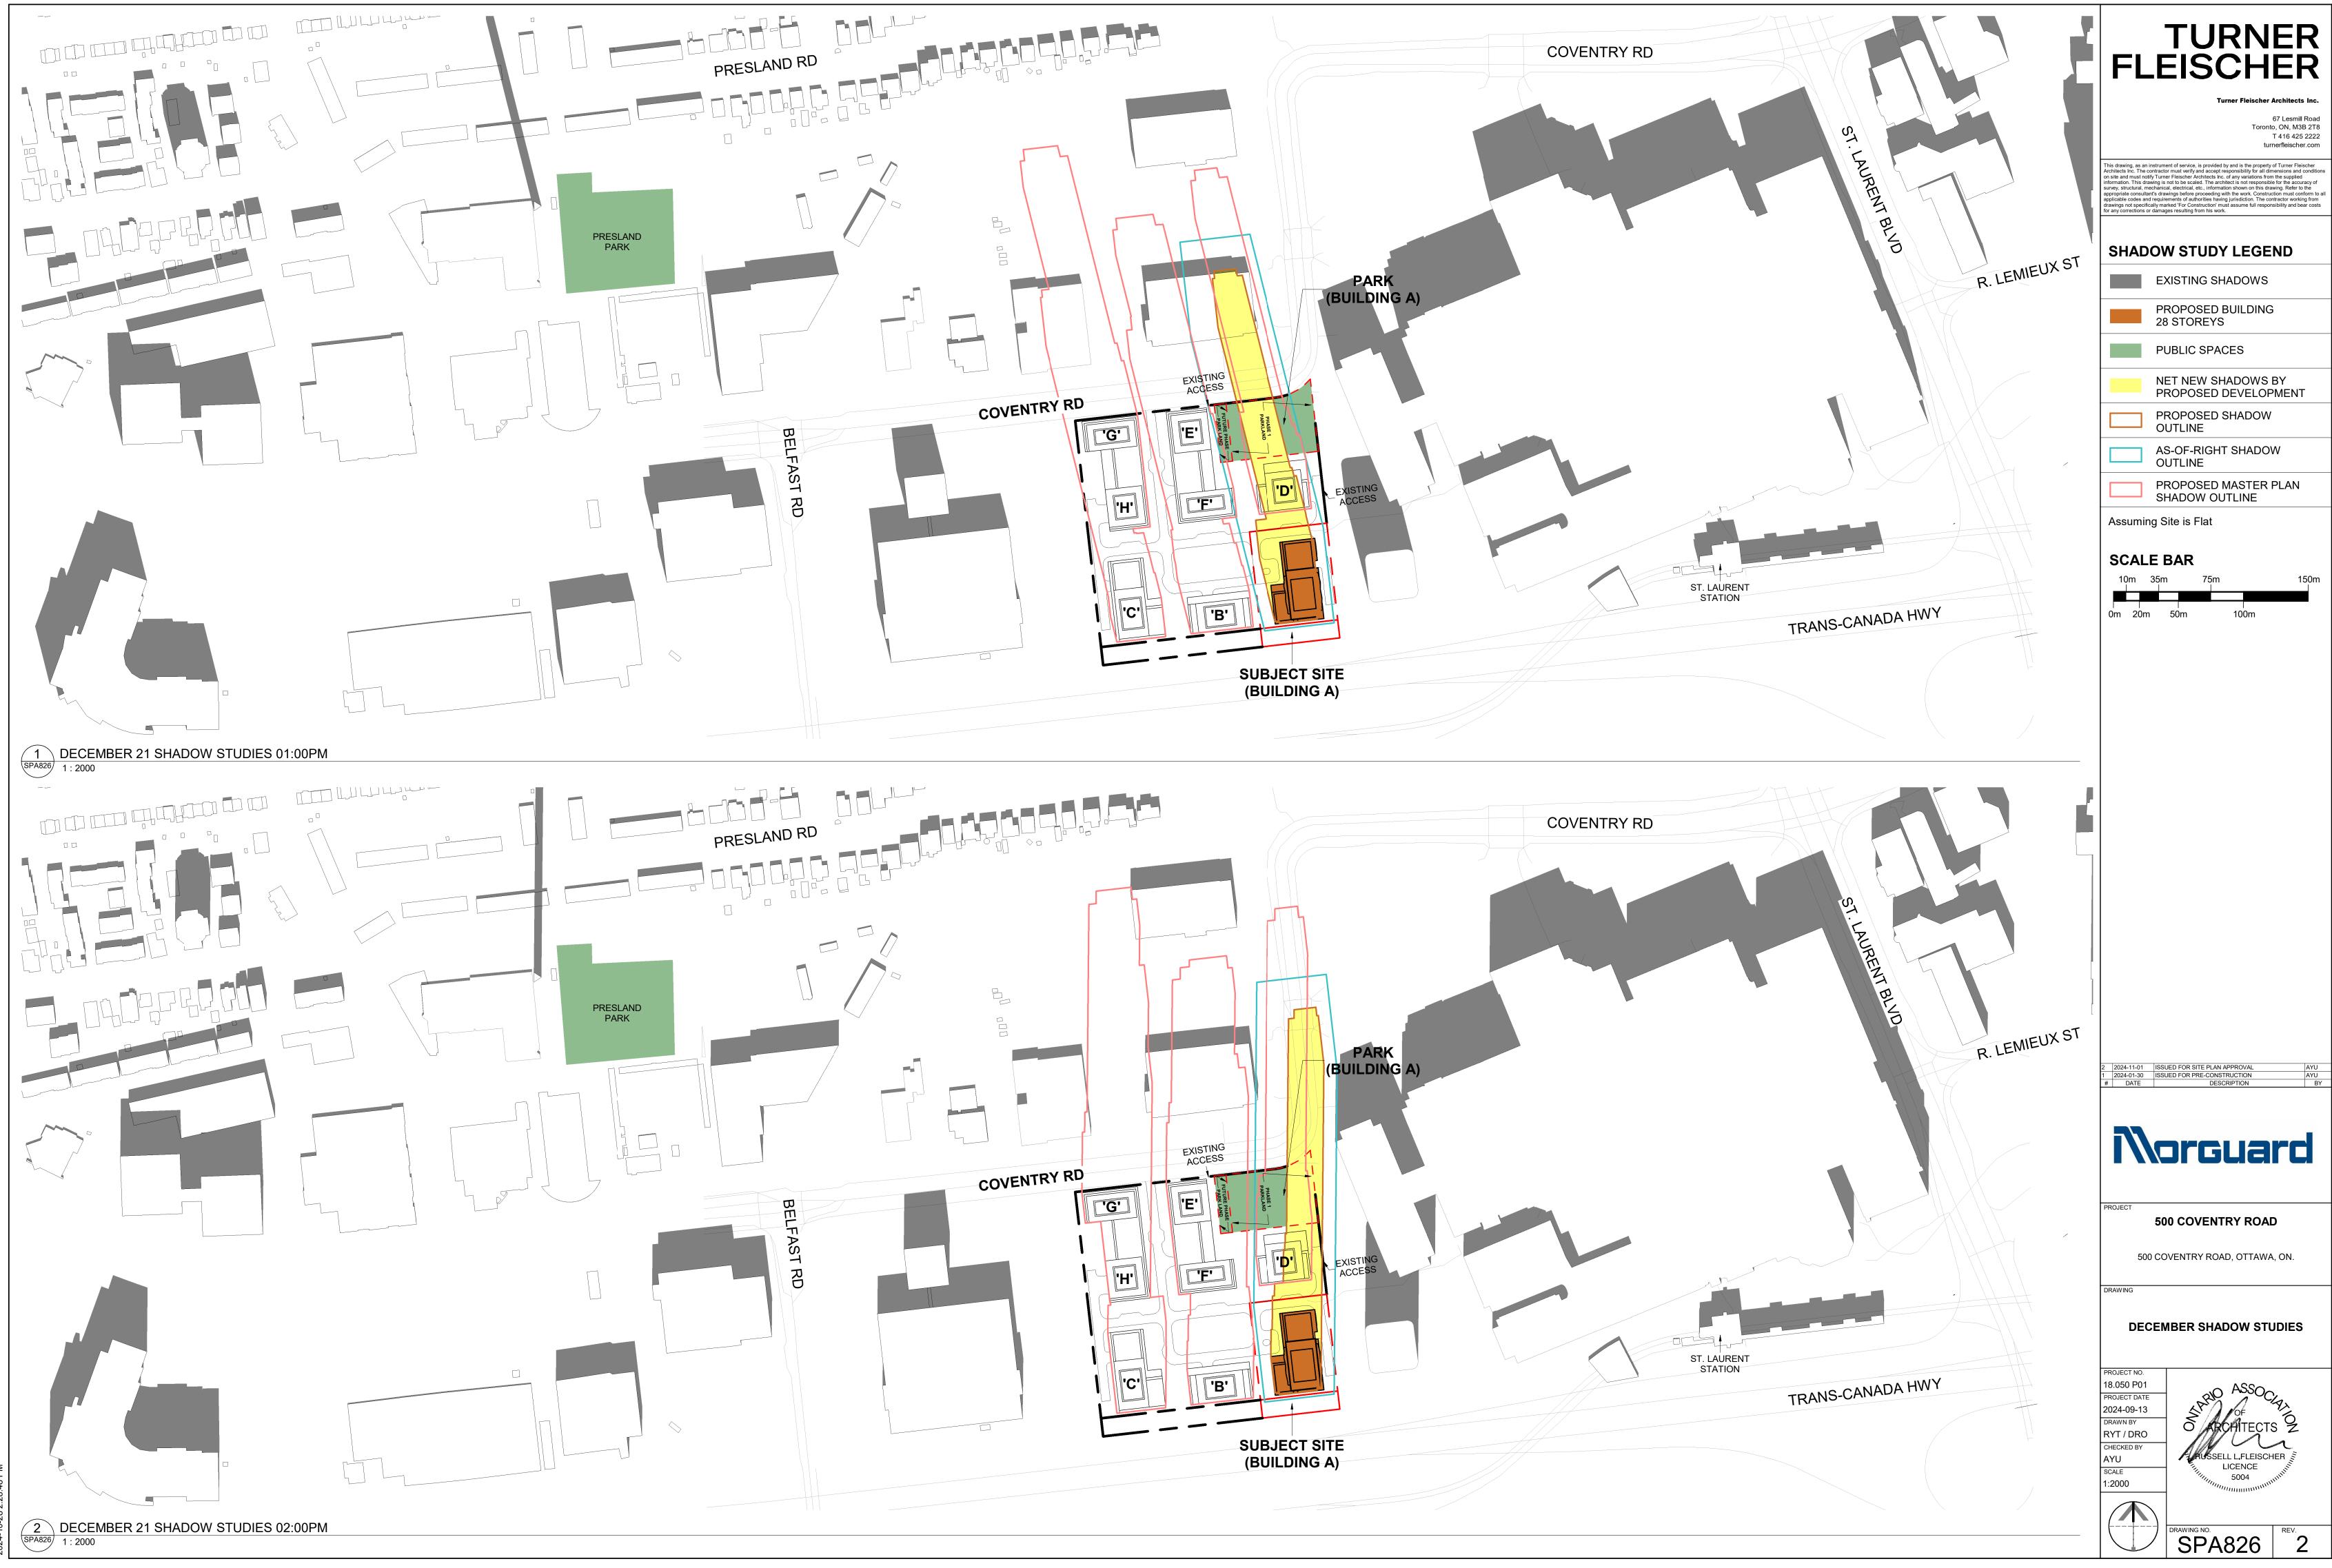







AYU AYU BY

#### 500 COVENTRY ROAD

500 COVENTRY ROAD, OTTAWA, ON.

DRAWING

DECEMBER SHADOW STUDIES

PROJECT NO. 18.050 P01 PROJECT DATE 2024-09-13 DRAWN BY RYT / DRO CHECKED BY AYU SCALE 1:2000



DRAWING NO. SPA827