

ASPHALT

—1.5m. HIGH—

±31500

3 m (10') HIGH ABOVE GROUND POSTS (6 POSTS)

WITH HEAVY DUTY EYELETS WELDED TO THE TOP OF THE POSTS FOR FUTURE SHADE SAIL

±20300

6700

CHAINLINK FENCE

TRIPLE HOOP

ASPHALT

\ ENLARGEMENT - KINDERGARTEN & DAYCARE PLAY AREA

L-01 Scale: 1:150

CHAINLINK FENCE

DAYCARE PLAY AREA

EN-1 ENLARGEMENT - BIKE RACK 1

4 BIKE RACKS - EQUIPARC EP5911-7; 30 BIKES

EN-2 ENLARGÊMENT - BIKE RACK 2

6 BIKE RACKS - EQUIPARC EP5911-7; 45 BIKES

L-01 Scale: NTS

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All general site information and conditions compiled from existing plans, surveys and consultant's field notes. Report all discrepancies prior to any work. No responsibility is born by the

.2 The location of the utilities is approximate only, and the exact location should be determined by consulting the municipal authorities and utility companies concerned. The Contractor shall prove the location of utilities and shall be responsible for adequate

construction. No deviations are to be made from the layouts as shown on this plan without prior consultation with the Landscape

.4 Obtain approval of Landscape Architect for granular base and layout of all pavement areas prior to construction.

.5 Stake planting locations and receive approval of Landscape Architect, prior to excavation of any planting pits. No substitutions of plant material shall be made without prior approval of the

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prior to sod being laid.

Maintain positive surface runoff through the entire

.10 Reinstate all areas and items damaged as a result of construction activities.



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	04		
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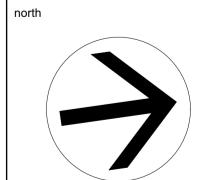
## N45 ARCHITECTURE INC.

tel. 613.224.0095

**Ruhland & Associates Ltd** landscape architecture • urban design • site planning

## East Urban Centre Elementary School

700 Spring Valley Dr, Ottawa, ON, K1W 0H2.



N45

EN-3 ENLARGEMENT - BIKE RACK 3

6 BIKE RACKS - EQUIPARC EP5911-7; 45 BIKES

L-01 Scale: NTS



drawing title LANDSCAPE PLAN


As Shown 2025-02-25 project number

L-01


RA 24-1743 CONTRACTOR TO VERIFY ALL DIMENSIONS AND revision NOTIFY THE ARCHITECT OF ANY DISCREPANCIES BEFORE WORK COMMENCES.

DO NOT SCALE DRAWINGS

19255

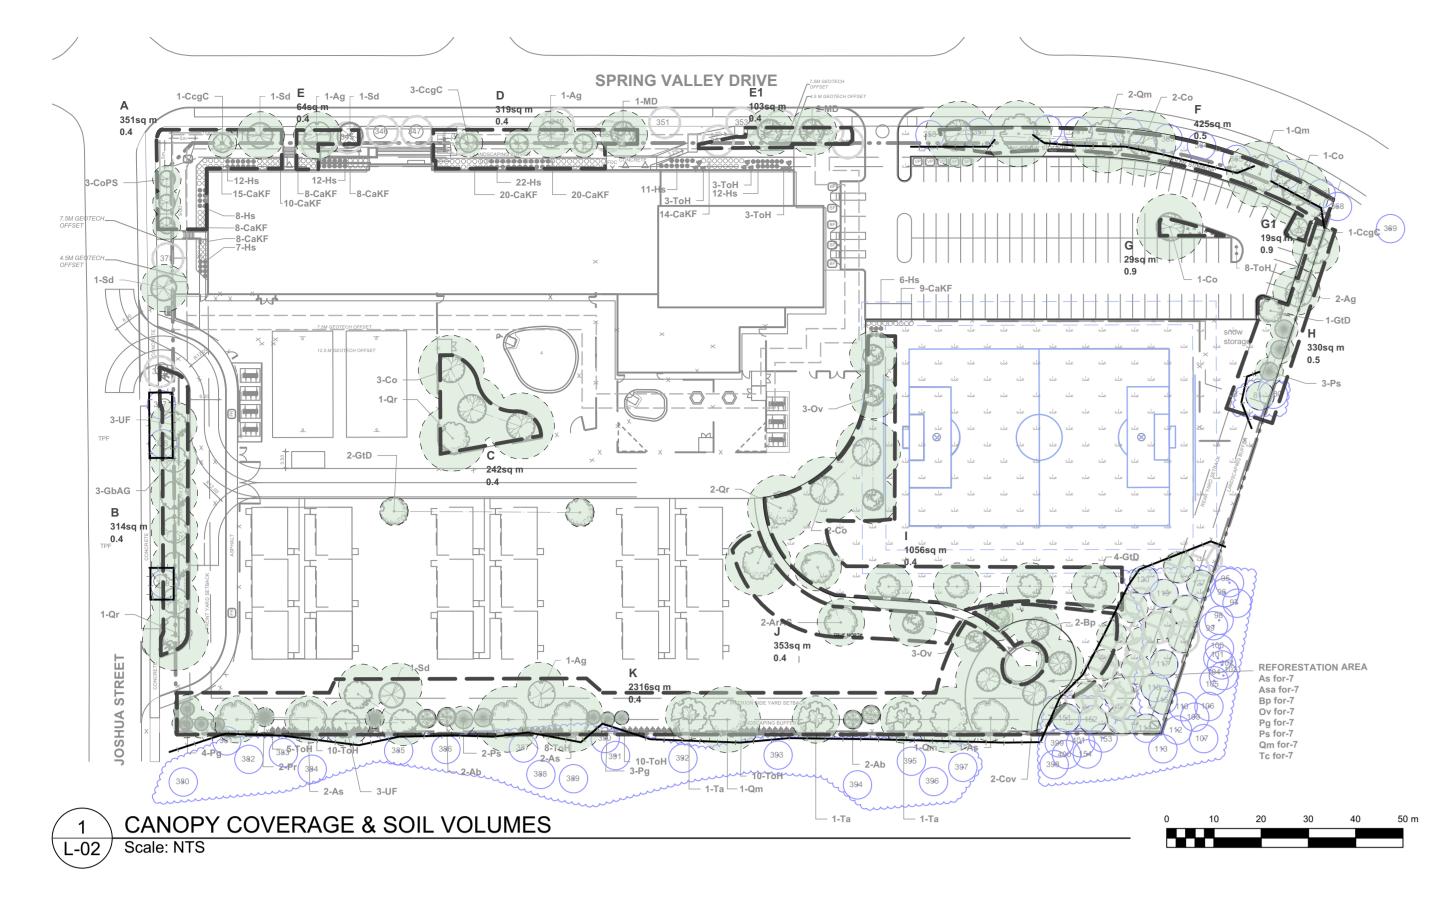

## **LEGEND**

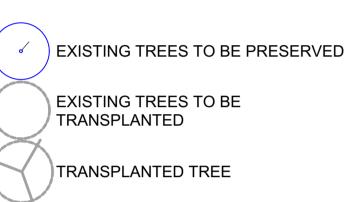

TREE CANOPY COVERAGE TOTAL CANOPY AREA 28345 TOTAL SITE AREA m2 PERCENT COVERAGE

TREE PROTECTION FENCE (TPF)

Betulus papyrifera

Ostrya virginiana

Picea glauca

Pinus strobus

7 Tsuga canadensis

Quercus macrocarpa

REFORESTATION PLANTING & DETAIL

PROPOSED PLANTING

OTTAWA Design Soil | Soil Adequacy Target Soil Soil Volume Area, Tree Quantity and Size Tree Quantity Volume percentage Volume (m<sup>3</sup>) contractor 1 Medium, 1 Small, 3 L - Columnar Trees SEE NOTE 87.0 140.4 161% plant bed (351 sq m x 0.4 ave metre deep) AREA B - 1 Large, 6 Medium, 2 Ex. Trees SEE NOTE 144.0 125.6 plant bed (314 sq m x 0.4 ave metre deep) AREA C - 4 Large Trees SEE NOTE plant bed (242 sq m x 0.4 ave metre deep) 72.0 134% AREA D - 3 Small, 2 Medium Trees SEE NOTE plant bed (319 sq m x 0.4 ave metre deep) 66.0 127.6 193% 1 Medium Tree AREA E -SEE NOTE plant bed (61 sq m x 0.7 ave metre deep) 36.0 42.7 119% AREA E1 - 2 Medium Trees SEE NOTE plant bed (103 sq m x 0.4 ave metre deep) 36.0 114% 41.2 AREA F - 6 Large, 3 Ex. Trees SEE NOTE 108.0 plant bed (425 sq m x 0.4 ave metre deep) 170.0 157% AREA G - 1 Large Tree SEE NOTE plant bed (29.5 sq m x 1.2ave metre deep) 30.0 35.4 118% AREA G1 - 1 Small Tree SEE NOTE plant bed (19 sq m x 1.1ave metre deep) 25.0 20.9 3 Medium Trees, 3 Conifers SEE NOTE Dantback (370 sent x 0.4ave metre deep) 132.0 122% 108.0 3 Large, 8 Medium Trees
---Qty--- Botanical name SEE NOTE Remark Sched. size Common name plant bed (1056 sq m + 0.4 ave metre deep) 422.4 198.0 Caliper Trees 1 Large, 2 Medium Trees SEE NOTE Balsam Fir 54.0 plant bed (3ին sonmit of have a metre deep) 200 €₱1%t AREAK - 7 8Hiargeg13 Medium Trees, 13 Con. 200 cm ht plant bed (2316 sq mus 0 4 ave metre deep) 926.4 2Red Pine 504.0 P's Smaller cotumnar trees with growth to 8-15 բրց թեր երաթեր and columnar configors cm ht. WB, Staked calculated using 'How much soil to grow a big tree' by DeepRoot as a guide Potted 60 Thuja occidentalis 'Holmstrup' 125cm ht Holmstrup Cedar Perennials Ornamental Oats 3 year Potted 90 Helictrochon semperverens 120 Calamagrostis x acutiflora 'Karl Foerster' Feather Reed Grass Potted 3 year **Reforestation Trees** Sugar Maple 150 cm ht. Bare root Acer saccharum Acer rubrum Red Maple 150 cm ht. Bare root Asa for ∣

White Birch

White Spruce

Canadian Hemlock

White Pine

Bur Oak

American Hophornbeam

150 cm ht.

150 cm ht.

75 cm ht.

50 cm ht.

75 cm ht.

150 cm ht.

Bare root

Bare root

Bare root

Potted

Potted

#### PLANTING MEDIUM REQUIREMENTS FOR TREE PLANTING

#### .1 WHERE SOIL VOLUMES ARE WITHIN EXCAVATED DEVELOPMENT AREA:

PROVIDE 100% PLANTING MEDIUM TO DEPTHS INDICATED IN SOIL VOLUME CHART. WHERE SUBSOIL BELOW THE INDICATED DEPTH OF PLANTING MEDIUM IS NOT CONDUCIVE TO PLANT GROWTH, REPLACE WITH APPROVED SUBSOIL TO A FURTHER DEPTH OF 300mm.

## .2 WHERE SOIL VOLUMES INCLUDE SOIL VOLUMES IN R.O.W. AT PROPERTY LINE

R.O.W. AND WITHIN SUBJECT PROPERTY: ASSUME ALL SOIL VOLUME REQUIREMENTS ARE MET WITHIN THE R.O.W. AREA. REINSTATE ANY DISTURBED AREAS IN R.O.W. OUTSIDE THE 2m RADIUS TREE PITS WITH 100-150mm TOPSOIL AND

PLACE PLANTING MEDIUM (TO DEPTH INDICATED ON SOIL VOLUME CHART) AT ALL DISTURBED AREAS WHERE EXISTING SOILS ARE REMOVED, OR WHERE EXISTING SOILS ARE NOT CONDUCIVE TO PLANT GROWTH.

ADDITIONAL PLANTING MEDIUM IS NOT REQUIRED WHERE EXISTING SOIL IS PRESENT IN OR ADJACENT TO THE R.O.W. THIS DOES NOT INCLUDE TOPSOIL REQUIRED FOR SODDING. WHERE SUBSOIL BELOW THE INDICATED DEPTH OF PLANTING MEDIUM IS NOT CONDUCIVE TO PLANT GROWTH, REPLACE WITH APPROVED SUBSOIL TO A FURTHER DEPTH OF 300mm.

BASE CONTRACT TO ASSUME SUBSOIL IS CONDUCIVE TO PLANT GROWTH.

## WHERE SOIL VOLUMES INCLUDE SOIL VOLUMES ON ADJACENT PROPERTY AT

ADJACENT PROPERTY AND WITHIN SUBJECT PROPERTY: ASSUME ALL SOIL VOLUME REQUIREMENTS ARE MET WITHIN THE ADJACENT PROPERTY AREA. REINSTATE ANY DISTURBED AREAS ON ADJACENT PROPERTY OUTSIDE THE 2m RADIUS TREE PITS WITH 100-150mm TOPSOIL AND SOD.

PLACE PLANTING MEDIUM (TO DEPTH INDICATED ON SOIL VOLUME CHART) AT ALL DISTURBED AREAS WHERE EXISTING SOILS ARE REMOVED, OR WHERE EXISTING SOILS ARE NOT CONDUCIVE

ADJACENT TO THE ADJACENT PROPERTY. THIS DOES NOT INCLUDE TOPSOIL REQUIRED FOR

ADDITIONAL PLANTING MEDIUM IS NOT REQUIRED WHERE EXISTING SOIL IS PRESENT IN OR

WHERE SUBSOIL BELOW THE INDICATED DEPTH OF PLANTING MEDIUM IS NOT CONDUCIVE TO PLANT GROWTH, REPLACE WITH APPROVED SUBSOIL TO A FURTHER DEPTH OF 300mm.


#### .4 AREAS NEAR SOCCER FIELD AND OUTDOOR CLASSROOM

BASE CONTRACT TO ASSUME SUBSOIL IS CONDUCIVE TO PLANT GROWTH.


ASSUME ALL SOIL VOLUME REQUIREMENTS ARE MET, REINSTATE ANY DISTURBED AREAS ON ADJACENT PROPERTY OUTSIDE THE 2m RADIUS TREE PITS WITH 100-150mm TOPSOIL AND SOD. ADDITIONAL PLANTING MEDIUM IS NOT REQUIRED WHERE EXISTING SOIL IS PRESENT IN OR ADJACENT TO THE ADJACENT PROPERTY. THIS DOES NOT INCLUDE TOPSOIL REQUIRED FOR

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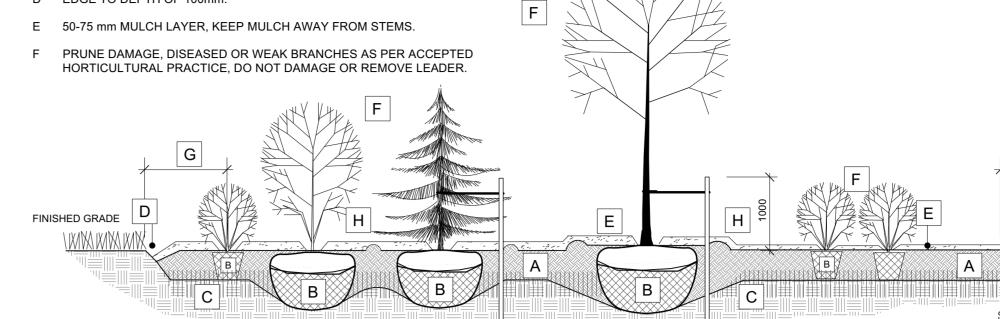
TREE & PERENNIAL PLANTING IN CURBED PLANTER

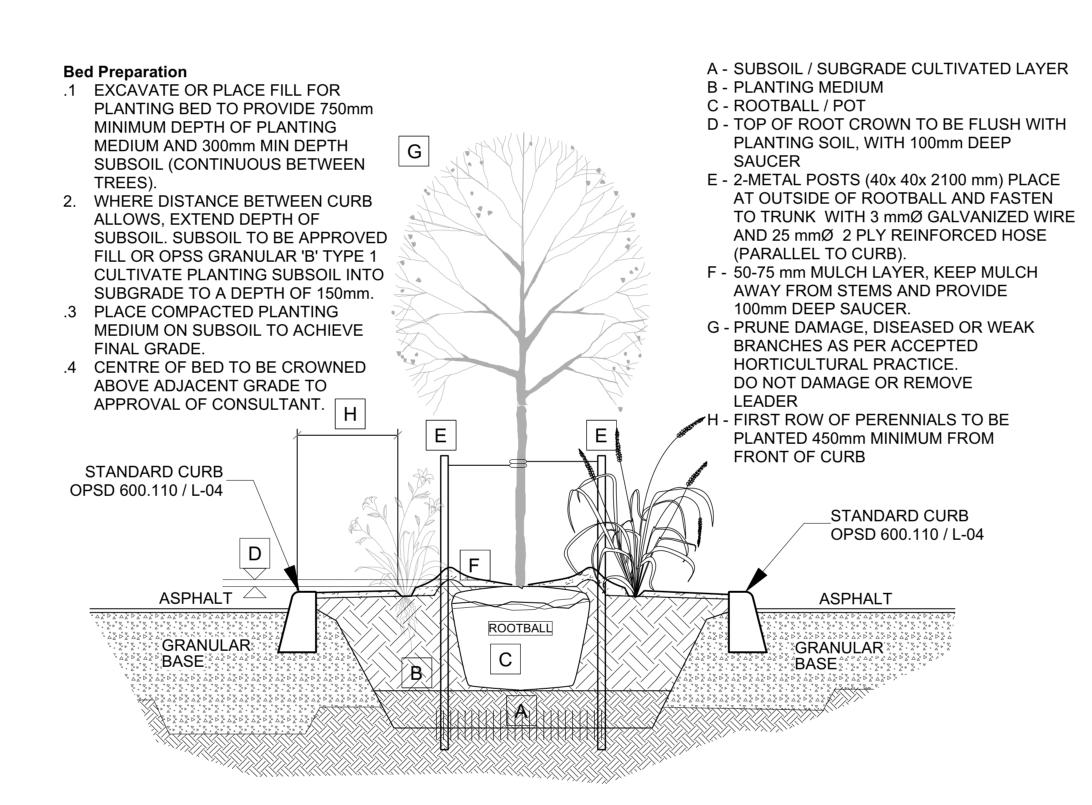

A 450mm COMPACTED PLANTING MEDIUM, DEEPEN AT TREES

B ROOTBALL, TOP OF ROOT CROWN TO BE FLUSH WITH PLANTING SOIL

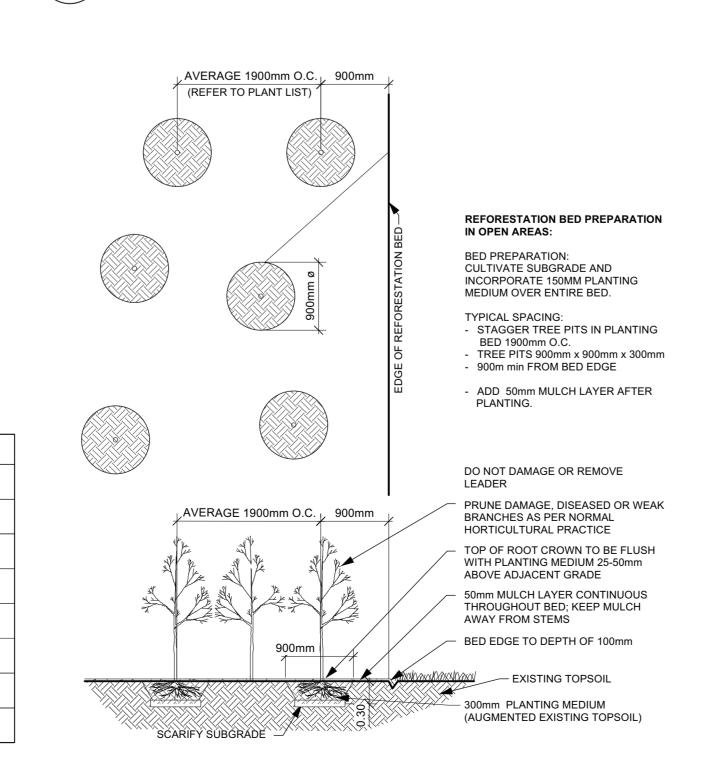- AND 50mm ABOVE SOIL OUTSIDE PLANTING PIT / POT.
- C 350mm PLANTING MEDIUM / SUBSOIL CULTIVATED LAYER. CULTIVATE AT TREE PIT BOTTOM. SEE NOTE BELOW.
- D EDGE TO DEPTH OF 100mm.



BED PREPARATION

- .1 EXCAVATE OR PLACE FILL FOR PLANTING BED TO PROVIDE 450mm MINIMUM DEPTH OF PLANTING MEDIUM. PLANTING BED TO BE DEEPENED AT TREE LOCATIONS. IF BASE OF PIT IS OVER EXCAVATED, RAISE BOTTOM TO PROPER LEVEL WITH COMPACTED PLANTING
- .2 PLACE 150mm PLANTING MEDIUM ON SUBGRADE AND CULTIVATE INTO TOP 200mm OF SUBSOIL. SEE NOTE BELOW.
- .3 PLACE REMAINDER OF PLANTING MEDIUM OVER CULTIVATED PORTION TO ACHIEVE FINAL GRADE. .4 CENTRE OF BED TO BE CROWNED ABOVE ADJACENT GRADE TO
- APPROVAL OF CONSULTANT. .5 ENSURE POSITIVE DRAINAGE AWAY FROM BUILDING WALLS WHERE APPLICABLE.
- 1 CUT AND REMOVE TOP 2/3 OF BURLAP AND WIRE BASKET FROM ROOTBALL. PLACE 1-METAL POST (40 x 40 x 2100 mm) AT OUTSIDE OF ROOTBALL ON THE PREVAILING WIND SIDE AND FASTEN TO TRUNK WITH APPROVED WATER THOROUGHLY SUBSEQUENT TO PLANTING AND THROUGHUT THE WARRANTY PERIOD.

G FIRST ROW OF PERENNIALS TO BE PLANTED 600mm FROM EDGE OF BED/CURB

H PROVIDE 150 mm DEEP SAUCER AT TREES

FIRST ROW OF SHRUBS TO BE PLANTED 900mm FROM EDGE OF BED/CURB


.5 INSTALL RODENT GUARD AND PROTECT TREE FROM RODENT DAMAGE. .6 REMOVE TREE RINGS, STAKES AND TRUNK WRAPPING AFTER WARRANTY


.4 WRAP TREE TRUNK AFTER INSPECTION OF TREES BY LANDSCAPE

ENSURE THAT ALL TREES MEET THEIR REQUIRED SETBACKS WHEN PLANTED AS PER CITY'S TREE PLANTING GUIDELINE (2006). DECIDUOUS SPECIES SHALL BE A MINIMUM 1.5 METERS AND CONIFEROUS SPECIES SHALL BE A MINIMUM OF 4.5 METER FROM ROADWAY, DRIVEWAY, SIDEWALK.

**PLANTING DETAIL** L-02 / Scale: NTS

NOTES: - PLANTING BED AREAS EXCAVATED TO 500mm BELOW FINAL GRADE FOR ROUGH GRADE. REFER TO PLANT LIST FOR PLANT SPACING.

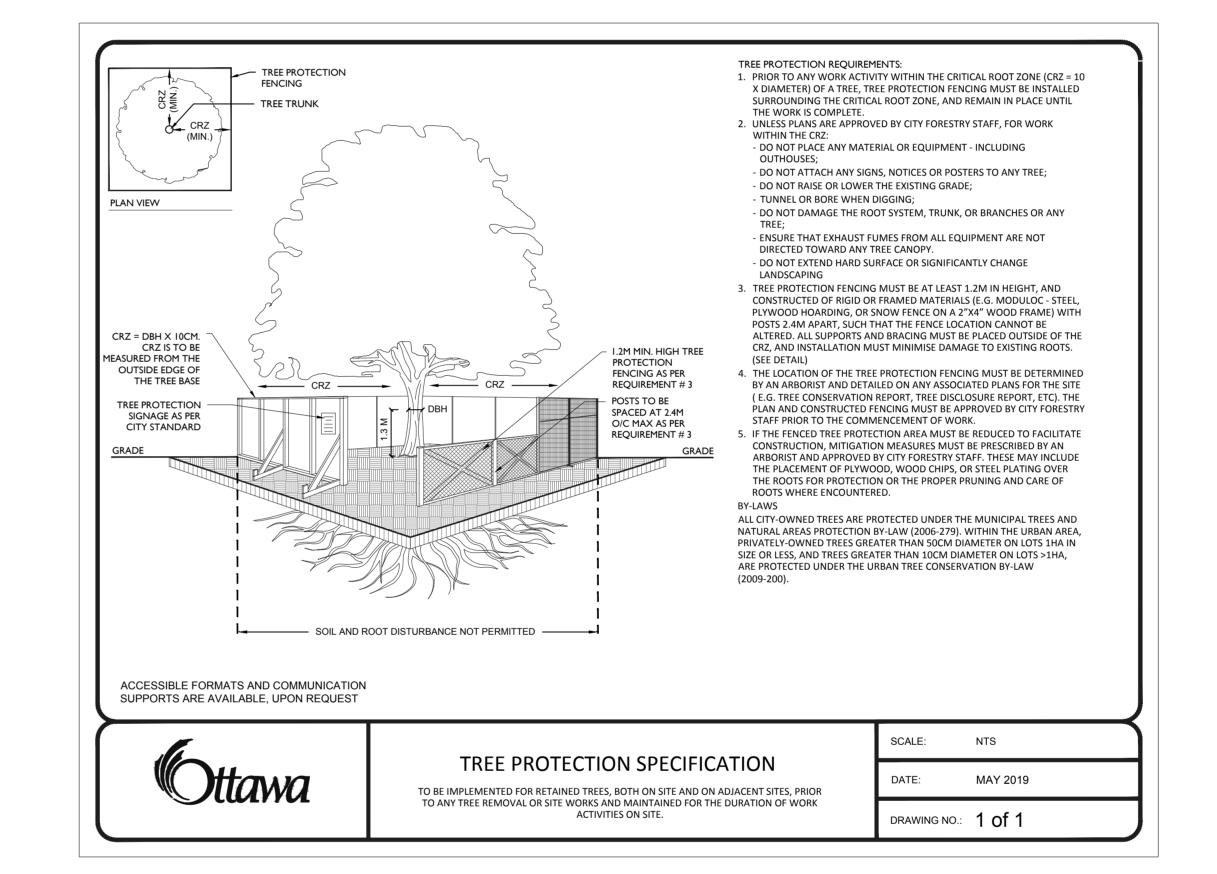

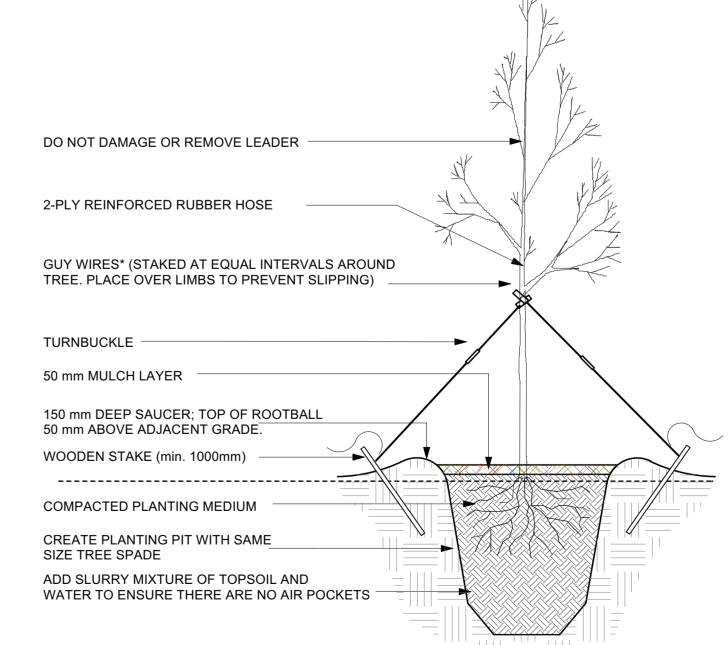

- 1. FERTILIZE TREES AFTER PLANTING WATER THOROUGHLY SUBSEQUENT TO PLANTING.
- 3. WRAP TREE TRUNK FOR PROTECTION FROM CLIMATIC CONDITIONS.
- 4. PROTECT TREE FROM RODENT DAMAGE. 5. REMOVE TREE RING AND STAKE(S) AFTER ONE YEAR
- FOR TREES UP TO 150mmø: PROVIDE 3 GUY WIRES OF 3mmø, FOR TREES OVER 150mmø PROVIDE 3 GUY WIRES CONSISTING EACH OF 3 WIRES OF 4mmø TWISTED TOGETHER.

TREE TRANSPLANTING DETAIL L-02 Scale: NTS



#### GENERAL NOTES

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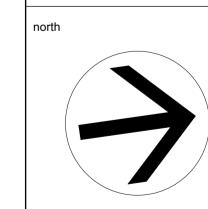
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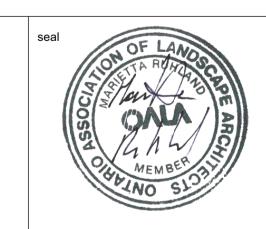
#### **Ruhland & Associates Ltd** landscape architecture • urban design • site planning

Ph 613-224-4744 Fx 613-224-1131

**East Urban Centre Elementary School** 700 Spring Valley Dr, Ottawa, ON, K1W 0H2.



N45



drawing title LANDSCAPE SOIL **VOLUMES / DETAILS** 

As Shown checked by 2025-02-25

project number drawing number


L-02


RA 24-1743


CONTRACTOR TO VERIFY ALL DIMENSIONS AND | revision NOTIFY THE ARCHITECT OF ANY DISCREPANCIES BEFORE WORK COMMENCES.


DO NOT SCALE DRAWINGS


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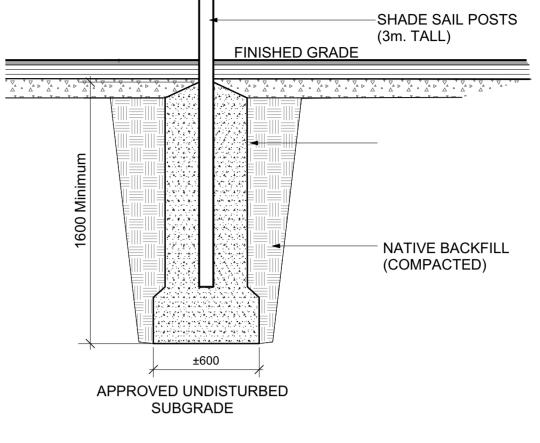


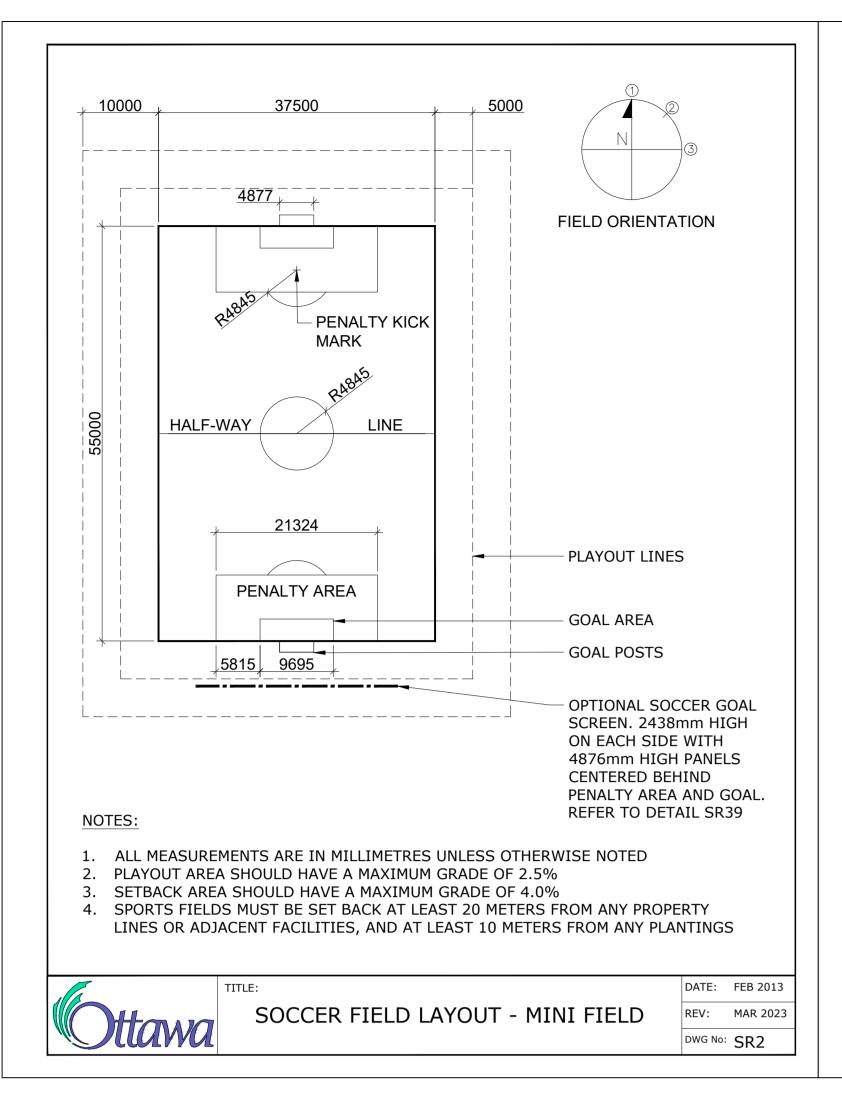

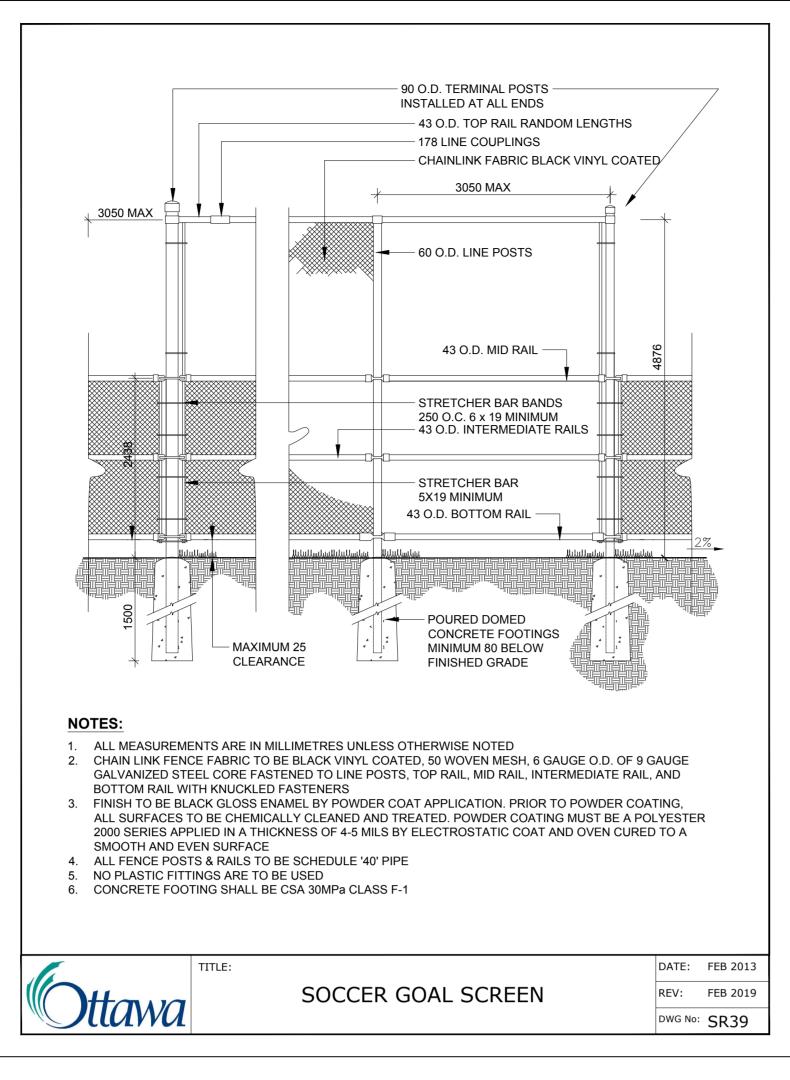

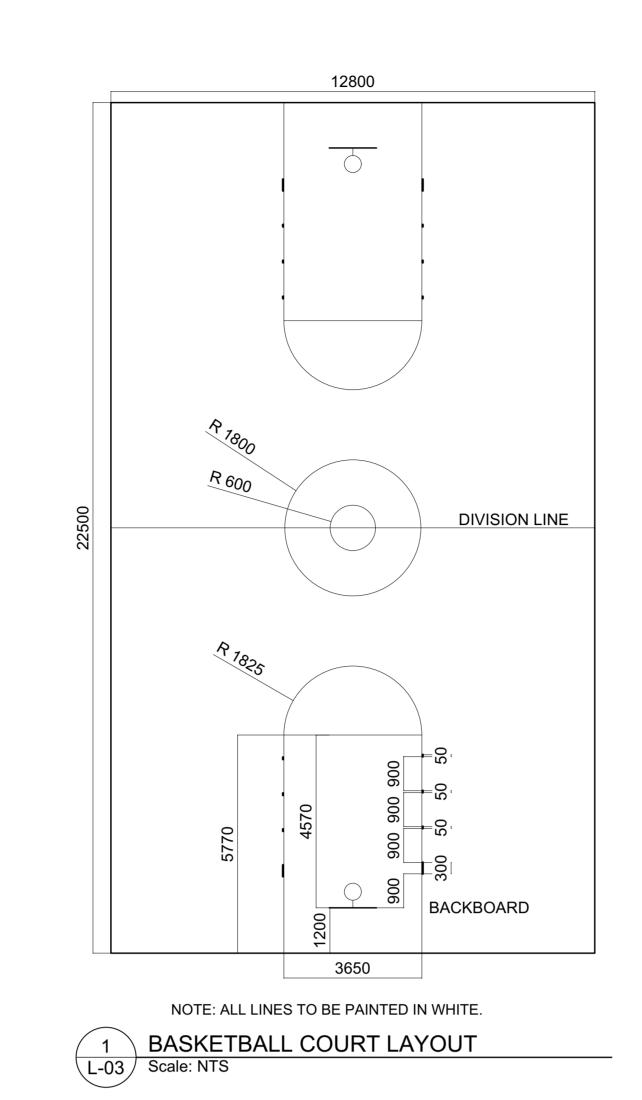

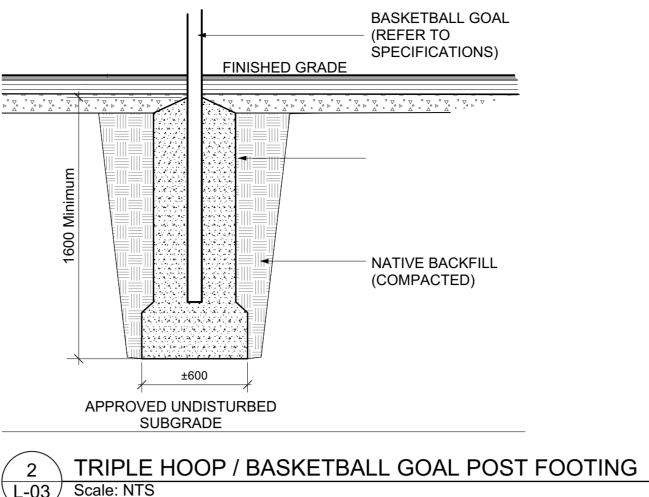S3 SOCCER GOAL POST FOOTING
L-03 Scale: NTS

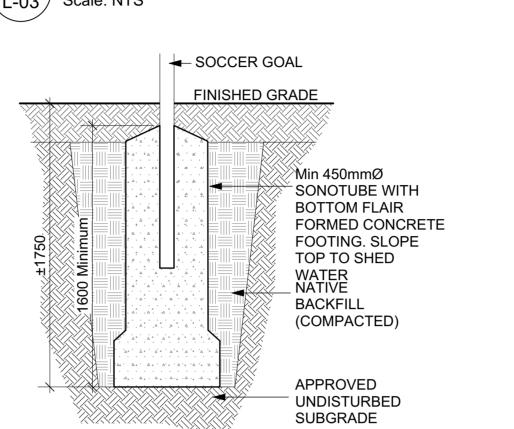

POST HEIGHT ABOVE GROUND: 3 m. (10'); HEAVY DUTY EYELET WELDED TO THE TOP OF THE POSTS FOR FUTURE SHADE SAIL. CONTRACTOR TO PROVIDE SHOP DRAWINGS / PRODUCT DATA SHEET OF THE EYELET FOR SHADE SAIL. SHADE SAIL IS NOT PART OF THE

SHADE SAIL POST FOOTING L-03 Scale: NTS

THIS DETAIL IS FOR DESIGN INTENT ONLY; CONTRACTOR TO SUBMIT COMPLETE SHOP DRAWINGS REVIEWED AND STAMPED BY A PROFESSIONAL ENGINEER LICENSED IN THE PROVINCE OF ONTARIO.

S1 SOCCER FIELD LAYOUT L-03 Scale: NTS

100mm WIDE YELLOW PAINTED

WARNING STRIP

**PLAN** 

D8 ACCESSIBLE ASPHALT RAMP
L-03 Scale: NTS

BLACK VINYL COATED

CHAINLINK FENCE

EXTEND ASPHALT

TOPSOIL AND SOD\_

FINISHED GRADE

OR PLANTING

300mm min. FROM FENCE

**BOTTOM RAIL-**



- APPROXIMATE EDGE OF SAFETY SURFACING

-SAFETY SURFACING

-ASPHALT LIP

TO EDGE OF

ASPHALT LIP


STANDARD FENCE PANEL

3000 o.c. typ.

SLOPE


LEVEL

ROLLED EDGE

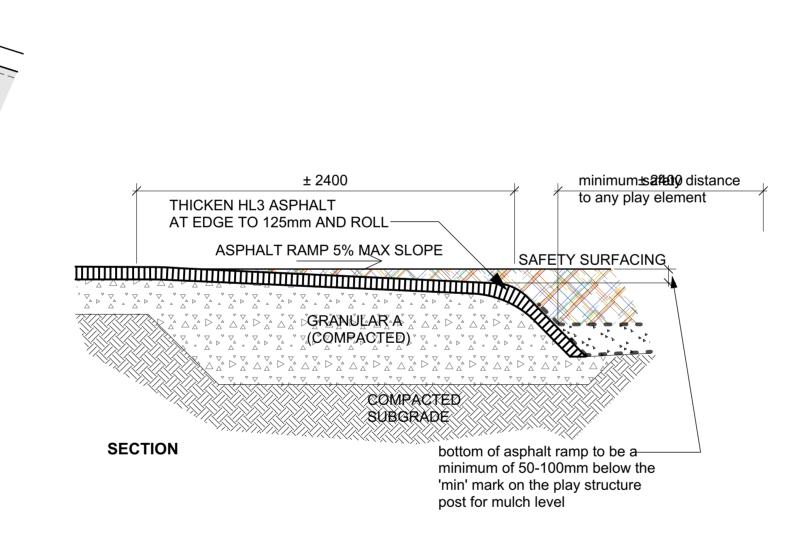


MIDRAIL / CROSSBRACE AT CORNERS AND END

SECTIONS

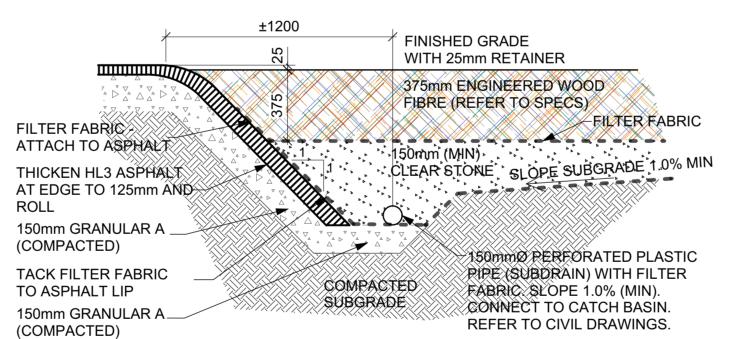

L-03 Scale: NTS




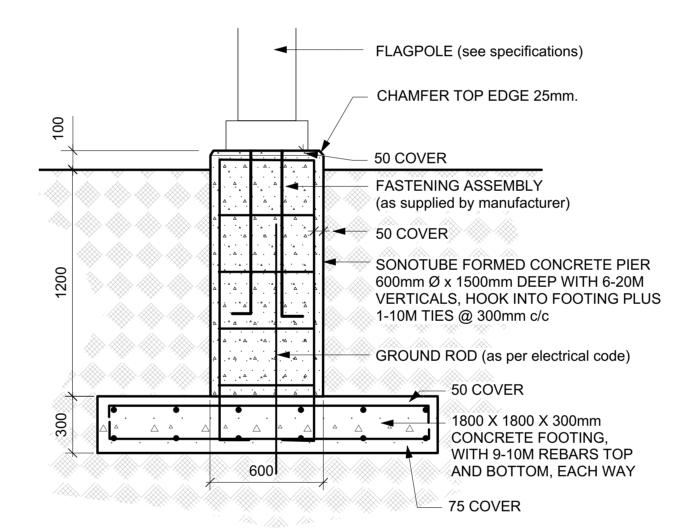


• CONCRETE IN PIER TO BE CLASS C-2 (32MPa, AIR 5-8%). • CONCRETE IN FOOTING TO BE 25MPa. • ALL EXPOSED SURFACES TO BE LIGHTLY SANDBLASTED. • ALL REBARS TO BE EPOXY COATED. • INSTALL FLAGPOLE AS PER MANUFACTURER'S SPECIFICATIONS

**TLAGPOLE BASE** L-03 Scale: NTS

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OTTAWA - CARLETON

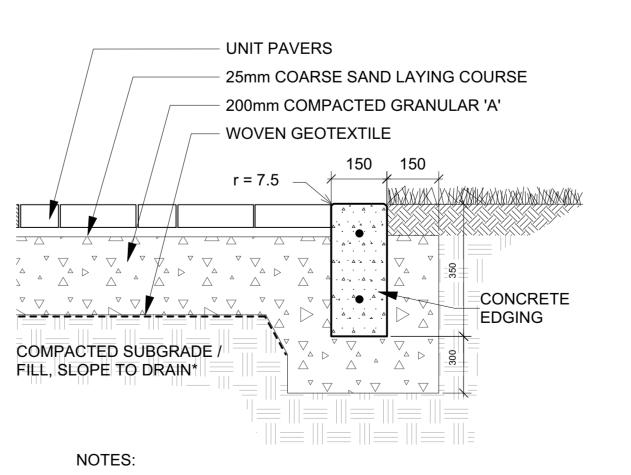DISTRICT SCHOOL BOARD
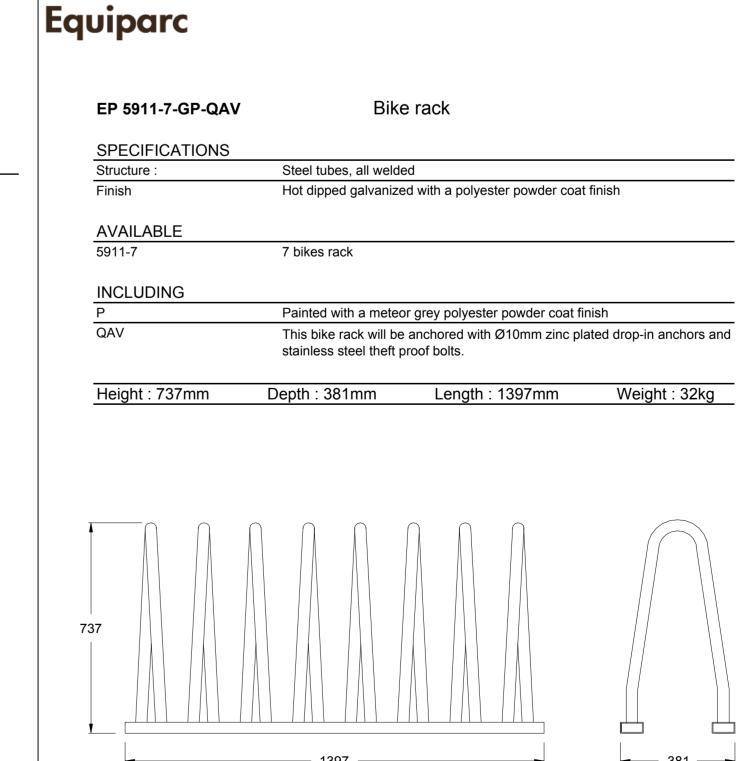
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GENERAL NOTES

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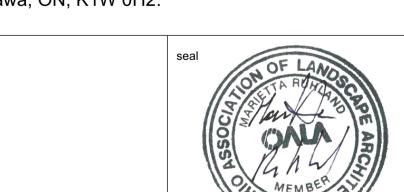
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fax 613.224.9811

drawing title LANDSCAPE DETAILS

As Shown 2025-02-25 project number

N45


drawing number L-03


RA **24-1743** 

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19255

EXPANSION JOINT SPACING MAX. 4.0m x 10mm WIDE, FILLED **FOOTINGS** - ASPHALT PAVEMENT Confidential information contained herein is the property of Equiparc. Intended use is limited to professionals specifying Equiparc's products and UNILOCK PROMENADE PAVER PATTERN 'G' WITH APPROVED NON-EXTRUDING PRE-MOULDED FIBRE (REFER TO SPECS) AND BASE their direct clients. All information is not to be copied or disclosed to others without the written consent of Equiparc. All rights reserved - Equiparc BOARD. 2-15M REBARS DOWELS AT EXPANSION JOINTS. 40% - 8X24 Manufacturier d'Equipement de Parcs 40% - 4X16 T: 1 800 363.9264 \* GEOTECHNICAL CONSULTANT TO APPROVE SUBBASE / www.equiparc.com 1001, rue James-Brodie F: 1866 346.2538 20% - 4X12 info@equiparc.com Saint-Jean-sur-Richelieu, QC Canada J2X 0C1 **PAVING PATTERN** FILL MATERIAL L-03 Scale: NTS D5 CHAINLINK FENCE
L-03 Scale: NTS D4 BIKE RACK - EQUIPARC EP 5911 D2 PRECAST UNIT PAVERS NOTE: PAVING PATTERN ROWS TO BE PERPENDICULAR TO PATH OF TRAVEL L-03 Scale: NTS L-03 Scale: NTS




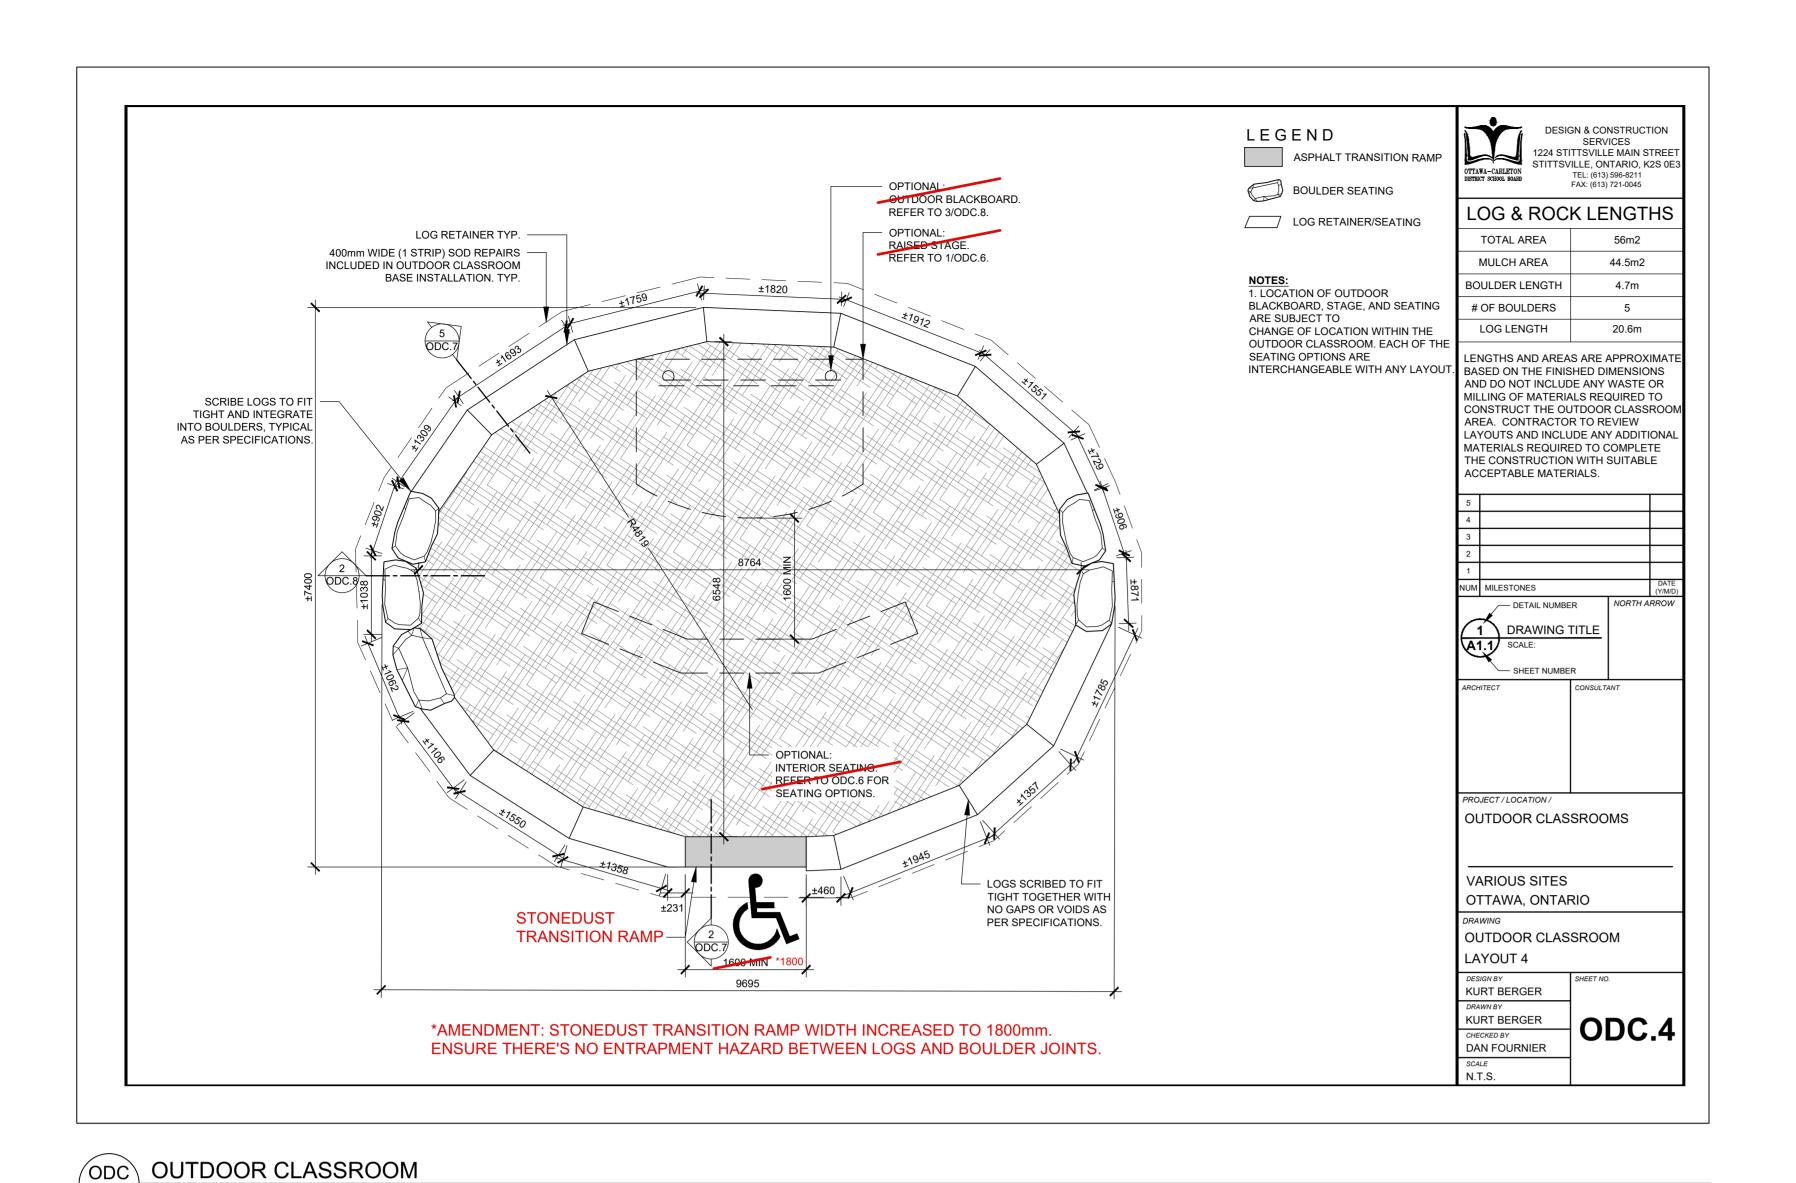

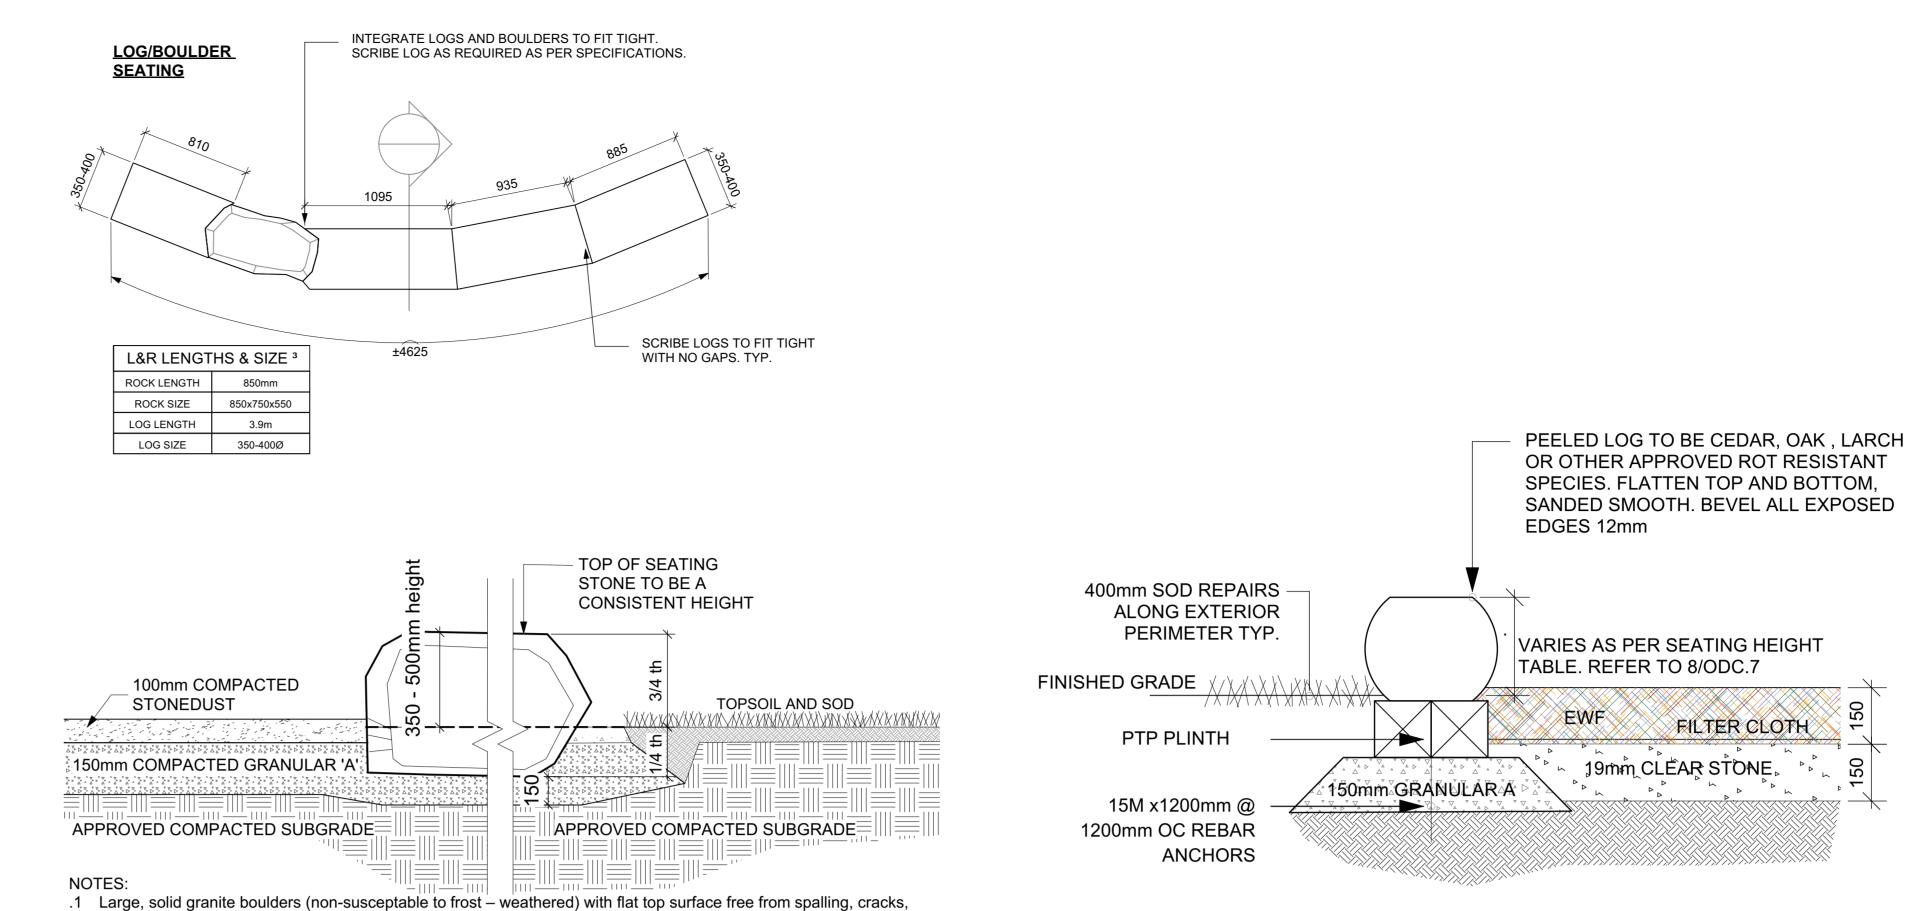 MITRE BUTT JOINTS AND CORNERS TO FIT NEATLY. SCRIBE TO FIT TIGHTLY AGAINST BOULDERS/LOGS

• IF GAPS REMAIN FILL WITH APPROX 2-3 1/4" TAPCONS BURIED 1 1/2" DEEP INTO ROCK FACE, THEN FILLED WITH NONE SHRINK GROUT COLOUR TO MATCH.

ODC.7, LOG RETAINER

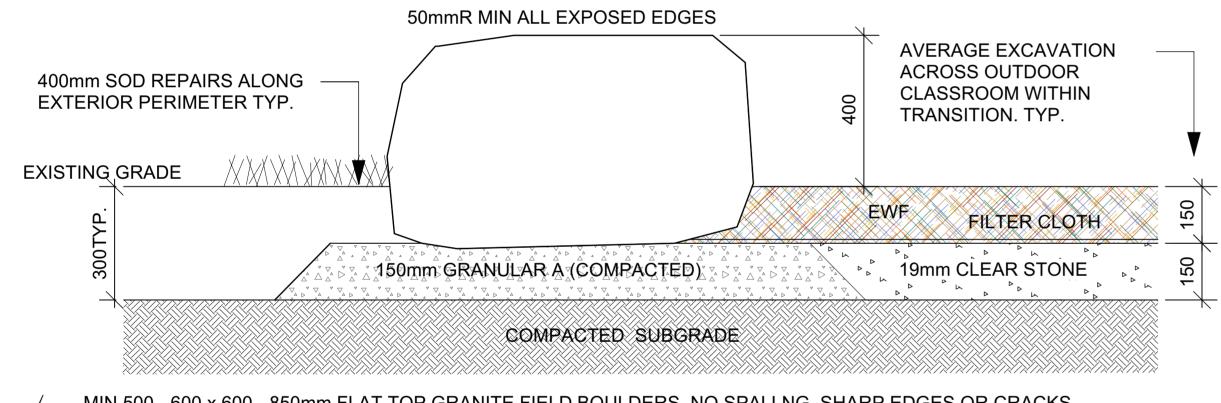

MIN 500 - 600 x 600 - 850mm FLAT TOP GRANITE FIELD BOULDERS. NO SPALLNG, SHARP EDGES OR CRACKS

IF PLACED SIDE BY SIDE, CHIP/SAW OR FLATTEN FACE TO FIT TIGHTLY TOGETHER AND AVOID GAPS

IF GAPS REMAIN FILL WITH APPROX 2-3 1/4" TAPCONS BURIED 1 1/2" DEEP INTO ROCK FACE, THEN FILLED WITH NONE

SHRINK GROUT COLOUR TO MATCH.

ODC.8 BOULDER RETAINER
L-04 Scale: NTS

L-04 Scale: NTS

HAND TAMP TO FORM AN THICKEN TO 100mm EVEN/SMOOTH EDGE 50mm HL3 FINE ASPHALT MAX 2% CROSS FALL FINISHED GRADE FILTER CLOTH ĠŔĄŇŰĿĄŔ Á (ĊŎMPĄĊŢĘĎ ŢŎŶ100% ŞPD) ▶ 19mm CLEAR STONE → 

sharp edges, entrapment holes

aesthetically meet the requirements of the design.

.4 Boulders to be set below grade by minimum of 150mm on stable grade.

1 SEATING BOULDER / STONEDUST PATH L-04 Scale: NTS

Height: 685 - 765mm[se]; Width: 600-800mm; Length: 1000 -1500mm, or as indicated on the layout plan to


.5 Top of boulder to be flat and level with the recommended sitting heights as follows, to be approved by the OCDSB's

Project Manager on site: JK/SK: 250-300mm (10-12")[1]; Primary: 300-375mm ( 12-15 ")[1]; Junior: 375-500mm (


.3 QTY: 15-21 stones. Additional boulders may be required to accomplish the desired concept, as per plan.

.2 Size of boulders:


3 STONEDUST PATHWAY L-04 | Scale: NTS

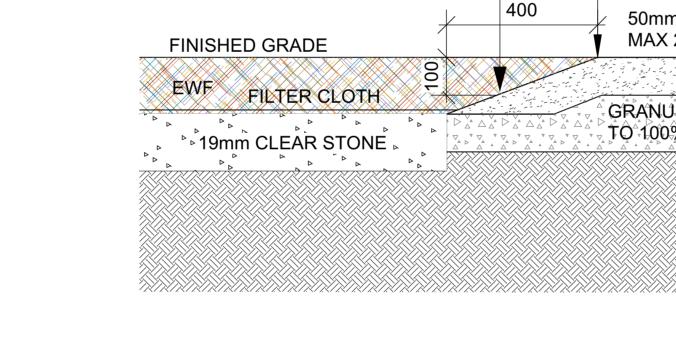



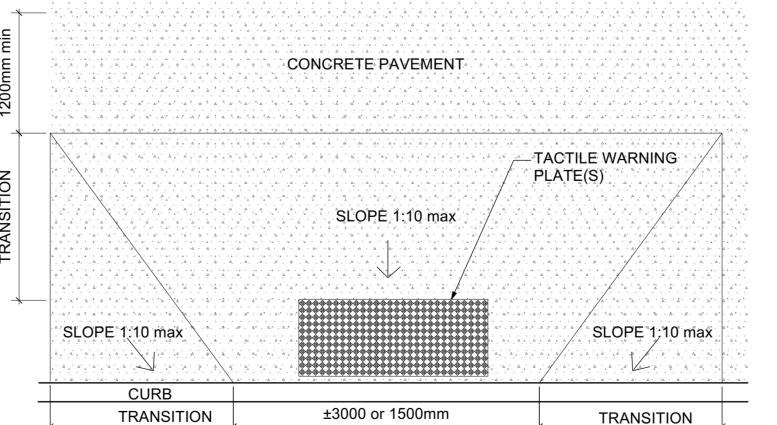

TRANSITION

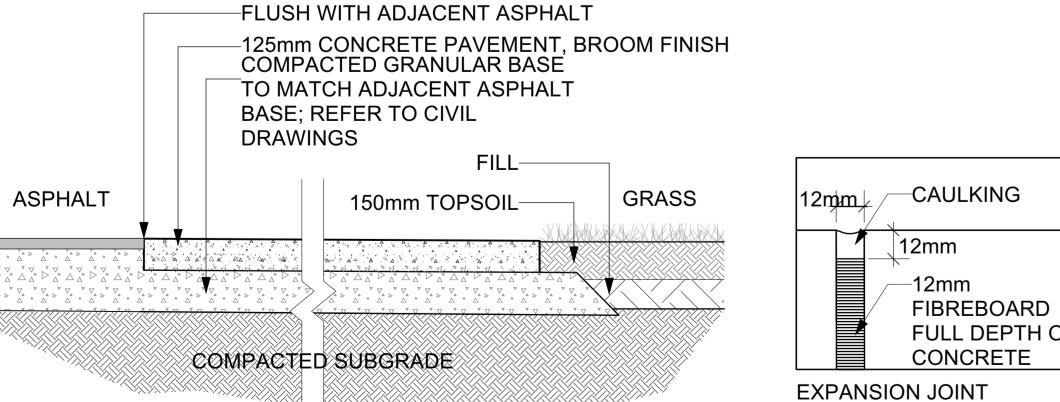

CONCRETE:

 CONCRETE TO BE CLASS C-2 (32MPa, AIR 5-8%, TYPE 10 CEMENT) SLUMP 80mm WITH A TOLERANCE OF ±30mm ).

AGGREGATE SIZE 20mm.

 PROVIDE SHOP DRAWINGS CONFIRMING THE LOCATIONS OF CONTROL JOINTS, ANY REQUIRED EXPANSION JOINTS.


-20mm DEEI SAWCUT FULL DEPTH OF **CONTROL JOINT** 

 SAWCUT CONTROL JOINTS AND EXPANSION JOINTS AS DETAILED.

 ONLY TOOL EDGES AT OUTSIDE EDGES OF PAD. EXPANSION JOINTS TO BE SPACED AT 6m oc. max.

CONTROL JOINTS TO BE SPACED AT 1.5m o.c. max.

CONCRETE PAD FOR BIKE RACK L-04 Scale: NTS

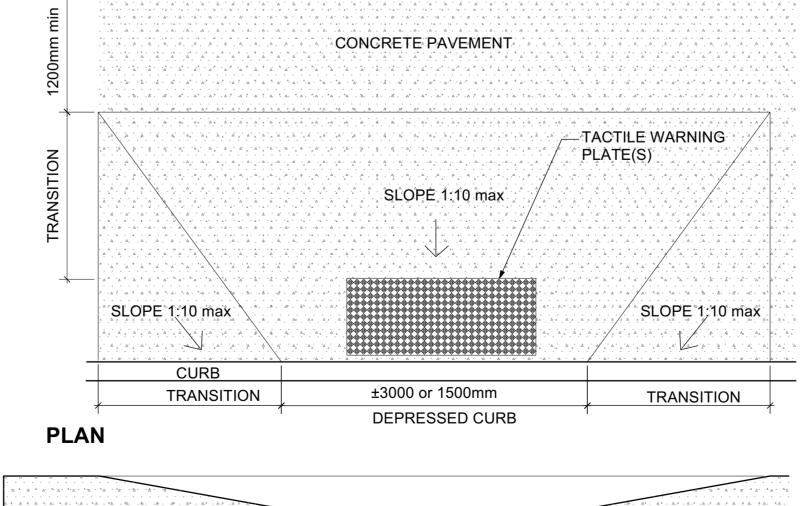


**SECTION - DEPRESSED CURB** 

NOTE: REFER TO CITY OF OTTAWA STANDARD DETAIL

D4 TACTILE WALKING SURFACE INDICATOR (TWSI)

L-04 Scale: NTS

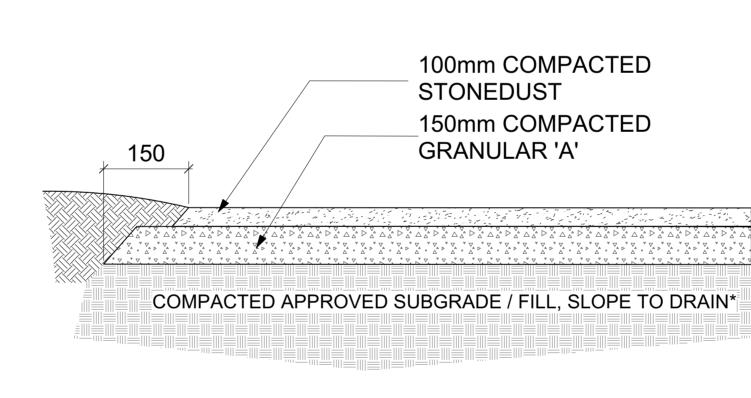

## **Ruhland & Associates Ltd** landscape architecture • urban design • site planning Ph 613-224-4744 Fx 613-224-1131

OTTAWA - CARLETON

DISTRICT SCHOOL BOARD

1.1 All general site information and conditions compiled from

existing plans, surveys and consultant's field notes. Report all

.2 The location of the utilities is approximate only, and the

exact location should be determined by consulting the municipal

3 All dimensions shown are to be verified on site prior to any

construction. No deviations are to be made from the layouts as

shown on this plan without prior consultation with the Landscape

.4 Obtain approval of Landscape Architect for granular base

.5 Stake planting locations and receive approval of Landscape

Architect, prior to excavation of any planting pits. No substitutions

.7 All sodded areas to receive a minimum of 150mm of topsoil

over graded sub-base. If sod with mesh is used, mesh to be

from an approved source and shall be laid within 24 hours of

being cut in the nursery. Only nursery sod shall be used.

.9 Maintain positive surface runoff through the entire

SITE

.10 Reinstate all areas and items damaged as a result of

KEY PLAN

2025/04/14

2025/02/04

2025/01/30

date

fax 613.224.9811

removed completely during sodding operations. Sod shall come

l.8 Final subgrade is to approved by the Landscape Architect

of plant material shall be made without prior approval of the

.6 Where clay is encountered proper drainage must be

ensured in tree/shrub pits, prior to planting. Have method

and layout of all pavement areas prior to construction.

authorities and utility companies concerned. The Contractor shall

prove the location of utilities and shall be responsible for adequate

Consultant for unknown subsurface conditions.

discrepancies prior to any work. No responsibility is born by the

GENERAL NOTES

protection from damage.

Architect and Owner.

Landscape Architect.

prior to sod being laid.

construction period.

06

05

04

03

02

01

Reissued for SPC

Issued for Permit

Issued for Coordination

tel. 613.224.0095


revision

N45 ARCHITECTURE INC.

approved by Landscape Architect.

East Urban Centre Elementary School

700 Spring Valley Dr, Ottawa, ON, K1W 0H2.

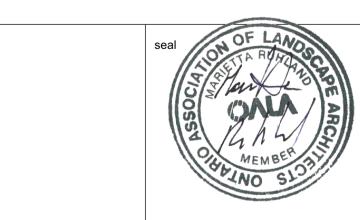

	CAPE DETAILS
scale As Shown	drawn by D.A.
date 2025-02-25	checked by M.R.
project number N45 24-828 RA 24-1743	drawing number  L-04

DO NOT SCALE DRAWINGS

PAVEMENT CONCRETE FINISH TO BE APPROVED THROUGH SHOP **DRAWINGS** TACTILE WARNING PLATE -SEE SPECS - 200mm REINFORCED .a.,a.,a.,a.,a.,a. CONCRETE SLAB 15M EPOXY COATED REBAR @ 300mm O.C. 15M EPOXY COATED REBAR @ 350mm O.C. 200mm COMPACTED GRANULAR 'A' COMPACTED APPROVED SUBGRADE **SECTION - CONCRETE PAD** 

BARRIER FREE PATH OF ACCESS AND DEPRESSED CURB TO COMPLY WITH A.O.D.A. STANDARDS AND CITY OF OTTAWA ACCESSIBLE GUIDELINES. WIDTH OF DEPRESSED CURBS AT HANDICAP PARKING STALLS IS ±1500mm. WIDTH OF DEPRESSED CURB AT DROP OFF ZONE