


STORM STRUCTURE TABLE										
STRUCTURE	TOP OF GRATE	STRUC INLET	INLET	INLET	OUTLET	SIZE	OPSD	COVER	OUTLET DIAMETER	TYPE
CB01	66.30				64.550	REFER TO ACO TRENCH DRAIN DESIGN			250	PVC SDR-35
CB02	66.30				64.550	REFER TO ACO TRENCH DRAIN DESIGN			200	PVC SDR-35
CB03	66.30				64.550	REFER TO ACO TRENCH DRAIN DESIGN			200	PVC SDR-35
CB04	66.30				64.550	REFER TO ACO TRENCH DRAIN DESIGN			200	PVC SDR-35
CB05	66.30				64.550	REFER TO ACO TRENCH DRAIN DESIGN			200	PVC SDR-35
CB06	66.30				64.550	REFER TO ACO TRENCH DRAIN DESIGN			200	PVC SDR-35
CB07	66.30				64.550	REFER TO ACO TRENCH DRAIN DESIGN			250	PVC SDR-35

		Obvert Invert				Obvert Invert			
1	EX. 825mm @ CONC STM	64.563	63.624	0.310	Clearance Under	65.122	64.872	200mmØ PVC SAN	
2	250mmØ CB LEAD	64.779	64.529	0.579	Clearance Above	63.950	63.750	200mmØ PVC W/M	

WATERMAIN SCHEDULE				
STATION	DESCRIPTION	FINISHED GRADE	TOP OF WATERMAIN	COVER
0+000	North Side Stand Connection	66.32	63.920	2.40
0+000.97	45° Bend	66.34	63.940	2.40
0+001.74	45° Bend	66.36	63.960	2.40
0+003.92	Crossing with 250mmØ CB Lead	66.35	63.950	2.40
0+015.88	45° Bend	66.33	63.930	2.40
0+016.59	45° Bend	66.34	63.940	2.40
0+017.17	Connect to ex.w/m	66.35	63.950	2.40

*Note: Provide Concrete Encased for crossing clearance less than 0.30m

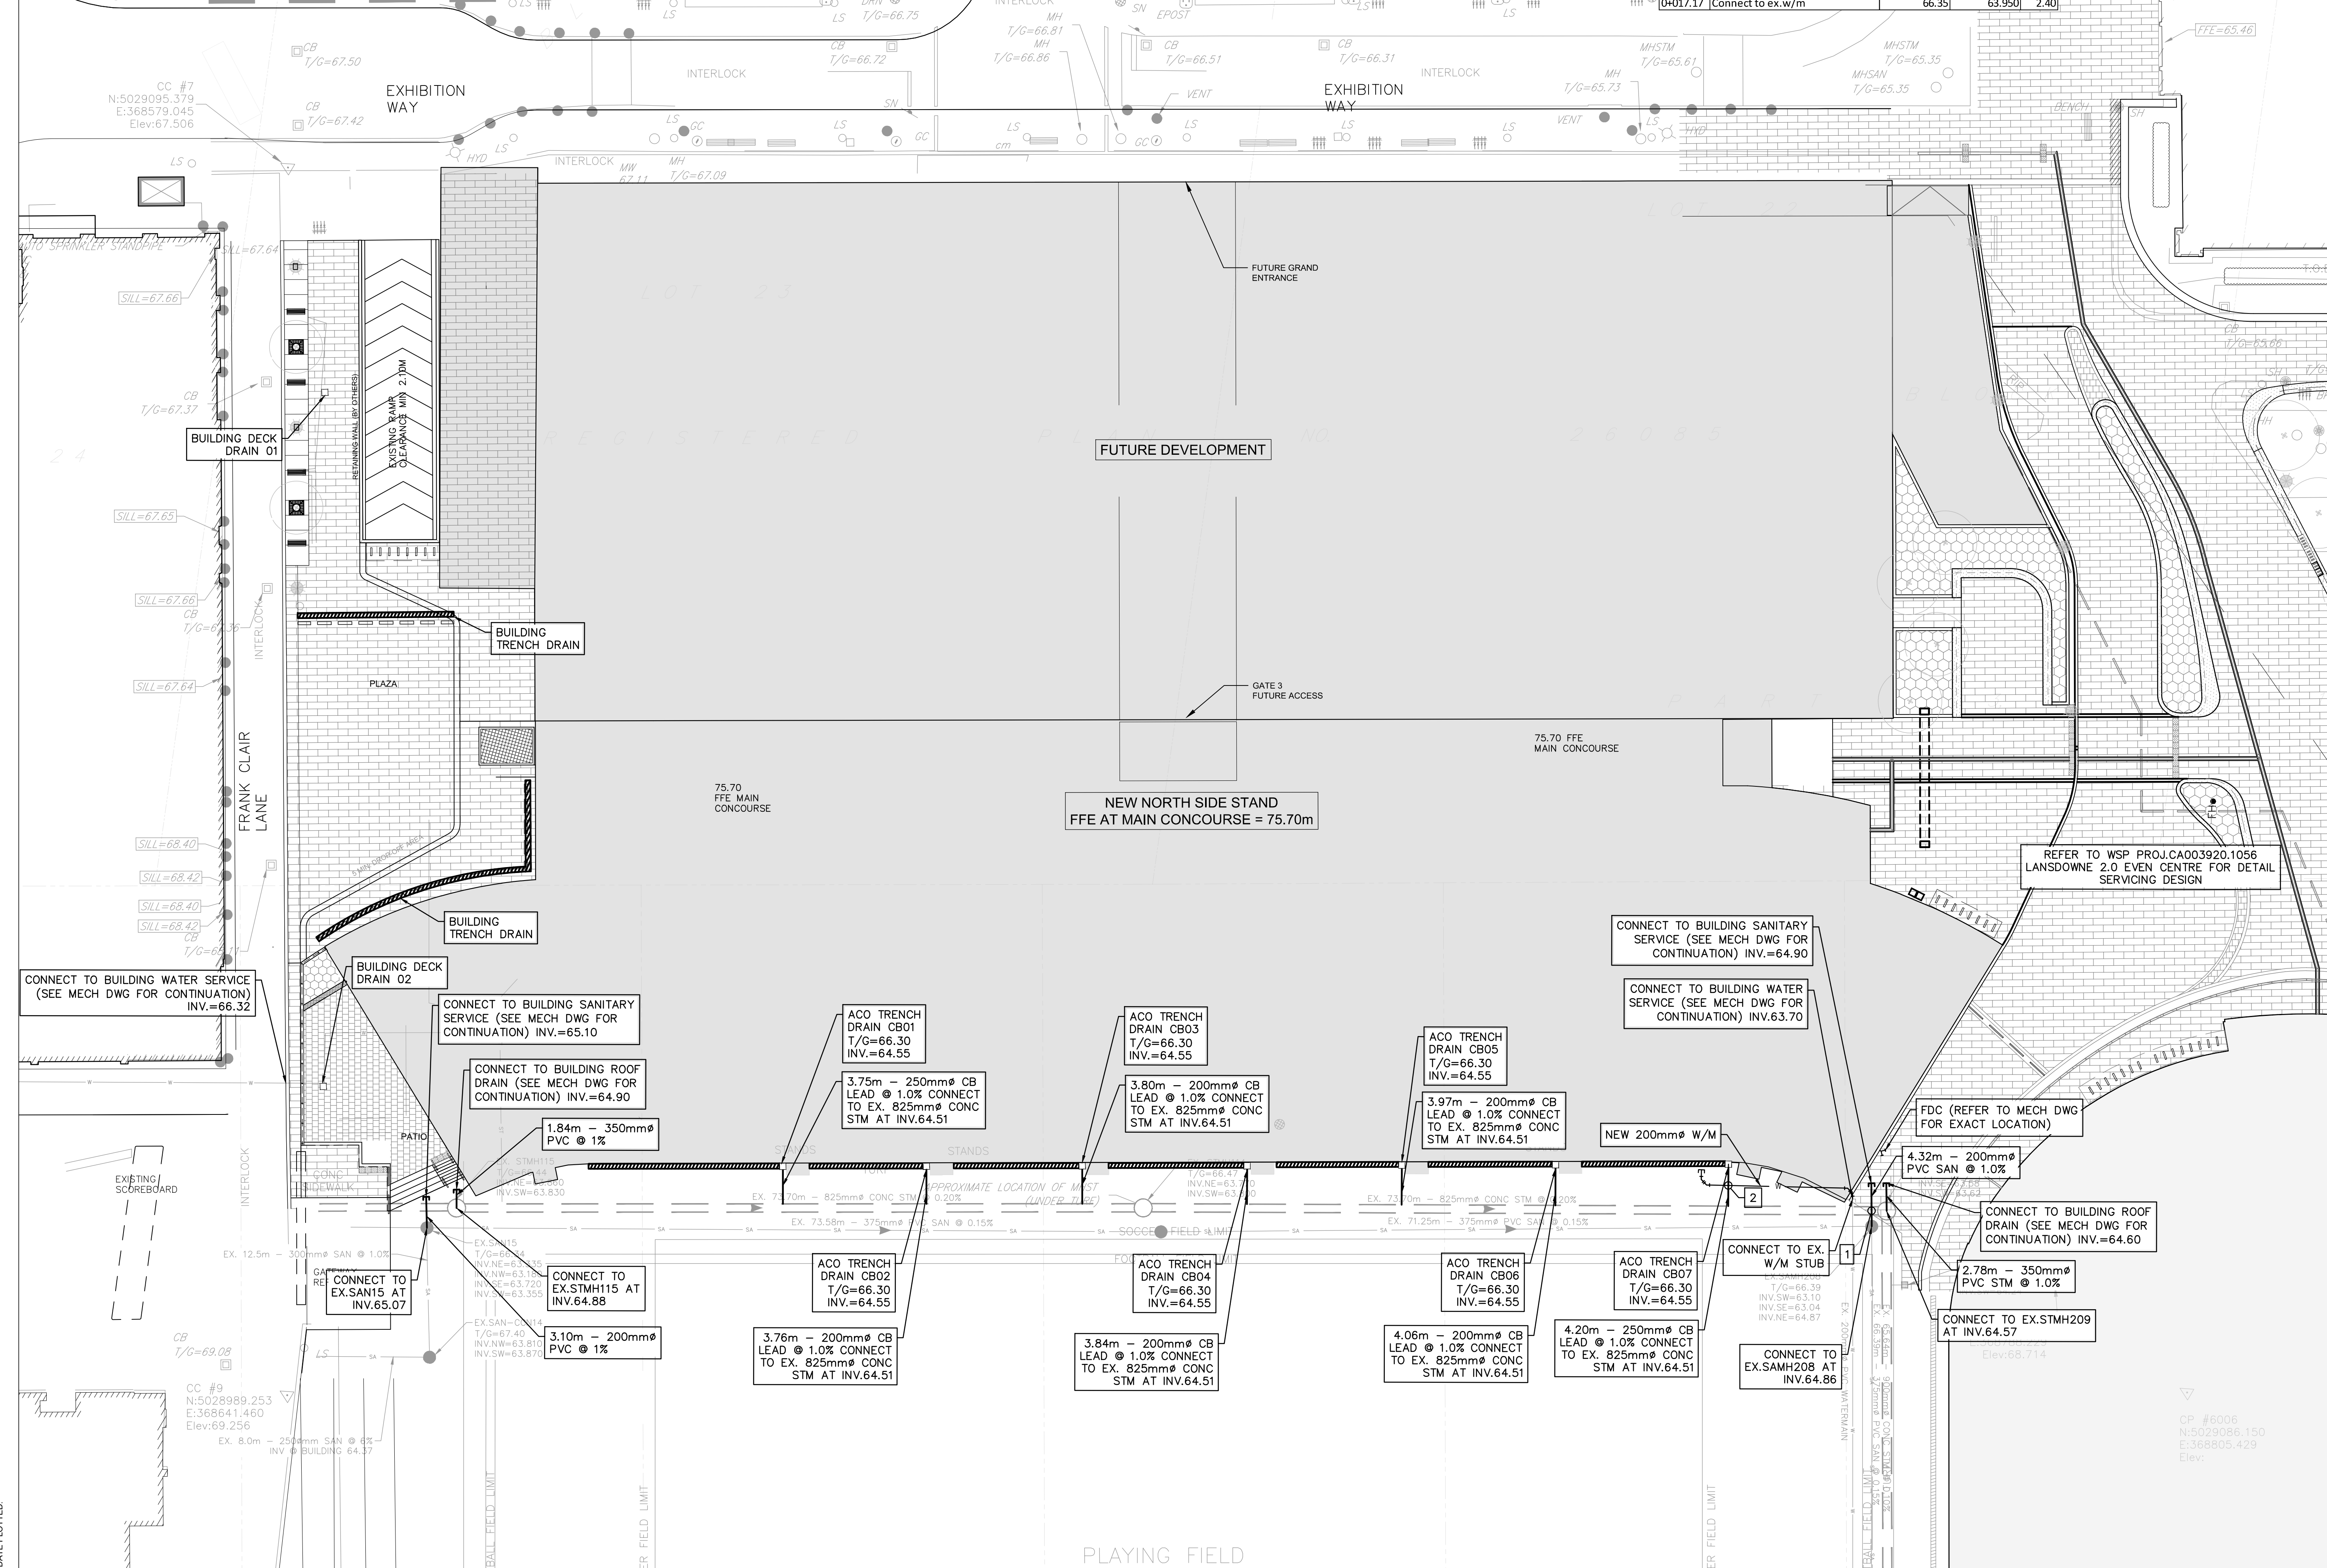

BRISBROOK BEYOND ARCHITECTS
 14 DUNCAN ST 4TH FLOOR
 TORONTO, ON M5H 3G8
 (416) 591-8999
 ARCHITECT

ENTUITIVE
 135 LAURIER AVE WEST, SUITE 413
 OTTAWA, ON K1P 5J2
 (343) 308-9274
 STRUCTURAL ENGINEER

TMP
 200 KING ST. WEST, SUITE 310
 TORONTO, ON M5H 3T4
 (416) 499-8000
 MECH. PLUMB. FIRE PROTECTION ENGINEER

MULVEY & BANANI
 90 SHEPPARD AVE. EAST, SUITE 500
 TORONTO, ON M2N 3A
 (416) 751-2520
 ELEC. LIGHTING ENGINEER


S2O
 530 N. WOOD STREET #C
 CHICAGO, IL 60622
 (224) 717-1999
 FOOD AND BEVERAGE

CSW
 319 MCRAE AVENUE, SUITE 502
 OTTAWA, ONTARIO K1Z 0B9
 (613) 729-4536
 LANDSCAPE ARCHITECT

wsp
 2011 QUEENSVIEW DR.
 OTTAWA, ONTARIO K2B 8K2
 (613) 829-2800
 CIVIL ENGINEER

NO.	DESCRIPTION	DATE
2	ISSUED FOR SITE PLAN APPLICATION	2024-11-20
1	ISSUED FOR URP	2024-11-19

REVISIONS/ ISSUES
 CONTRACTOR SHALL CHECK AND VERIFY ALL DIMENSIONS AND REPORT ANY OMISSIONS OR DISCREPANCIES TO THE ARCHITECT BEFORE PROCEEDING WITH THE WORK. DO NOT SCALE THE DRAWINGS

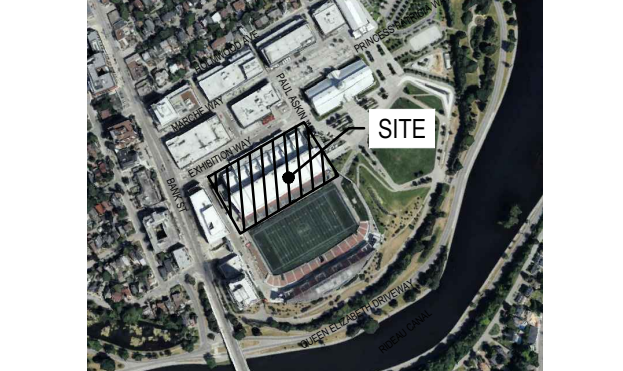

SEAL
D. B. YANG
 100230568
 2024-12-20
 PROVINCE OF ONTARIO
 LICENSED PROFESSIONAL ENGINEER

DRAWN: J.T
 DATE: 2024/11/20
 CHECKED: W.Y

LANSDOWNE NSS

DWG. TITLE: **SERVICING PLAN**

SCALE: 1:300
 PROJ. NO.: CA0043476.7969
 DWG. NO.: C04