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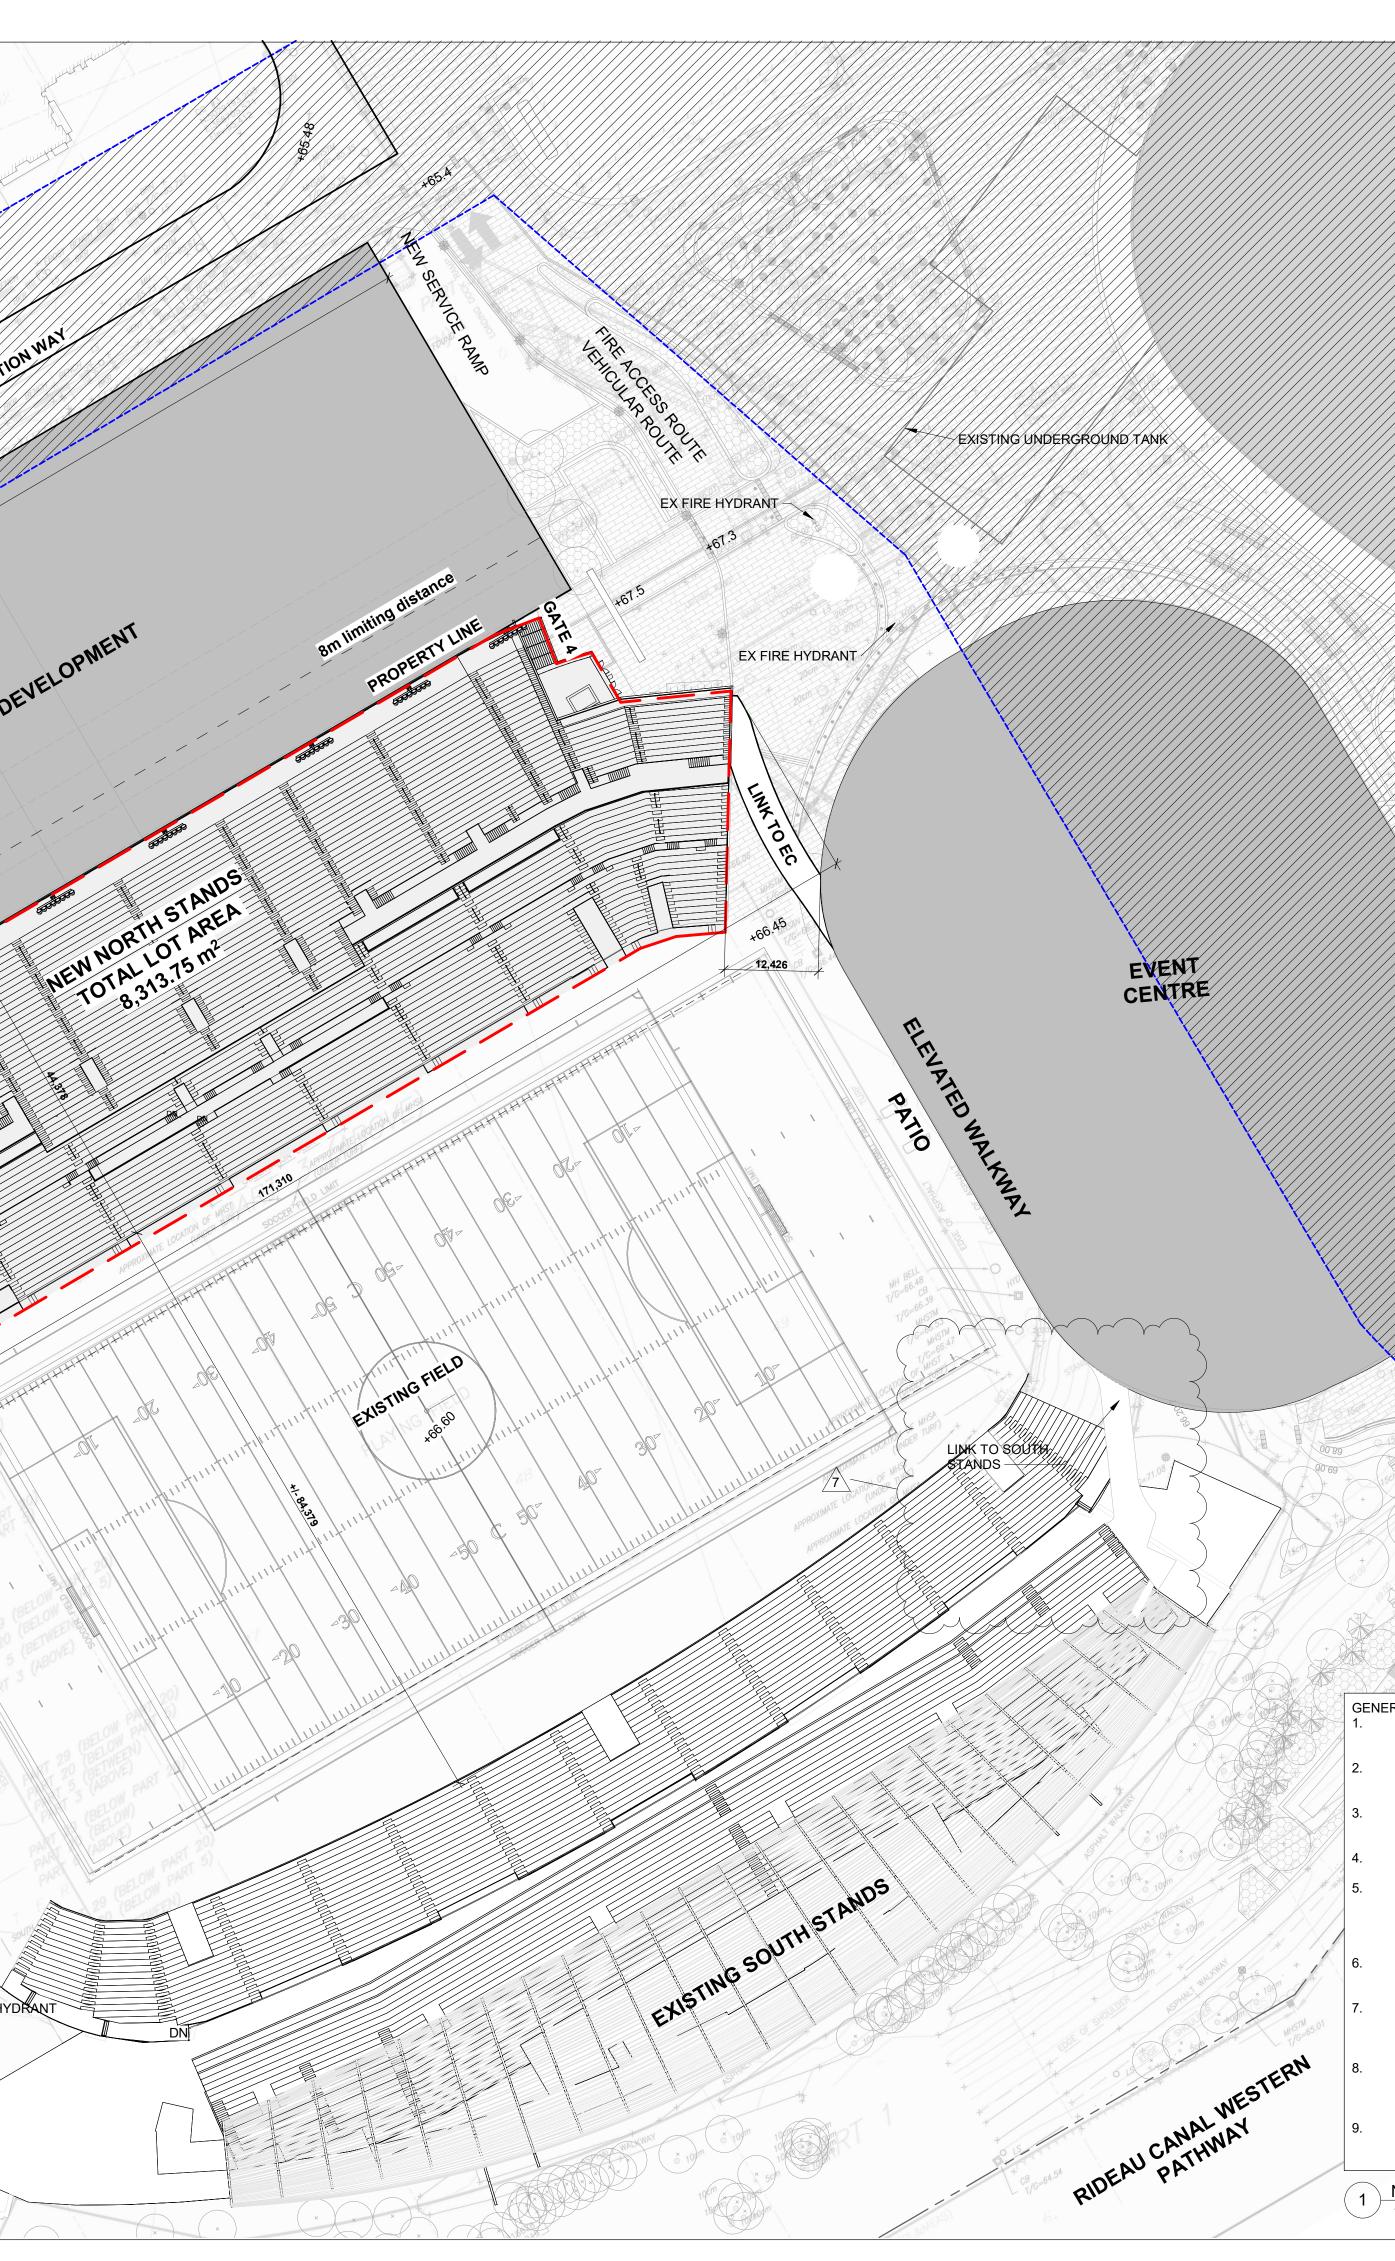
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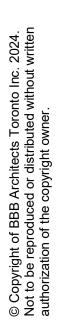
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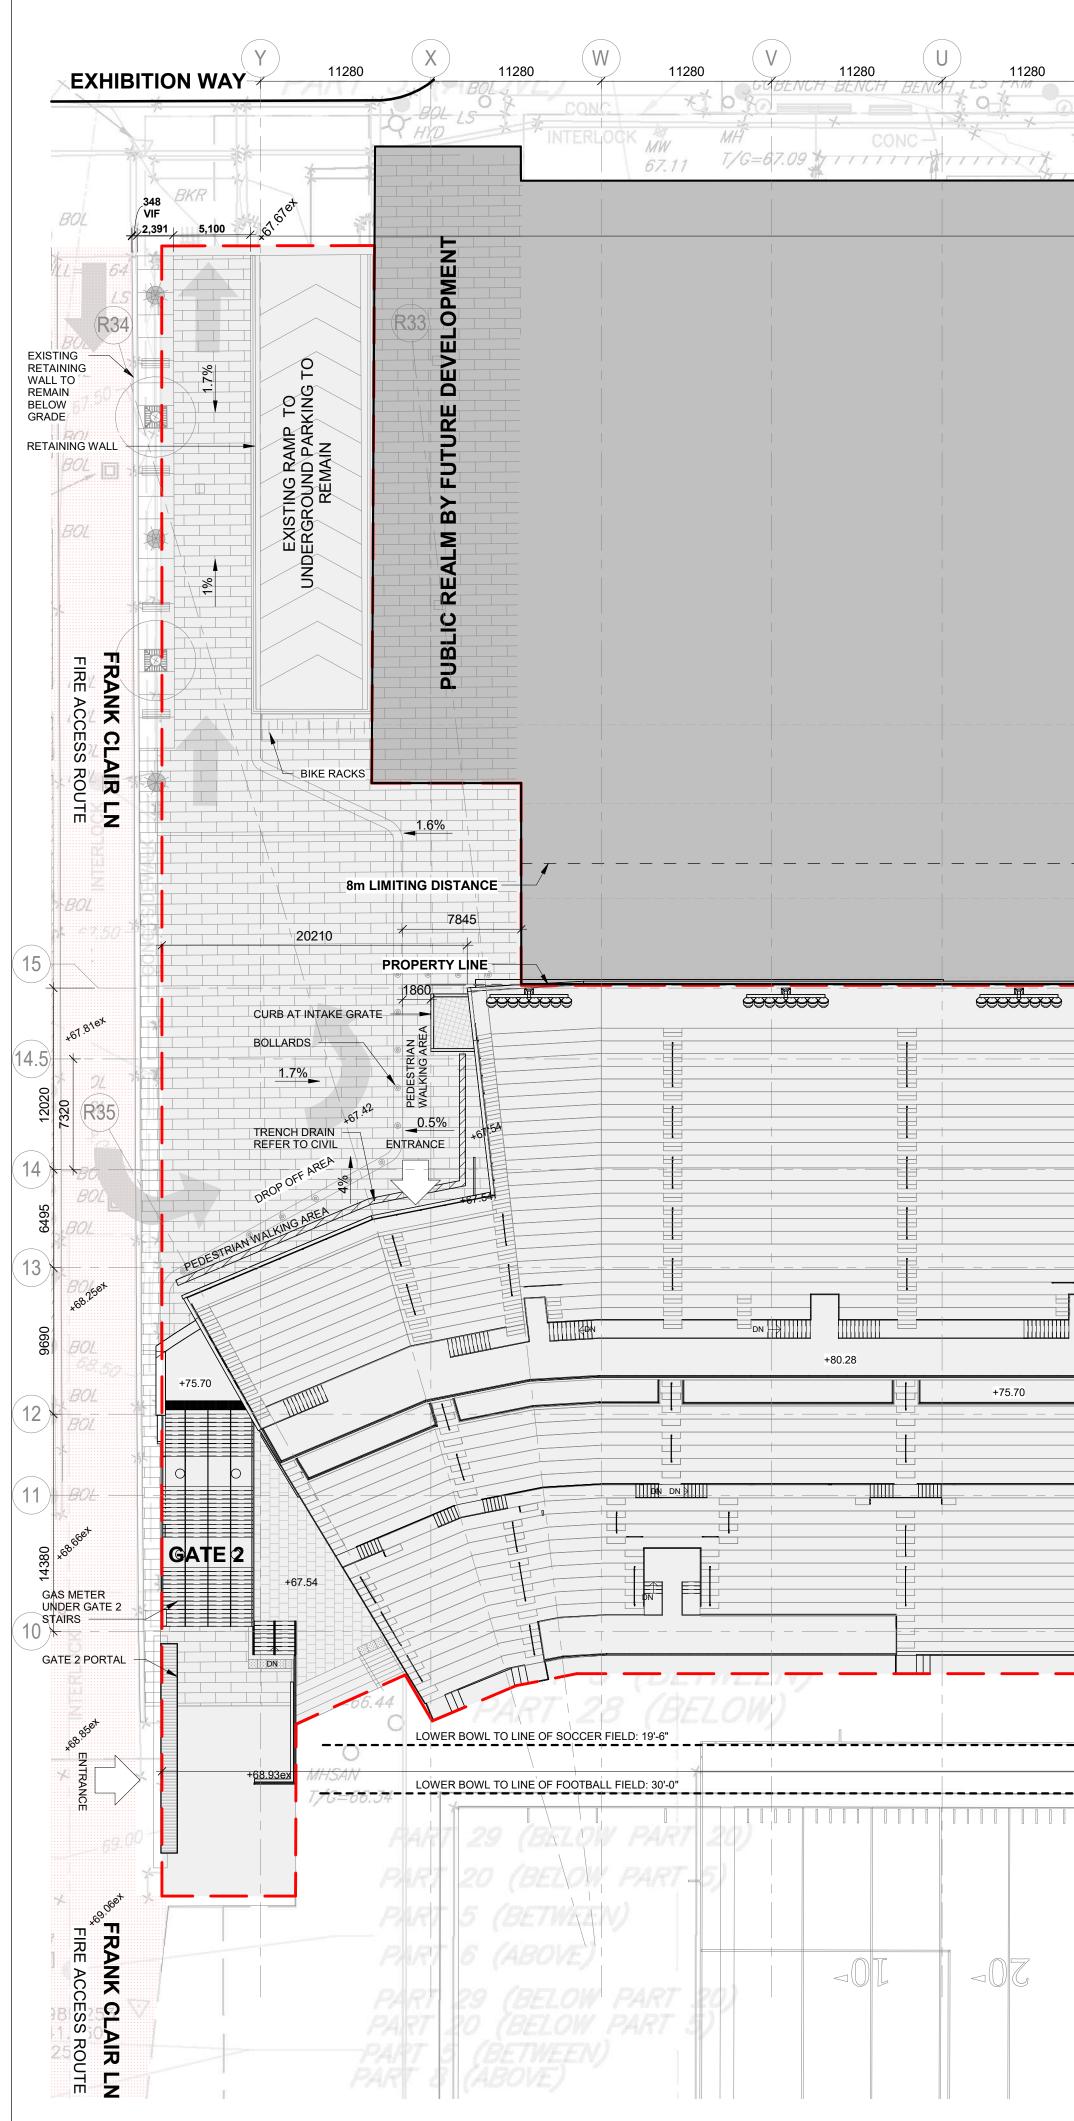
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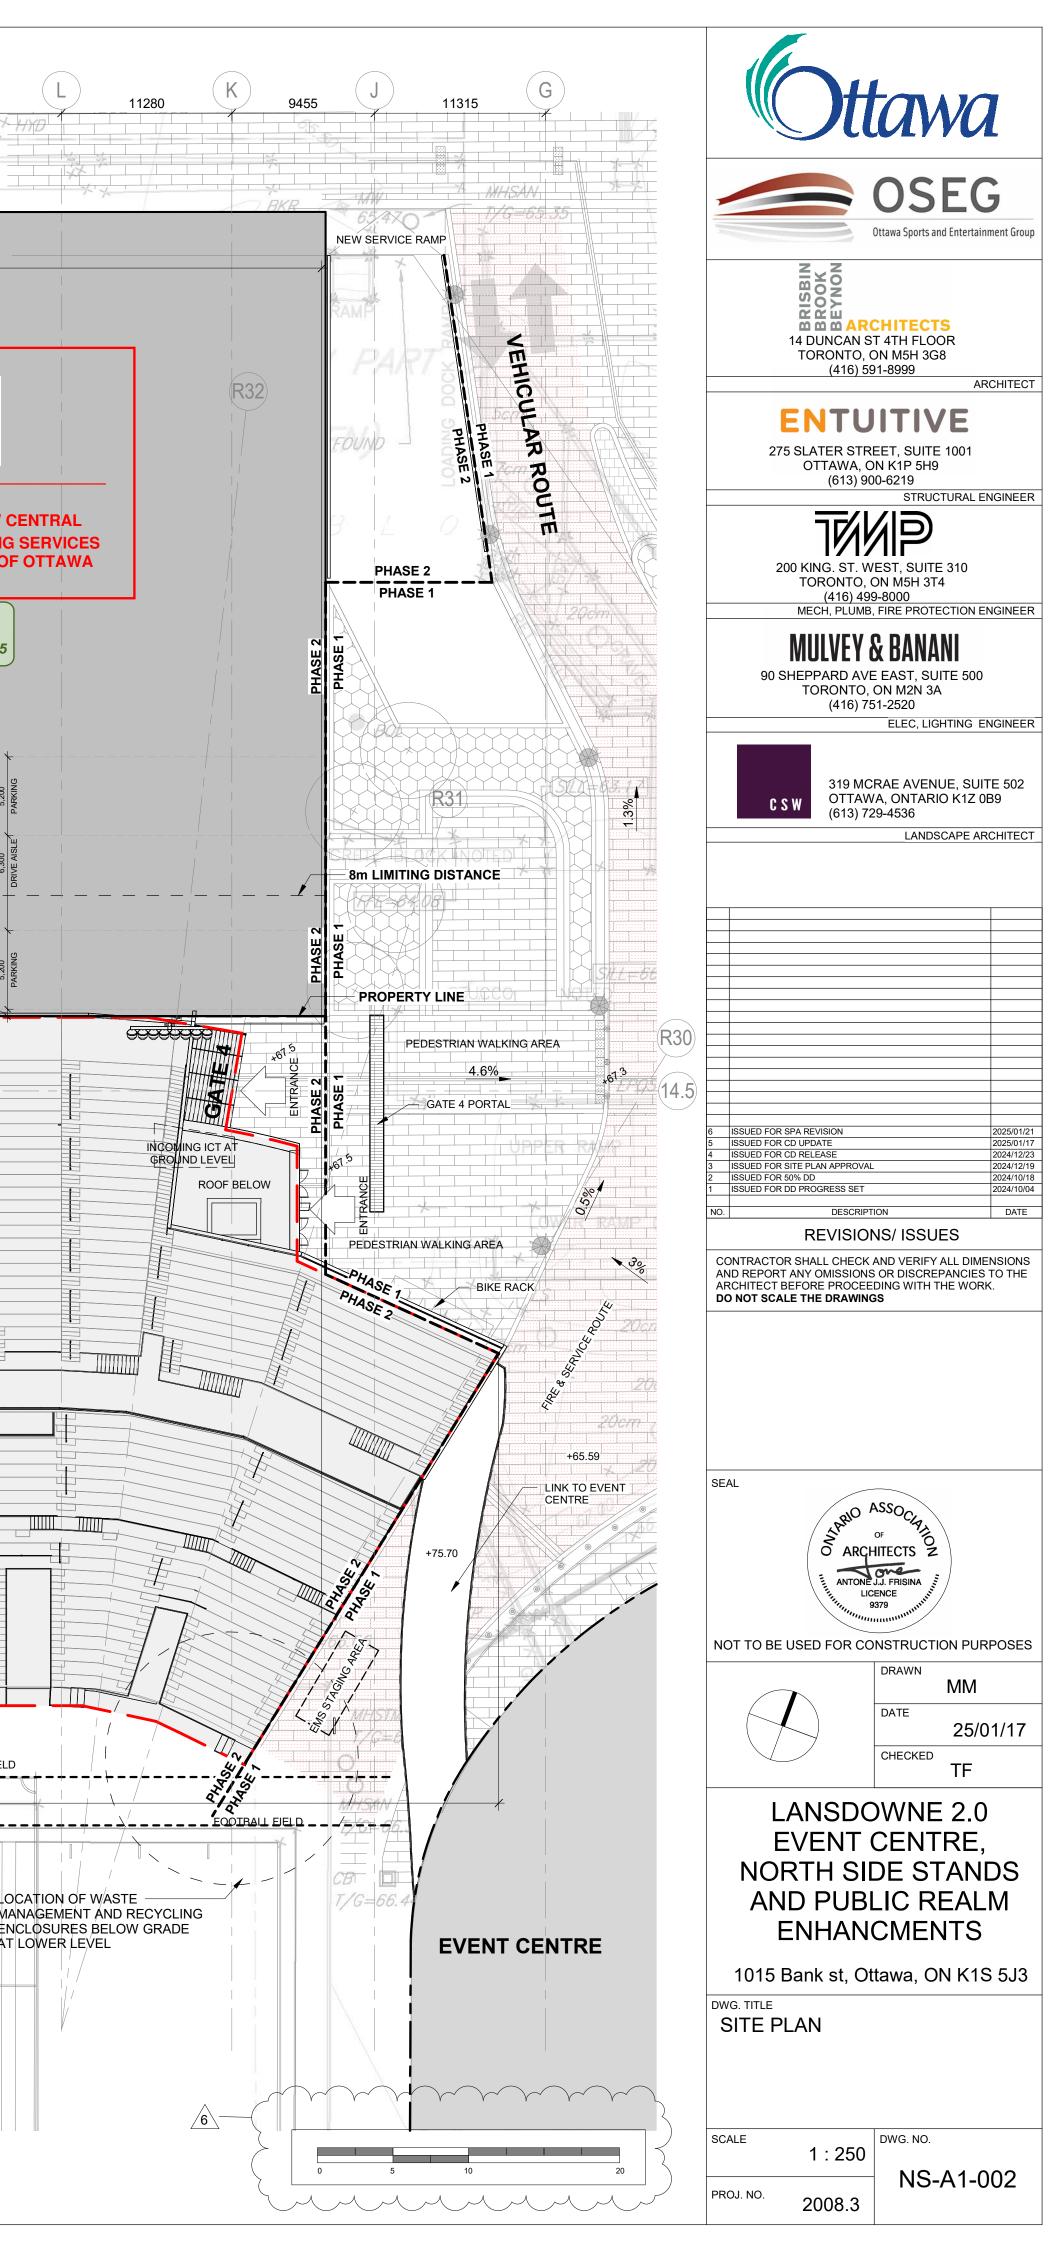
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					90 SHEPPARD AVE TORONTO, (416) 75	S BANANI E EAST, SUITE 500 ON M2N 3A
						RAE AVENUE, SUITE 502 A, ONTARIO K1Z 0B9 9-4536 LANDSCAPE ARCHITECT
				VIIII		
					7 ISSUED FOR SPA REVISION	2025/01/21
		<u>LEGE</u> O	<u>ND</u> FIRE HYDRANT		6 ISSUED FOR CD UPDATE 5 ISSUED FOR CD RELEASE 4 ISSUED FOR SITE PLAN APPROVAL 3 ISSUED FOR 90% DD - CLASS B ES	2025/01/17 2024/12/23 2024/12/19
		0	EXISTING FIRE HYDRANT		2 ISSUED FOR 50% DD 1 ISSUED FOR DD PROGRESS SET NO. DESCRIPT	2024/10/18 2024/10/04 ION DATE
			PRECAST CONCRETE STEPS		CONTRACTOR SHALL CHECK AND REPORT ANY OMISSIONS	
		[]]]	TOTAL LOT AREA (37,300 m ²)		ARCHITECT BEFORE PROCEE DO NOT SCALE THE DRAWING	DING WITH THE WORK.
		╈ᡇ	LIGHT COLUMN			
15911		+66.75	PROPOSED SPOT ELEVATION	1		
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GENEF 1.	RAL NOTES: ALL EXTERIOR LIGHTING SHALL BE DIREC INFRINGE UPON ADJACENT PROPERTIES					DATE
2.	ALL ROOF TOP MECHANICAL UNITS SHAL AND BE LOCATED BEHIND THE BUILDING	L BE SCRE				25/01/17 ^{СНЕСКЕД} ТF
3.	ALL STRUCTURAL DESIGN ARE TO BE AP ENGINEER FOR THE PROJECT	PROVED B	Y THE STRUCTURAL		LANSDO	WNE 2.0
4. 5.	ALL DIMENSIONS ARE IN MILLIMETERS UP REFER TO DRAWINGS AND REPORTS PR -SITE SERVICING AND GRADING B -LANDSCAPING BY: CSW LANDSCA -ELECTRICAL SERVICES BY: MBII	EPARED B' 8Y: WSP	Y :		NORTH SII AND PUBI	CENTRE, DE STANDS LIC REALM
6.	LOCATION OF WASTE MANAGEMENT AND ONE LEVEL DOWN OFF OF THE LOADING		NG ENCLOSURES LOCATED			CMENTS tawa, ON K1S 5J3
7.	SIGNAGE AND PAVEMENT MARKING SHAI STANDARDS - ALL SITE SIGNAGE DESIGN TO CODE AND AUTHORITY HAVING JURIS	I IS IN DEV	ELOPMENT AND WILL COMPLY		DWG. TITLE SITE PLAN CON	
8.	SNOW REMOVAL OPERATIONS ARE TO B SNOW IS TO BE TRANSFERRED TO GREA REMOVAL	T LAWN FO	OR SUBSEQUENT OFF-SITE			
9.	PROPERTY INFORMATION DERIVED FROM OCTOBER 23, 2024				SCALE As indicated	DWG. NO.
	NS CONTEXT SITE PLAN				PROJ. NO. 2008.3	NS-A1-001

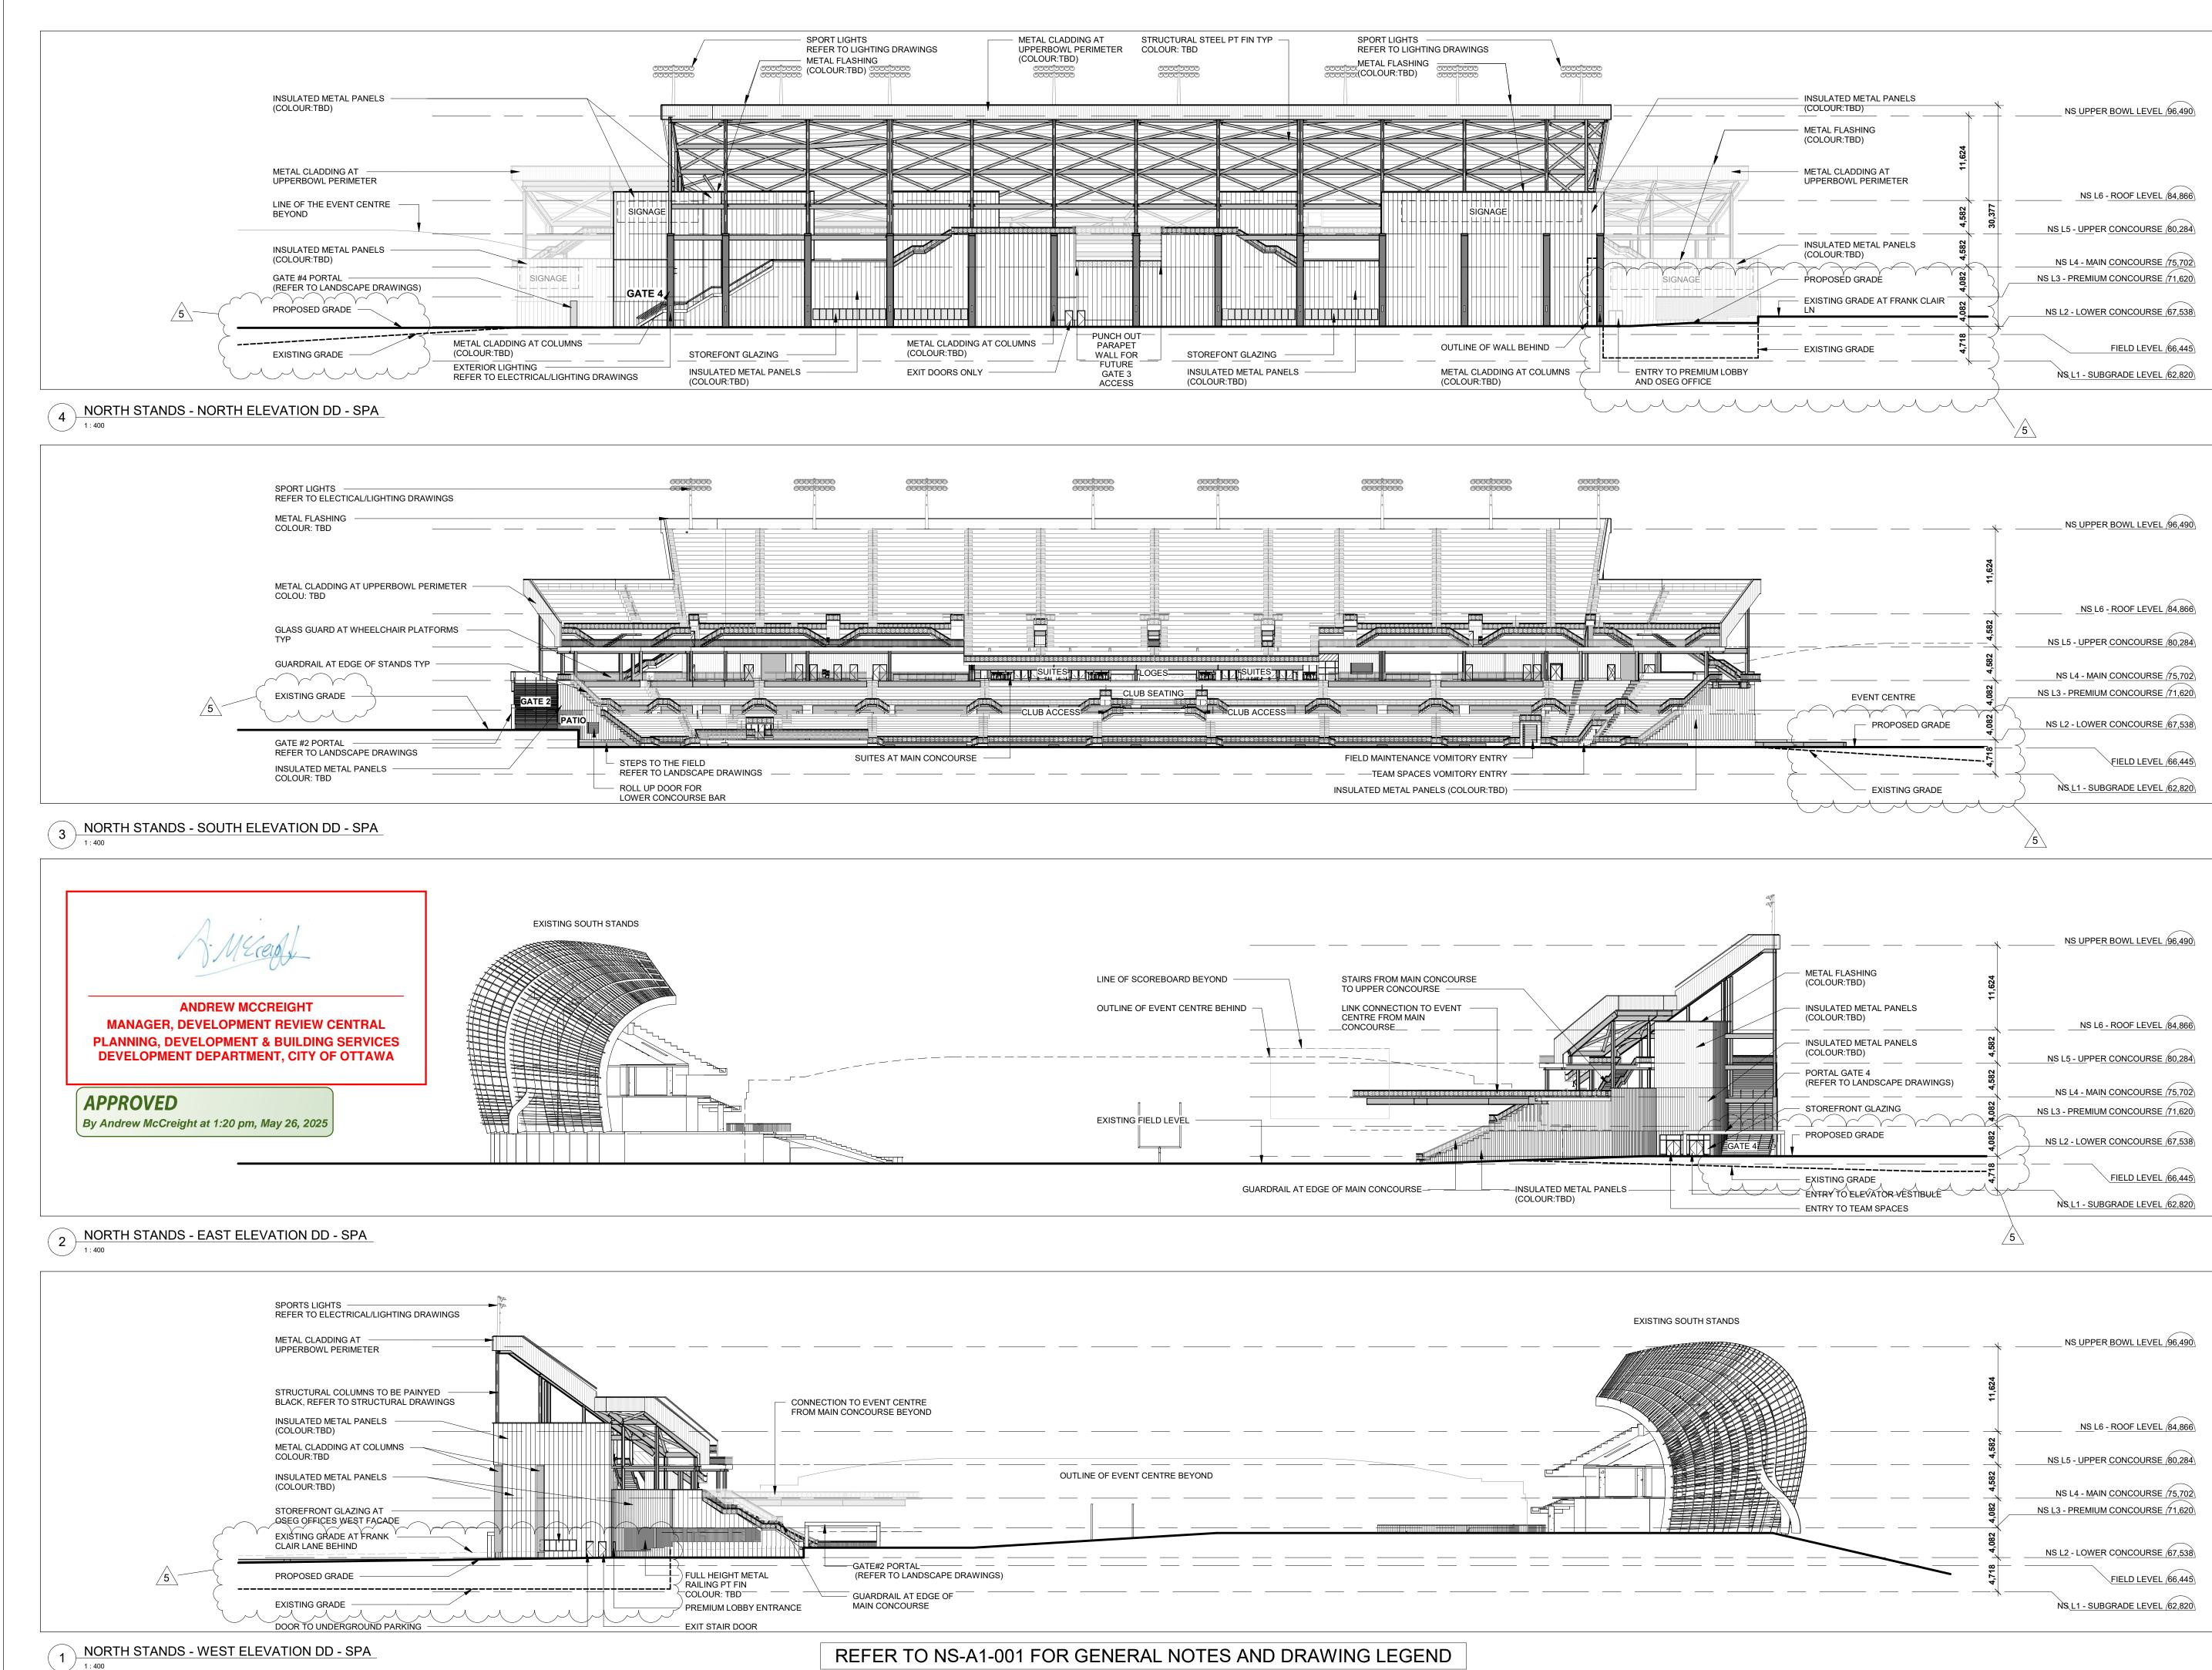


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					Prew McCreight at 1:20 pm, May 26, 2025
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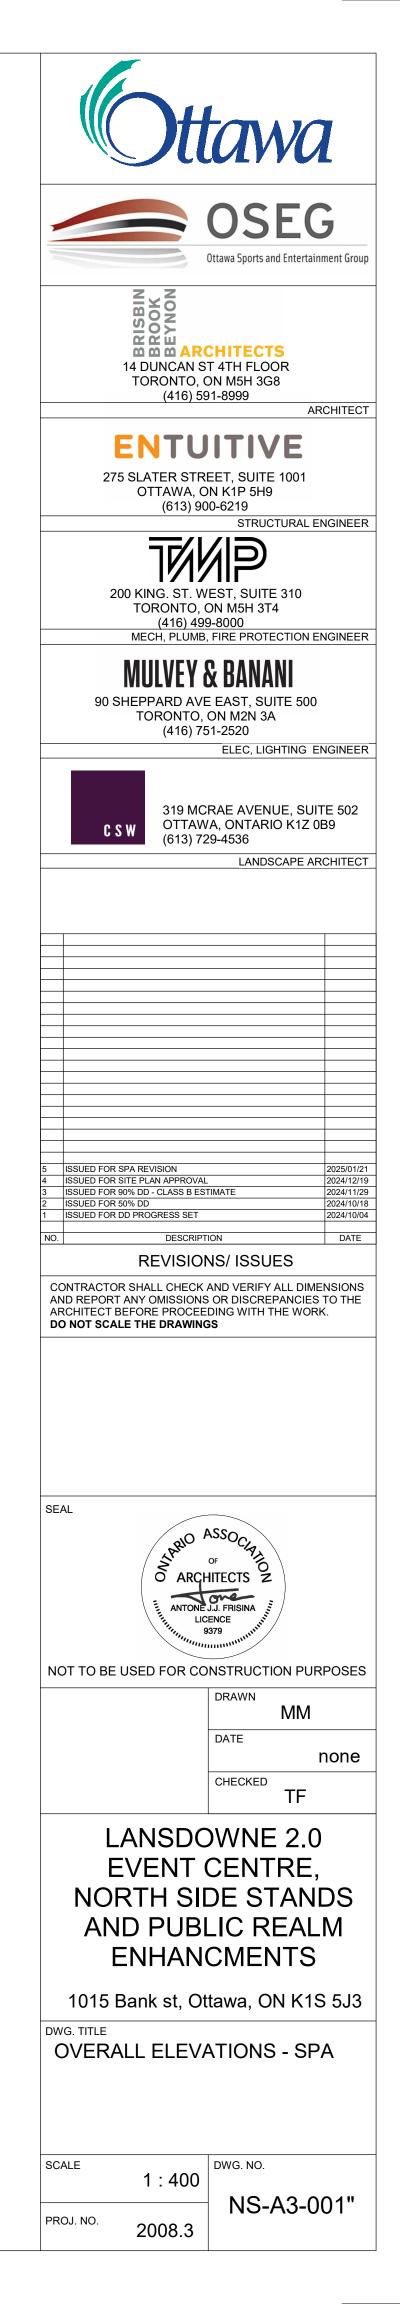




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	METAL FLASHING (COLOUR:TBD)	11,624	
	INSULATED METAL PANELS (COLOUR:TBD)		NS L6 - ROOF LEVEL 84,866
	INSULATED METAL PANELS (COLOUR:TBD)	4,582	NS L5 - UPPER CONCOURSE 80,284
	PORTAL GATE 4 (REFER TO LANDSCAPE DRAWINGS)	4,582	NS L4 - MAIN CONCOURSE 75,702
		4,082	NS L3 - PREMIUM CONCOURSE 71,620
TE 4	PROPOSED GRADE	4,082	NS L2 - LOWER CONCOURSE 67,538
 .		4,718	FIELD LEVEL 66,445
	ENTRY TO ELEVATOR VESTIBULE		NS_L1 - SUBGRADE LEVEL 62,820
			5