

GENERAL LANDSCAPE NOTES

- 1. All planting and associated landscape work shall comply with the **Canadian Society of Landscape Architects Canadian Landscape Standard**, latest edition.
- All nursery stock shall comply with the Canadian Nursery Landscape Association Canadian Nursery Landscape Association Canadian Nursery Standard, latest edition.
- Landscape work shall be carried out by experienced professionals with a minimum 5 years proven experience.
- The Contractor shall notify the Landscape Architect for review and approval of layout. Work that has been installed without layout approval that requires adjustment will be corrected at the Contractor's expense. The Landscape Architect reserves the right to adjust layout based on site conditions. Layout shall adhere to all authority clearances and setbacks. Trees shall not be directly over or under utilities.
- The Landscape Architect may reject any work, whether installed or not, that does not confirm to specifications.
- The Contractor shall notify the Landscape Architect upon completion of work to arrange for substantial performance inspection and approval. Inspection shall be carried out during the leaf-on growing season.
- Plant material shall have nursery labels intact and trunk wrap and ties removed for substantial performance review. The Contractor shall remove all labels, tags and ties following substantial
- Corrective pruning shall be completed by the Contractor in accordance with ISA Best Management Practice Pruning Standard prior to inspection and include the removal of dead or broken branches, suckers and co-dominant leaders.
- Any leaning plant material shall be corrected by the Contractor prior to inspections.
- 10. The Contractor shall carry out maintenance of all work immediately following installation until the end of the warranty period. Maintenance shall include all measures necessary to establish and maintain all plants and associated landscape work in an acceptable, vigorous and healthy condition including rodent protection, cultivating, weeding, watering, pruning and maintenance of all accessories.
- 11. The Contractor shall notify the Landscape Architect at the end of the warranty period to arrange for final completion inspection. Inspection shall be carried out during the leaf-on growing season. The Contractor shall remove all staking prior to inspection for final completion if plant material is stable. Staking shall be left in place for removal by the Owner if plant material is not stable. At the time of final inspection all planting beds and tree pits shall be freshly cultivated, free of weeds, leaves, broken branches or debris.
- 12. Any work that is not in satisfactory condition or does not meet the specifications shall be replaced within two (2) weeks of notification at the Contractor's expense. Replacement work shall include warranty equal to the original installation.

GROWING MEDIA

- All subsoil shall be scarified to be the specified depth prior to the installation of growing media. Growing media shall be mixed in to the scarified subsoil interface.
- On-site (preserved) soil to be used as growing media should be tested by the Owner's consultant for recommendations to be included in the Contractor's scope of work.
- The Contractor shall provide origin documentation for approval for all imported growing media. Imported growing media shall be tested by a reputable laboratory at the expense of the Contractor or Owner. The results of the soil test and recommendations are to be provided to the Landscape Architect for approval one week prior to work commencing. If necessary, recommendations from the laboratory are to be implemented at the Contractor's expense.
- Growing media shall not contain any extraneous physical or chemical properties that may detract from supporting plant growth, no subsoil contamination, roots or stones over 50mm diameter.
- Growing media depths shall be noted on the drawings and details. Growing media shall be installed in lifts and compacted to be firm under foot.
- Growing media shall meet Canadian Landscape Standard nutrient levels identified in Section 5.2.7 and properties for Level 3 Moderate
- Growing media properties shall be adjusted to meet requirements for L low traffic lawn areas, trees and large shrubs; H high traffic lawn areas; and P planting areas.

PLANT MATERIAL

- Contractor shall verify all plant material on drawing(s) and plant material list(s) and report any discrepancies during the bidding process.
- 2. All plants shall be healthy, vigorous, and free of disease, insect pests, and invasive or noxious plant species. All plant parts shall be free from defects, decay, disfigurements and injury.
- There shall be no substitutions of plants without prior written approval from the Landscape Architect.
- 4. The Landscape Architect reserves the right to reject plant material after installation and throughout the warranty period.

<u>PLANTING</u>

- Planting shall only be carried out during periods that are normal for such work as determined by local weather conditions, when seasonal conditions are likely to provide successful adaptation of plants in their new environment.
- Plants shall be well watered prior to being planted.
- Where poor drainage or percolation is suspected or observed, the Contractor shall report it to the Landscape Architect and rectify the condition prior to planting.
- Plants shall be stabilized using methods such that the crown of each tree is permitted free movement but normal forces will not shift the rootball in the growing medium. All tree stabilization methods shall be such that they do not damage the plants.

<u>MULCH</u>


- Mulch shall be commercially prepared four-season aged pine bark. The Contractor shall submit a sample of mulch and source for approval prior to delivery.
- Mulch shall be free of debris, construction waste and hardwood chips.
- Mulch shall not be placed against trunks or on top of branches and foliage.

WATERING

- The Contractor shall water all plants and turf areas immediately after planting to the depth of their root systems.
- The Contractor shall carry out supplemental watering of all new plants for the first full growing season under warranty
- Watering shall supplement natural precipitation to ensure soil moisture content is maintained at 50 percent to 100 percent field capacity.
- A minimum frequency of once per month throughout the growing season is required. Apply water to the root area, around the trunk/stem and within the dripline to saturate the soil to a minimum of 500mm.
- The Contractor shall water all coniferous trees in late fall, prior to freeze-up.
- Watering bags may be used for trees. 20 gallon drip watering bags shall be installed at the base of each tree with no mulch between the bag and the trunk. The Contractor shall monitor bags
- and tree trunks for damage and repair/replace as required. Watering bags shall be removed during winter and at the end of the warranty period.
- If no automated irrigation system or on-site hose bib has been provided for watering operations, the Contractor shall provide water to the site. Watering operations shall not disturb or wash away mulch, soil or turf.
- The Contractor shall monitor new plantings for signs of drought.

<u>SOD</u>

- Sod all be designated and disturbed areas.
- Sod shall be certified Number One Grade Natural Grass Nursery Sod *Kentucky Bluegrass/Fine Fescue Mix*, grown and sold in accordance with the Nursey Sod Growers Association of
- Approval of site preparation shall be obtained prior to commencement of sod placement.
- Fertilizer shall be applied as identified by growing medium test results.
- Sodding shall be carried out during periods when seasonal conditions provide sucessful rooting and continued growth. All sodding shall be conducted when growing media is free of frost, snow and standing water.
- Sod shall be pegged where required to provide secure anchorage. Pegs shall be removed before pedestrian traffic is permitted and after turf is well rooted.
- The Contractor shall install temporary barricades and signage to protect newly sodded areas from damage from pedestrian and vehicular traffic.
- Upon installation the Contractor shall water the sod to saturate the sod and upper 100mm of topsoil. After the sod and soil have dried sufficiently to prevent damage, it shall be rolled.
- The Contractor shall water sodded areas in sufficent quantities and at frequency required to maintain optimum soil moisture to a depth of 100mm until rooted and at weekly intervals during
- 10. The Contractor shall be responsible for mowing the sod areas at least once to a height of 50mm when or before it reaches a height of 75mm. The last mowing shall be within 48 hours of field review for acceptance.
- 11. Sod shall be sufficiently established so that its roots are growing into the underlying growing medium with no visible seams and free of weeds for acceptance.

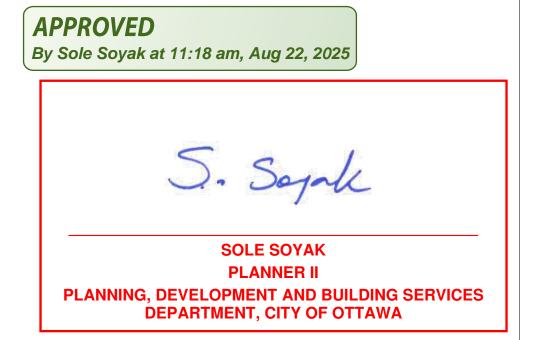

Coniferous Tree Detail

1.Excavate continuous planting bed where woody

shrubs and perennials are mass planted as

2.All perennials and shrubs are to be planted in

continuous planting beds unless otherwise

3. Planting pit sides and bottom shall be scarified

the CSLA Canadian Landscape Standard for

5. Plants shall be set plumb in the planting beds.

7. Water thoroughly during growing season to

Shrub Planting

period to supplement precipitation.

Scale: 1:25

compacted depth four-season aged pine bark

maintain vigorous, healthy growth from the time

of delivery/installation to the end of warranty

properties for Type 2P in table T-5.3.5.3.

Growing Medium nutrients in Section 5.2.7 and

6.Continuously mulch planting beds with 100mm

to a depth of 150mm with backfill and growing

Scale: 1:25


medium thoroughly mixed in.


4. Native backfill shall be used with soil


General Notes


mulch.

shown on plans.

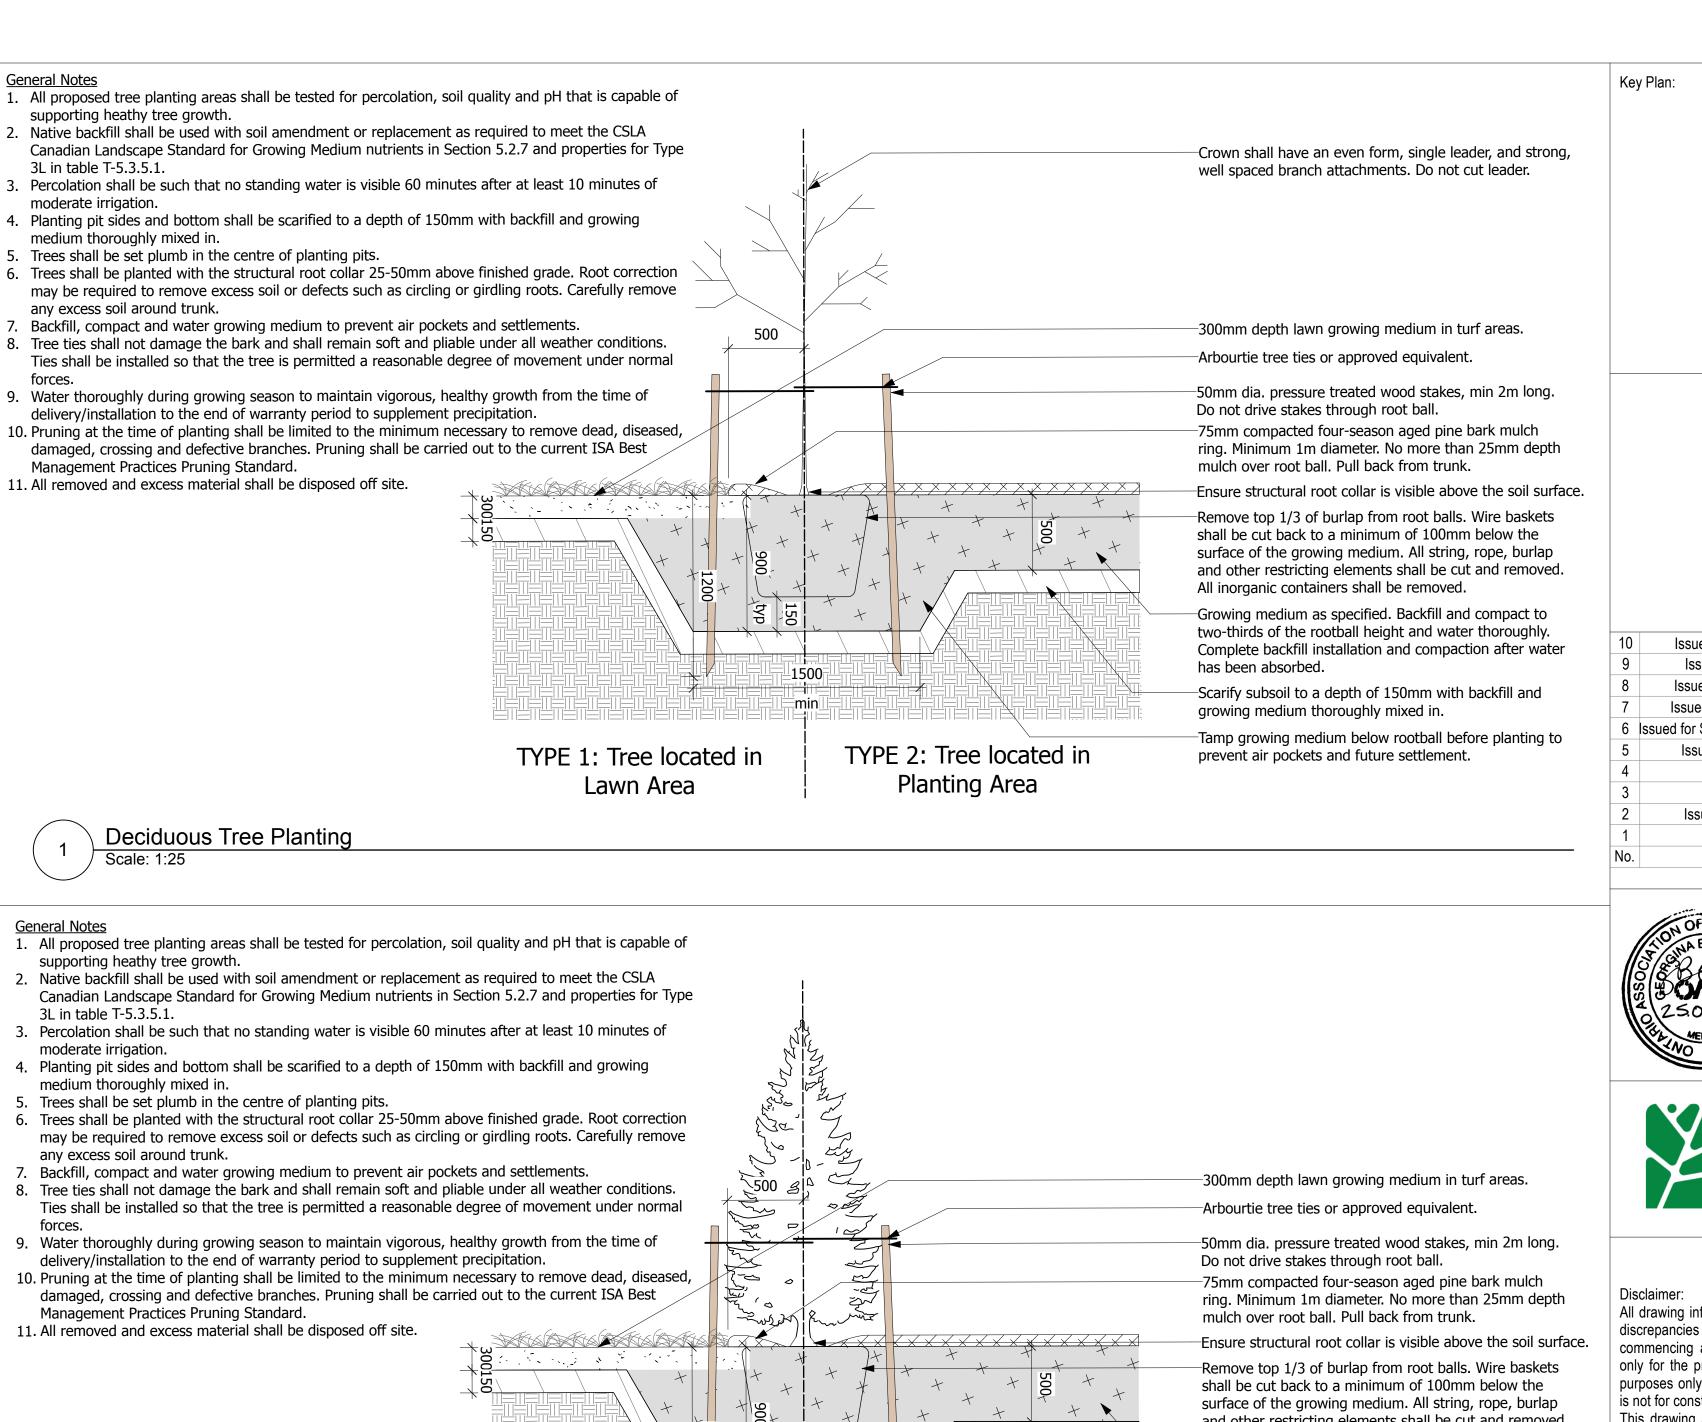

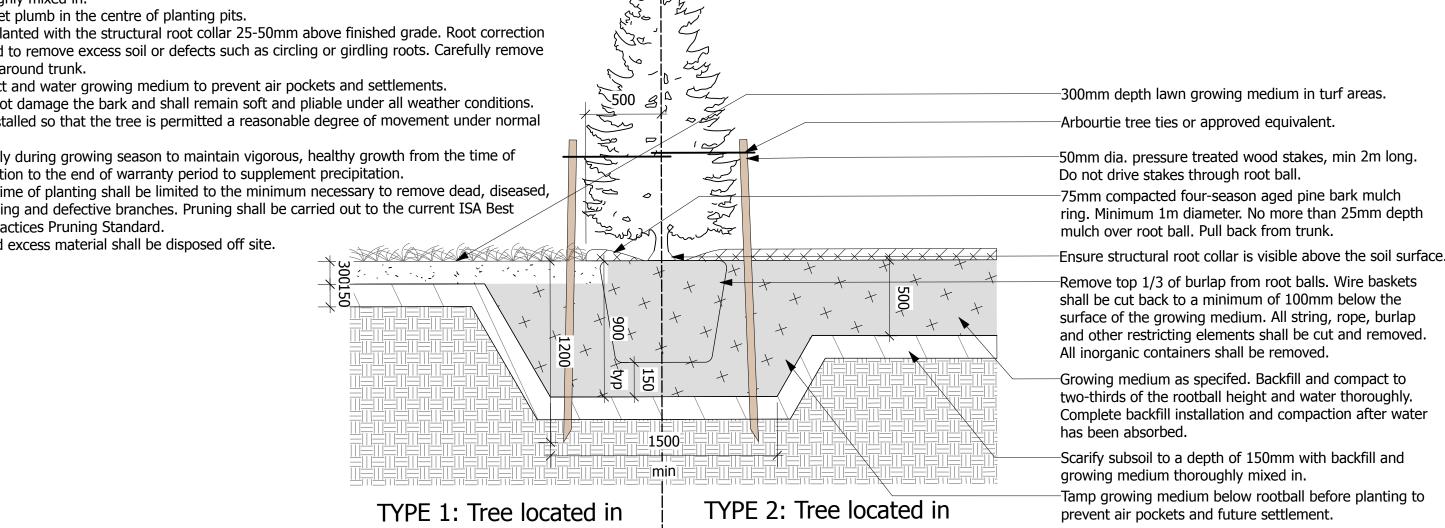


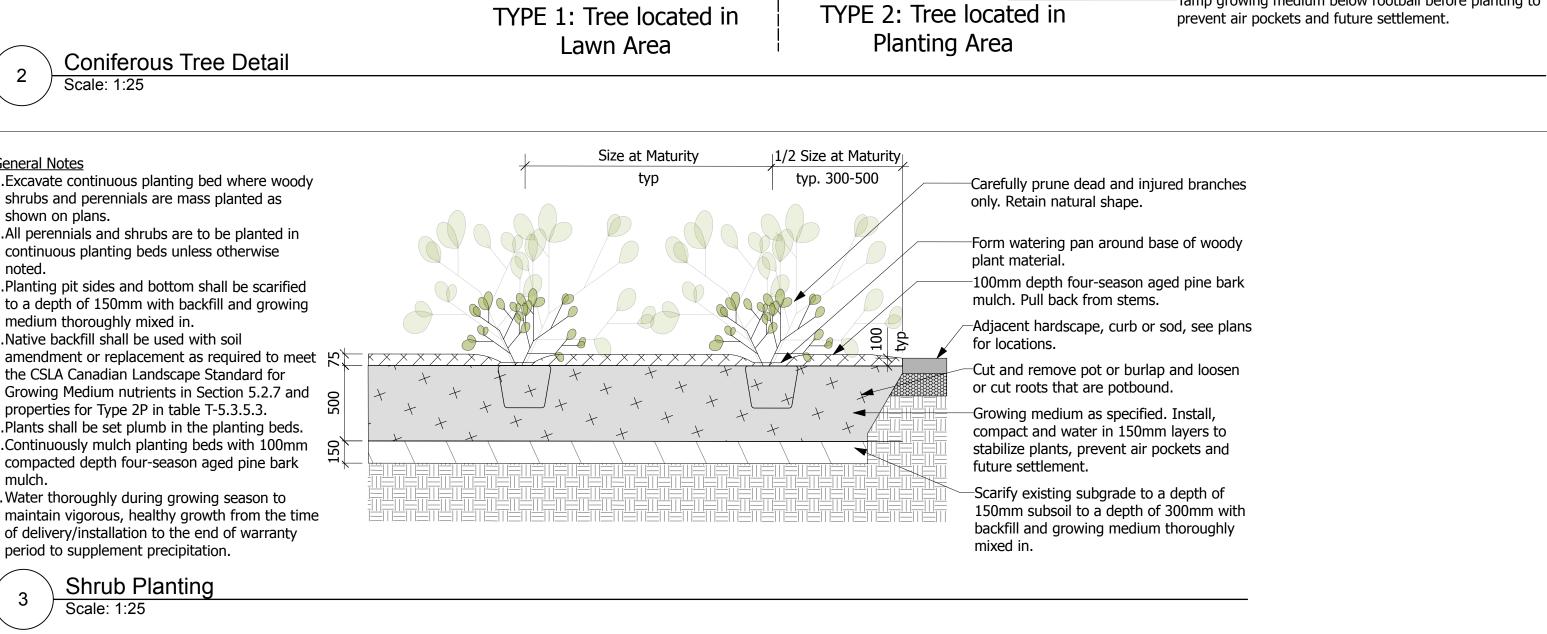


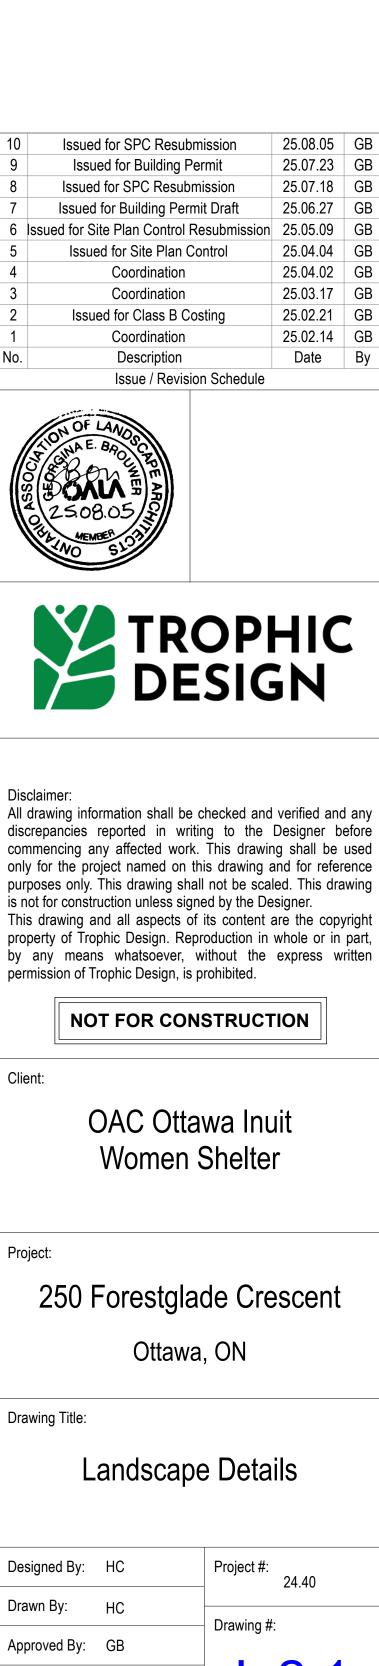


#19300

Date: 25/01/09

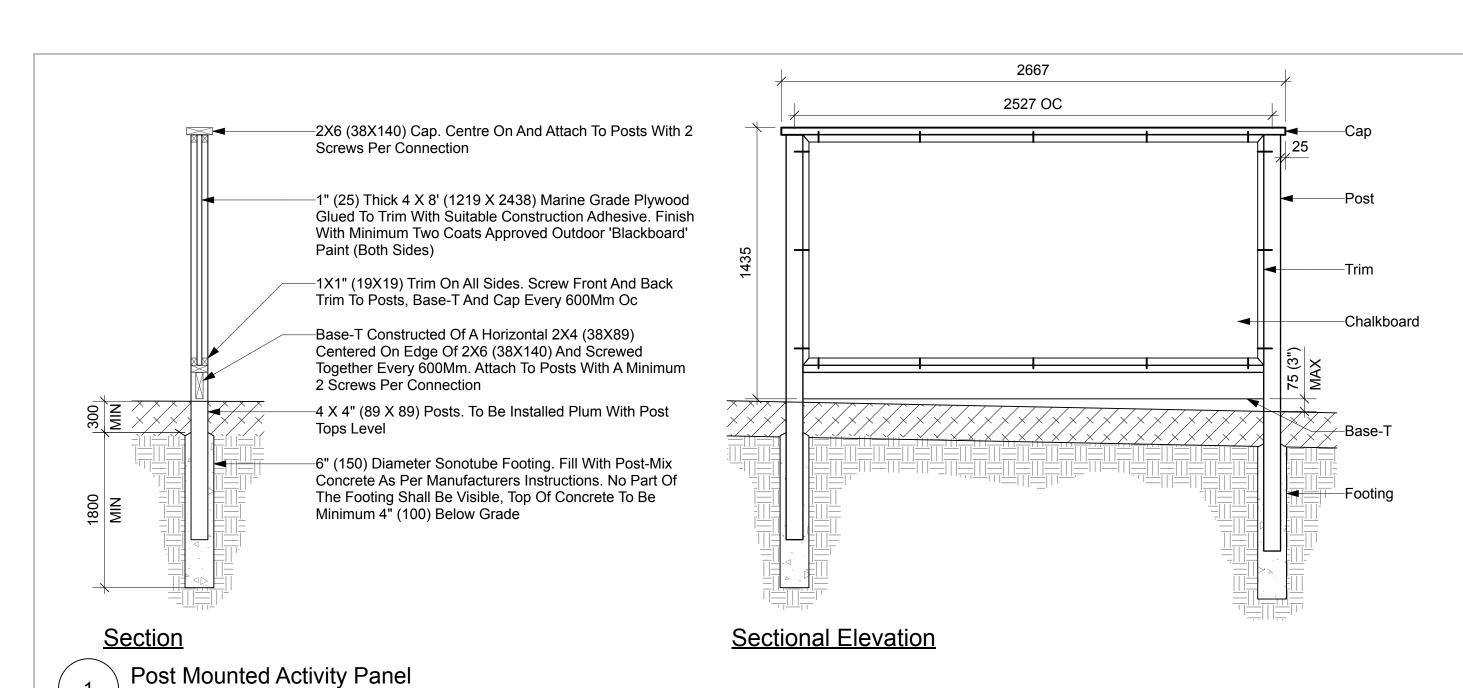

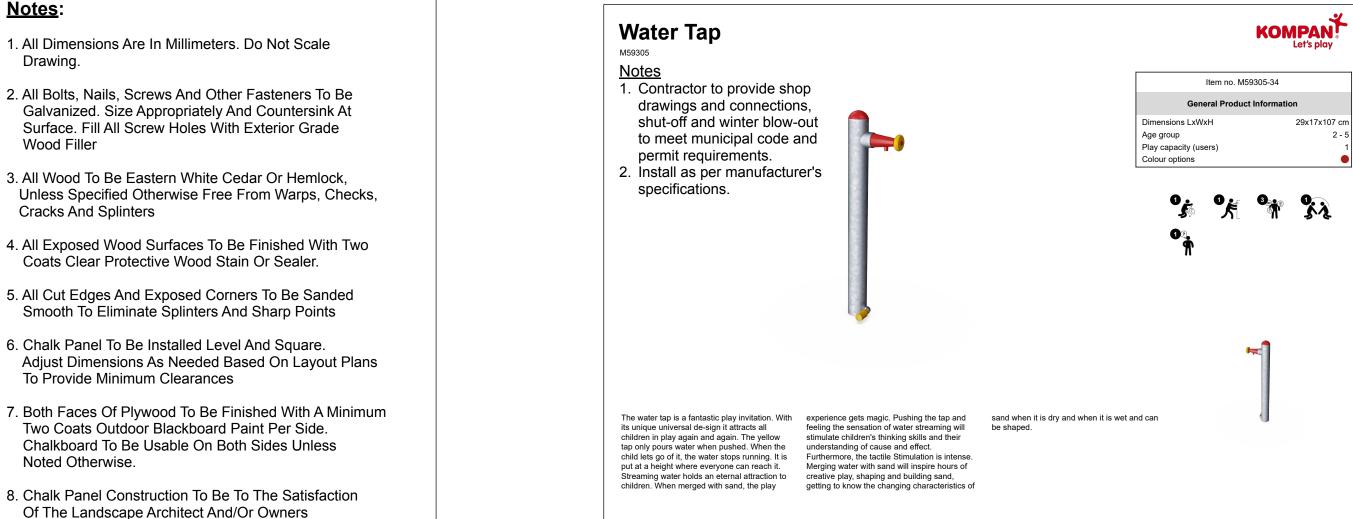

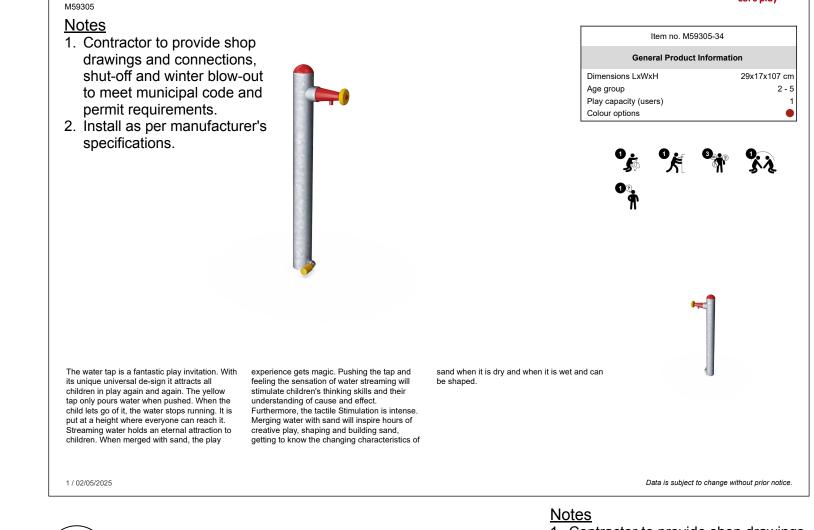

Kompan Water Tap

1. Contractor to provide shop drawings.




JUNIOR FORM - CLOUD SMALL Intended user age: 18m-5y

PRODUCT INFORMATION **CSA Z614**


The small Cloud is perfect for climbing, lounging or hiding. Circular cutouts that range from 2.5" to 3.5" are just the right size for fingers, hands and toes. The circular cutouts can catch the sunlight beams of different sizes as light and shadow playfully dot the ground. They are perfect for active and social play and add whimsy and art to a playscape or a public space.



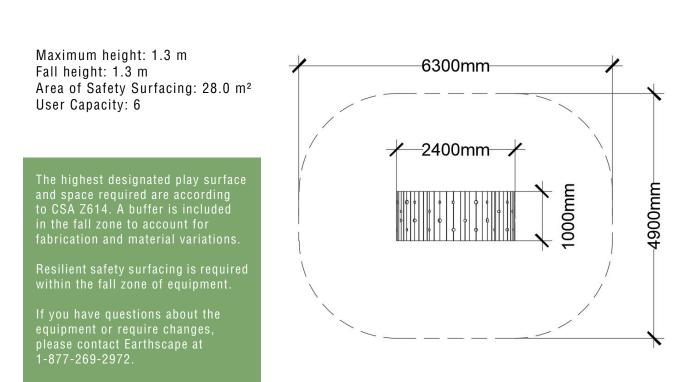

<u>Notes</u> 1. Contractor to provide shop drawings.

Earthscape Junior Form- Cloud Small (Stain: Snow)

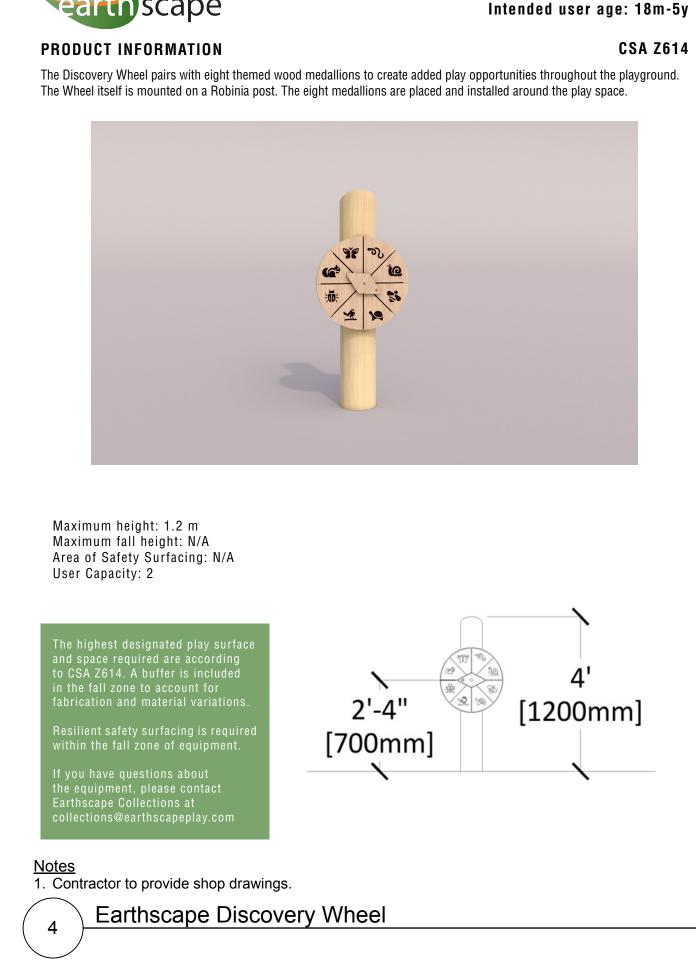

Representative.

Do not scale drawings.

checks and cracks.

with tops cut horizontal. Vary

heights as indicated on plans.

Play Post


Scale: 1:25

5.Installation to comply with

owner's representative.


to be galvanized.


DISCOVERY WHEEL

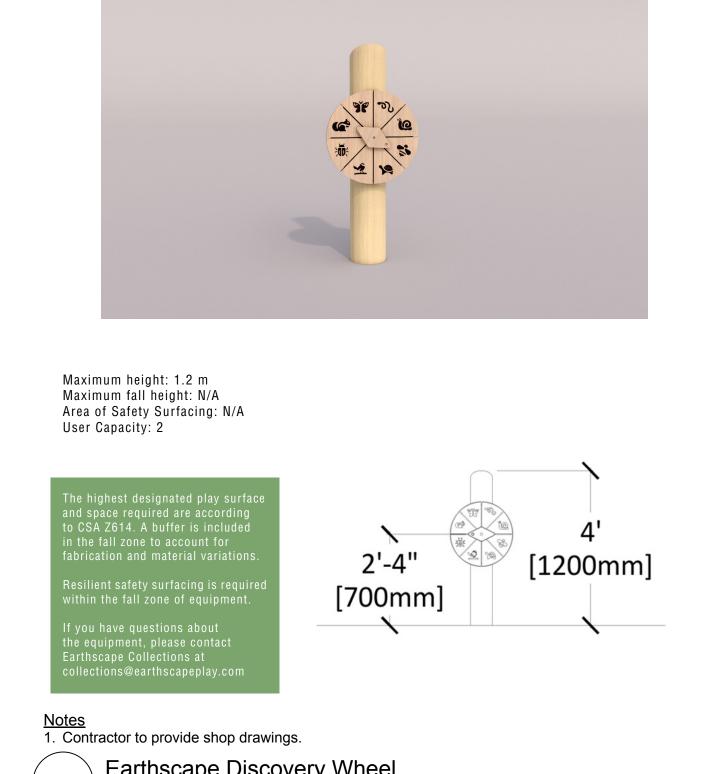






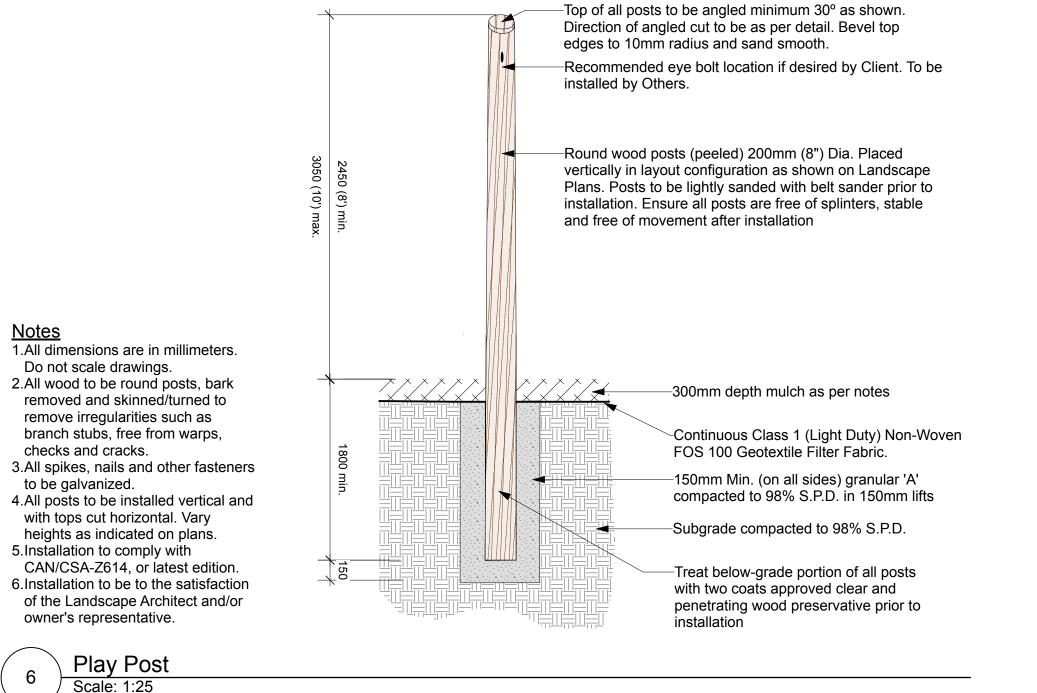

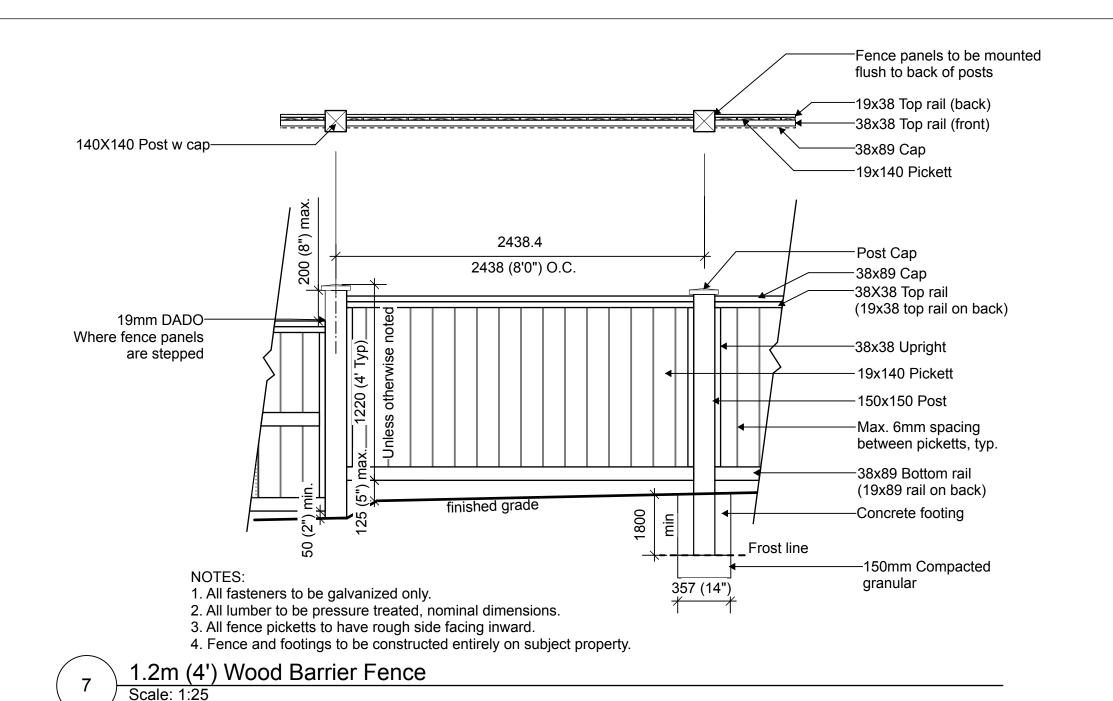

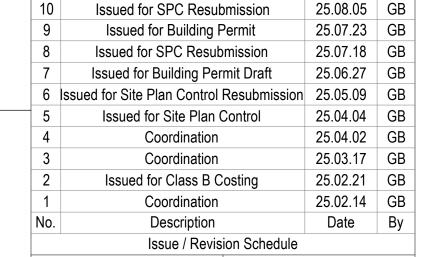



Key Plan:



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Client:

OAC Ottawa Inuit Women Shelter

Project:


250 Forestglade Crescent

Ottawa, ON

Drawing Title:

Landscape Details

Designed By: HC	Project #: 24.40
Drawn By: HC	
Approved By: GB	Drawing #:
Date: 25/01/09	L 2.2

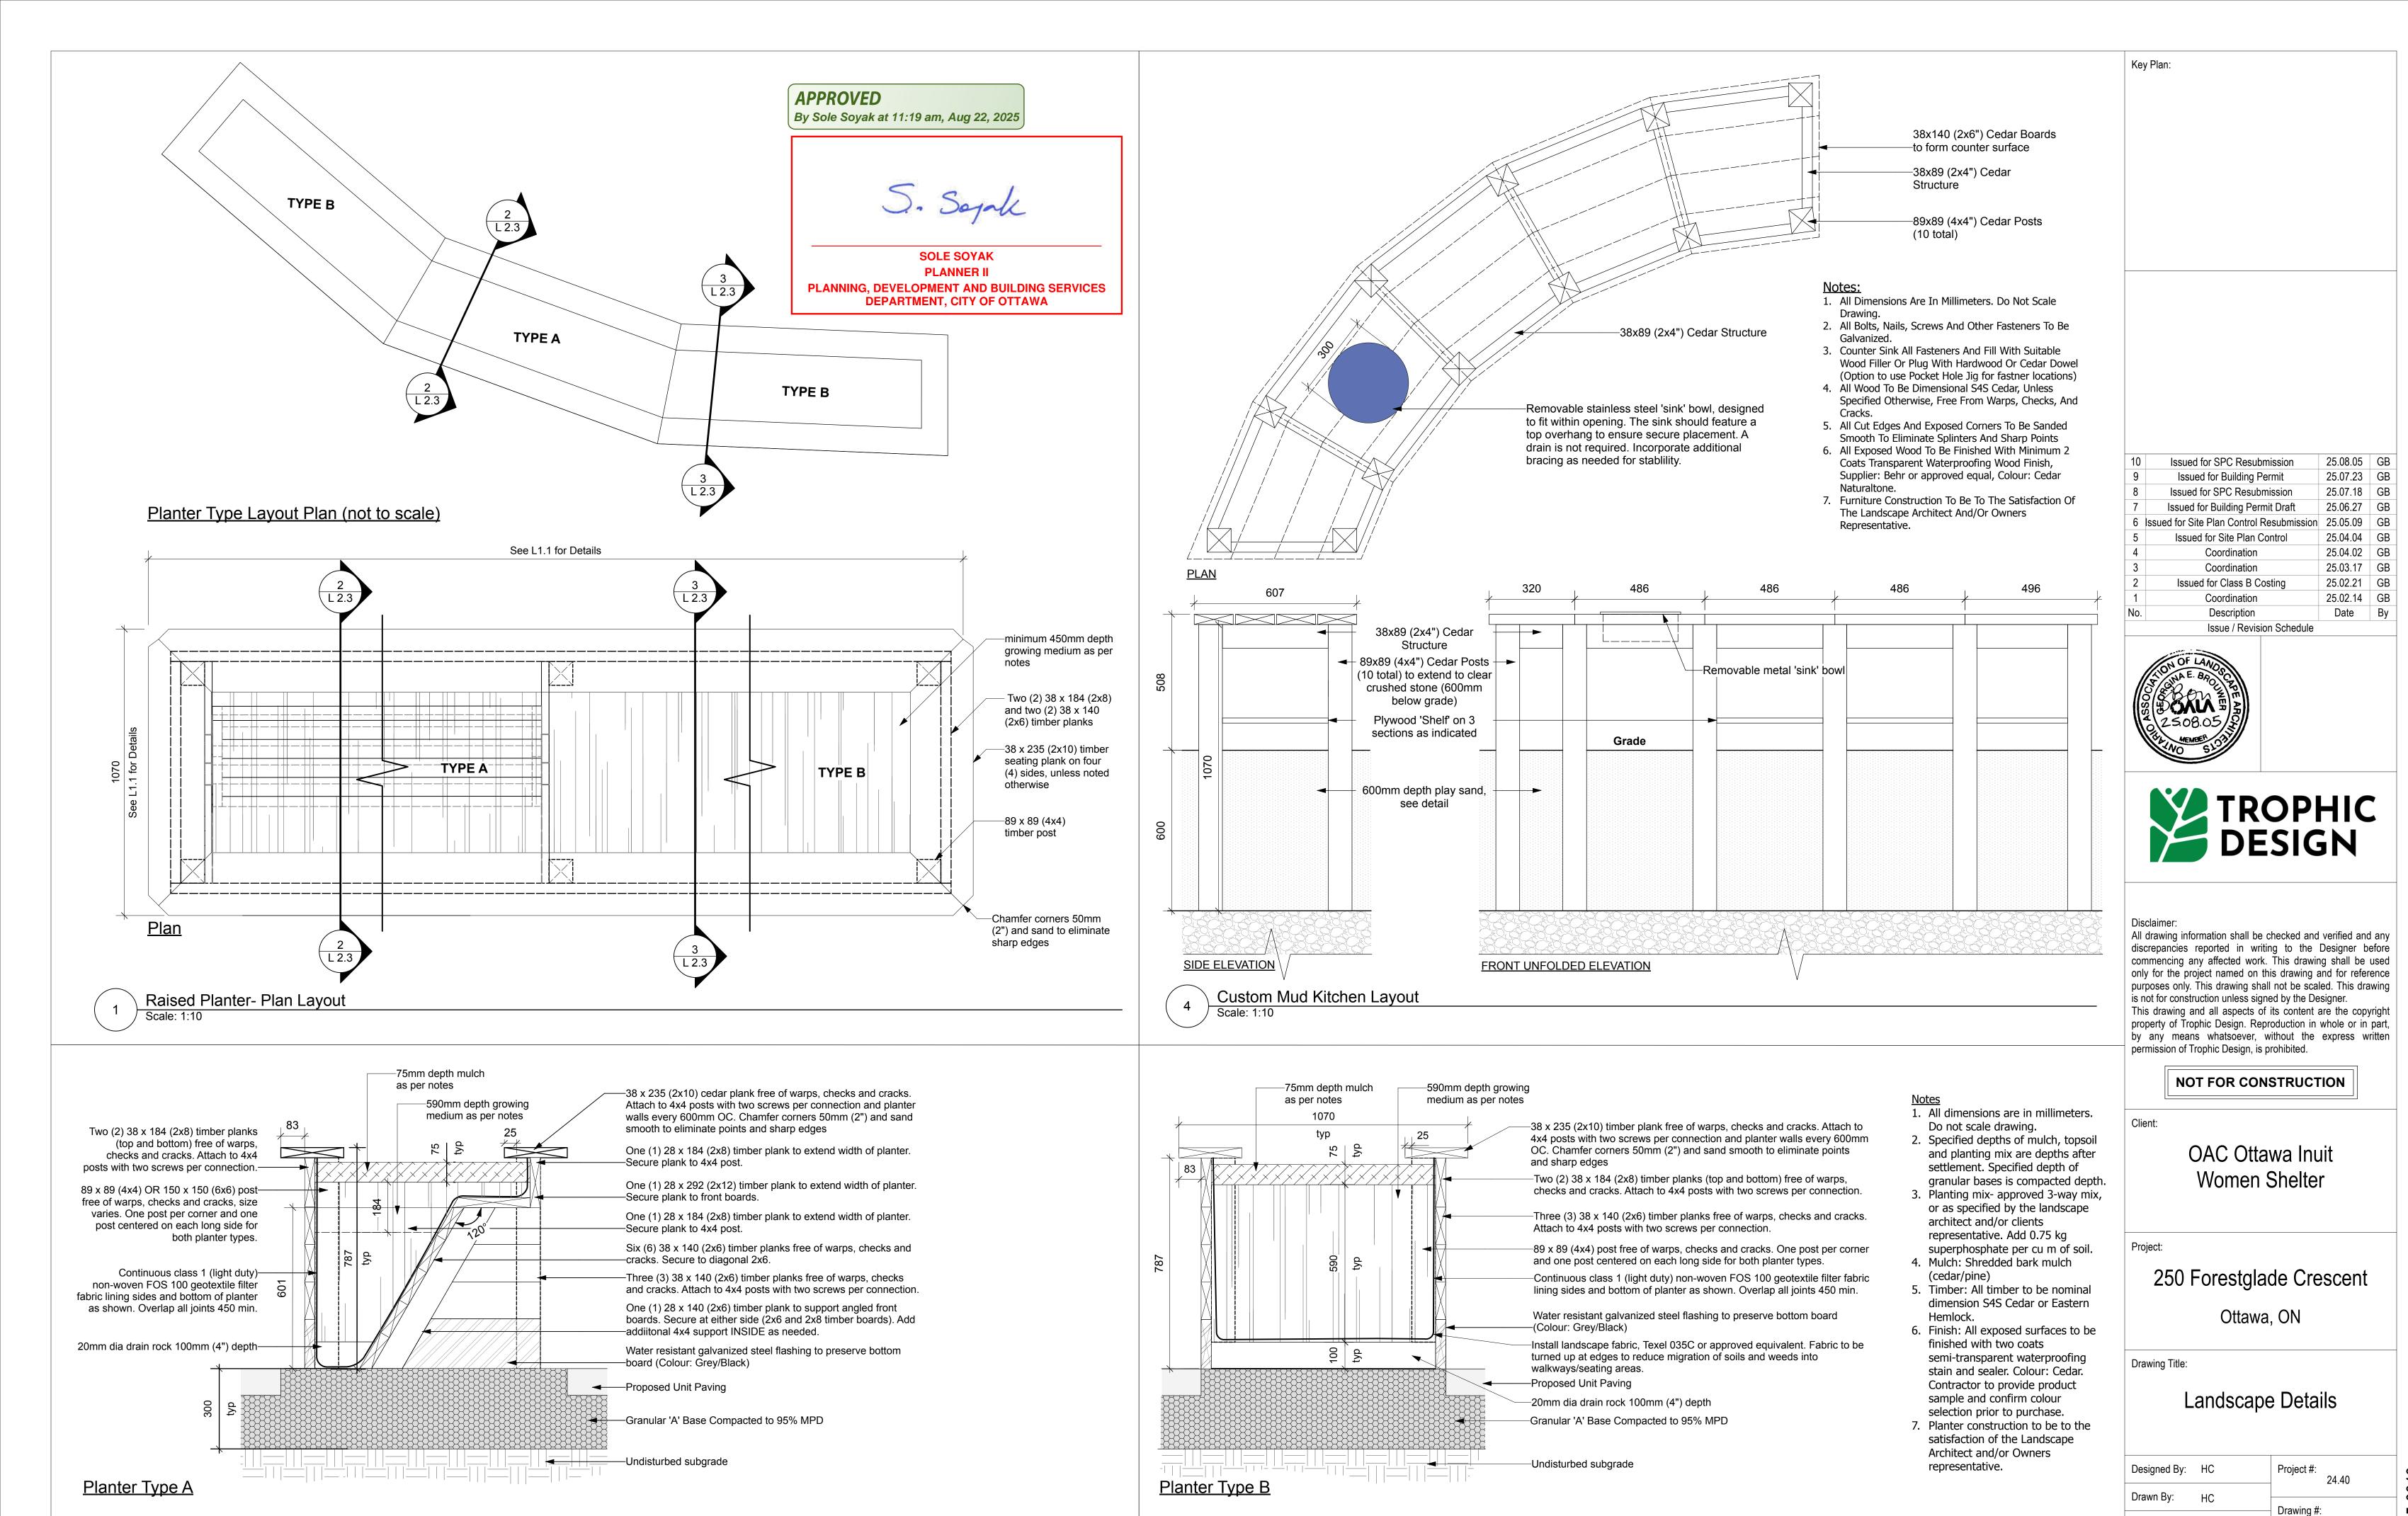

Raised Planter- Type B

Scale: 1:10

Raised Planter- Type A


Scale: 1:10


#19300

Approved By: GB

Date: 25/01/09


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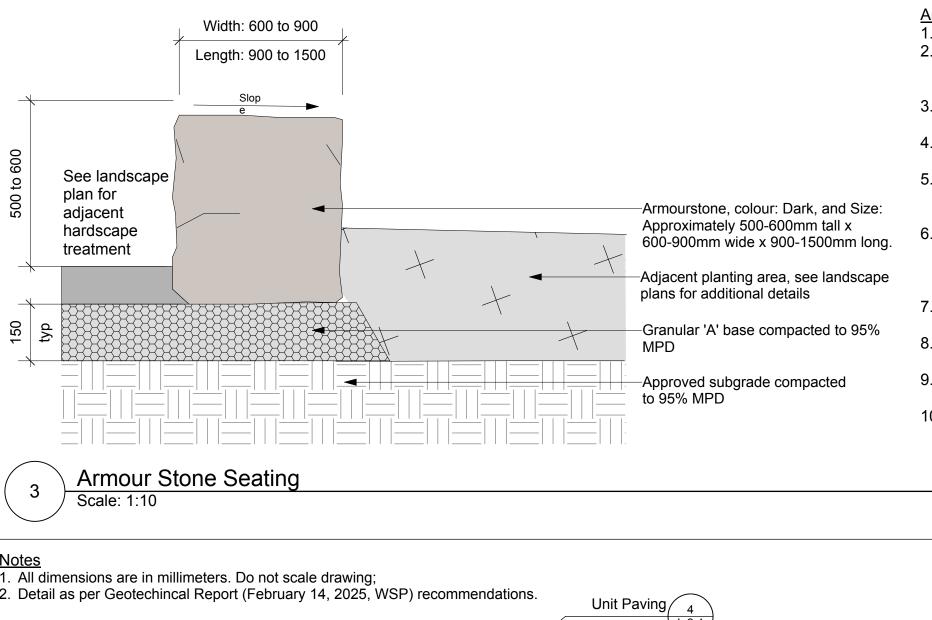


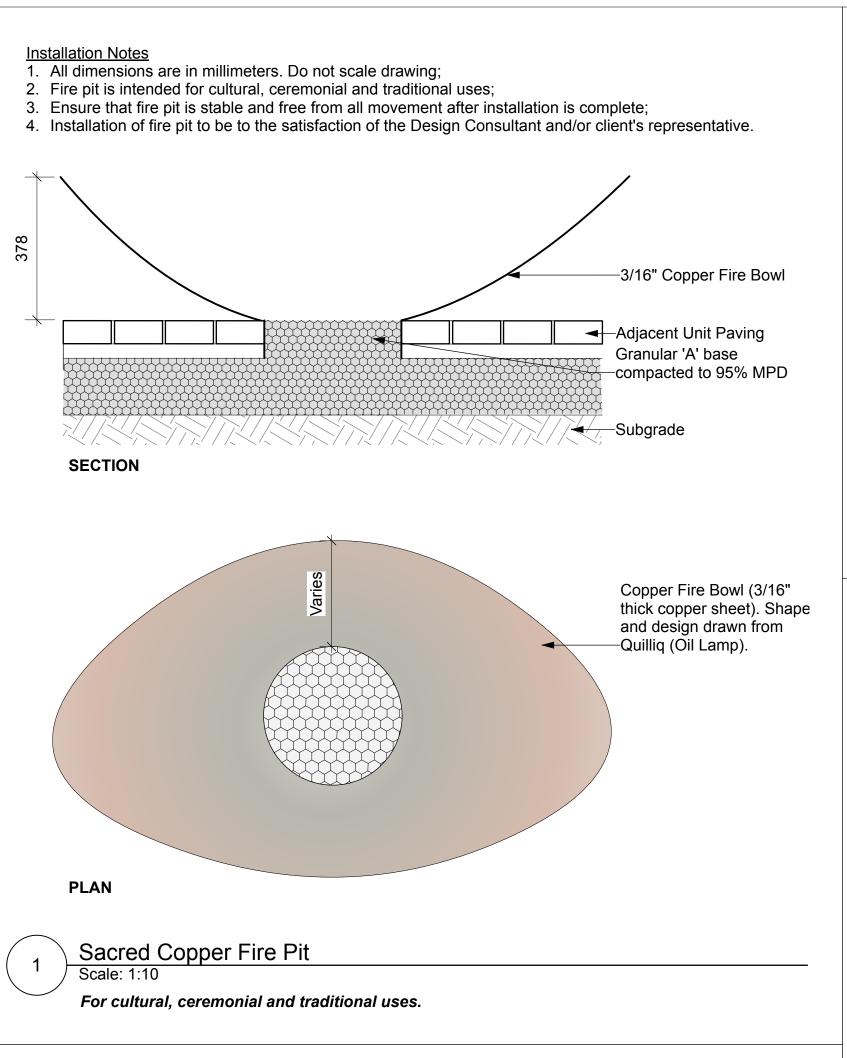


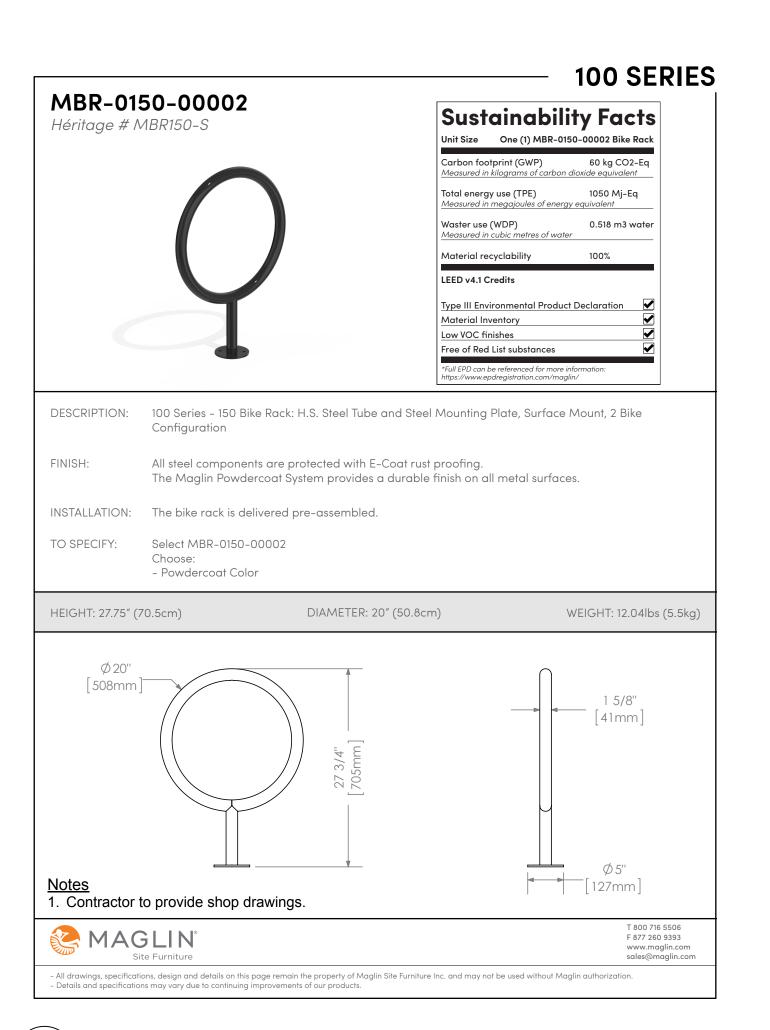Maglin MBR-0150-00002 Bike Rack

Finish: 'Silver 14'. Surface Mount.



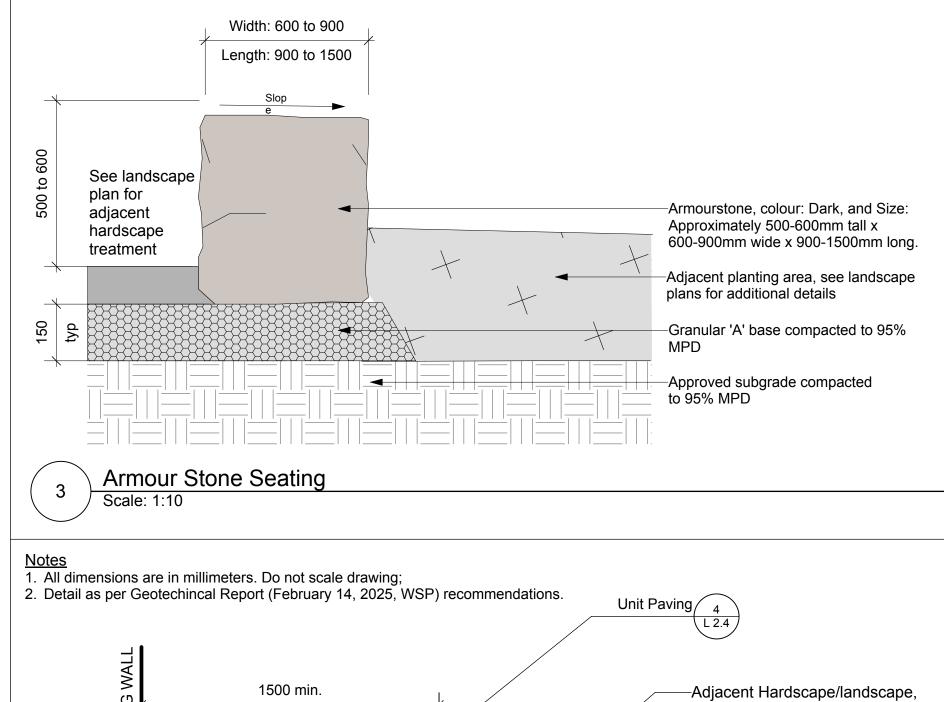

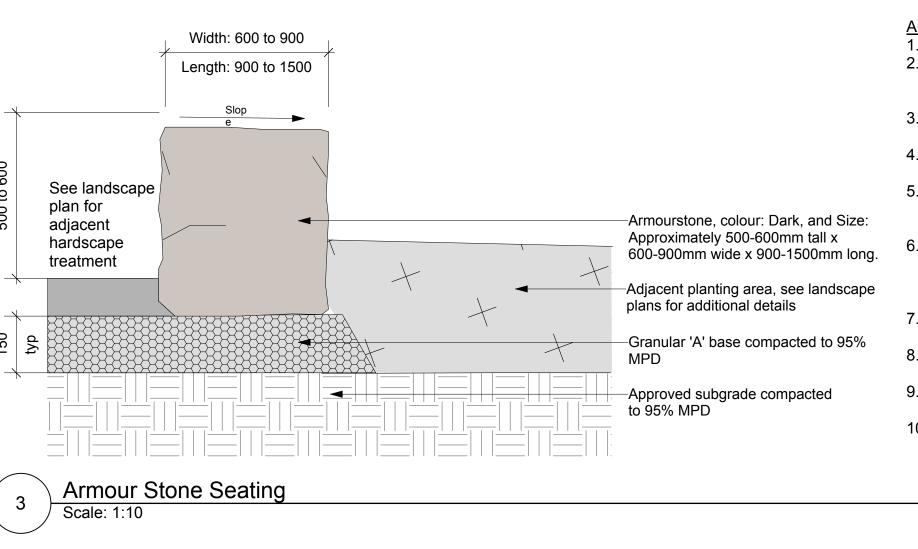


Armour Stone Installation Notes

- 1. All dimensions are in millimeters. Do not scale drawing; 2. Specified depths of mulch and topsoil are depths after settlement. Specified depth of granular base is compacted depth;
- 3. Install all armour stone with a minimum 50mm below
- finished grade of adjacent surface; 4. Ensure that all armour stone are stable and free from all
- movement after installation is complete 5. Gaps between adjacent armour stones are to be minimized to the greatest extent possible. Gaps are to
- be less than 50mm. 6. Gaps greater than 50mm shall be parged with a concrete mix or filled by alternative method to the satisfaction of the Landscape Architect. Contractor to approve method of filling prior to completing;
- 7. Ensure that all armour stone are installed with a maximum 2% slope; 8. Ensure all extruding angles are chiseled and there are
- no sharp corners. 9. Ensure all armour stone seating surfaces are level with adjacent armour stone; and

10. Installation of armour stone to be to the satisfaction of the Design Consultant and/or clients representative.

1. All dimensions are in millimeters. Do not scale drawing; 2. Unit Paving within 1500mm of building to have plastic clay cap and free draining backfill beneath as per Geotechincal Report (February 14, 2025, WSP) recommendations. Refer to L1.1 for layout. 3. Contractor to provide edge restraint for all locations where unit paving meets landscape areas to ensure stability and prevent movement. Edge restaint installation shall comply with manufacturer recommendations and industry standards. Hollandstone Pavers. Size: Standard, 100x200x60mm. Colour: Varies, Refer to Landscape Plan. Supplier: Unilock or slope to drain approved equal. Running Bond Pattern. -Polymeric Jointing Sand -Screening leveling course min. 25mm- max. 38mm depth -Edge Restraint (Buried) where paving is adjacent to landscape -Granular 'A' base course compacted to 95% M.P.D., 150mm depth Subgrade compacted to 95% M.P.D. **Unit Paving** Scale: 1:10

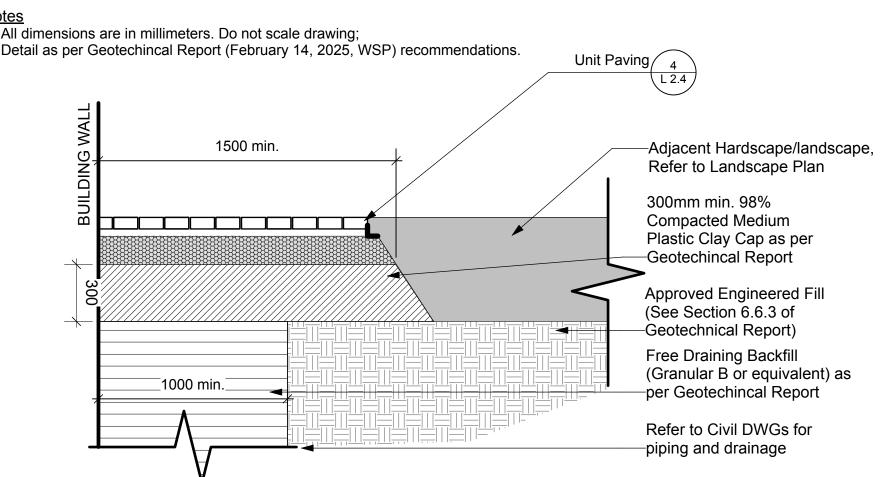

Plastic Clay Cap and Unit Paving

1. All dimensions are in millimeters. Do not scale drawing;

2. Contractor to provide shop drawings or detailed design for:

Rain Chain Installation Kit 6": https://www.rainchainscanada.com/product/copper-installation-kit-6/

3. RainChains Kenchiku Pure Copper Rain Chain: https://www.rainchainscanada.com/product/kenchiku-pure-copper-rain-chain/. 4. The Kenchiku Pure Copper Rain Chain is to be ordered with all welded links for a strong connection.

5. Chain to be secured to ground with metal anchoring stake.

6. Installation of rain chain and cobble channel to be to the satisfaction of the Design Consultant and/or clients representative. -Roof Overhang, Refer to Structural and Arch DWGs -Eavestrough, Refer to Arch DWGs -RainChains Copper Installation Kit 6" attached to eavestrough, Refer to Arch DWGs for installation to eaves. -RainChains Kenchiku Pure Copper Rain Chain. Length: 6334mm (x4 chain for third floor), 3675mm (x2 for second floor). Remove chain links as needed to acheive exact Unit Paving —Secure to ground with metal anchoring -300-600mm smooth round river rock, as needed to limit splash onto adjacent paving Grading as per -25-75mm Smooth River Rock (150mm Deep) Filter fabric Texel 035C or approved equal. Install continuous below river rock, overlap seams 150mm. -Amended Soil, 600mm depth 1600 1219 (4') Refer to Landscape Plan Cobble Splash Pad with Rain Chain




3429

SOLE SOYAK PLANNER II PLANNING, DEVELOPMENT AND BUILDING SERVICES **DEPARTMENT, CITY OF OTTAWA**

By Sole Soyak at 11:19 am, Aug 22, 2025

APPROVED

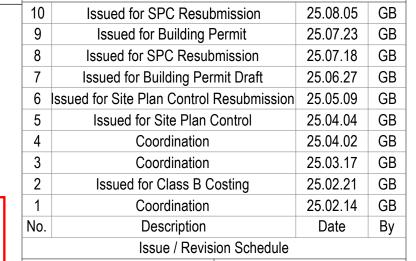



Key Plan:



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OAC Ottawa Inuit Women Shelter

Project:


250 Forestglade Crescent


Ottawa, ON

Drawing Title:

Landscape Details

Designed By: HC	Project #: 24.40
Drawn By: HC	
Approved By: GB	Drawing #:
Date: 25/01/09	L 2.4

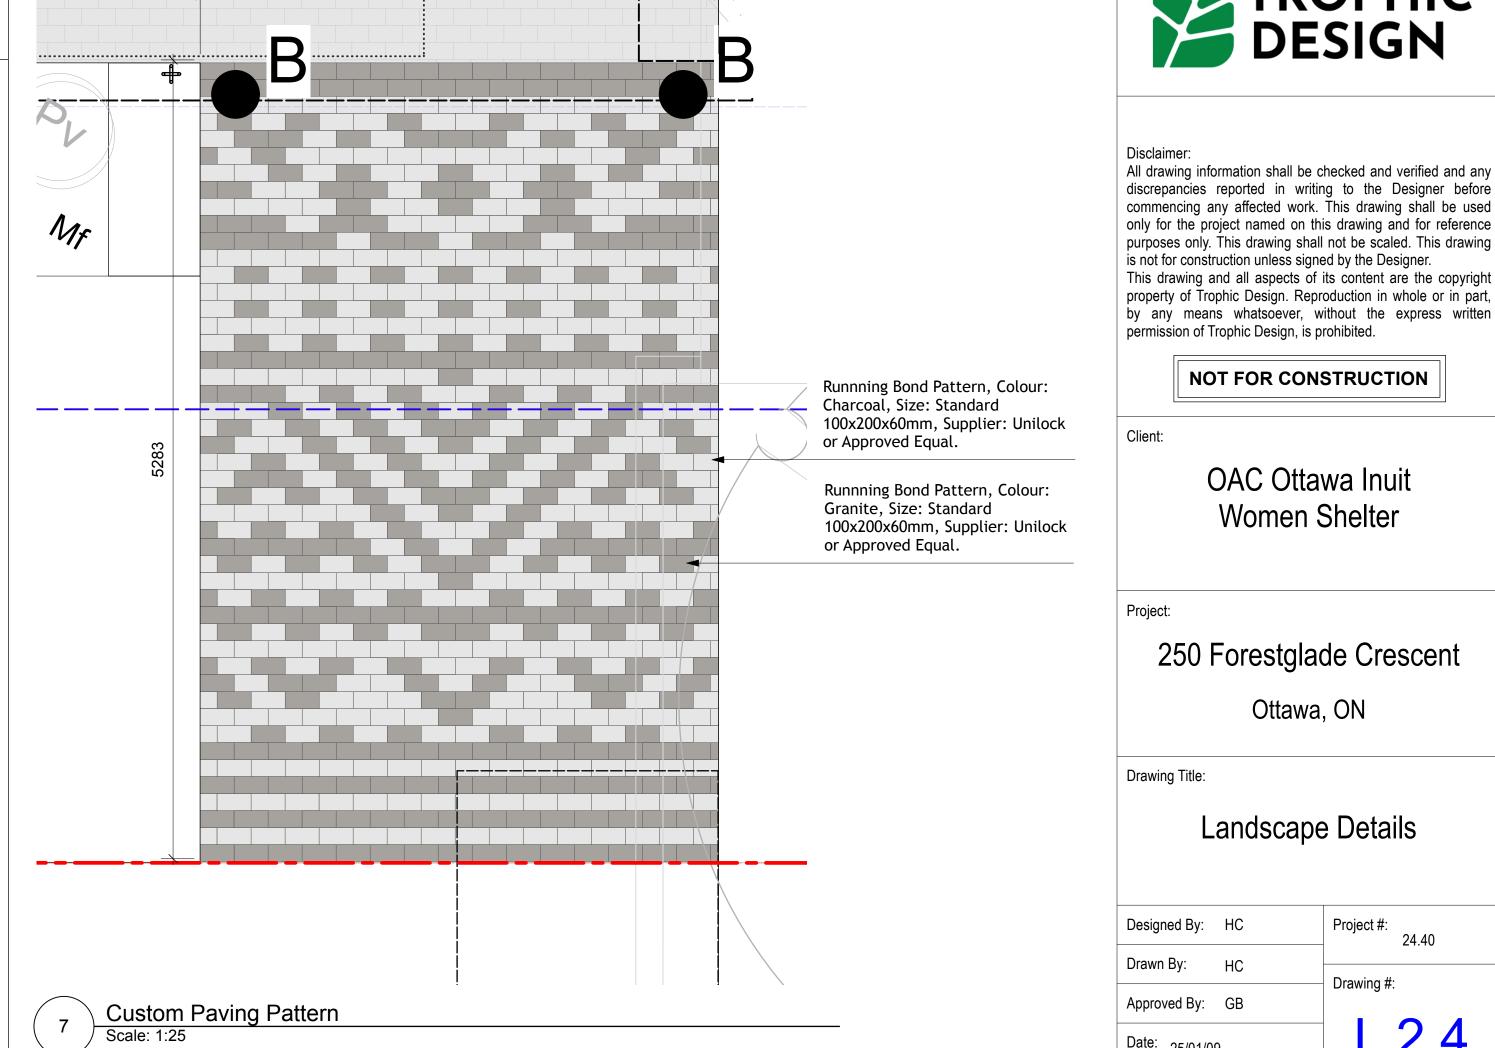


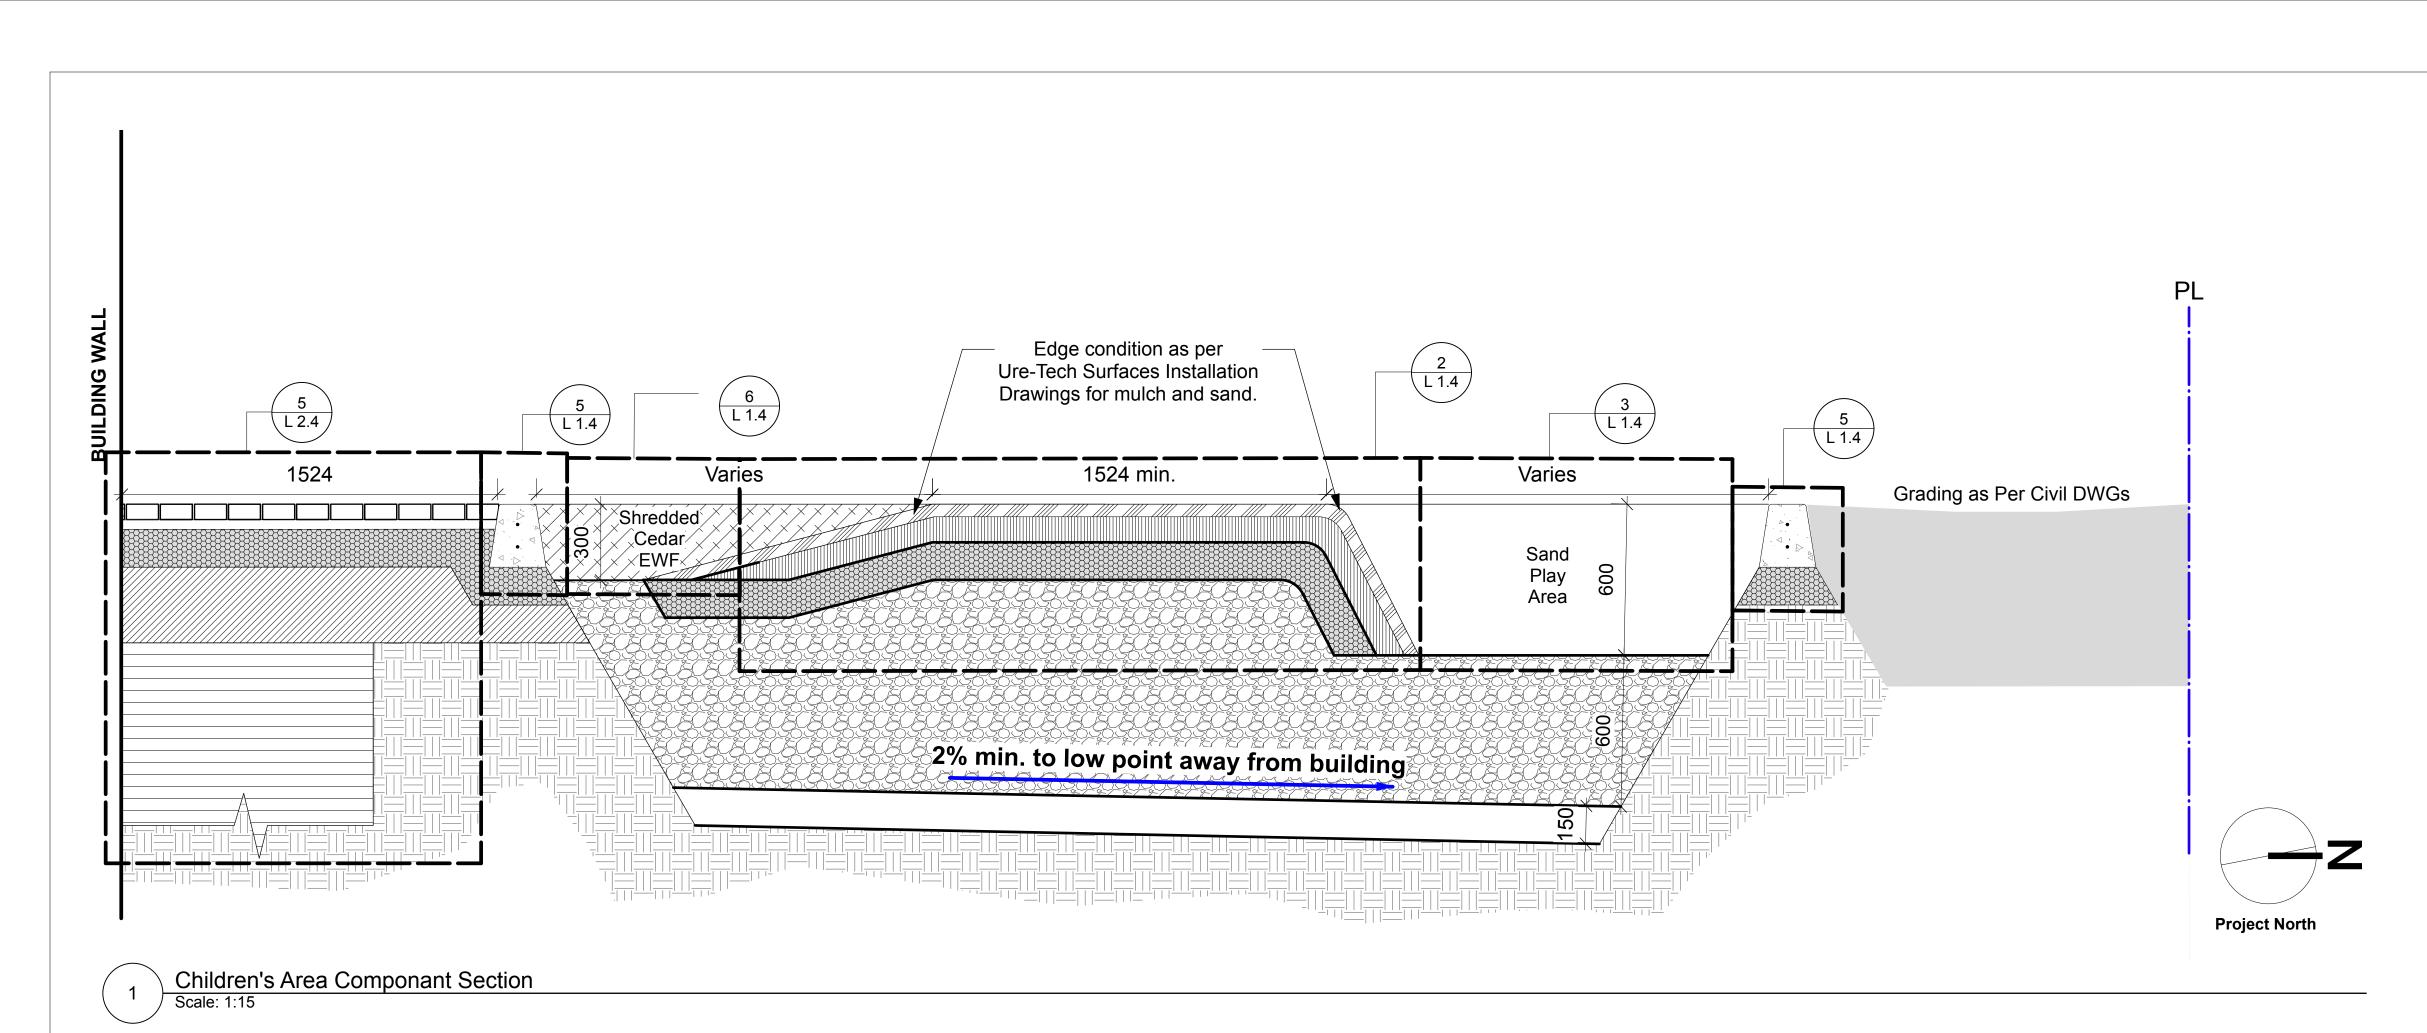

APPROVED
By Sole Soyak at 11:19 am, Aug 22, 2025

SOLE SOYAK
PLANNER II
PLANNING, DEVELOPMENT AND BUILDING SERVICES
DEPARTMENT, CITY OF OTTAWA

Issued for SPC Resubmission 25.08.05 GB 25.07.23 GB Issued for Building Permit Issued for SPC Resubmission 25.07.18 GB Issued for Building Permit Draft 25.06.27 GB 6 Issued for Site Plan Control Resubmission 25.05.09 GB Issued for Site Plan Control 25.04.04 GB 25.04.02 GB Coordination 25.03.17 GB Coordination 25.02.21 GB Issued for Class B Costing 25.02.14 GB Coordination Date By Description Issue / Revision Schedule

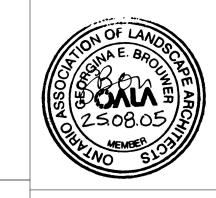

Key Plan:



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Client:

OAC Ottawa Inuit Women Shelter

Project:

250 Forestglade Crescent

Ottawa, ON

Drawing Title:

Landscape Sections

Designed By: HC

Drawn By: HC

Approved By: GB

Date: 25/01/09

Project #: 24.40

Drawing #:

L 2.5

D07-12-25-0046