



Copyright Reserved

The Contractor shall verify and be responsible for all dimensions. DO NOT scale the drawing - any errors or omissions shall be reported to Stantec without delay.
The Copyrights to all designs and drawings are the property of Stantec. Reproduction or use for any purpose other than that authorized by Stantec is forbidden.

Legend

- AREA ID
- RUNOFF COEFFICIENT
- STORM DRAINAGE AREA No.
- FUTURE AREA ID
- FUTURE RUNOFF COEFFICIENT
- FUTURE STORM DRAINAGE AREA No.
- STORM DRAINAGE BOUNDARY
- FUTURE STORM DRAINAGE BOUNDARY
- DIRECTION OF OVERLAND FLOW
- PROPOSED STORM MH AND SEWER
- PROPOSED CATCHBASIN MANHOLE
- PROPOSED CATCHBASIN
- EXISTING STORM MH AND SEWER
- EXISTING CATCHBASIN
- EXISTING COMBINED MH AND SEWER
- THERMAL INSULATION ON STORM SEWER WHERE COVER IS LESS THAN 1.5m. THERMAL INSULATION ON WATERMAIN WHERE COVER IS LESS THAN 2.4m AS PER W22.

Notes

Revision	By	Appd.	Date
1	WAJ	KJK	25.04.16
Permit-Seal			
File Name: 160402095-D8-1137 Oglvie.dwg	WAJ	KJK	WAJ 25.04.08
	Dwn.	Chkd.	Dgn.
			YY.MM.DD





Client/Project
TC UNITED DEVELOPMENT CORPORATION

1137 OGLVIE ROAD
OTTAWA, ON

Title
CONCEPTUAL STORM DRAINAGE PLAN

Project No. 160402095	Scale 1:250	Sheet 7.5	Revision 12.5m
Drawing No. SD-1	Sheet 5 of 7	Revision 1	

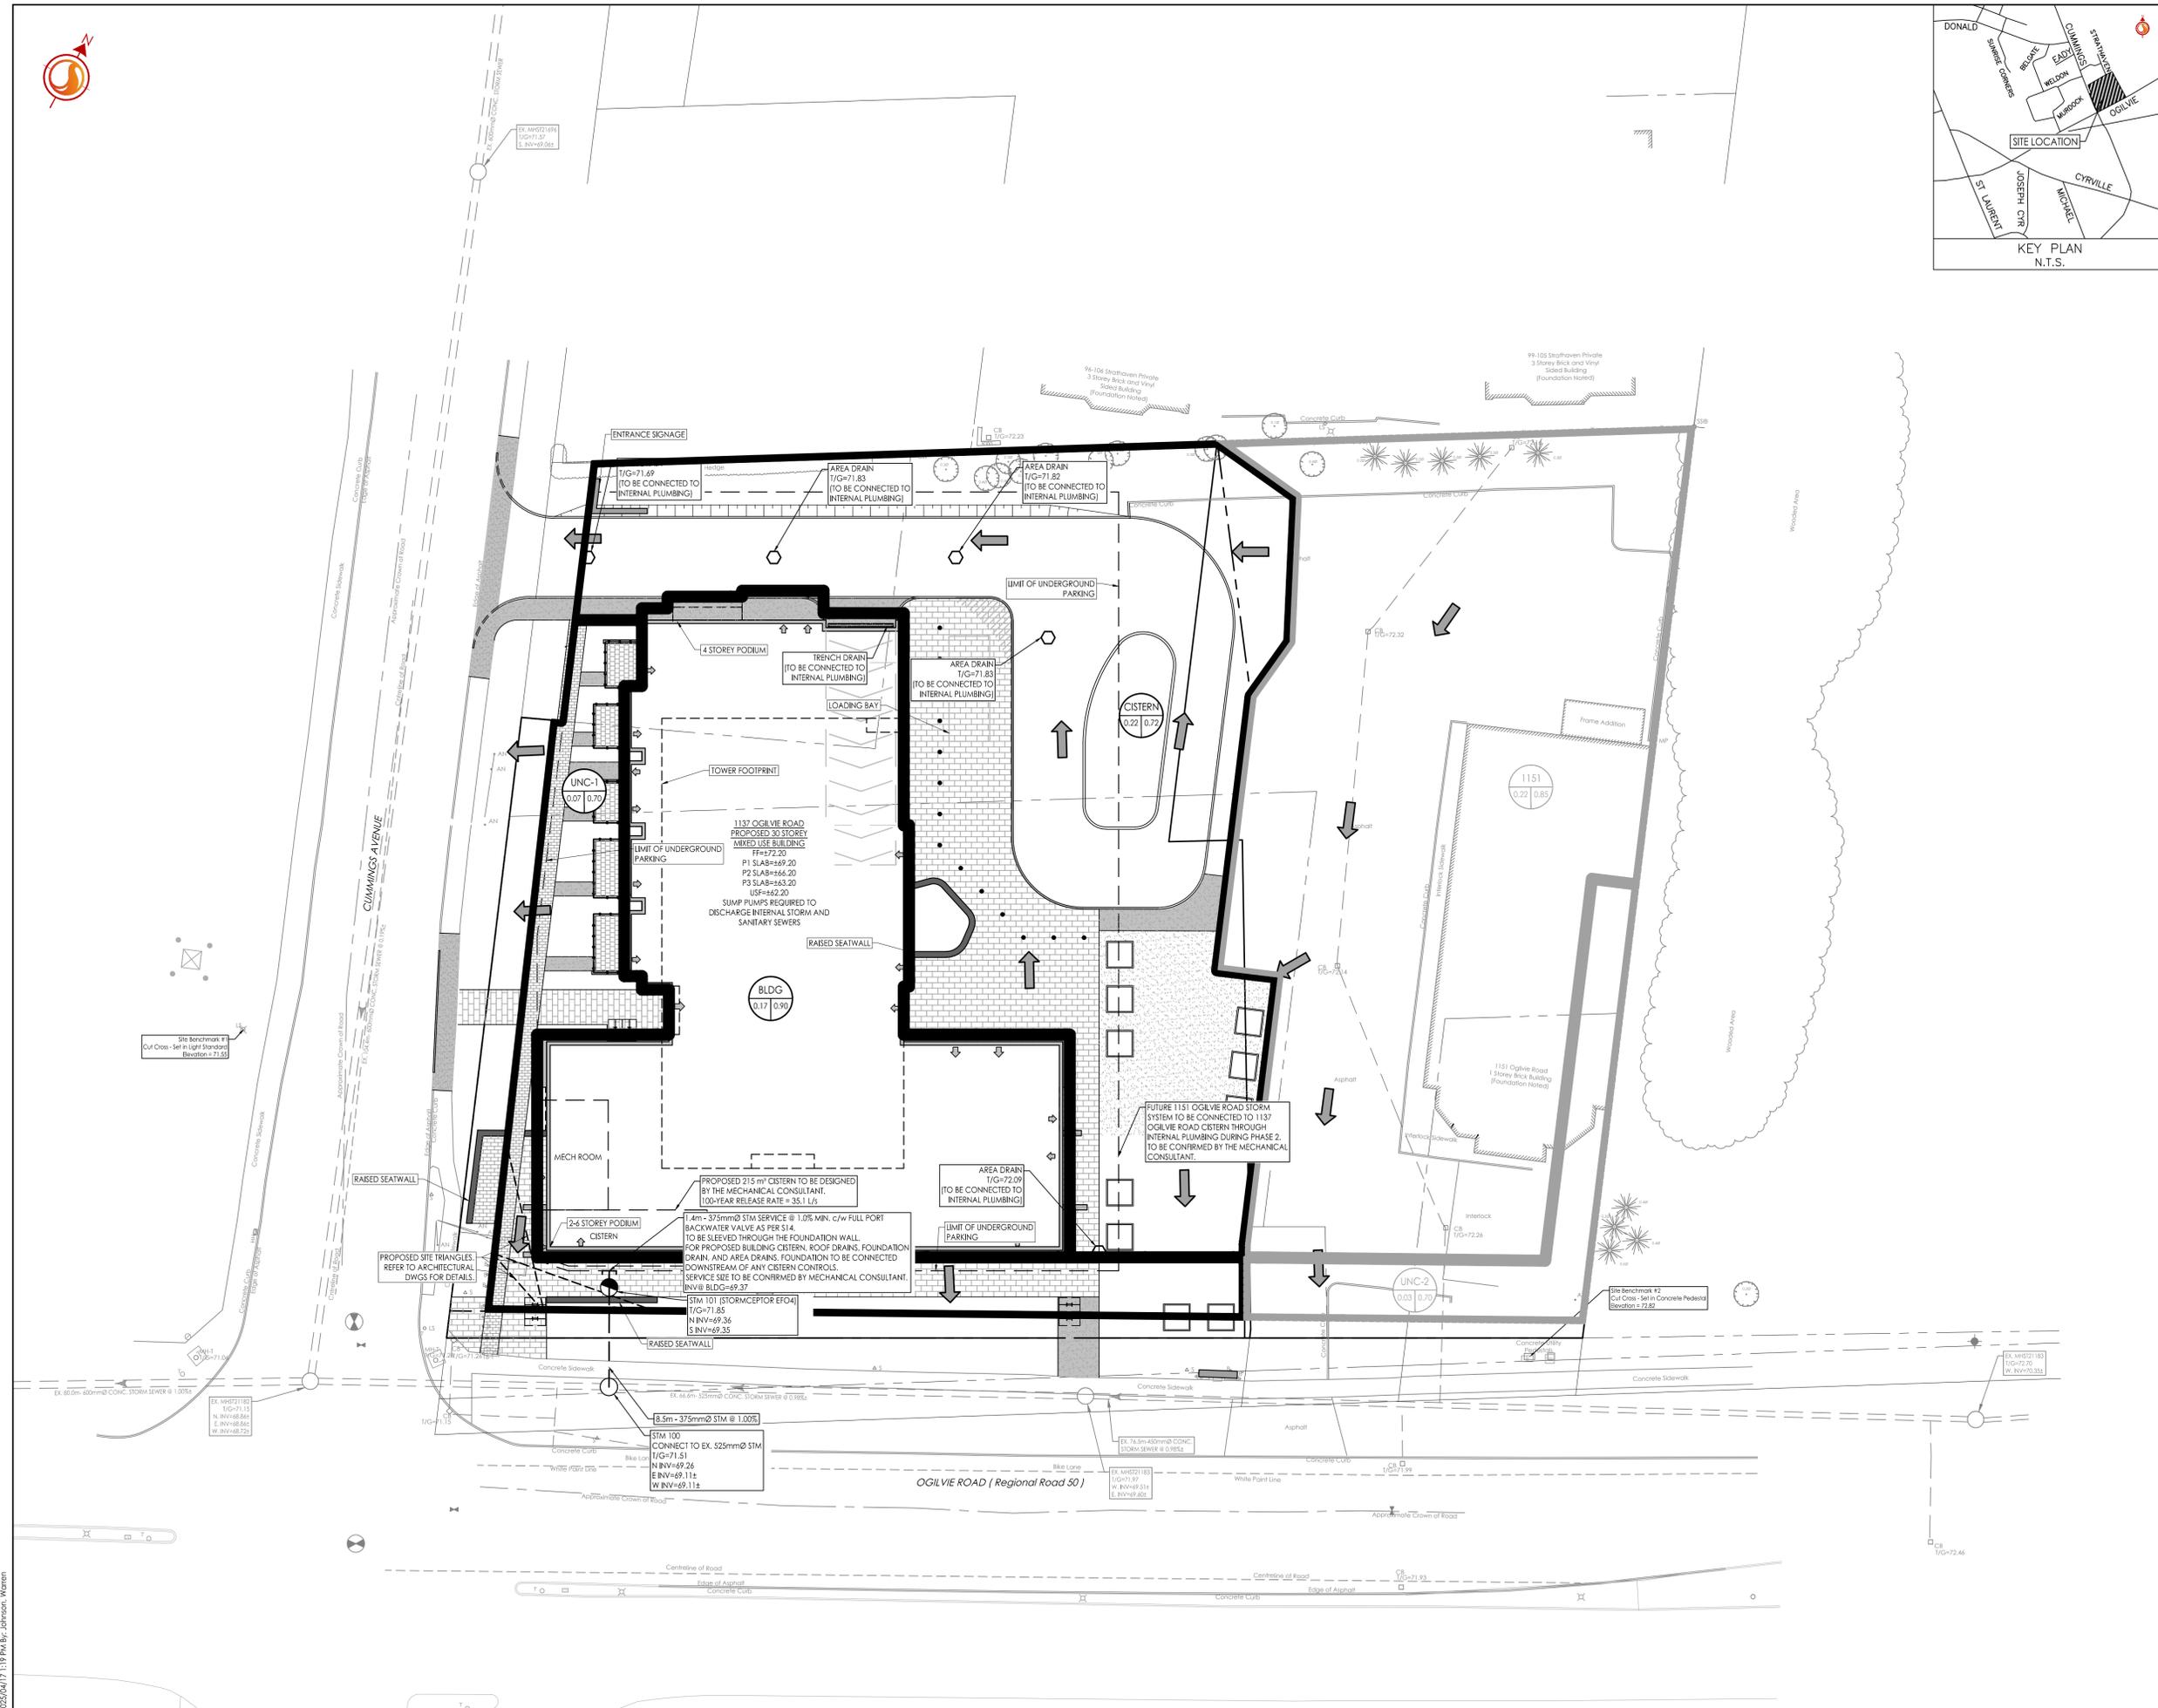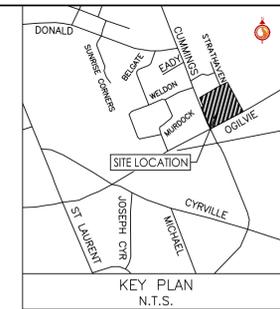

W:\Projects\160402095_Design\Drawings\160402095-D8-1137 Oglvie.dwg
 2025/04/17 10:19:46 AM - P:\STANTEC\160402095