



1. INTERIOR FINISHES (INCLUDING FLOORS AND BASEBOARDS): REFER TO FINISH PLANS FOR DETAILS OF

2. PROVIDE NAILERS ON ALL WALLS TO RECEIVE BUILT-IN FURNITURE, SHELVING, SCREENS, ETC.

3. UNLESS NOTED OTHERWISE, ALL DIMENSIONS ARE TAKEN FROM FACE OF STUDS AND CENTER OF DOORS AND WINDOWS. REQUIRED CLEARANCES WILL BE DIMENSIONED AND SHOWN TO FACE OF WALL OR DOOR OPENING

4. SEE A800 FOR DOOR SCHEDULE

5. UNLESS OTHERWISE INDICATED, ALL EQUIPMENT IS PROVIDED AND INSTALLED BY THE CONTRACTOR. THE CONTRACTOR MUST COORDINATE AND PROVIDE THE SERVICES REQUIRED TO POWER THE EQUIPMENT.

6. FILL ALL GAPS AND JOINTS WITH ACOUSTIC INSULATION AND SEAL WITH ACOUSTIC CAULKING WHEN ACOUSTIC PERFORMANCE IS REQUIRED.

7. COORDINATE WALL OPENINGS WITH MECHANICAL (SEE MECHANICAL DRAWINGS).

8. PLYWOOD PANELS USED AS NAILERS IN THE ELECTRICAL ROOMS MUST BE FIRE-TREATED.

9. PROVIDE ROD AND SHELF TYP. FOR ALL CLOSETS AS SHOWN.

10. ALL WINDOW AND DOOR DIMENSIONS ARE TO ROUGH STUD OPENING.

11. ALL OUTSIDE DIMENSIONS ARE TO OUTSIDE FACE OF STUD SHEATHING.

12. REFER TO STRUCTURAL DRAWINGS FOR BEAMS, LINTELS, POSTS, FLOOR, AND ROOF FRAMING.

13. ALL ELECTRICAL AND MECHANICAL ITEMS SHOWN ON DRAWINGS ARE FOR LOCATION PROPOSED ONLY. COORDINATE WITH M&E DRAWINGS.

14. CAULK AND SEAL AT ALL MECHANICAL AND ELECTRICAL PENETRATIONS.

15. PROVIDE FIRE STOPPING FOR MECHANICAL AND ELECTRICAL PENETRATONS THROUGH FIRE-RATED ASSEMBLIES. INFILL ANY UNUSED PENETRATIONS WITH FIRE-STOPPING TO SUIT ASSEMBLY.

16. REFER TO RCP PLANS FOR BULKHEAD LOCATIONS AND

17. FURNITURE SHOWN FOR REFERENCE PURPOSE ONLY.

18. ALL ELECTRICAL CONTROL HEIGHTS WITHIN BARRIER-FREE UNITS AND PATHS OF TRAVEL THROUGHOUT THE BUILDING TO COMPLY WITH CSA B-651

19. PROVIDE SOUNDPROOF FIBERGLASS BATT IN ALL PARTITIONS WITH SUPPLY PIPES, SANITARY DRAIN OR RAINWATER LEADERS. COORDINATE WITH MECH.

20. UNIT NAME: "XBD-B/F" INDICATES BARRIER-FREE REQUIREMENTS AS PER CAN/CSA, NATIONAL STANDARD OF CANADA, AND ACTION OTTAWA'S ACCESSBLE UNIT REQUIREMENTS.

GENERAL NOTES - PARTITIONS

1. UNLESS INDICATED OTHERWISE, ALL NEW GYPSUM PARTITIONS ARE WOOD-FRAMED. REFER TO WALL TAGS FOR DETAILS OF COMPOSITION.

2. PARTITIONS CONTINUING TO THE SLAB MUST BLEND PERFECTLY WITH ITS GEOMETRY TO ENSURE THAT THE FULL PERIMETER IS CAULKED TO MEET THE REQUIRED ULC FIRE RESISTANCE AND/OR TO ENSURE THE REQUIRED ACOUSTIC PERFORMANCE.

3. UNLESS NOTED OTHERWISE, DOOR FRAMES ARE INSTALLED 4" FROM THE ADJACENT WALL.

4. WATER-REPELLENT GYPSUM PANELS ARE REQUIRED IN ROOMS WITH WATER OR MOISTURE EXPOSURE (BATHROOMS, JANITOR'S LODGE, KITCHENS WALL ABOVE MILLWORK, ETC.).

5. CONTRACTION JOINTS ON GYPSUM PANELS TO BE USED AT MAXIMUM 9,100mm (30'-0").

6. WALLS TO RECIEVE TILE FINISH MUST BE PROVIDED WITH FIBERBOARD BACKING WITHOUT COMPROMISING THE FIRE RESISTANCE RATING WHERE REQUIRED.

No. Date Issued for 1 04/04/2025 SITE PLAN CONTROL 2 11/06/2025 SPC RESPONSE 1

Architecte Paysagiste/ Landscape Architect





Ingénieur / Engineer (Mécanique & Électricité / Mechanical & Electrical)



Ingénieur / Engineer (Structure / Structure)



Urban Planner / Urbaniste

420 O'Connor St., Suite 200, Ottawa, ON, K2P 1W4





Architecte / Architect 3550, Saint-Antoine O.

Montréal QC H4C 1A9 T. 514 861-5122 190 Somerset St W #206

Ottawa ON K2P 0J4 T. 613 695-6122 Oroit d'auteur / Copyright

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l'architecte de toutes erreurs

Projet / Project

Titre / Title

Échelle / Scale As indicated

6 STOREY APARTMENT BUILDING

240 PRESLAND ROAD

BASEMENT

Dessiné par / Drawn by No. projet / Project number 2424 Vérifié par / Verified by No. dessin / Drawing number

Date de création du dessin / Drawing creation date 04/04/25

LEGEND - CONSTRUCTION PLAN

NEW WALL WALL TYPE

1.23 - NUMBER OF WALL TYPE 1h X 0.75h REAL FIRE RATING

0h = FIRE SEPARATION WITHOUT RATING 45 min. = FIRE RESISTANCE RATING OF 45 MIN. 1h = FIRE RESISTANCE RATING OF 1h



NUMBER AND CEILING HEIGHT



NUMBER AND ROOM NAME




WINDOW NUMBER

REVISION NUMBER



CENTRE LINE

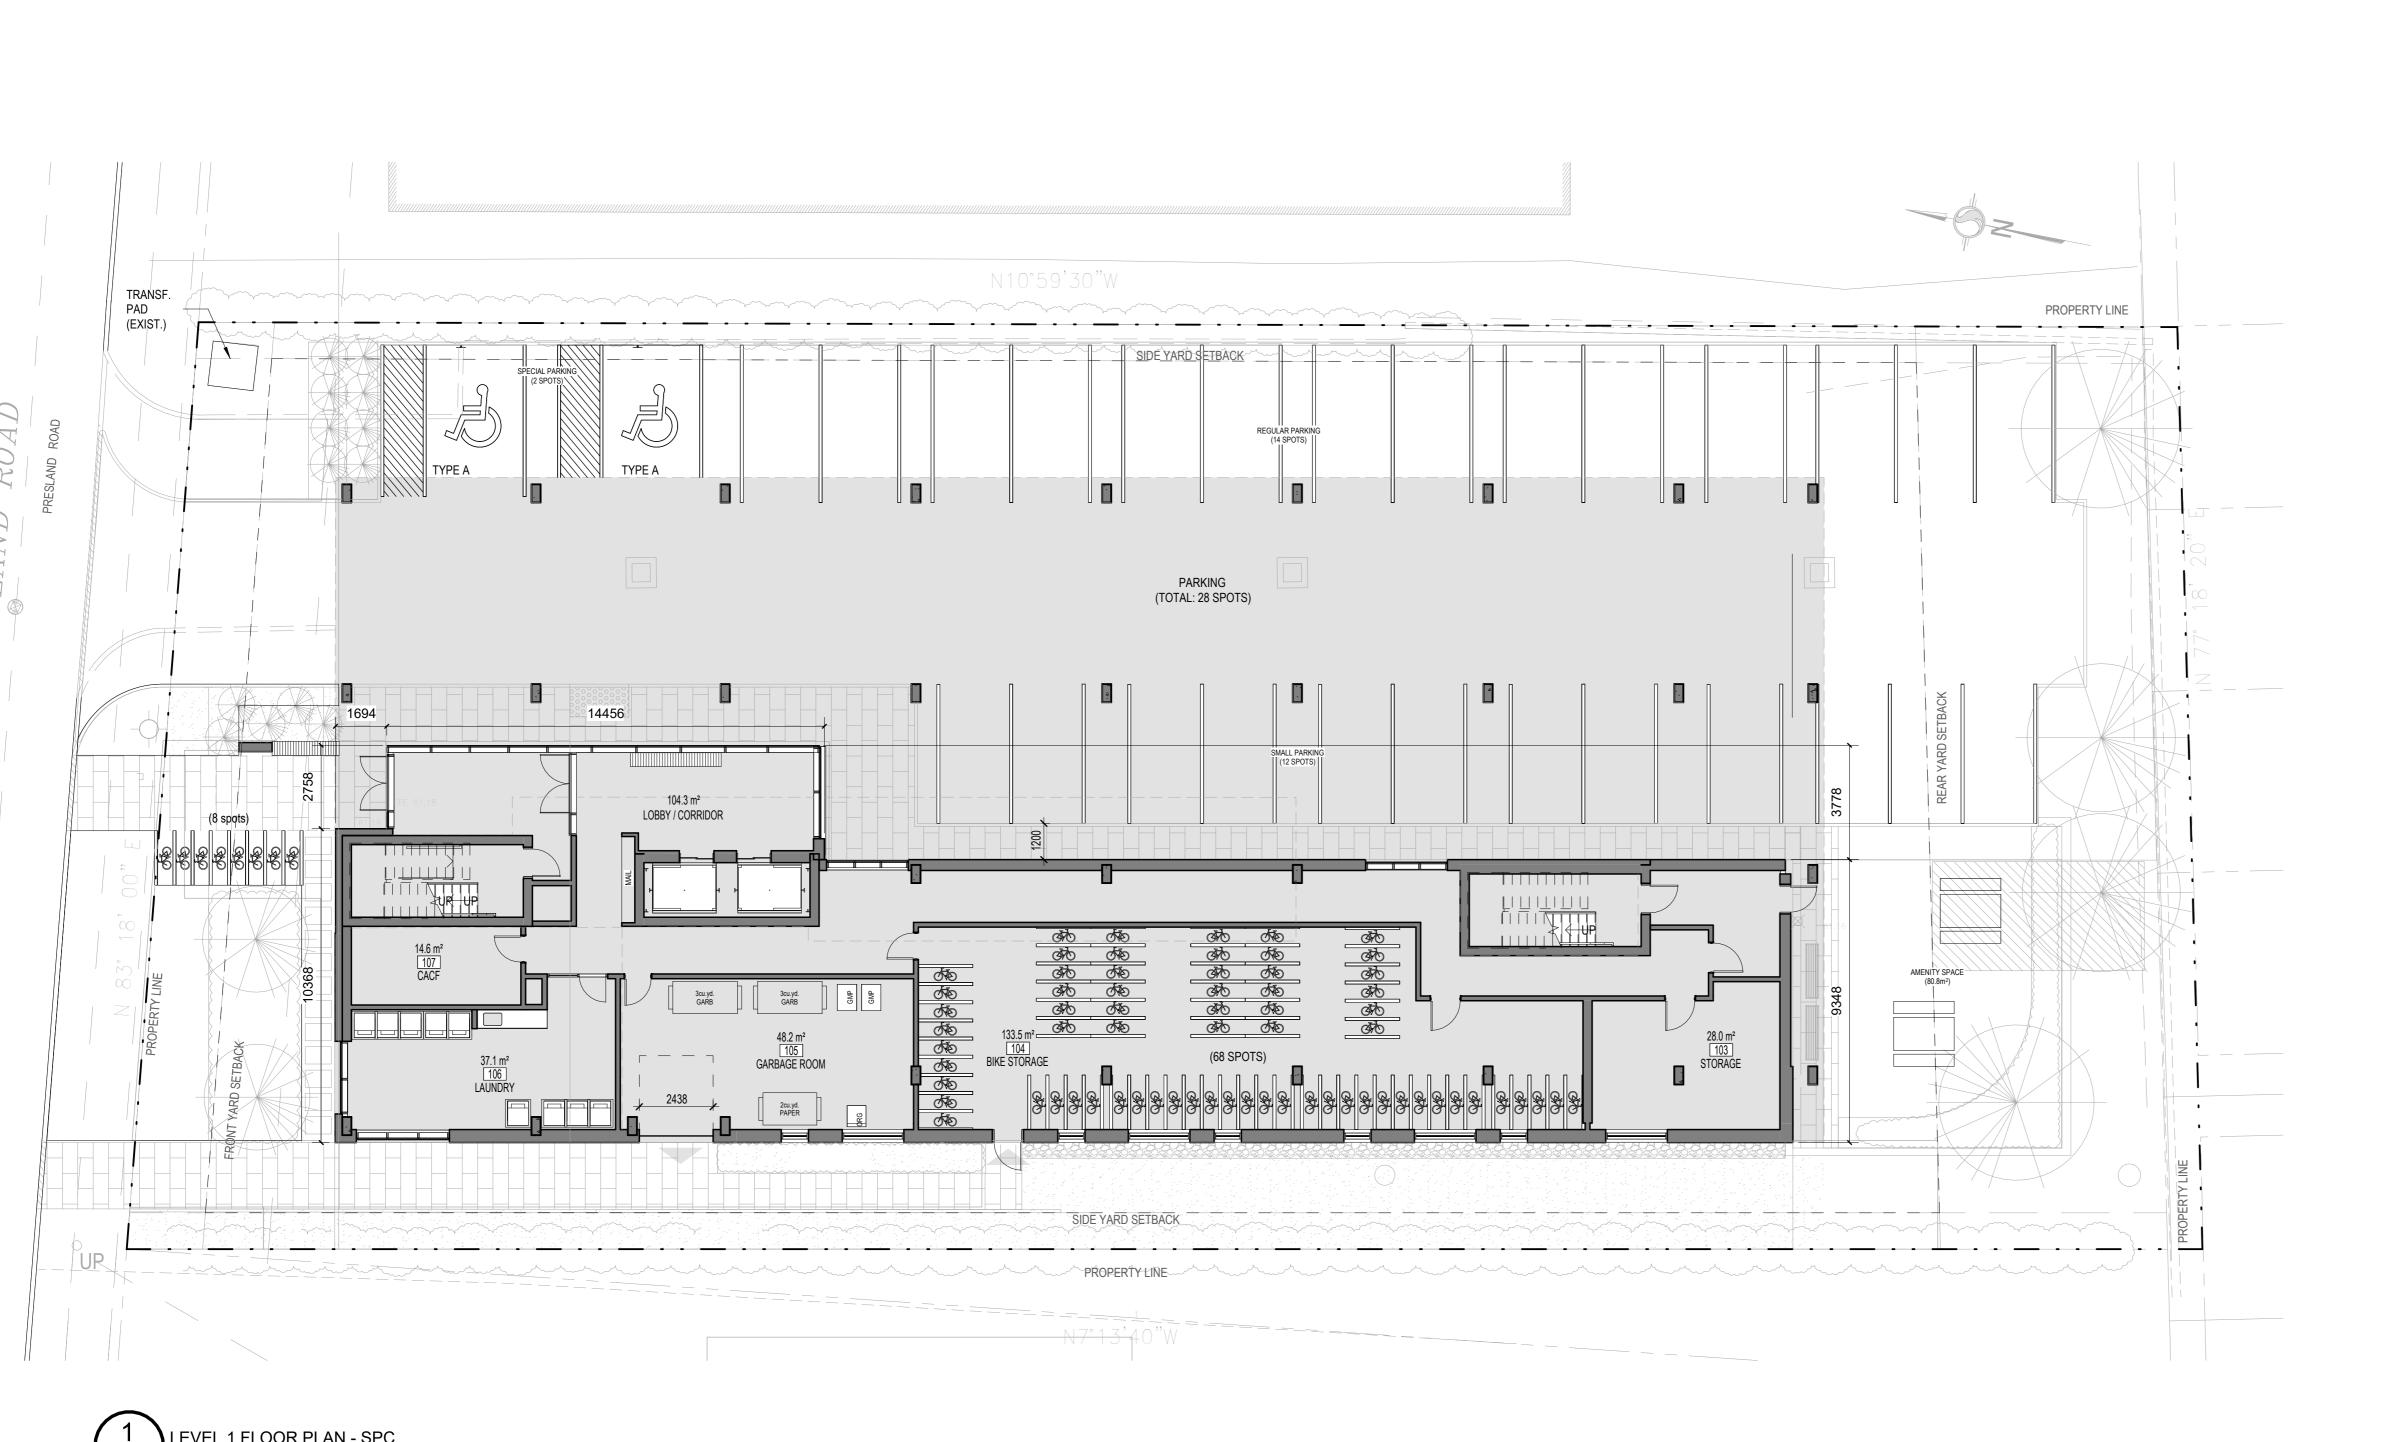

GENERAL NOTES - CONSTRUCTION PLAN

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11. ALL OUTSIDE DIMENSIONS ARE TO OUTSIDE FACE OF STUD SHEATHING.

POSTS, FLOOR, AND ROOF FRAMING.

DRAWINGS ARE FOR LOCATION PROPOSED ONLY. COORDINATE WITH M&E DRAWINGS.

PENETRATIONS.

17. FURNITURE SHOWN FOR REFERENCE PURPOSE ONLY.

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LEGEND - CONSTRUCTION PLAN

NEW WALL

— FIRE RATING

TYPE\
9'

(WXXXX)

—— NUMBER OF WALL TYPE

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NUMBER AND CEILING HEIGHT

NUMBER AND ROOM NAME

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CENTRE LINE

1 04/04/2025 SITE PLAN CONTROL 2 11/06/2025 SPC RESPONSE 1

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REQUIREMENTS.

DETAILS OF COMPOSITION.

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MAXIMUM 9,100mm (30'-0").

Architecte Paysagiste/ Landscape Architect design strategies



Ingénieur / Engineer (Mécanique & Électricité / Mechanical & Electrical)



Ingénieur / Engineer (Structure / Structure)



Urban Planner / Urbaniste





Architecte / Architect 3550, Saint-Antoine O. Montréal QC H4C 1A9 T. 514 861-5122

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Projet / Project

Titre / Title

04/04/25

6 STOREY APARTMENT BUILDING


240 PRESLAND ROAD

LEVEL 1

Dessiné par / Drawn by No. projet / Project number 2424 Vérifié par / Verified by No. dessin / Drawing number


Échelle / Scale As indicated Date de création du dessin / Drawing creation date



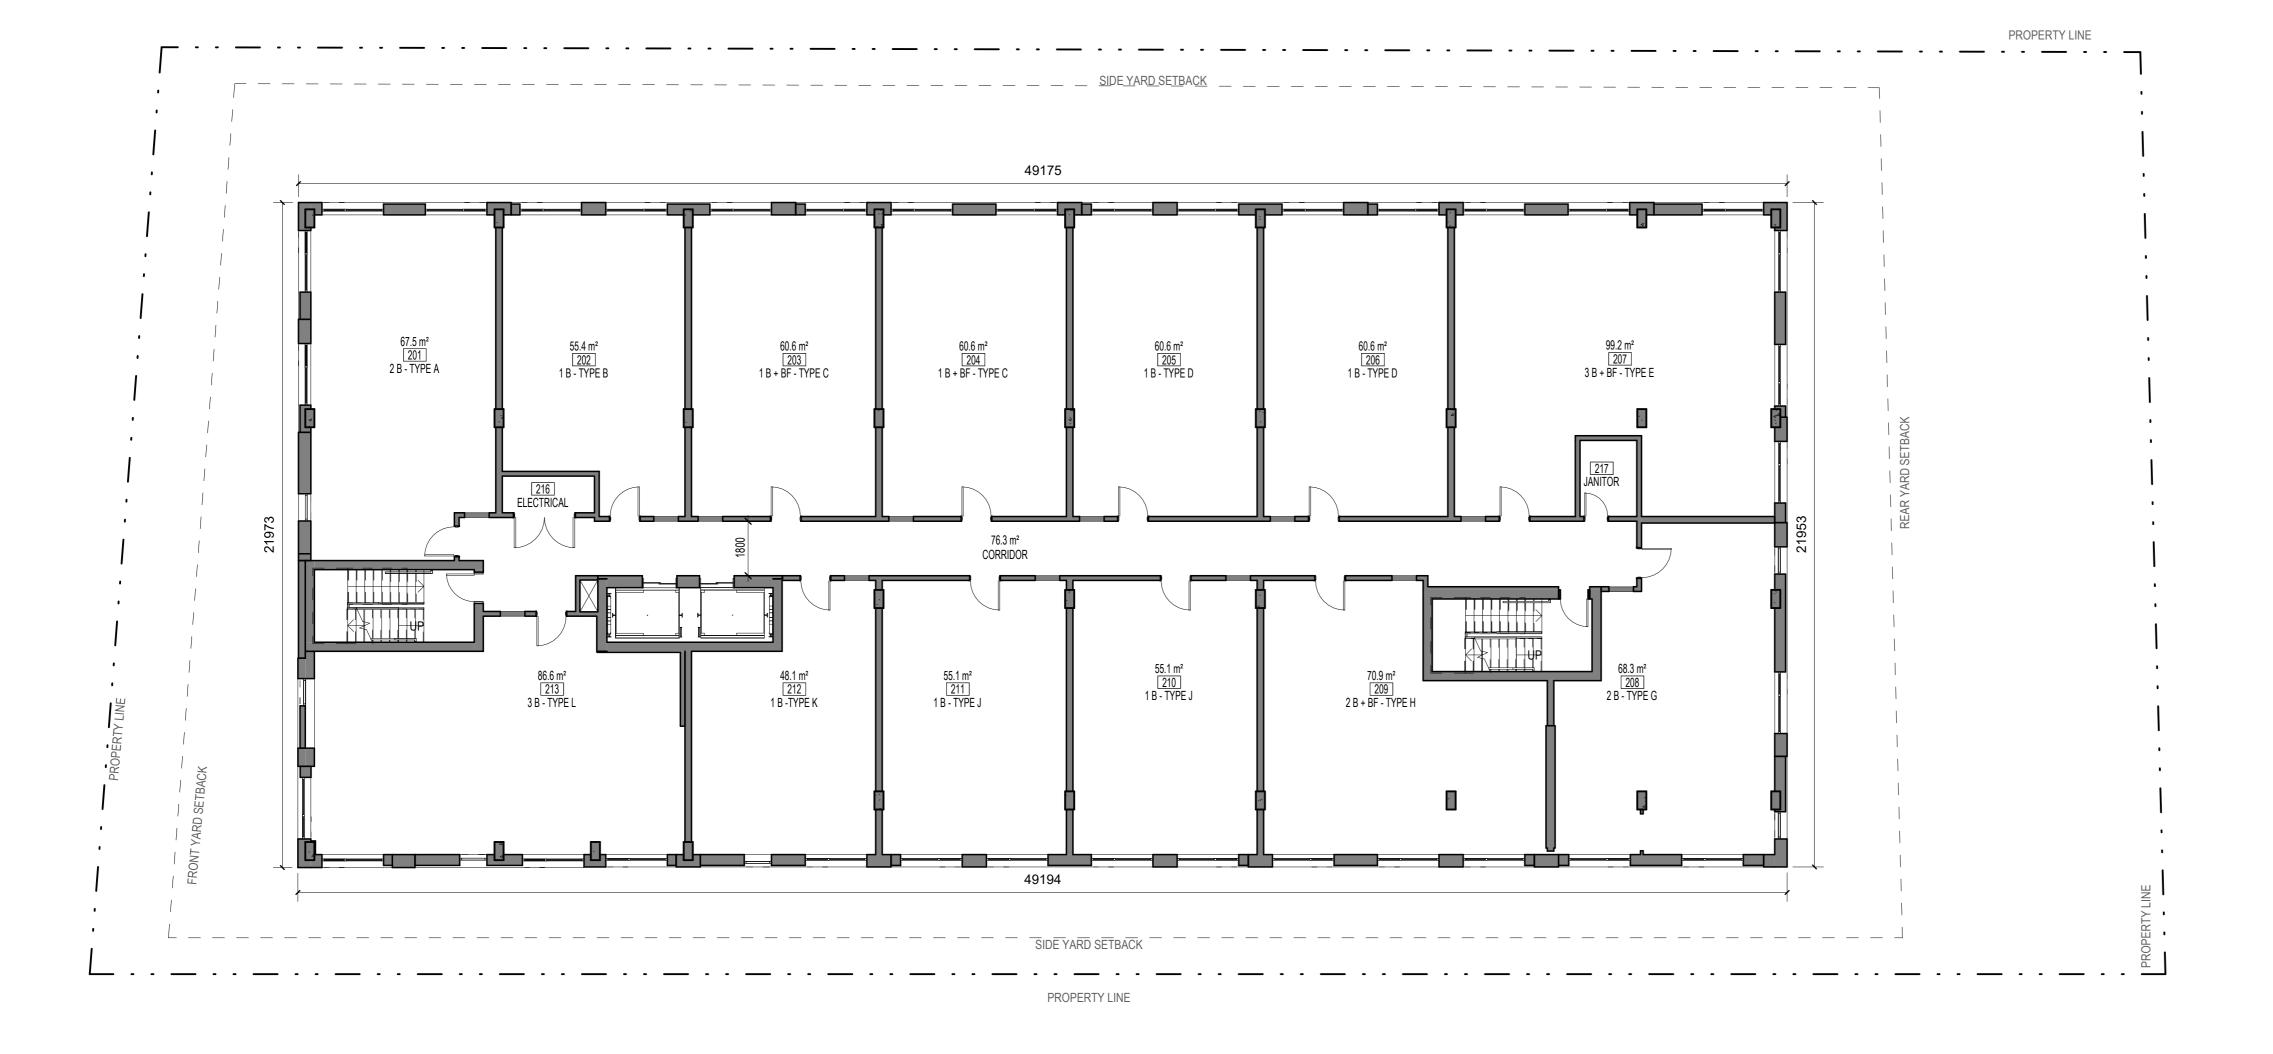





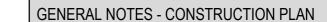

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RAINWATER LEADERS. COORDINATE WITH MECH.

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No. Date Issued for 1 04/04/2025 SITE PLAN CONTROL 2 11/06/2025 SPC RESPONSE 1

Architecte Paysagiste/ Landscape Architect





Ingénieur / Engineer (Mécanique & Électricité / Mechanical & Electrical)



Ingénieur / Engineer (Structure / Structure)



Urban Planner / Urbaniste





3550, Saint-Antoine O.

190 Somerset St W #206 Ottawa ON K2P 0J4 T. 613 695-6122

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aviser immédiatement l'architecte de toutes erreurs Contractor shall verify all information and dimensions on site and immediately report any errors or

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omissions to the architect.

Projet / Project

Titre / Title

04/04/25

6 STOREY APARTMENT BUILDING

240 PRESLAND ROAD

LEVEL 2 & 3 (TYP.)

Dessiné par / Drawn by No. projet / Project number 2424 Vérifié par / Verified by No. dessin / Drawing number Échelle / Scale

As indicated Date de création du dessin / A.122 Drawing creation date

1.23 - NUMBER OF WALL TYPE 1h X 0.75h REAL FIRE RATING

NEW WALL

WALL TYPE

LEGEND - CONSTRUCTION PLAN

0h = FIRE SEPARATION WITHOUT RATING 45 min. = FIRE RESISTANCE RATING OF 45 MIN. 1h = FIRE RESISTANCE RATING OF 1h

NUMBER AND CEILING HEIGHT






WINDOW NUMBER


NUMBER AND ROOM NAME



CENTRE LINE

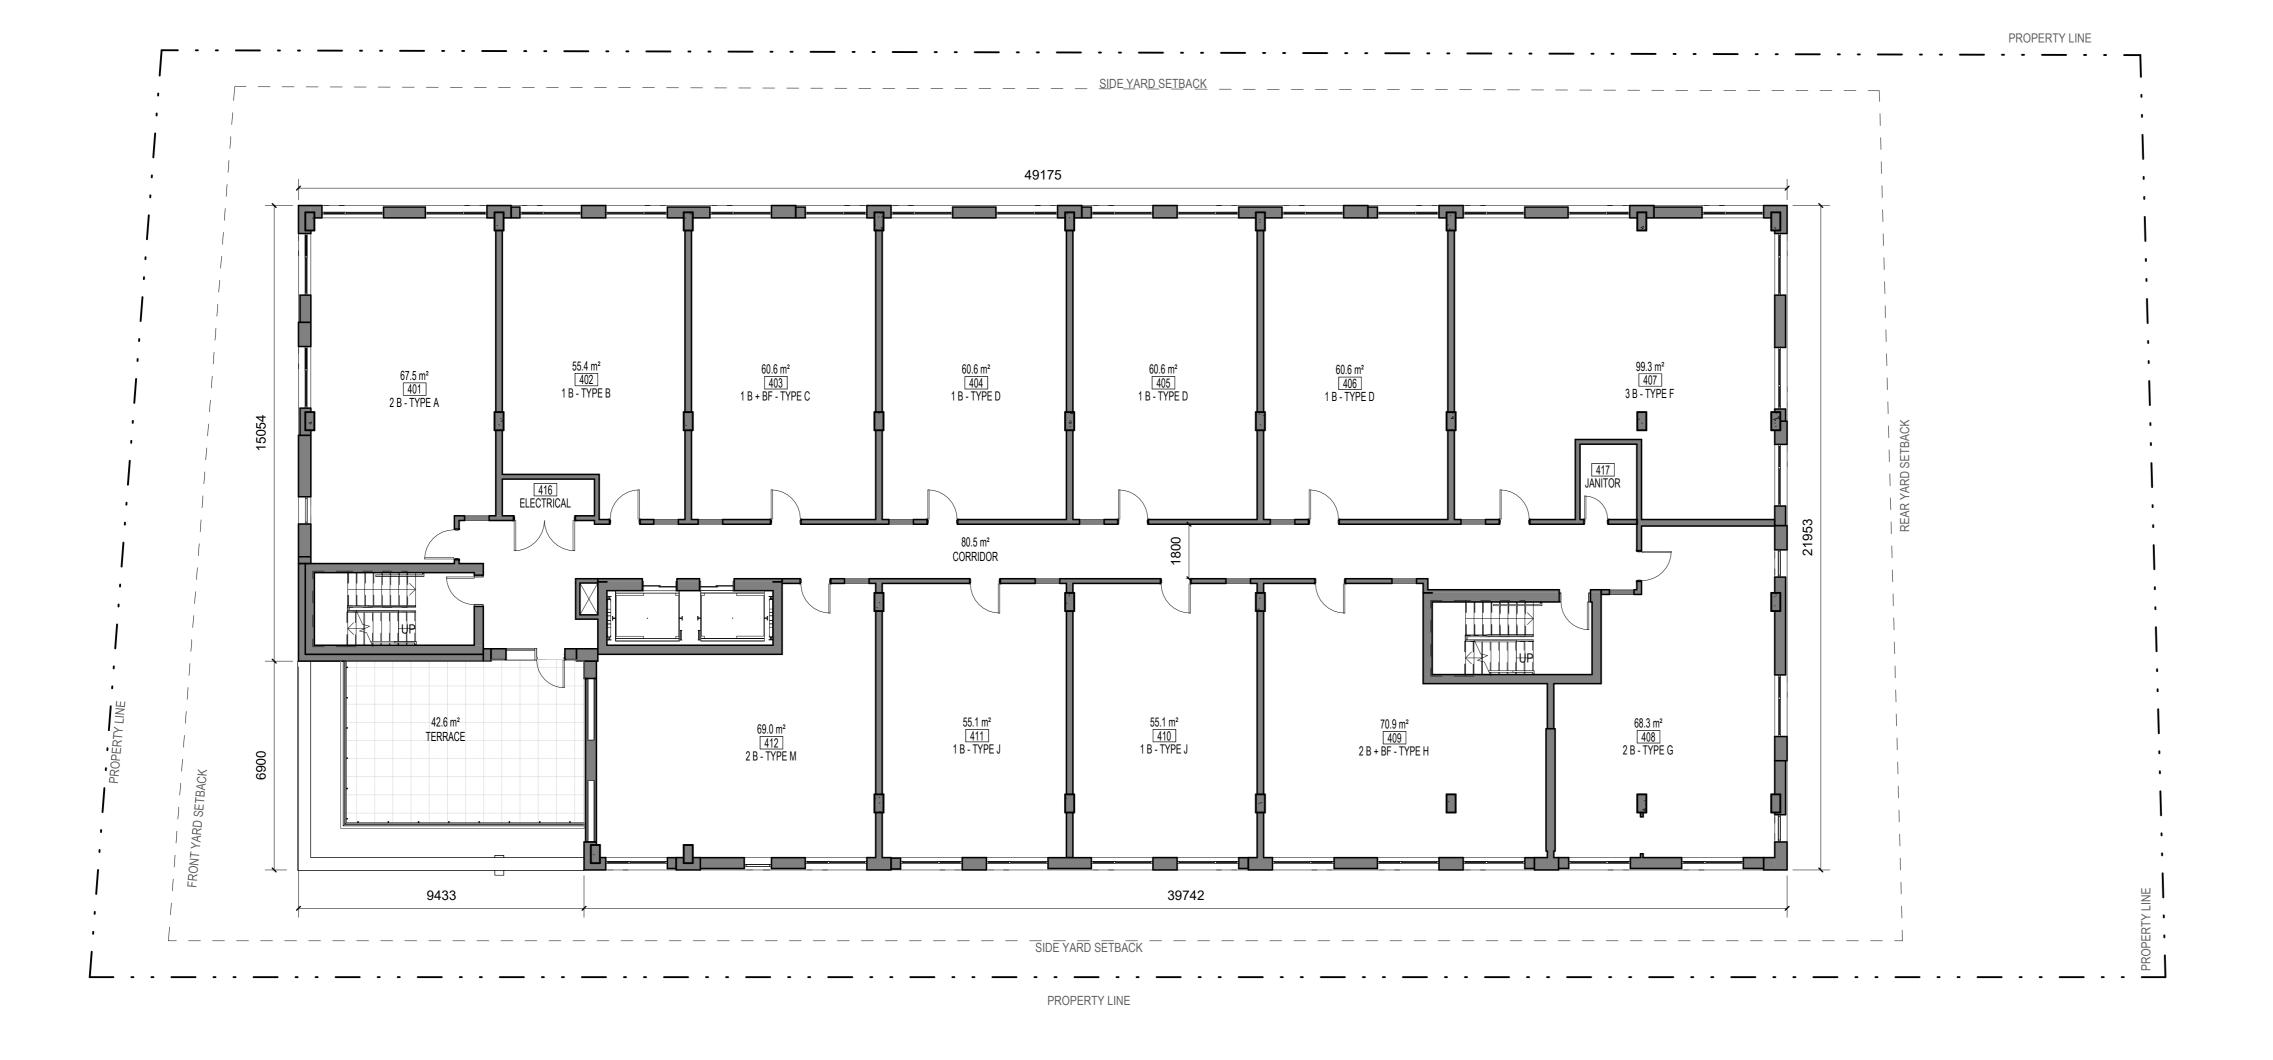



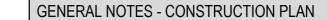

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- POSTS, FLOOR, AND ROOF FRAMING.
- DRAWINGS ARE FOR LOCATION PROPOSED ONLY. COORDINATE WITH M&E DRAWINGS.
- PENETRATIONS.
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LEGEND - CONSTRUCTION PLAN

NEW WALL

WALL TYPE

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NUMBER AND CEILING HEIGHT

NUMBER AND ROOM NAME

WINDOW NUMBER

REVISION NUMBER

CENTRE LINE

1h X 0.75h REAL FIRE RATING

(WXXXX)

1 04/04/2025 SITE PLAN CONTROL 2 11/06/2025 SPC RESPONSE 1

No. Date Issued for

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design strategies

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190 Somerset St W #206



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6 STOREY APARTMENT BUILDING


240 PRESLAND ROAD


LEVEL 4


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- 2. PARTITIONS CONTINUING TO THE SLAB MUST BLEND PERFECTLY WITH ITS GEOMETRY TO ENSURE THAT THE FULL PERIMETER IS CAULKED TO MEET THE REQUIRED ULC FIRE RESISTANCE AND/OR TO ENSURE THE REQUIRED ACOUSTIC PERFORMANCE.
- 3. UNLESS NOTED OTHERWISE, DOOR FRAMES ARE INSTALLED 4" FROM THE ADJACENT WALL.
- 4. WATER-REPELLENT GYPSUM PANELS ARE REQUIRED IN ROOMS WITH WATER OR MOISTURE EXPOSURE (BATHROOMS, JANITOR'S LODGE, KITCHENS WALL ABOVE MILLWORK, ETC.).
- 5. CONTRACTION JOINTS ON GYPSUM PANELS TO BE USED AT MAXIMUM 9,100mm (30'-0").
- 6. WALLS TO RECIEVE TILE FINISH MUST BE PROVIDED WITH FIBERBOARD BACKING WITHOUT COMPROMISING THE FIRE RESISTANCE RATING WHERE REQUIRED.

LEGEND - CONSTRUCTION PLAN

NEW WALL

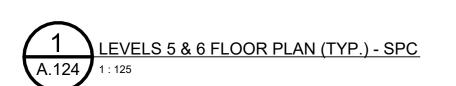1.23 - NUMBER OF WALL TYPE

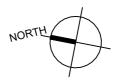1h X 0.75h REAL FIRE RATING

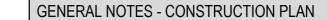(WXXXX)

1 04/04/2025 SITE PLAN CONTROL 2 11/06/2025 SPC RESPONSE 1

No. Date Issued for

Architecte Paysagiste/ Landscape Architect





Ingénieur / Engineer (Mécanique & Électricité / Mechanical & Electrical)



Ingénieur / Engineer (Structure / Structure)



Urban Planner / Urbaniste



420 O'Connor St., Suite 200, Ottawa, ON, K2P 1W4



3550, Saint-Antoine O.

190 Somerset St W #206 Ottawa ON K2P 0J4

T. 613 695-6122

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toutes les dimensions et informations sur le site et aviser immédiatement l'architecte de toutes erreurs ou omissions. Contractor shall verify all information and dimensions on site and immediately

L'entrepreneur doit vérifier

report any errors or omissions to the architect.

Projet / Project

Titre / Title

04/04/25

6 STOREY APARTMENT BUILDING

240 PRESLAND ROAD

LEVEL 5 & 6 (TYP.)

Dessiné par / Drawn by No. projet / Project number 2424 Vérifié par / Verified by No. dessin / Drawing number Échelle / Scale

As indicated Date de création du dessin / Drawing creation date

CENTRE LINE


0h = FIRE SEPARATION WITHOUT RATING 45 min. = FIRE RESISTANCE RATING OF 45 MIN. 1h = FIRE RESISTANCE RATING OF 1h


NUMBER AND CEILING HEIGHT

NUMBER AND ROOM NAME


WINDOW NUMBER

REVISION NUMBER

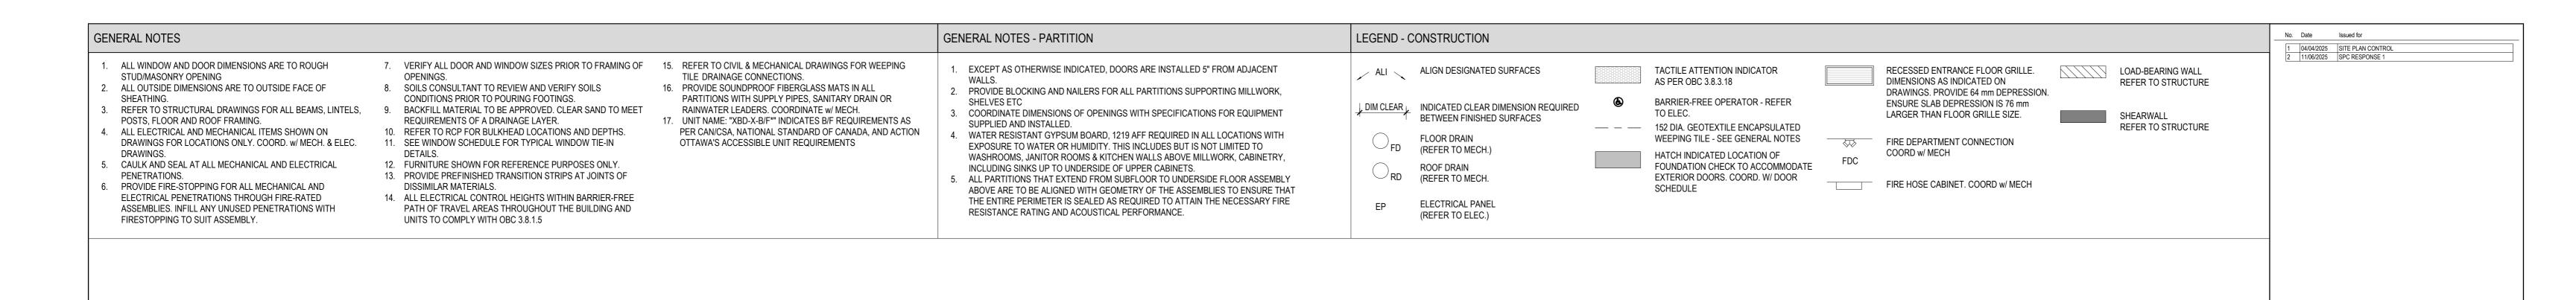

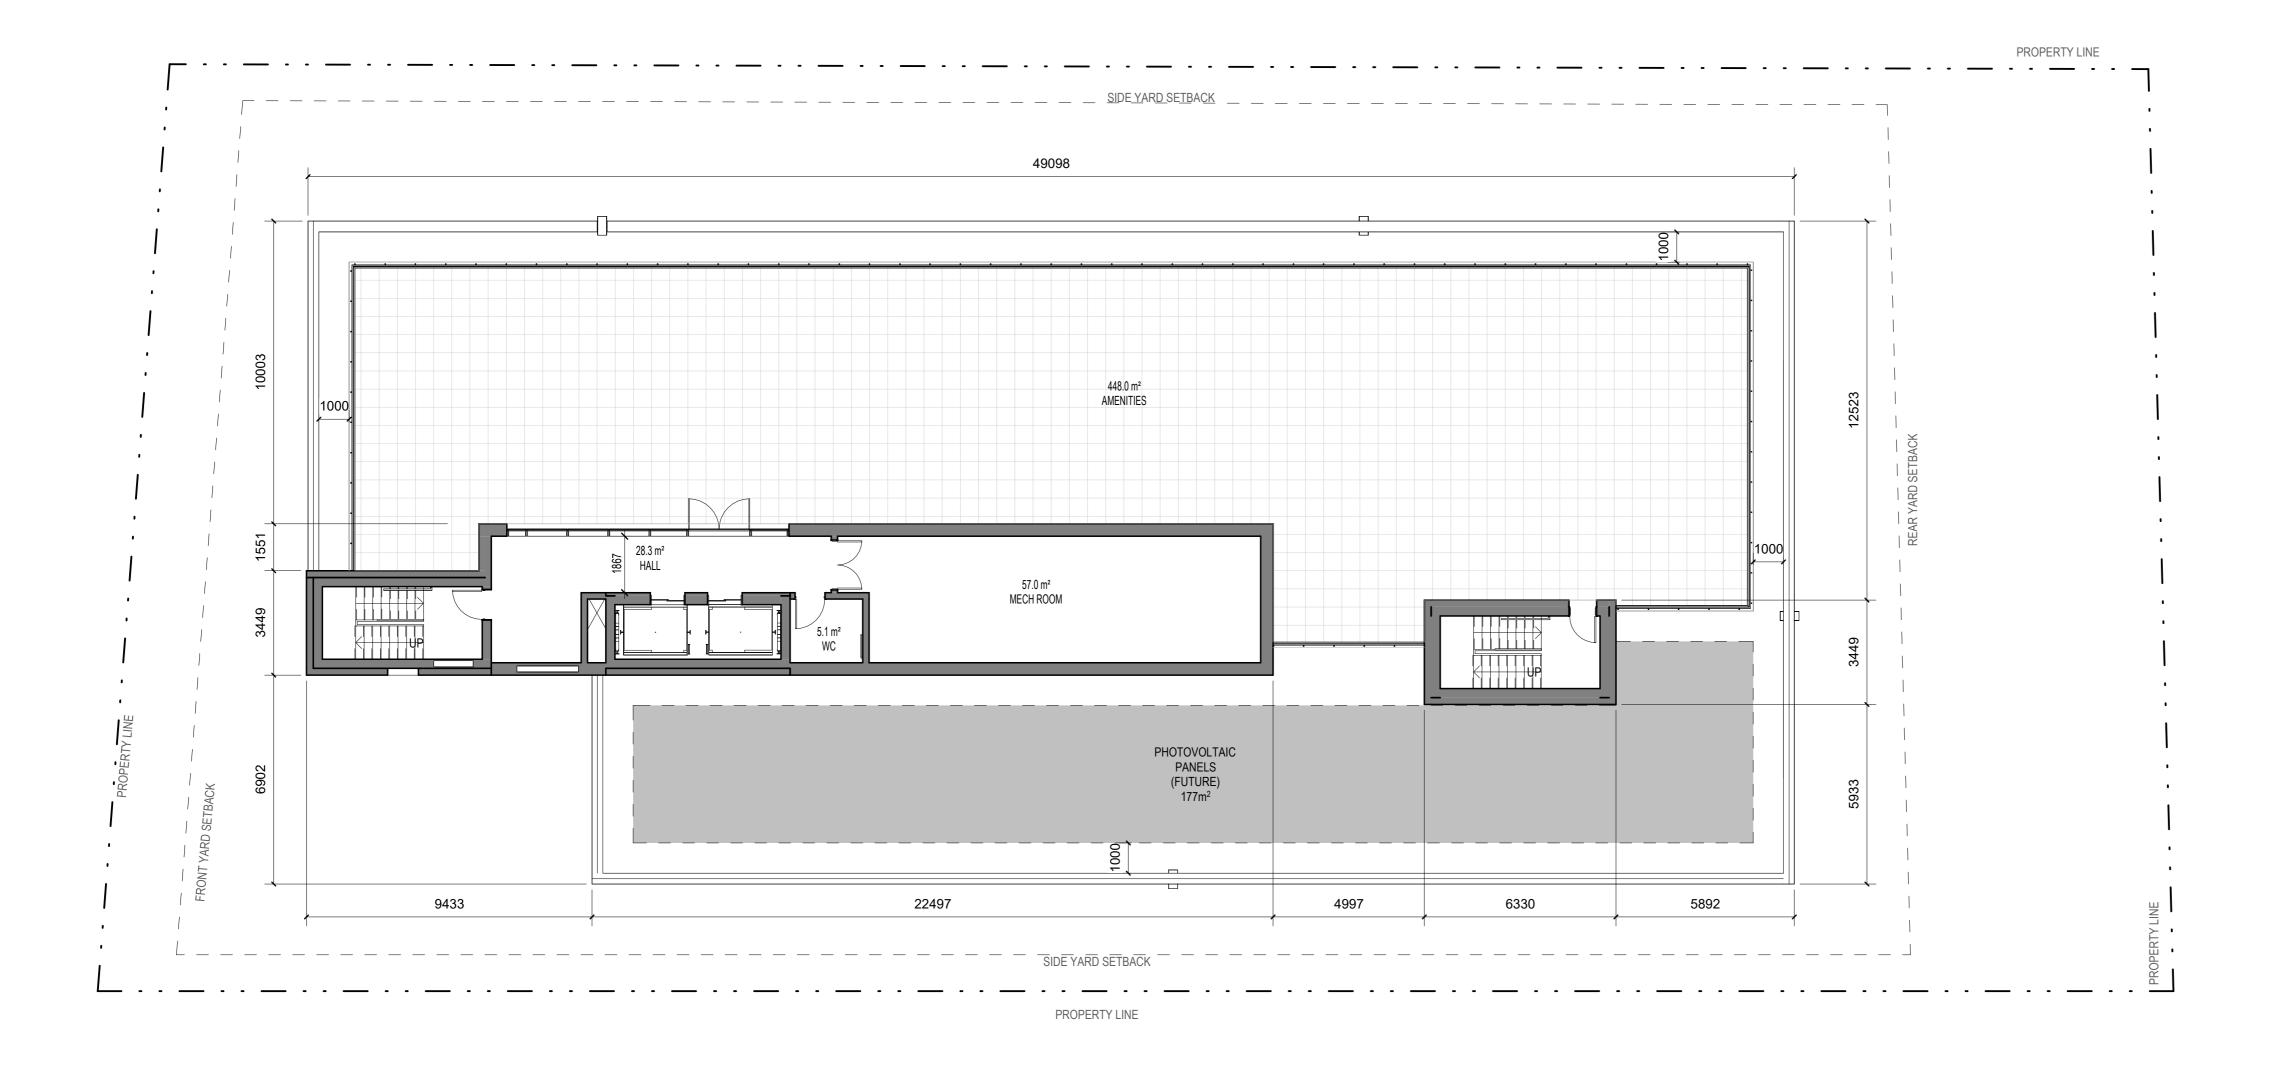



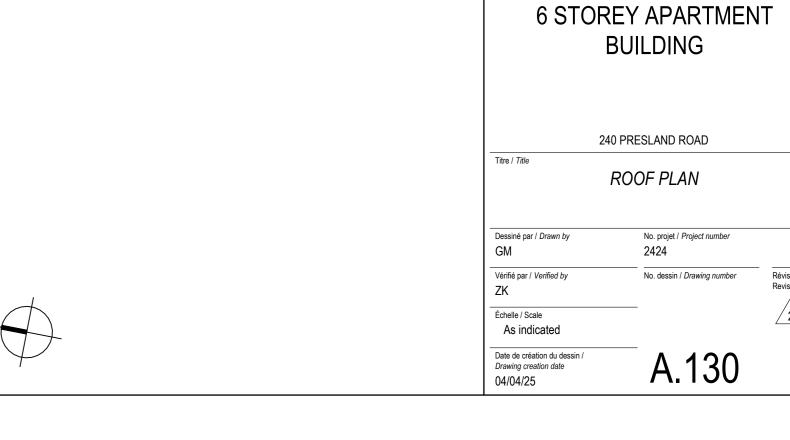

Architecte Paysagiste/ Landscape Architect

Ingénieur / Engineer (Mécanique & Électricité / Mechanical & Electrical)

Ingénieur / Engineer (Civil / Civil)

Ingénieur / Engineer (Structure / Structure)

Urban Planner / Urbaniste

Client / Client

Architecte / Architect

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design strategies

STRUCTURAL

Centretown Citizens

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L'entrepreneur doit vérifier toutes les dimensions et informations sur le site et aviser immédiatement l'architecte de toutes erreurs

Contractor shall verify all information and dimensions on site and immediately report any errors or omissions to the architect.

