

- 1. INTERIOR FINISHES (INCLUDING FLOORS AND BASEBOARDS): REFER TO FINISH PLANS FOR DETAILS OF
- 2. PROVIDE NAILERS ON ALL WALLS TO RECEIVE BUILT-IN FURNITURE, SHELVING, SCREENS, ETC.
- 3. UNLESS NOTED OTHERWISE, ALL DIMENSIONS ARE TAKEN FROM FACE OF STUDS AND CENTER OF DOORS AND WINDOWS. REQUIRED CLEARANCES WILL BE DIMENSIONED AND SHOWN TO FACE OF WALL OR DOOR OPENING
- 4. SEE A800 FOR DOOR SCHEDULE
- 5. UNLESS OTHERWISE INDICATED, ALL EQUIPMENT IS PROVIDED AND INSTALLED BY THE CONTRACTOR. THE CONTRACTOR MUST COORDINATE AND PROVIDE THE SERVICES REQUIRED TO POWER THE EQUIPMENT.
- 6. FILL ALL GAPS AND JOINTS WITH ACOUSTIC INSULATION AND SEAL WITH ACOUSTIC CAULKING WHEN ACOUSTIC PERFORMANCE IS REQUIRED.
- 7. COORDINATE WALL OPENINGS WITH MECHANICAL (SEE MECHANICAL DRAWINGS).
- 8. PLYWOOD PANELS USED AS NAILERS IN THE ELECTRICAL ROOMS MUST BE FIRE-TREATED.
- 9. PROVIDE ROD AND SHELF TYP. FOR ALL CLOSETS AS SHOWN.
- 10. ALL WINDOW AND DOOR DIMENSIONS ARE TO ROUGH STUD OPENING.
- 11. ALL OUTSIDE DIMENSIONS ARE TO OUTSIDE FACE OF STUD SHEATHING.
- 12. REFER TO STRUCTURAL DRAWINGS FOR BEAMS, LINTELS, POSTS, FLOOR, AND ROOF FRAMING.
- 13. ALL ELECTRICAL AND MECHANICAL ITEMS SHOWN ON DRAWINGS ARE FOR LOCATION PROPOSED ONLY. COORDINATE WITH M&E DRAWINGS.
- 14. CAULK AND SEAL AT ALL MECHANICAL AND ELECTRICAL PENETRATIONS.
- 15. PROVIDE FIRE STOPPING FOR MECHANICAL AND ELECTRICAL PENETRATONS THROUGH FIRE-RATED ASSEMBLIES. INFILL ANY UNUSED PENETRATIONS WITH FIRE-STOPPING TO SUIT ASSEMBLY.
- 16. REFER TO RCP PLANS FOR BULKHEAD LOCATIONS AND
- 17. FURNITURE SHOWN FOR REFERENCE PURPOSE ONLY.
- 18. ALL ELECTRICAL CONTROL HEIGHTS WITHIN BARRIER-FREE UNITS AND PATHS OF TRAVEL THROUGHOUT THE BUILDING TO COMPLY WITH CSA B-651
- 19. PROVIDE SOUNDPROOF FIBERGLASS BATT IN ALL PARTITIONS WITH SUPPLY PIPES, SANITARY DRAIN OR RAINWATER LEADERS. COORDINATE WITH MECH.
- 20. UNIT NAME: "XBD-B/F" INDICATES BARRIER-FREE REQUIREMENTS AS PER CAN/CSA, NATIONAL STANDARD OF CANADA, AND ACTION OTTAWA'S ACCESSBLE UNIT REQUIREMENTS.

## **GENERAL NOTES - PARTITIONS**

- 1. UNLESS INDICATED OTHERWISE, ALL NEW GYPSUM PARTITIONS ARE WOOD-FRAMED. REFER TO WALL TAGS FOR
- 2. PARTITIONS CONTINUING TO THE SLAB MUST BLEND PERFECTLY WITH ITS GEOMETRY TO ENSURE THAT THE FULL PERIMETER IS CAULKED TO MEET THE REQUIRED ULC FIRE RESISTANCE AND/OR TO ENSURE THE REQUIRED ACOUSTIC PERFORMANCE.
- INSTALLED 4" FROM THE ADJACENT WALL.
- 4. WATER-REPELLENT GYPSUM PANELS ARE REQUIRED IN ROOMS WITH WATER OR MOISTURE EXPOSURE (BATHROOMS, JANITOR'S LODGE, KITCHENS WALL ABOVE MILLWORK, ETC.).
- 5. CONTRACTION JOINTS ON GYPSUM PANELS TO BE USED AT MAXIMUM 9,100mm (30'-0").
- 6. WALLS TO RECIEVE TILE FINISH MUST BE PROVIDED WITH FIBERBOARD BACKING WITHOUT COMPROMISING THE FIRE RESISTANCE RATING WHERE REQUIRED.

# Architecte Paysagiste/ Landscape Architect

No. Date Issued for

1 04/04/2025 SITE PLAN CONTROL



Ingénieur / Engineer (Civil / Civil)



Ingénieur / Engineer (Mécanique & Électricité / Mechanical & Electrical)



Ingénieur / Engineer (Structure / Structure)



- DETAILS OF COMPOSITION.
- 3. UNLESS NOTED OTHERWISE, DOOR FRAMES ARE

LEGEND - CONSTRUCTION PLAN

**NEW WALL** 

WALL TYPE

1.23 - NUMBER OF WALL TYPE

0h = FIRE SEPARATION WITHOUT RATING 45 min. = FIRE RESISTANCE RATING OF 45 MIN. 1h = FIRE RESISTANCE RATING OF 1h

NUMBER AND CEILING HEIGHT

NUMBER AND ROOM NAME

1h X 0.75h REAL FIRE RATING

# Centretown Citizens Ottawa Corporation

3550, Saint-Antoine O.

Architecte / Architect

190 Somerset St W #206 Ottawa ON K2P 0J4

T. 613 695-6122 Oroit d'auteur / Copyright

Collectif d'architectes

Ce dessin est sujet au droit d'auteur. Il ne peut être reproduit pour quelques intentions ou usages que ce soit, il ne peut être utilisé uniquement avec l'apposition de la signature et de l'estampe originale. This drawing is subject to copyright. It is not to be reproduced for any purpose or by any means, and may only be used if it bears an original stamp and signature.



toutes les dimensions et informations sur le site et aviser immédiatement l'architecte de toutes erreurs Contractor shall verify all information and dimensions on site and immediately report any errors or

L'entrepreneur doit vérifier

omissions to the architect.

Projet / Project

Titre / Title

Échelle / Scale

04/04/25

**6 STOREY APARTMENT** BUILDING

240 PRESLAND ROAD

BASEMENT

Dessiné par / Drawn by No. projet / Project number 2424 Vérifié par / Verified by No. dessin / Drawing number


As indicated Date de création du dessin / Drawing creation date

CENTRE LINE

WINDOW NUMBER


REVISION NUMBER

(WXXXX)

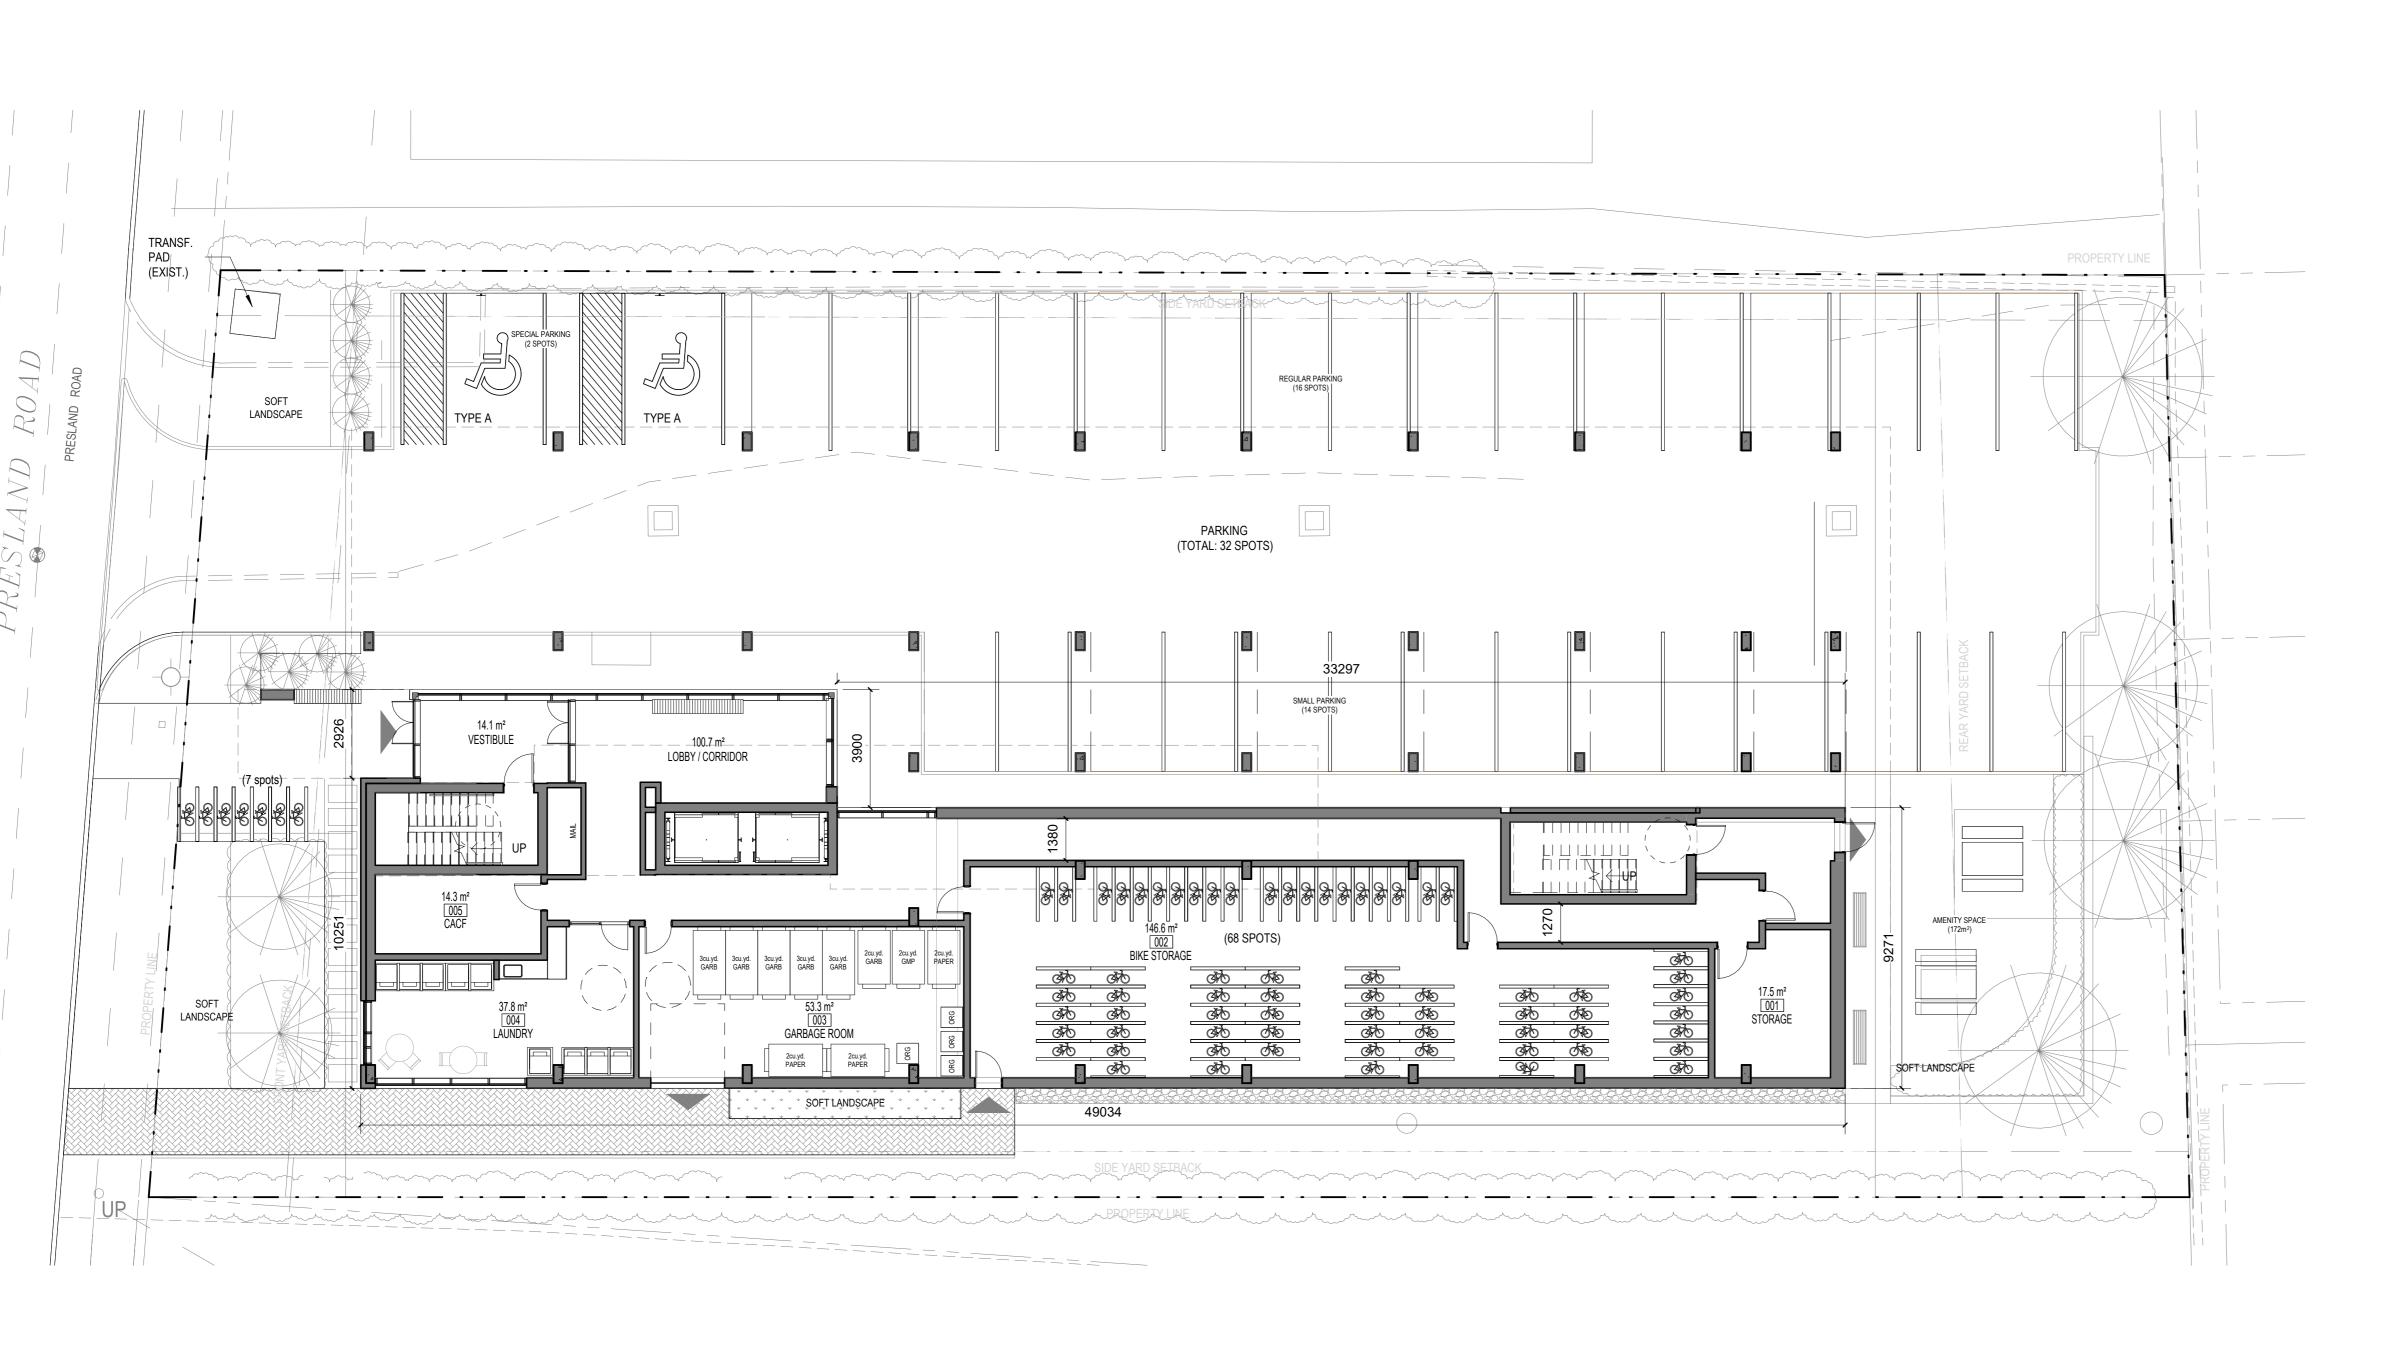





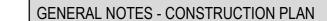

- 1. INTERIOR FINISHES (INCLUDING FLOORS AND BASEBOARDS): REFER TO FINISH PLANS FOR DETAILS OF
- 2. PROVIDE NAILERS ON ALL WALLS TO RECEIVE BUILT-IN FURNITURE, SHELVING, SCREENS, ETC.
- 3. UNLESS NOTED OTHERWISE, ALL DIMENSIONS ARE TAKEN FROM FACE OF STUDS AND CENTER OF DOORS AND WINDOWS. REQUIRED CLEARANCES WILL BE DIMENSIONED AND SHOWN TO FACE OF WALL OR DOOR OPENING
- 4. SEE A800 FOR DOOR SCHEDULE
- 5. UNLESS OTHERWISE INDICATED, ALL EQUIPMENT IS PROVIDED AND INSTALLED BY THE CONTRACTOR. THE CONTRACTOR MUST COORDINATE AND PROVIDE THE SERVICES REQUIRED TO POWER THE EQUIPMENT.
- 6. FILL ALL GAPS AND JOINTS WITH ACOUSTIC INSULATION AND SEAL WITH ACOUSTIC CAULKING WHEN ACOUSTIC PERFORMANCE IS REQUIRED.
- 7. COORDINATE WALL OPENINGS WITH MECHANICAL (SEE MECHANICAL DRAWINGS).
- 8. PLYWOOD PANELS USED AS NAILERS IN THE ELECTRICAL ROOMS MUST BE FIRE-TREATED.
- 9. PROVIDE ROD AND SHELF TYP. FOR ALL CLOSETS AS SHOWN.
- 10. ALL WINDOW AND DOOR DIMENSIONS ARE TO ROUGH STUD OPENING.
- 11. ALL OUTSIDE DIMENSIONS ARE TO OUTSIDE FACE OF STUD SHEATHING.
- 12. REFER TO STRUCTURAL DRAWINGS FOR BEAMS, LINTELS, POSTS, FLOOR, AND ROOF FRAMING.
- 13. ALL ELECTRICAL AND MECHANICAL ITEMS SHOWN ON DRAWINGS ARE FOR LOCATION PROPOSED ONLY. COORDINATE WITH M&E DRAWINGS.
- 14. CAULK AND SEAL AT ALL MECHANICAL AND ELECTRICAL PENETRATIONS.
- 15. PROVIDE FIRE STOPPING FOR MECHANICAL AND ELECTRICAL PENETRATONS THROUGH FIRE-RATED ASSEMBLIES. INFILL ANY UNUSED PENETRATIONS WITH FIRE-STOPPING TO SUIT ASSEMBLY.
- 16. REFER TO RCP PLANS FOR BULKHEAD LOCATIONS AND
- 17. FURNITURE SHOWN FOR REFERENCE PURPOSE ONLY.
- 18. ALL ELECTRICAL CONTROL HEIGHTS WITHIN BARRIER-FREE UNITS AND PATHS OF TRAVEL THROUGHOUT THE BUILDING TO COMPLY WITH CSA B-651
- 19. PROVIDE SOUNDPROOF FIBERGLASS BATT IN ALL PARTITIONS WITH SUPPLY PIPES, SANITARY DRAIN OR RAINWATER LEADERS. COORDINATE WITH MECH.
- 20. UNIT NAME: "XBD-B/F" INDICATES BARRIER-FREE REQUIREMENTS AS PER CAN/CSA, NATIONAL STANDARD OF CANADA, AND ACTION OTTAWA'S ACCESSBLE UNIT REQUIREMENTS.

## **GENERAL NOTES - PARTITIONS**

- 1. UNLESS INDICATED OTHERWISE, ALL NEW GYPSUM PARTITIONS ARE WOOD-FRAMED. REFER TO WALL TAGS FOR DETAILS OF COMPOSITION.
- 2. PARTITIONS CONTINUING TO THE SLAB MUST BLEND PERFECTLY WITH ITS GEOMETRY TO ENSURE THAT THE FULL PERIMETER IS CAULKED TO MEET THE REQUIRED ULC FIRE RESISTANCE AND/OR TO ENSURE THE REQUIRED ACOUSTIC PERFORMANCE.
- 3. UNLESS NOTED OTHERWISE, DOOR FRAMES ARE INSTALLED 4" FROM THE ADJACENT WALL.
- 4. WATER-REPELLENT GYPSUM PANELS ARE REQUIRED IN ROOMS WITH WATER OR MOISTURE EXPOSURE (BATHROOMS, JANITOR'S LODGE, KITCHENS WALL ABOVE MILLWORK, ETC.).
- 5. CONTRACTION JOINTS ON GYPSUM PANELS TO BE USED AT MAXIMUM 9,100mm (30'-0").
- 6. WALLS TO RECIEVE TILE FINISH MUST BE PROVIDED WITH FIBERBOARD BACKING WITHOUT COMPROMISING THE FIRE RESISTANCE RATING WHERE REQUIRED.

LEGEND - CONSTRUCTION PLAN

NEW WALL

WALL TYPE

1.23 - NUMBER OF WALL TYPE

— FIRE RATING

**ROOF TYPE** 

TYPE\
9'

(WXXXX)

0h = FIRE SEPARATION WITHOUT RATING 45 min. = FIRE RESISTANCE RATING OF 45 MIN. 1h = FIRE RESISTANCE RATING OF 1h

NUMBER AND CEILING HEIGHT

NUMBER AND ROOM NAME

WINDOW NUMBER

REVISION NUMBER

CENTRE LINE

Architecte Paysagiste/ Landscape Architect

No. Date Émis pour / Object

1 04/04/2025 SITE PLAN CONTROL



Ingénieur / Engineer (Civil / Civil)



Ingénieur / Engineer (Mécanique & Électricité / Mechanical & Electrical)



Ingénieur / Engineer (Structure / Structure)





3550, Saint-Antoine O.



T. 613 695-6122 Oroit d'auteur / Copyright

Ce dessin est sujet au droit d'auteur. Il ne peut être reproduit pour quelques intentions ou usages que ce soit, il ne peut être utilisé uniquement avec l'apposition de la signature et This drawing is subject to copyright. It is not to be reproduced for any purpose or by any means, and may only be used if it bears an original stamp and signature.



toutes les dimensions et informations sur le site et aviser immédiatement l'architecte de toutes erreurs Contractor shall verify all information and dimensions on site and immediately report any errors or omissions to the architect.

L'entrepreneur doit vérifier

Projet / Project

Titre / Title

**6 STOREY APARTMENT** 

No. projet / Project number 2424 No. dessin / Drawing number Échelle / Scale

As indicated Date de création du dessin / Drawing creation date 04/04/25

BUILDING


240 PRESLAND ROAD


LEVEL 1


Dessiné par / Drawn by Vérifié par / Verified by

A.121



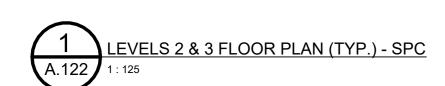

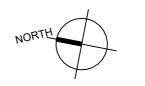

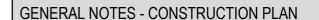

- 1. INTERIOR FINISHES (INCLUDING FLOORS AND BASEBOARDS): REFER TO FINISH PLANS FOR DETAILS OF
- 2. PROVIDE NAILERS ON ALL WALLS TO RECEIVE BUILT-IN FURNITURE, SHELVING, SCREENS, ETC.
- 3. UNLESS NOTED OTHERWISE, ALL DIMENSIONS ARE TAKEN FROM FACE OF STUDS AND CENTER OF DOORS AND WINDOWS. REQUIRED CLEARANCES WILL BE DIMENSIONED AND SHOWN TO FACE OF WALL OR DOOR OPENING
- 4. SEE A800 FOR DOOR SCHEDULE
- 5. UNLESS OTHERWISE INDICATED, ALL EQUIPMENT IS PROVIDED AND INSTALLED BY THE CONTRACTOR. THE CONTRACTOR MUST COORDINATE AND PROVIDE THE SERVICES REQUIRED TO POWER THE EQUIPMENT.
- 6. FILL ALL GAPS AND JOINTS WITH ACOUSTIC INSULATION AND SEAL WITH ACOUSTIC CAULKING WHEN ACOUSTIC PERFORMANCE IS REQUIRED.
- 7. COORDINATE WALL OPENINGS WITH MECHANICAL (SEE MECHANICAL DRAWINGS).
- 8. PLYWOOD PANELS USED AS NAILERS IN THE ELECTRICAL ROOMS MUST BE FIRE-TREATED.
- 9. PROVIDE ROD AND SHELF TYP. FOR ALL CLOSETS AS SHOWN.
- 10. ALL WINDOW AND DOOR DIMENSIONS ARE TO ROUGH STUD OPENING.
- 11. ALL OUTSIDE DIMENSIONS ARE TO OUTSIDE FACE OF STUD SHEATHING.
- 12. REFER TO STRUCTURAL DRAWINGS FOR BEAMS, LINTELS, POSTS, FLOOR, AND ROOF FRAMING.
- 13. ALL ELECTRICAL AND MECHANICAL ITEMS SHOWN ON DRAWINGS ARE FOR LOCATION PROPOSED ONLY. COORDINATE WITH M&E DRAWINGS.
- 14. CAULK AND SEAL AT ALL MECHANICAL AND ELECTRICAL PENETRATIONS.
- 15. PROVIDE FIRE STOPPING FOR MECHANICAL AND ELECTRICAL PENETRATONS THROUGH FIRE-RATED ASSEMBLIES. INFILL ANY UNUSED PENETRATIONS WITH FIRE-STOPPING TO SUIT ASSEMBLY.
- 16. REFER TO RCP PLANS FOR BULKHEAD LOCATIONS AND
- 17. FURNITURE SHOWN FOR REFERENCE PURPOSE ONLY.
- 18. ALL ELECTRICAL CONTROL HEIGHTS WITHIN BARRIER-FREE UNITS AND PATHS OF TRAVEL THROUGHOUT THE BUILDING TO COMPLY WITH CSA B-651
- 19. PROVIDE SOUNDPROOF FIBERGLASS BATT IN ALL PARTITIONS WITH SUPPLY PIPES, SANITARY DRAIN OR RAINWATER LEADERS. COORDINATE WITH MECH.
- 20. UNIT NAME: "XBD-B/F" INDICATES BARRIER-FREE REQUIREMENTS AS PER CAN/CSA, NATIONAL STANDARD OF CANADA, AND ACTION OTTAWA'S ACCESSBLE UNIT REQUIREMENTS.

## **GENERAL NOTES - PARTITIONS**

- 1. UNLESS INDICATED OTHERWISE, ALL NEW GYPSUM PARTITIONS ARE WOOD-FRAMED. REFER TO WALL TAGS FOR
- 2. PARTITIONS CONTINUING TO THE SLAB MUST BLEND
- INSTALLED 4" FROM THE ADJACENT WALL.
- 4. WATER-REPELLENT GYPSUM PANELS ARE REQUIRED IN ROOMS WITH WATER OR MOISTURE EXPOSURE (BATHROOMS, JANITOR'S LODGE, KITCHENS WALL ABOVE MILLWORK, ETC.).
- 5. CONTRACTION JOINTS ON GYPSUM PANELS TO BE USED AT
- 6. WALLS TO RECIEVE TILE FINISH MUST BE PROVIDED WITH FIBERBOARD BACKING WITHOUT COMPROMISING THE FIRE RESISTANCE RATING WHERE REQUIRED.

LEGEND - CONSTRUCTION PLAN

NEW WALL

WALL TYPE

1.23 - NUMBER OF WALL TYPE

0h = FIRE SEPARATION WITHOUT RATING 45 min. = FIRE RESISTANCE RATING OF 45 MIN. 1h = FIRE RESISTANCE RATING OF 1h

NUMBER AND CEILING HEIGHT

NUMBER AND ROOM NAME

WINDOW NUMBER

REVISION NUMBER

1h X 0.75h REAL FIRE RATING

## Architecte Paysagiste/ Landscape Architect

No. Date Issued for

1 04/04/2025 SITE PLAN CONTROL



Ingénieur / Engineer (Civil / Civil)



Ingénieur / Engineer (Mécanique & Électricité / Mechanical & Electrical)



Ingénieur / Engineer (Structure / Structure)



- DETAILS OF COMPOSITION.
- PERFECTLY WITH ITS GEOMETRY TO ENSURE THAT THE FULL PERIMETER IS CAULKED TO MEET THE REQUIRED ULC FIRE RESISTANCE AND/OR TO ENSURE THE REQUIRED ACOUSTIC PERFORMANCE.
- 3. UNLESS NOTED OTHERWISE, DOOR FRAMES ARE

- MAXIMUM 9,100mm (30'-0").

# Centretown Citizens Ottawa Corporation

Architecte / Architect 3550, Saint-Antoine O.

190 Somerset St W #206

Ottawa ON K2P 0J4

T. 613 695-6122

Oroit d'auteur / Copyright Ce dessin est sujet au droit d'auteur. Il ne peut être reproduit pour quelques intentions ou

Collectif d'architectes

usages que ce soit, il ne peut être utilisé uniquement avec l'apposition de la signature et de l'estampe originale. This drawing is subject to copyright. It is not to be reproduced for any purpose or by any means, and may only be used if it bears an original stamp and signature.



L'entrepreneur doit vérifier toutes les dimensions et informations sur le site et aviser immédiatement l'architecte de toutes erreurs Contractor shall verify all information and dimensions on site and immediately

report any errors or omissions to the architect.

Projet / Project

**6 STOREY APARTMENT** BUILDING

240 PRESLAND ROAD

Titre / Title LEVELS 2 & 3 (TYP.)

Dessiné par / Drawn by No. projet / Project number 2424 Vérifié par / Verified by No. dessin / Drawing number Échelle / Scale As indicated

Date de création du dessin / A.122 Drawing creation date 04/04/25

CENTRE LINE

(WXXXX)



GENERAL NOTES - CONSTRUCTION PLAN

1. INTERIOR FINISHES (INCLUDING FLOORS AND BASEBOARDS): REFER TO FINISH PLANS FOR DETAILS OF

2. PROVIDE NAILERS ON ALL WALLS TO RECEIVE BUILT-IN FURNITURE, SHELVING, SCREENS, ETC.

3. UNLESS NOTED OTHERWISE, ALL DIMENSIONS ARE TAKEN FROM FACE OF STUDS AND CENTER OF DOORS AND WINDOWS. REQUIRED CLEARANCES WILL BE DIMENSIONED AND SHOWN TO FACE OF WALL OR DOOR OPENING

4. SEE A800 FOR DOOR SCHEDULE

5. UNLESS OTHERWISE INDICATED, ALL EQUIPMENT IS PROVIDED AND INSTALLED BY THE CONTRACTOR. THE CONTRACTOR MUST COORDINATE AND PROVIDE THE SERVICES REQUIRED TO POWER THE EQUIPMENT.

6. FILL ALL GAPS AND JOINTS WITH ACOUSTIC INSULATION AND SEAL WITH ACOUSTIC CAULKING WHEN ACOUSTIC PERFORMANCE IS REQUIRED.

7. COORDINATE WALL OPENINGS WITH MECHANICAL (SEE MECHANICAL DRAWINGS).

8. PLYWOOD PANELS USED AS NAILERS IN THE ELECTRICAL ROOMS MUST BE FIRE-TREATED.

9. PROVIDE ROD AND SHELF TYP. FOR ALL CLOSETS AS SHOWN.

10. ALL WINDOW AND DOOR DIMENSIONS ARE TO ROUGH STUD OPENING.

11. ALL OUTSIDE DIMENSIONS ARE TO OUTSIDE FACE OF STUD SHEATHING.

12. REFER TO STRUCTURAL DRAWINGS FOR BEAMS, LINTELS, POSTS, FLOOR, AND ROOF FRAMING.

13. ALL ELECTRICAL AND MECHANICAL ITEMS SHOWN ON DRAWINGS ARE FOR LOCATION PROPOSED ONLY. COORDINATE WITH M&E DRAWINGS.

14. CAULK AND SEAL AT ALL MECHANICAL AND ELECTRICAL PENETRATIONS.

15. PROVIDE FIRE STOPPING FOR MECHANICAL AND ELECTRICAL PENETRATONS THROUGH FIRE-RATED ASSEMBLIES. INFILL ANY UNUSED PENETRATIONS WITH FIRE-STOPPING TO SUIT ASSEMBLY.

16. REFER TO RCP PLANS FOR BULKHEAD LOCATIONS AND

17. FURNITURE SHOWN FOR REFERENCE PURPOSE ONLY.

18. ALL ELECTRICAL CONTROL HEIGHTS WITHIN BARRIER-FREE UNITS AND PATHS OF TRAVEL THROUGHOUT THE BUILDING TO COMPLY WITH CSA B-651

19. PROVIDE SOUNDPROOF FIBERGLASS BATT IN ALL PARTITIONS WITH SUPPLY PIPES, SANITARY DRAIN OR RAINWATER LEADERS. COORDINATE WITH MECH.

20. UNIT NAME: "XBD-B/F" INDICATES BARRIER-FREE REQUIREMENTS AS PER CAN/CSA, NATIONAL STANDARD OF CANADA, AND ACTION OTTAWA'S ACCESSBLE UNIT REQUIREMENTS.

# **GENERAL NOTES - PARTITIONS**

1. UNLESS INDICATED OTHERWISE, ALL NEW GYPSUM PARTITIONS ARE WOOD-FRAMED. REFER TO WALL TAGS FOR DETAILS OF COMPOSITION.

2. PARTITIONS CONTINUING TO THE SLAB MUST BLEND PERFECTLY WITH ITS GEOMETRY TO ENSURE THAT THE FULL PERIMETER IS CAULKED TO MEET THE REQUIRED ULC FIRE RESISTANCE AND/OR TO ENSURE THE REQUIRED ACOUSTIC PERFORMANCE.

3. UNLESS NOTED OTHERWISE, DOOR FRAMES ARE INSTALLED 4" FROM THE ADJACENT WALL.

4. WATER-REPELLENT GYPSUM PANELS ARE REQUIRED IN ROOMS WITH WATER OR MOISTURE EXPOSURE (BATHROOMS, JANITOR'S LODGE, KITCHENS WALL ABOVE MILLWORK, ETC.).

5. CONTRACTION JOINTS ON GYPSUM PANELS TO BE USED AT MAXIMUM 9,100mm (30'-0").

6. WALLS TO RECIEVE TILE FINISH MUST BE PROVIDED WITH FIBERBOARD BACKING WITHOUT COMPROMISING THE FIRE RESISTANCE RATING WHERE REQUIRED.

Architecte Paysagiste/ Landscape Architect

No. Date Issued for

1 04/04/2025 SITE PLAN CONTROL



Ingénieur / Engineer (Civil / Civil)



Ingénieur / Engineer (Mécanique & Électricité / Mechanical & Electrical)



Ingénieur / Engineer (Structure / Structure)



**Centretown Citizens** Ottawa Corporation

Architecte / Architect Collectif d'architectes 3550, Saint-Antoine O.

190 Somerset St W #206 Ottawa ON K2P 0J4 T. 613 695-6122

Oroit d'auteur / Copyright Ce dessin est sujet au droit d'auteur. Il ne peut être reproduit pour quelques intentions ou usages que ce soit, il ne peut être utilisé uniquement avec l'apposition de la signature et

de l'estampe originale. This drawing is subject to copyright. It is not to be reproduced for any purpose or by any means, and may only be used if it bears an original stamp and signature.



informations sur le site et aviser immédiatement l'architecte de toutes erreurs Contractor shall verify all information and dimensions on site and immediately report any errors or omissions to the architect.

L'entrepreneur doit vérifier toutes les dimensions et

Projet / Project

Titre / Title

Échelle / Scale

**6 STOREY APARTMENT** BUILDING

240 PRESLAND ROAD


LEVEL 4

Dessiné par / Drawn by No. projet / Project number 2424 Vérifié par / Verified by No. dessin / Drawing number

As indicated Date de création du dessin / Drawing creation date 04/04/25



NEW WALL WALL TYPE 1.23 - NUMBER OF WALL TYPE

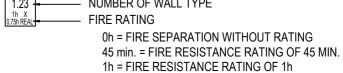





NUMBER AND CEILING HEIGHT

NUMBER AND ROOM NAME




WINDOW NUMBER

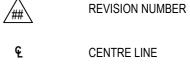

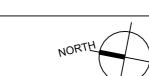



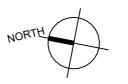



- 1. INTERIOR FINISHES (INCLUDING FLOORS AND BASEBOARDS): REFER TO FINISH PLANS FOR DETAILS OF
- 2. PROVIDE NAILERS ON ALL WALLS TO RECEIVE BUILT-IN FURNITURE, SHELVING, SCREENS, ETC.
- 3. UNLESS NOTED OTHERWISE, ALL DIMENSIONS ARE TAKEN FROM FACE OF STUDS AND CENTER OF DOORS AND WINDOWS. REQUIRED CLEARANCES WILL BE DIMENSIONED AND SHOWN TO FACE OF WALL OR DOOR OPENING
- 4. SEE A800 FOR DOOR SCHEDULE
- 5. UNLESS OTHERWISE INDICATED, ALL EQUIPMENT IS PROVIDED AND INSTALLED BY THE CONTRACTOR. THE CONTRACTOR MUST COORDINATE AND PROVIDE THE SERVICES REQUIRED TO POWER THE EQUIPMENT.
- 6. FILL ALL GAPS AND JOINTS WITH ACOUSTIC INSULATION AND SEAL WITH ACOUSTIC CAULKING WHEN ACOUSTIC PERFORMANCE IS REQUIRED.
- 7. COORDINATE WALL OPENINGS WITH MECHANICAL (SEE MECHANICAL DRAWINGS).
- 8. PLYWOOD PANELS USED AS NAILERS IN THE ELECTRICAL ROOMS MUST BE FIRE-TREATED.
- 9. PROVIDE ROD AND SHELF TYP. FOR ALL CLOSETS AS
- SHOWN. 10. ALL WINDOW AND DOOR DIMENSIONS ARE TO ROUGH STUD OPENING.
- 11. ALL OUTSIDE DIMENSIONS ARE TO OUTSIDE FACE OF STUD SHEATHING.
- 12. REFER TO STRUCTURAL DRAWINGS FOR BEAMS, LINTELS, POSTS, FLOOR, AND ROOF FRAMING.
- 13. ALL ELECTRICAL AND MECHANICAL ITEMS SHOWN ON DRAWINGS ARE FOR LOCATION PROPOSED ONLY.
- 14. CAULK AND SEAL AT ALL MECHANICAL AND ELECTRICAL PENETRATIONS.

COORDINATE WITH M&E DRAWINGS.

- 15. PROVIDE FIRE STOPPING FOR MECHANICAL AND ELECTRICAL PENETRATONS THROUGH FIRE-RATED ASSEMBLIES. INFILL ANY UNUSED PENETRATIONS WITH FIRE-STOPPING TO SUIT ASSEMBLY.
- 16. REFER TO RCP PLANS FOR BULKHEAD LOCATIONS AND
- 17. FURNITURE SHOWN FOR REFERENCE PURPOSE ONLY.
- 18. ALL ELECTRICAL CONTROL HEIGHTS WITHIN BARRIER-FREE UNITS AND PATHS OF TRAVEL THROUGHOUT THE BUILDING TO COMPLY WITH CSA B-651
- 19. PROVIDE SOUNDPROOF FIBERGLASS BATT IN ALL PARTITIONS WITH SUPPLY PIPES, SANITARY DRAIN OR RAINWATER LEADERS. COORDINATE WITH MECH.
- 20. UNIT NAME: "XBD-B/F" INDICATES BARRIER-FREE REQUIREMENTS AS PER CAN/CSA, NATIONAL STANDARD OF CANADA, AND ACTION OTTAWA'S ACCESSBLE UNIT REQUIREMENTS.

## **GENERAL NOTES - PARTITIONS**

- 1. UNLESS INDICATED OTHERWISE, ALL NEW GYPSUM PARTITIONS ARE WOOD-FRAMED. REFER TO WALL TAGS FOR
- 2. PARTITIONS CONTINUING TO THE SLAB MUST BLEND
- 3. UNLESS NOTED OTHERWISE, DOOR FRAMES ARE INSTALLED 4" FROM THE ADJACENT WALL.
- 4. WATER-REPELLENT GYPSUM PANELS ARE REQUIRED IN ROOMS WITH WATER OR MOISTURE EXPOSURE (BATHROOMS,
- MAXIMUM 9,100mm (30'-0").
- 6. WALLS TO RECIEVE TILE FINISH MUST BE PROVIDED WITH FIBERBOARD BACKING WITHOUT COMPROMISING THE FIRE

Architecte Paysagiste/ Landscape Architect

No. Date Issued for

1 04/04/2025 SITE PLAN CONTROL



Ingénieur / Engineer (Civil / Civil)



Ingénieur / Engineer (Mécanique & Électricité / Mechanical & Electrical)



Ingénieur / Engineer (Structure / Structure)



DETAILS OF COMPOSITION.

PERFECTLY WITH ITS GEOMETRY TO ENSURE THAT THE FULL PERIMETER IS CAULKED TO MEET THE REQUIRED ULC FIRE RESISTANCE AND/OR TO ENSURE THE REQUIRED ACOUSTIC PERFORMANCE.

JANITOR'S LODGE, KITCHENS WALL ABOVE MILLWORK, ETC.).

5. CONTRACTION JOINTS ON GYPSUM PANELS TO BE USED AT

RESISTANCE RATING WHERE REQUIRED.

LEGEND - CONSTRUCTION PLAN

NEW WALL

WALL TYPE

1.23 - NUMBER OF WALL TYPE

0h = FIRE SEPARATION WITHOUT RATING 45 min. = FIRE RESISTANCE RATING OF 45 MIN. 1h = FIRE RESISTANCE RATING OF 1h

NUMBER AND CEILING HEIGHT

NUMBER AND ROOM NAME

WINDOW NUMBER

REVISION NUMBER

CENTRE LINE

1h X 0.75h REAL FIRE RATING

(WXXXX)

# Centretown Citizens Ottawa Corporation

Architecte / Architect Collectif d'architectes 3550, Saint-Antoine O.

190 Somerset St W #206 Ottawa ON K2P 0J4 T. 613 695-6122

Oroit d'auteur / Copyright Ce dessin est sujet au droit d'auteur. Il ne peut être reproduit pour quelques intentions ou

usages que ce soit, il ne peut être utilisé uniquement avec l'apposition de la signature et de l'estampe originale. This drawing is subject to copyright. It is not to be reproduced for any purpose or by any means, and may only be used if it bears an original stamp and signature.



L'entrepreneur doit vérifier toutes les dimensions et informations sur le site et aviser immédiatement l'architecte de toutes erreurs Contractor shall verify all information and dimensions on site and immediately report any errors or

omissions to the architect.

Projet / Project

Titre / Title

04/04/25


**6 STOREY APARTMENT** BUILDING


240 PRESLAND ROAD


LEVELS 5 & 6 (TYP.)

Dessiné par / Drawn by No. projet / Project number 2424 Vérifié par / Verified by No. dessin / Drawing number Échelle / Scale

As indicated Date de création du dessin / Drawing creation date

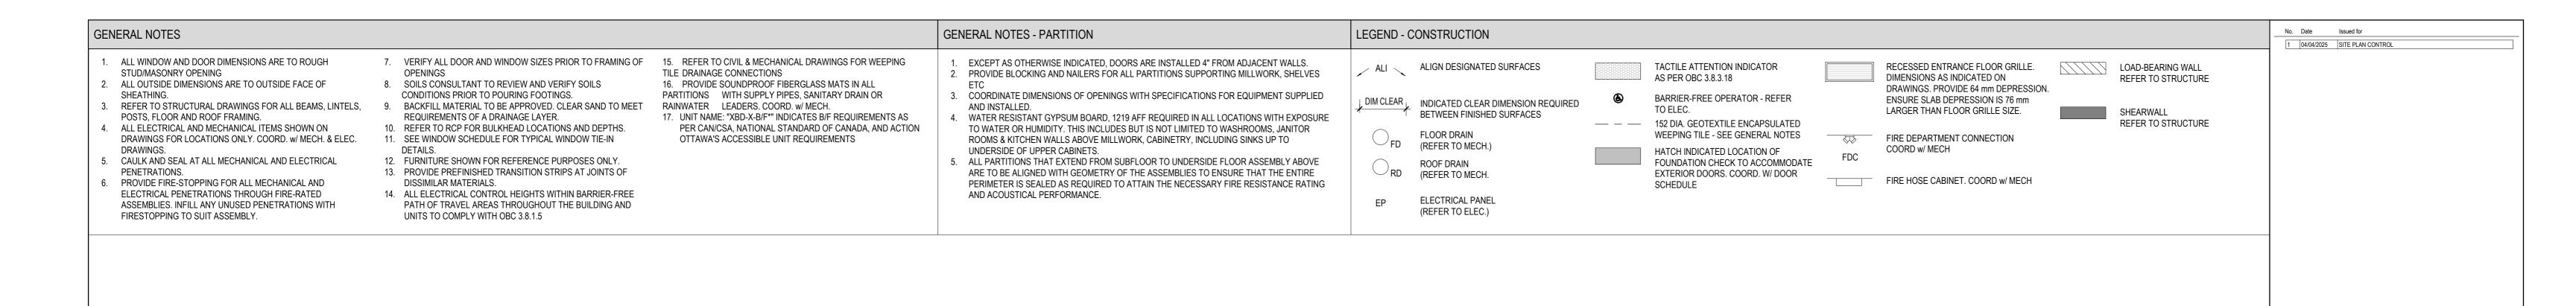

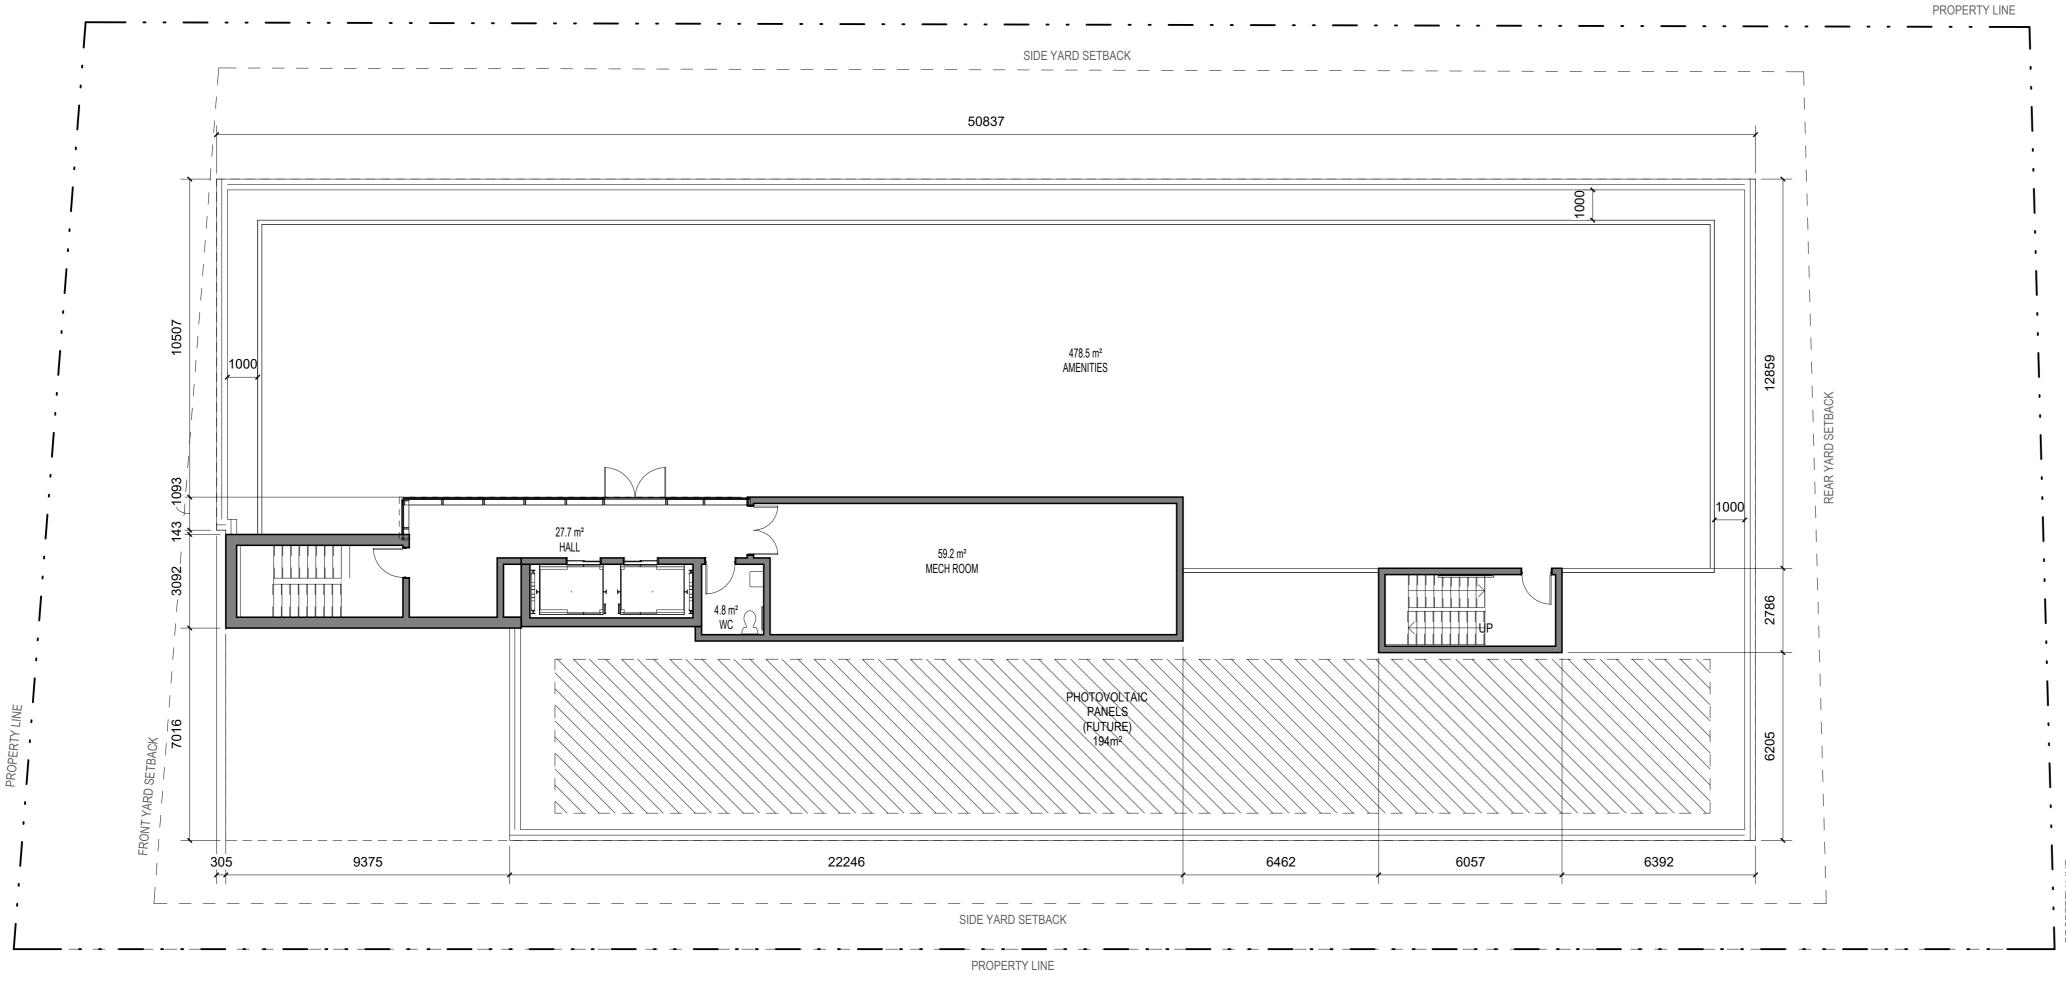

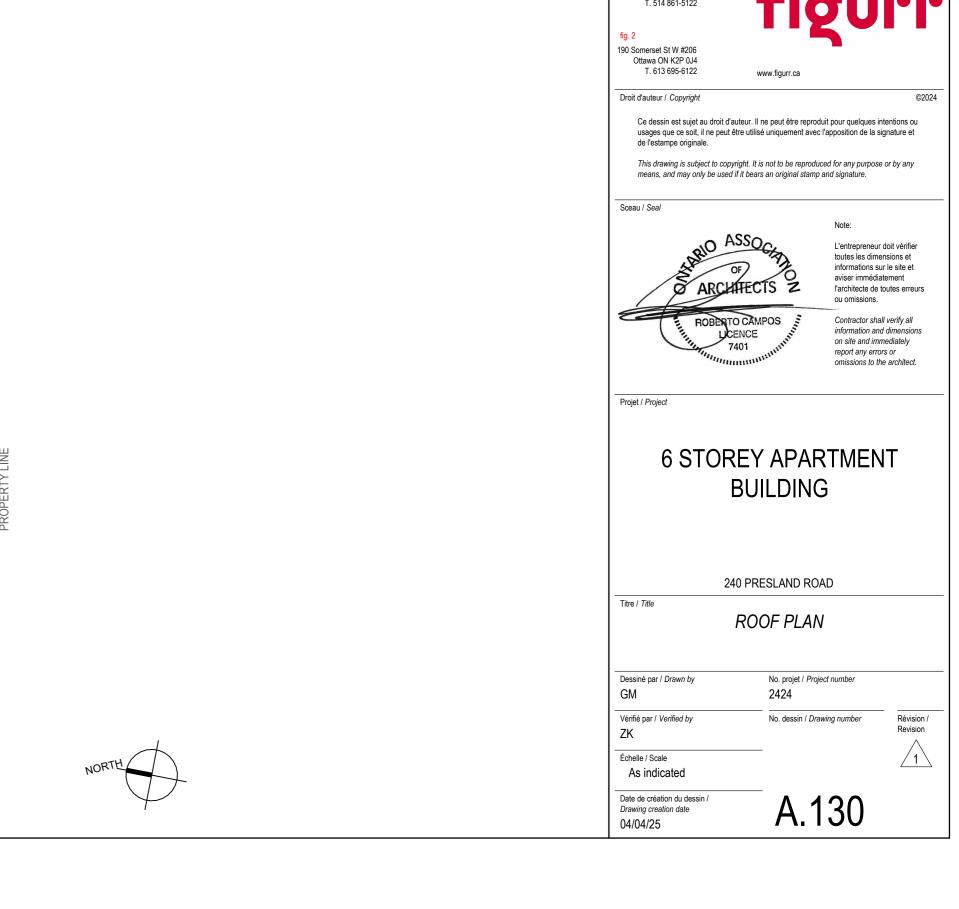

Architecte Paysagiste/ Landscape Architect

Ingénieur / Engineer (Mécanique & Électricité / Mechanical & Electrical)

Ingénieur / Engineer (Civil / Civil)

Architecte / Architect

3550, Saint-Antoine O.

design strategies

Centretown Citizens Ottawa Corporation

