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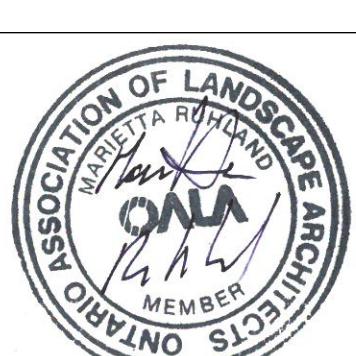
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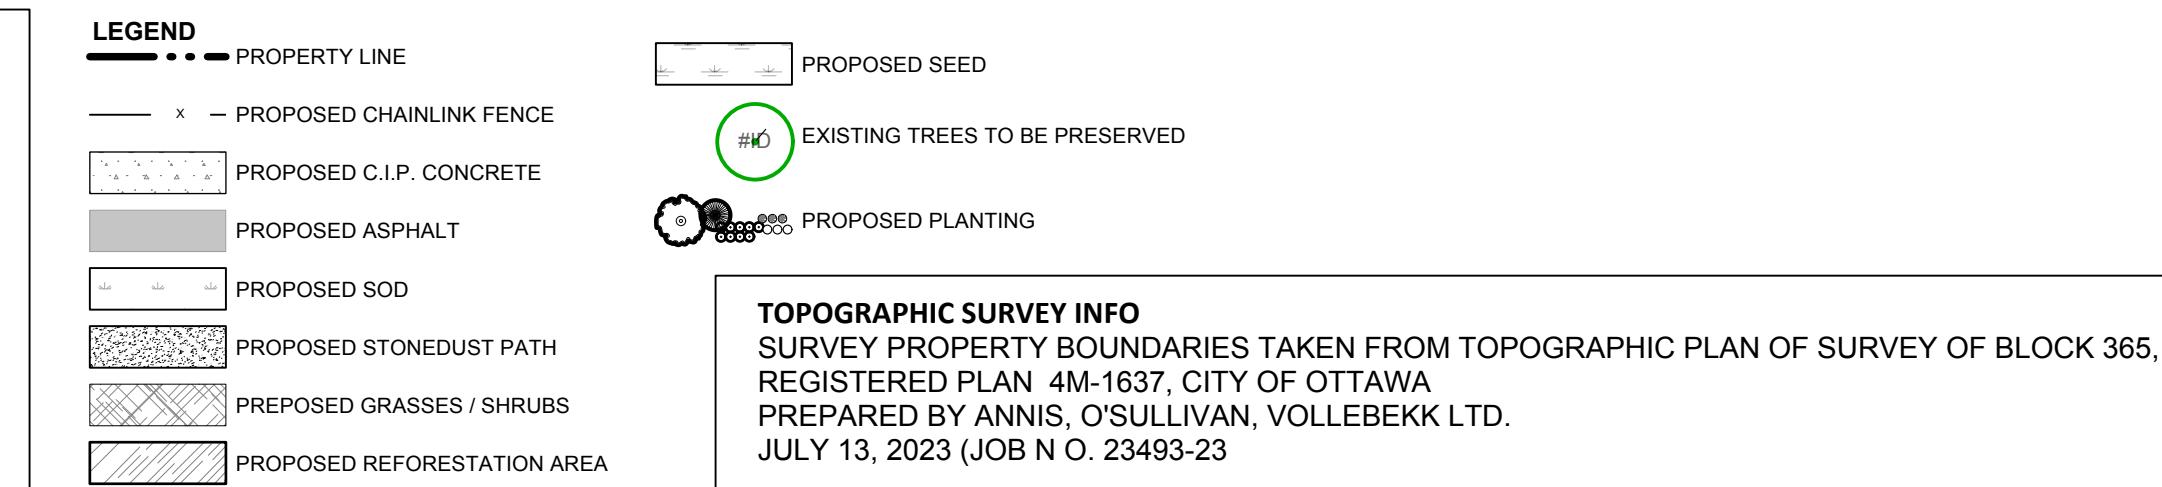
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**FERNBANK CATHOLIC HIGH SCHOOL**  
5431 FERNBANK ROAD  
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north

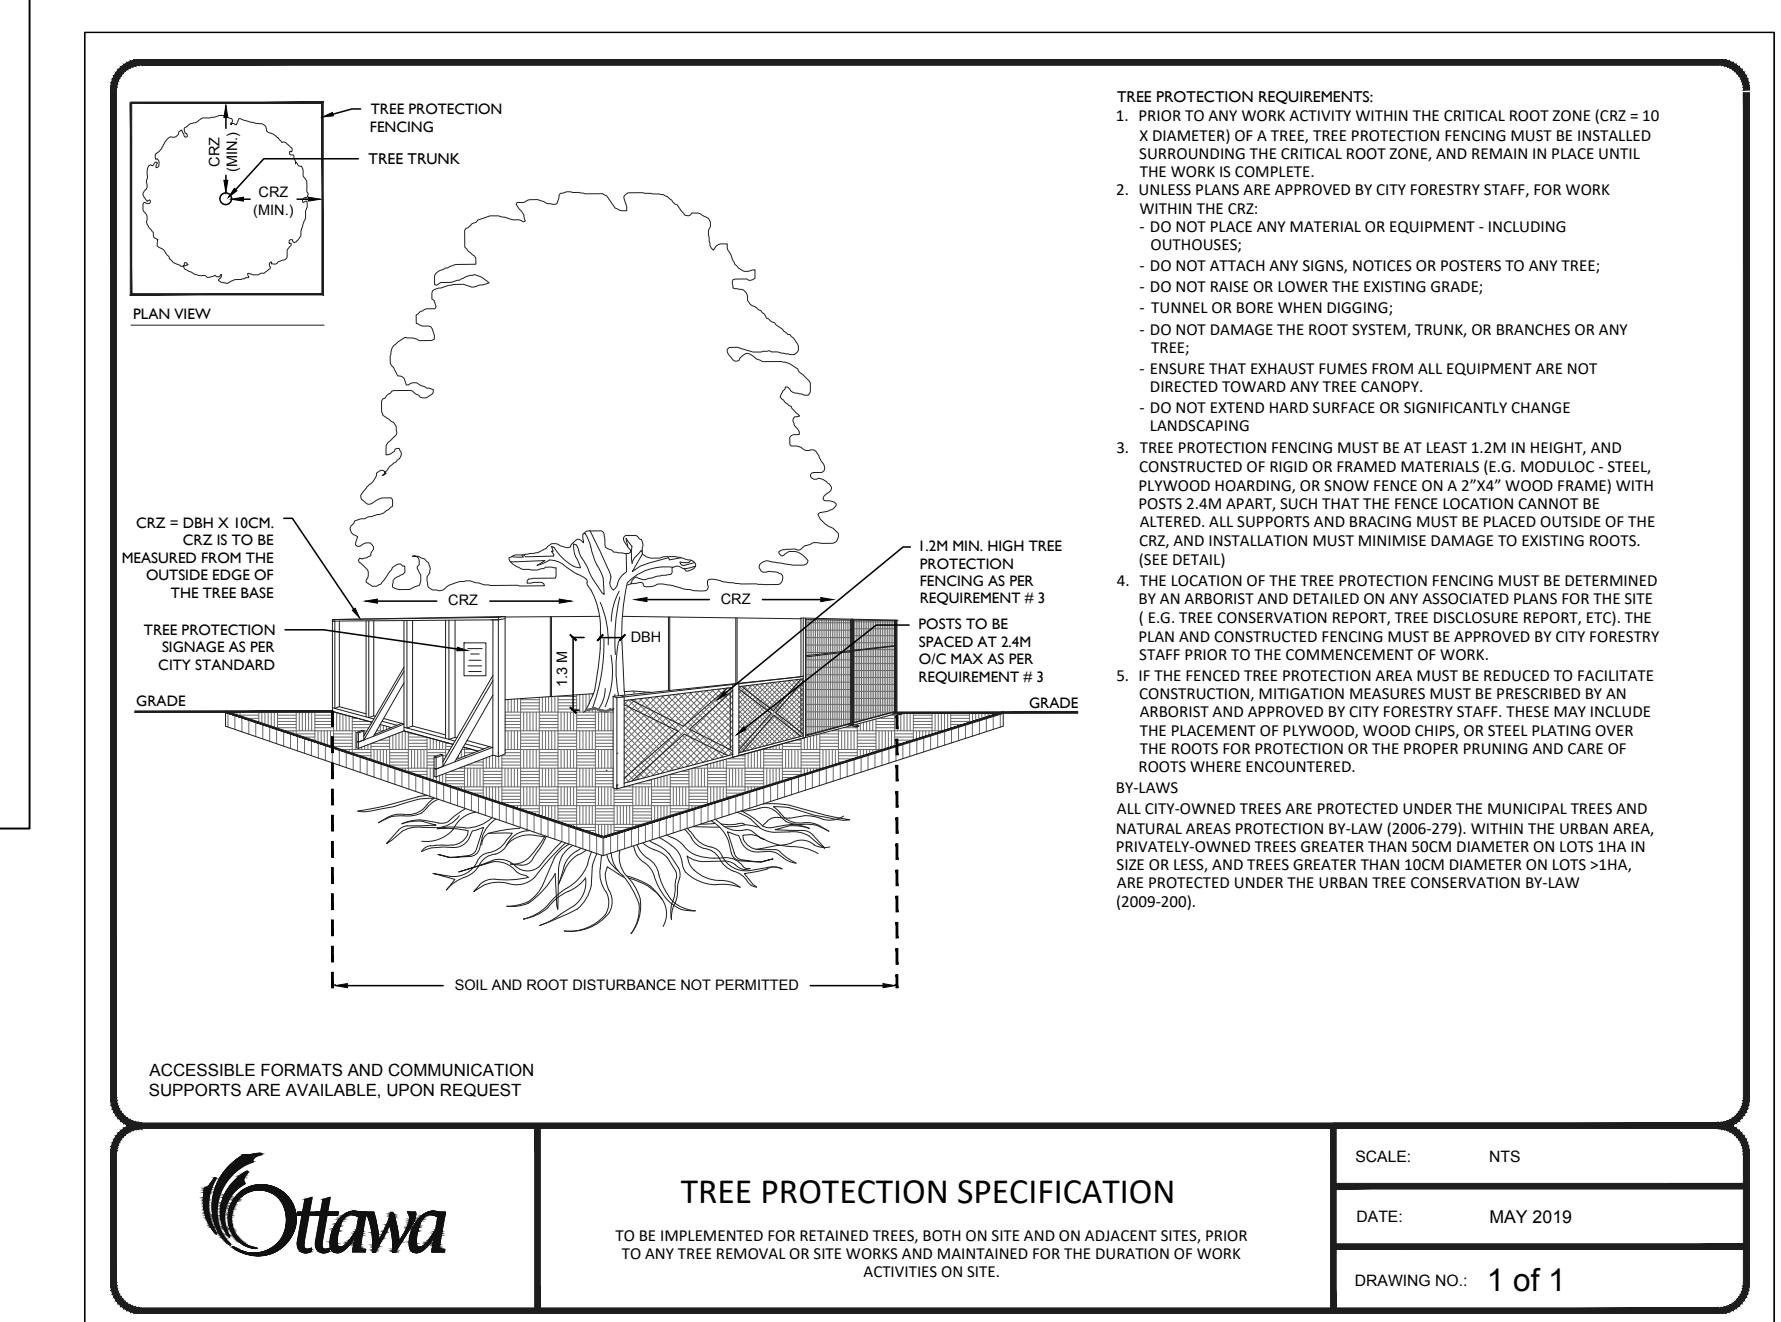


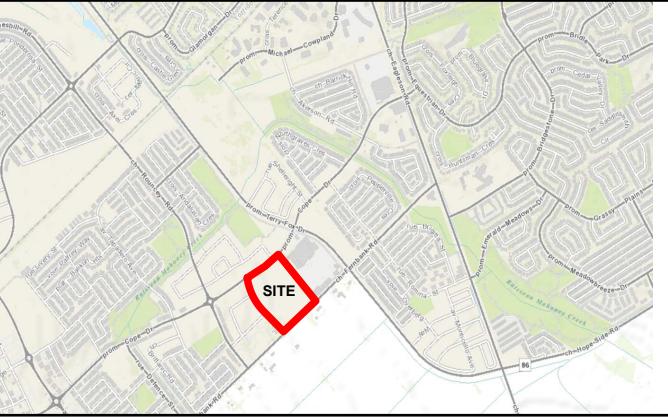
LANDSCAPE / PLANTING PLAN	scale	drawn by	D.A.
	date	checked by	M.R.
	project number	drawing number	N45
	RA 24-1743		L - 01
NOTE: SITE SERVICING ELEMENTS SHOWN ON THIS SHEET ARE FOR REFERENCE ONLY. SEE CIVIL DRAWINGS FOR SITE SERVICING / GRADING.			
THIS PLAN IS ISSUED FOR SITE PLAN CONTROL SUBMISSION ONLY. ADDITIONAL DETAILING AND SPECIFICATIONS ARE REQUIRED PRIOR TO TENDERING AND CONS.			
PLAN TO BE READ IN CONJUNCTION WITH 'TREE CONSERVATION REPORT FOR 5431 FERNBANK ROAD, OTTAWA ON' NOVEMBER 27, 2025 BY Andrew K. Boyd, Certified Arborist #ON-0496A, IFS Associates.			
 <b>Ottawa</b>		TREE PROTECTION SPECIFICATION	SCALE: NTS DATE: MAY 2019 DRAWING NO.: 1 of 1
TO BE IMPLEMENTED FOR RETAINED TREES, BOTH ON SITE AND ON ADJACENT SITES, PRIOR TO ANY TREE REMOVAL OR SITE WORKS AND MAINTAINED FOR THE DURATION OF WORK ACTIVITIES ON SITE.			



Plant List					
Origin	ID	Qty	Botanical Name	Common Name	Scheduled Si Remarks
<b>49) LARGE DECIDUOUS TREES</b>					
Ntv	Ar	8	Acer rubrum	Red Maple	70mm caliper WB, Staked
Ntv	As	9	Acer saccharum	Sugar Maple	70mm caliper WB, Staked
Ntv	Co	14	Celtis occidentalis	Common Hackberry	60mm caliper WB, Staked
Ntv H	GtS	6	Gleditsia triacanthos inermis 'Shademaster'	Shademaster Thornless Honeylocust	90mm caliper WB, Staked
Ntv	Qa	3	Quercus alba	White Oak	70mm caliper WB, Staked
Ntv	Qm	3	Quercus macrocarpa	Burr Oak	70mm caliper WB, Staked
Ntv	Qr	3	Quercus rubra	Northern Red Oak	70mm caliper WB, Staked
Ntv	Ta	3	Tilia americana	Basswood	70mm caliper WB, Staked
Ntv	TaB	8	Tilia americana 'Boulevard'	Boulevard Linden	70mm caliper WB, Staked
Ntv	Ag	16	Aesculus glabra	Ohio Buckeye	50mm caliper WB, Staked
Ntv	Cc	5	Carpinus caroliniana	Bluebeech, Musclewood	50mm caliper WB, Staked
Ntv	Gd	5	Gymnocladus dioicus	Kentucky Coffee Tree	50mm caliper WB, Staked
Ntv H	GtD	6	Gleditsia triacanthos inermis 'Draves'	Streetkeeper Honeylocust	70mm caliper WB, Staked
Non N	MD	7	Malus Dolgo'	Malus Dolgo'	60mm caliper WB, Staked
Ntv	Ov	11	Ostrya virginiana	Ironwood	50mm caliper WB, Staked
Non N	UF	4	Ulmus minor x parvifolia 'Frontier'	Frontier Elm	70mm caliper WB, Staked
Ntv H	CcgC	12	Crataegus crus-galli inermis 'Cuzam'	Thornless Crusader Cockspur Hawthorn	45mm caliper WB, Staked
Non N	MSD	1	Malus x 'Snowdrift'	Snowdrift Crabapple	40mm caliper WB, Staked
Ntv	Sd	9	Sorbus Americana	Mountain Ash	45mm caliper WB, Staked
Ntv H	AcB	2	Amelanchier canadensis 'Ballerina'	Ballerina Serviceberry (tree form)	40mm caliper WB, Staked
<b>84) CONIFEROUS TREES</b>					
Ntv	Ab	8	Abies balsamea	Balsam Fir	200 cm ht WB, Staked
Non N	JcBP	4	Juniperus chinensis 'Blue Point'	Blue Point Juniper	150 cm ht Potted
Ntv	Pg	11	Picea glauca	White Spruce	200 cm ht WB, Staked
Ntv	Pr	20	Pinus resinosa	Red Pine	200 cm ht WB, Staked
Ntv	Ps	13	Pinus strobus	Eastern White Pine	200 cm ht WB, Staked
Ntv	ToDs	3	Thuya occidentalis 'Degroot's Spire'	Degroot's Spire Arborvitae	150 cm ht. Potted
Ntv	ToH	25	Thuya occidentalis 'Holmstrup'	Holmstrup Cedar	125cm ht Potted
Ntv	DI	264	Diervilia lonicera	Dwarf Bush-honeysuckle	2 gallon pot
Ntv	Hp	42	Hypericum prolificum	Shrubby St. John's Wort	2 gallon pot
Non N	HpFl	63	Hydrangea paniculata 'Fire & Ice'	Fire & Ice paniclie hydrangea	2 gallon pot 0.9m o.c.
Ntv	Rp	69	Rosa palustris	Swamp Rose	3 year Potted
Ntv H	HalW	43	Hydrangea arborescens 'Invincibelle Wee White'	Wee White Annabelle Hydrangea	3 year Potted
<b>40) REFORESTATION PLANTING</b>					
Ntv	As	5	Acer saccharum	Sugar Maple	150 cm ht. Bare root
Ntv	Asa for	5	Acer rubrum	Red Maple	150 cm ht. Bare root
Ntv	Bp for	5	Betulus papyrifera	White Birch	150 cm ht. Bare root
Ntv	Ov for	5	Ostrya virginiana	American Hop hornbeam	150 cm ht. Bare root
Ntv	Pg for	5	Picea glauca	White Spruce	75 cm ht. Potted
Ntv H	Ps for	5	Pinus strobus	White Pine	50 cm ht. Potted
Ntv	Qm for	5	Quercus macrocarpa	Bur Oak	150 cm ht. Bare root
Ntv	Tc for	5	Tsuga canadensis	Canadian Hemlock	75 cm ht. Potted
<b>617) PERENNIALS</b>					
Non N	CaKF	189	Calamagrostis x acutiflora 'Karl Foerster'	Feather Reed Grass	3 year Potted
Ntv	Hs	109	Helictochon sompervirens	Ornamental Oats	3 year Potted
Ntv	Pv	141	Panicum virgatum	Switch Grass	1 gallon pot
Mix	PvF	38	Perennial Mix A - Shade	Ornamental Grasses - Shade	2 gallon pot
Ntv H	PvHM	140	Panicum virgatum 'Heavy Metal'	Heavy Metal Switch Grass	3 year Potted

EXISTING TREES UNDER CITY OWNERSHIP = 35, UNDER ADJACENT PRIVATE OWNERSHIP = 40  
PROPOSED TREES IN CITY R.O.W. = 3





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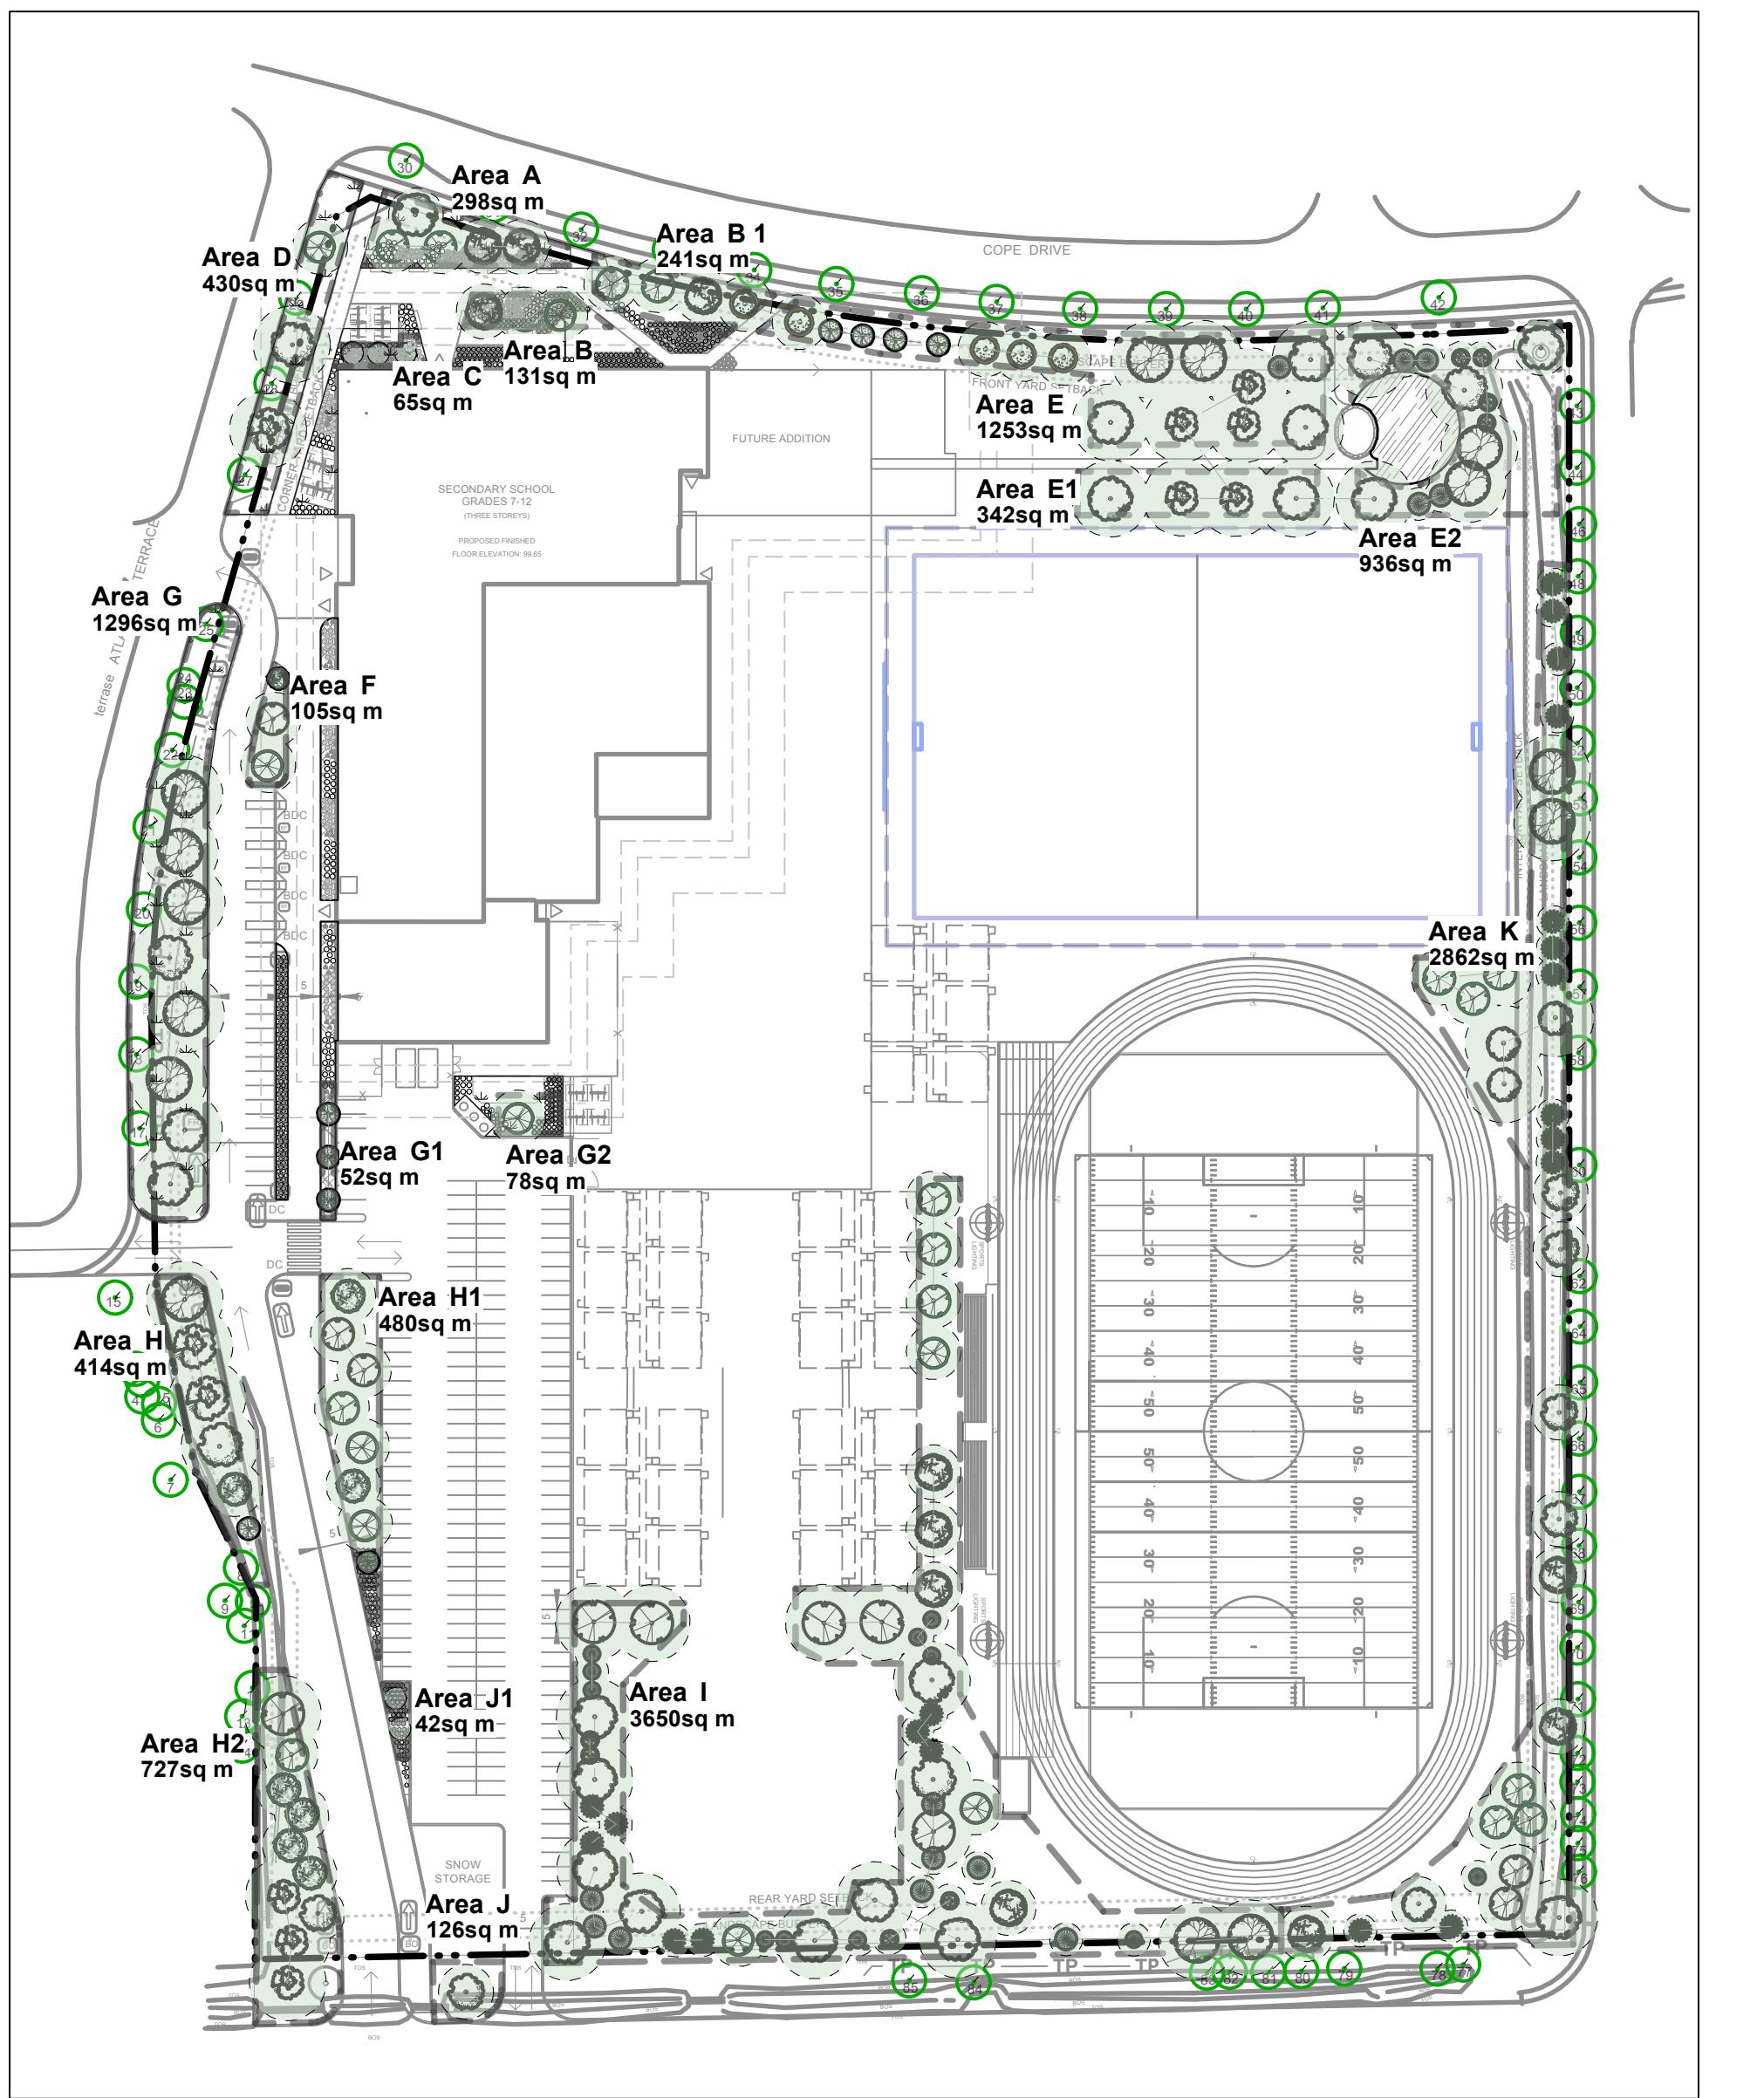
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**Ottawa** TITLE: PLANTING TRENCH DATE: MAY 2001  
WELL DRAINED SOILS (LOTS) REV: JAN 2017  
DWG No: L2

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1 CANOPY COVERAGE & SOIL VOLUMES  
L - 02  
Scale: 1:1200  
0 10 20 30 40 50 m



Soil Volume Area, Tree Quantity and Size	Tree Quantity	OTTAWA Target Soil Volume (m <sup>3</sup> )	Design Soil Volume	Soil Adequacy percentage	%Soil to be supplied by contractor
AREA A - 4 Medium trees					SEE NOTE
plant bed (298 sq m x 0.4 ave metre deep)	4	120.0	119.2	99%	2
AREA B - 2 Medium, 1 Small Trees					SEE NOTE
plant bed (131 sq m x 0.4 ave metre deep)	3	55.0	52.4	95%	2
AREA B 1 - 4 Medium trees					SEE NOTE
plant bed (241 sq m x 0.4 ave metre deep)	4	100.0	96.4	96%	1
AREA C - 3 Small trees					SEE NOTE
plant bed (65 sq m x 0.7 ave metre deep)	3	45.0	45.5	101%	1
AREA D - 2 Large, 1 Small, 3 Existing trees					SEE NOTE
plant bed (430 sq m x 0.4 ave metre deep)	6	119.0	172.0	145%	3
AREA E - 8 Large, 4 Medium, 4 Small, 1 Coniferous trees					SEE NOTE
plant bed (1253 sq m x 0.4 ave metre deep)	17	350.0	501.2	143%	4
AREA E 1 - 4 Large trees					SEE NOTE
plant bed (1296 sq m x 0.4 ave metre deep)	4	100.0	136.8	137%	4
AREA E 2 - 5 Large, 8 Coniferous trees					SEE NOTE
plant bed (936 sq m x 0.4 ave metre deep)	13	269.0	374.4	139%	4
AREA F - 1 Medium, 2 Small trees					SEE NOTE
plant bed (105 sq m x 0.5 ave metre deep)	3	48.0	52.5	109%	1
AREA G - 8 Large, 9 Existing trees					SEE NOTE
plant bed (1296 sq m x 0.4 ave metre deep)	17	362.0	518.4	143%	3
AREA G 1 - 3 Small trees					SEE NOTE
plant bed (51.6 sq m x 0.9ave metre deep)	3	45.0	46.4	103%	1
AREA G 2 - 1 Small tree					SEE NOTE
plant bed (78.5 sq m x 0.4ave metre deep)	1	25.0	31.4	126%	1
AREA G 3 - 7 Medium, 1 Small trees					SEE NOTE
plant bed (479 sq m x 0.4ave metre deep)	8	144.0	191.6	133%	1
AREA H - 4 Large, 1 Medium, 1 Small trees					SEE NOTE
plant bed (414 sq m x 0.4ave metre deep)	6	133.0	165.6	125%	3
AREA H 1 - 5 Medium, 3 Small trees					SEE NOTE
plant bed (480 sq m x 0.4ave metre deep)	8	144.0	192.0	133%	1
AREA H 2 - 1 Large, 3 Large Columnar, 6 Medium trees					SEE NOTE
plant bed (727 sq m x 0.4ave metre deep)	10	180.0	290.8	162%	1
AREA I - 16 Large, 3 Medium, 3 Small, 27 Coniferous trees					SEE NOTE
plant bed (3650 sq m x 0.4ave metre deep)	51	1035.0	1460.0	141%	4
AREA J - 1 Medium trees					SEE NOTE
plant bed (126 sq m x 0.4ave metre deep)	1	30.0	50.4	168%	1
AREA J 1 - 2 Ornamental trees					SEE NOTE
plant bed (42 sq m x 0.6ave metre deep)	2	24.0	25.2	105%	1
AREA K - 6 Large, 15 Medium, 13 Coniferous trees					SEE NOTE
plant bed (2862 sq m x 0.4ave metre deep)	45	672.0	1144.8	170%	4

\* Smaller columnar trees, small ornamental trees with growth to 8-15cm DBH, large shrubs, and columnar conifers calculated using "How much soil to grow a big tree" by DeepRoot as a guide

**NOTES:**  
**PLANTING MEDIUM REQUIREMENTS FOR TREE PLANTING**

**.1 WHERE SOIL VOLUMES ARE WITHIN EXCAVATED DEVELOPMENT AREA:**  
PROVIDE 100% PLANTING MEDIUM TO DEPTHS INDICATED IN SOIL VOLUME CHART.  
WHERE SUBSOIL BELOW THE INDICATED DEPTH OF PLANTING MEDIUM IS NOT CONDUCIVE TO PLANT GROWTH, REPLACE WITH APPROVED SUBSOIL TO A FURTHER DEPTH OF 300mm.

**.2 WHERE SOIL VOLUMES INCLUDE SOIL VOLUMES IN R.O.W. AT PROPERTY LINE**  
R.O.W. AND WITHIN SUBJECT PROPERTY:  
ASSUME ALL SOIL VOLUME REQUIREMENTS ARE MET WITHIN THE R.O.W. AREA. REINSTATE ANY DISTURBED AREAS IN R.O.W. OUTSIDE THE 2m RADIUS TREE PITS WITH 100-150mm TOPSOIL AND SOD.  
PLACE PLANTING MEDIUM (TO DEPTH INDICATED ON SOIL VOLUME CHART) AT ALL DISTURBED AREAS WHERE EXISTING SOILS ARE REMOVED, OR WHERE EXISTING SOILS ARE NOT CONDUCIVE TO PLANT GROWTH.  
ADDITIONAL PLANTING MEDIUM IS NOT REQUIRED WHERE EXISTING SOIL IS PRESENT IN OR ADJACENT TO THE R.O.W. THIS DOES NOT INCLUDE TOPSOIL REQUIRED FOR SODDING.  
WHERE SUBSOIL BELOW THE INDICATED DEPTH OF PLANTING MEDIUM IS NOT CONDUCIVE TO PLANT GROWTH, REPLACE WITH APPROVED SUBSOIL TO A FURTHER DEPTH OF 300mm.  
BASE CONTRACT TO ASSUME SUBSOIL IS CONDUCIVE TO PLANT GROWTH.

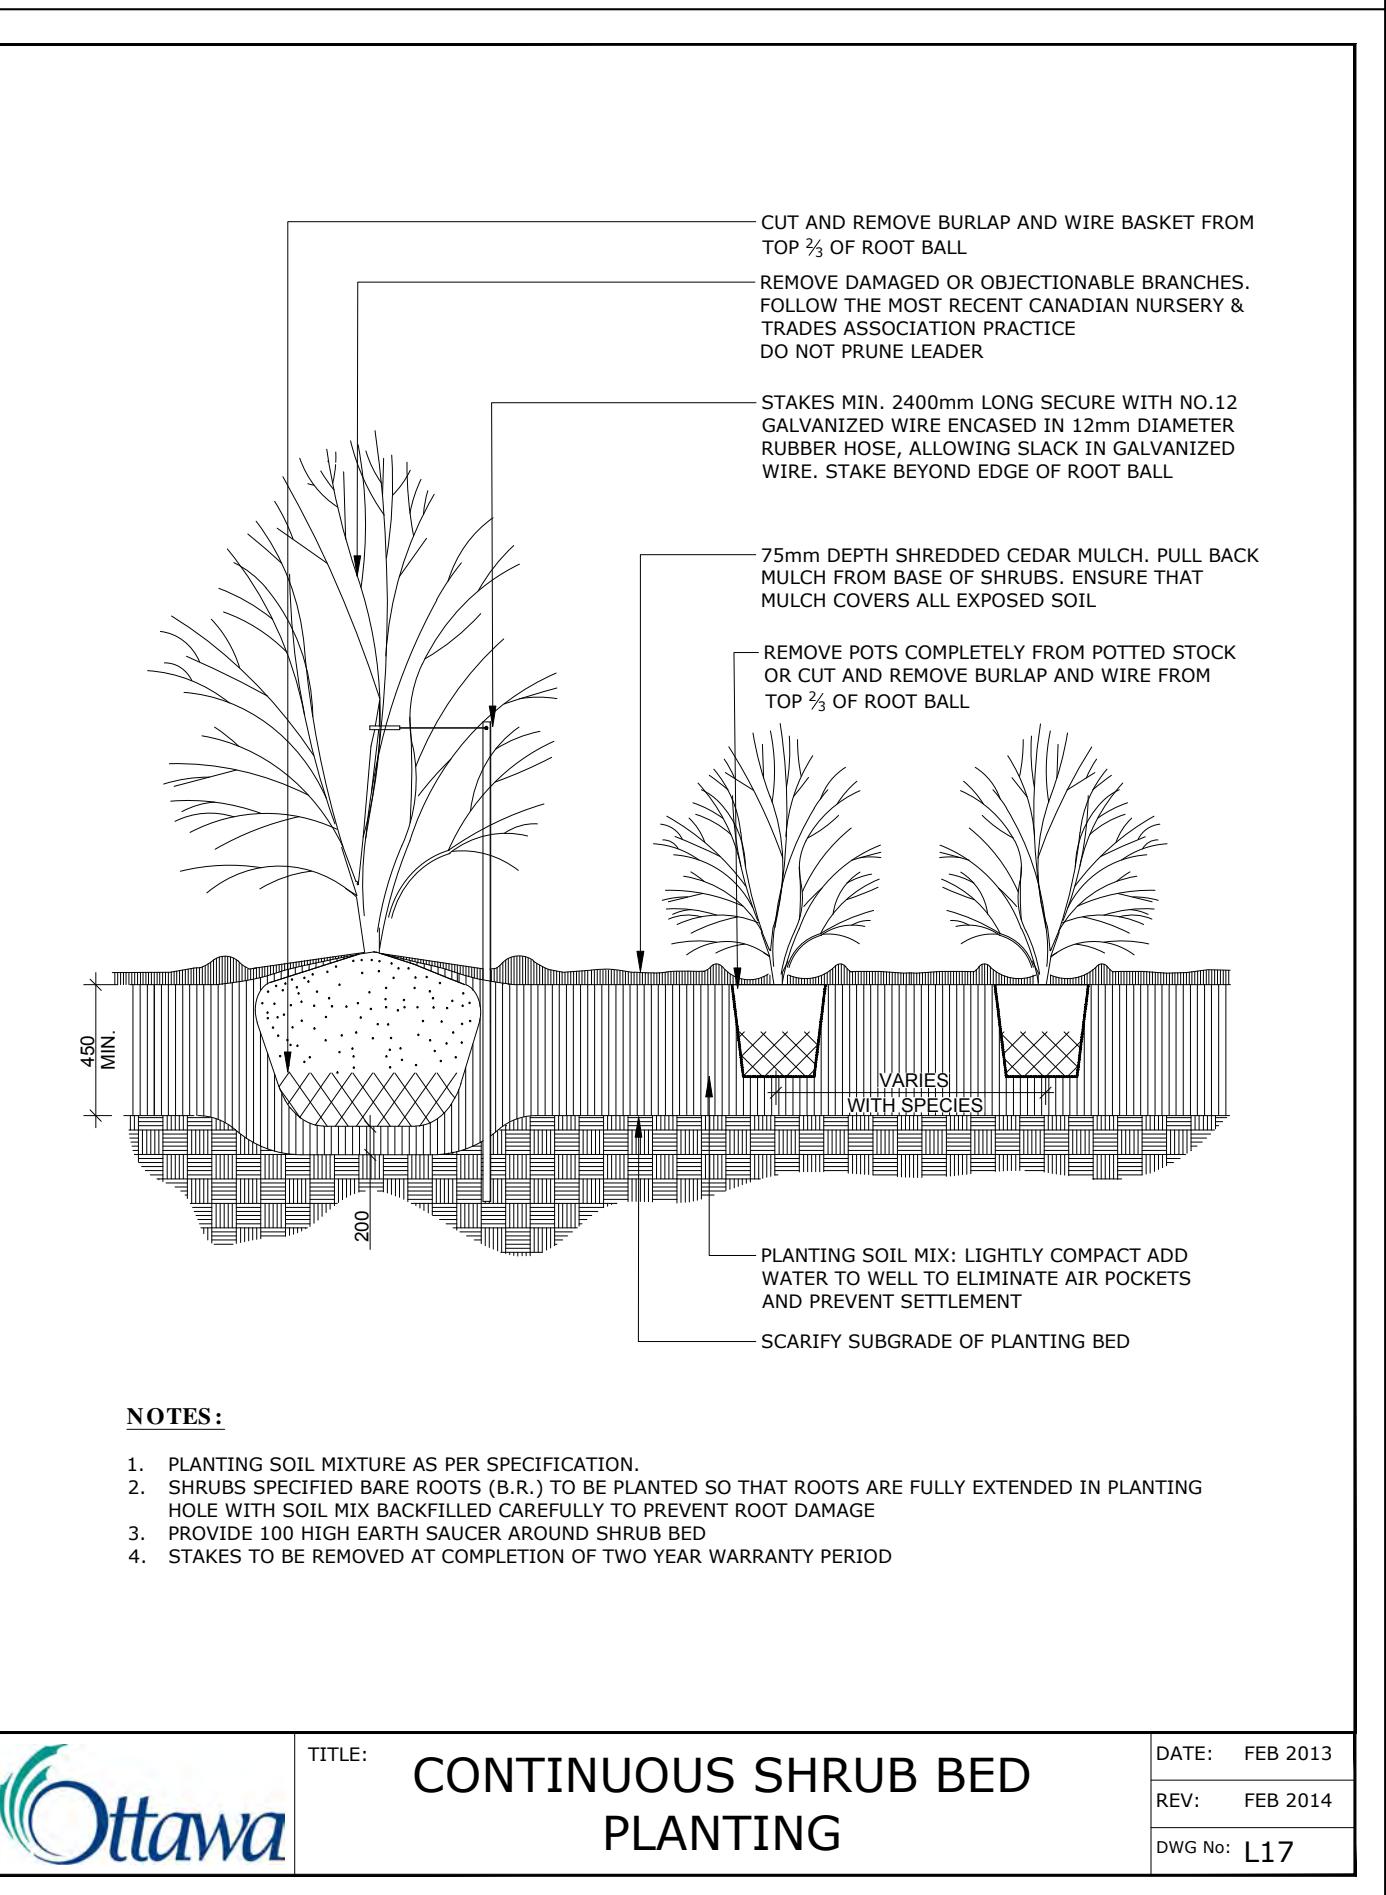
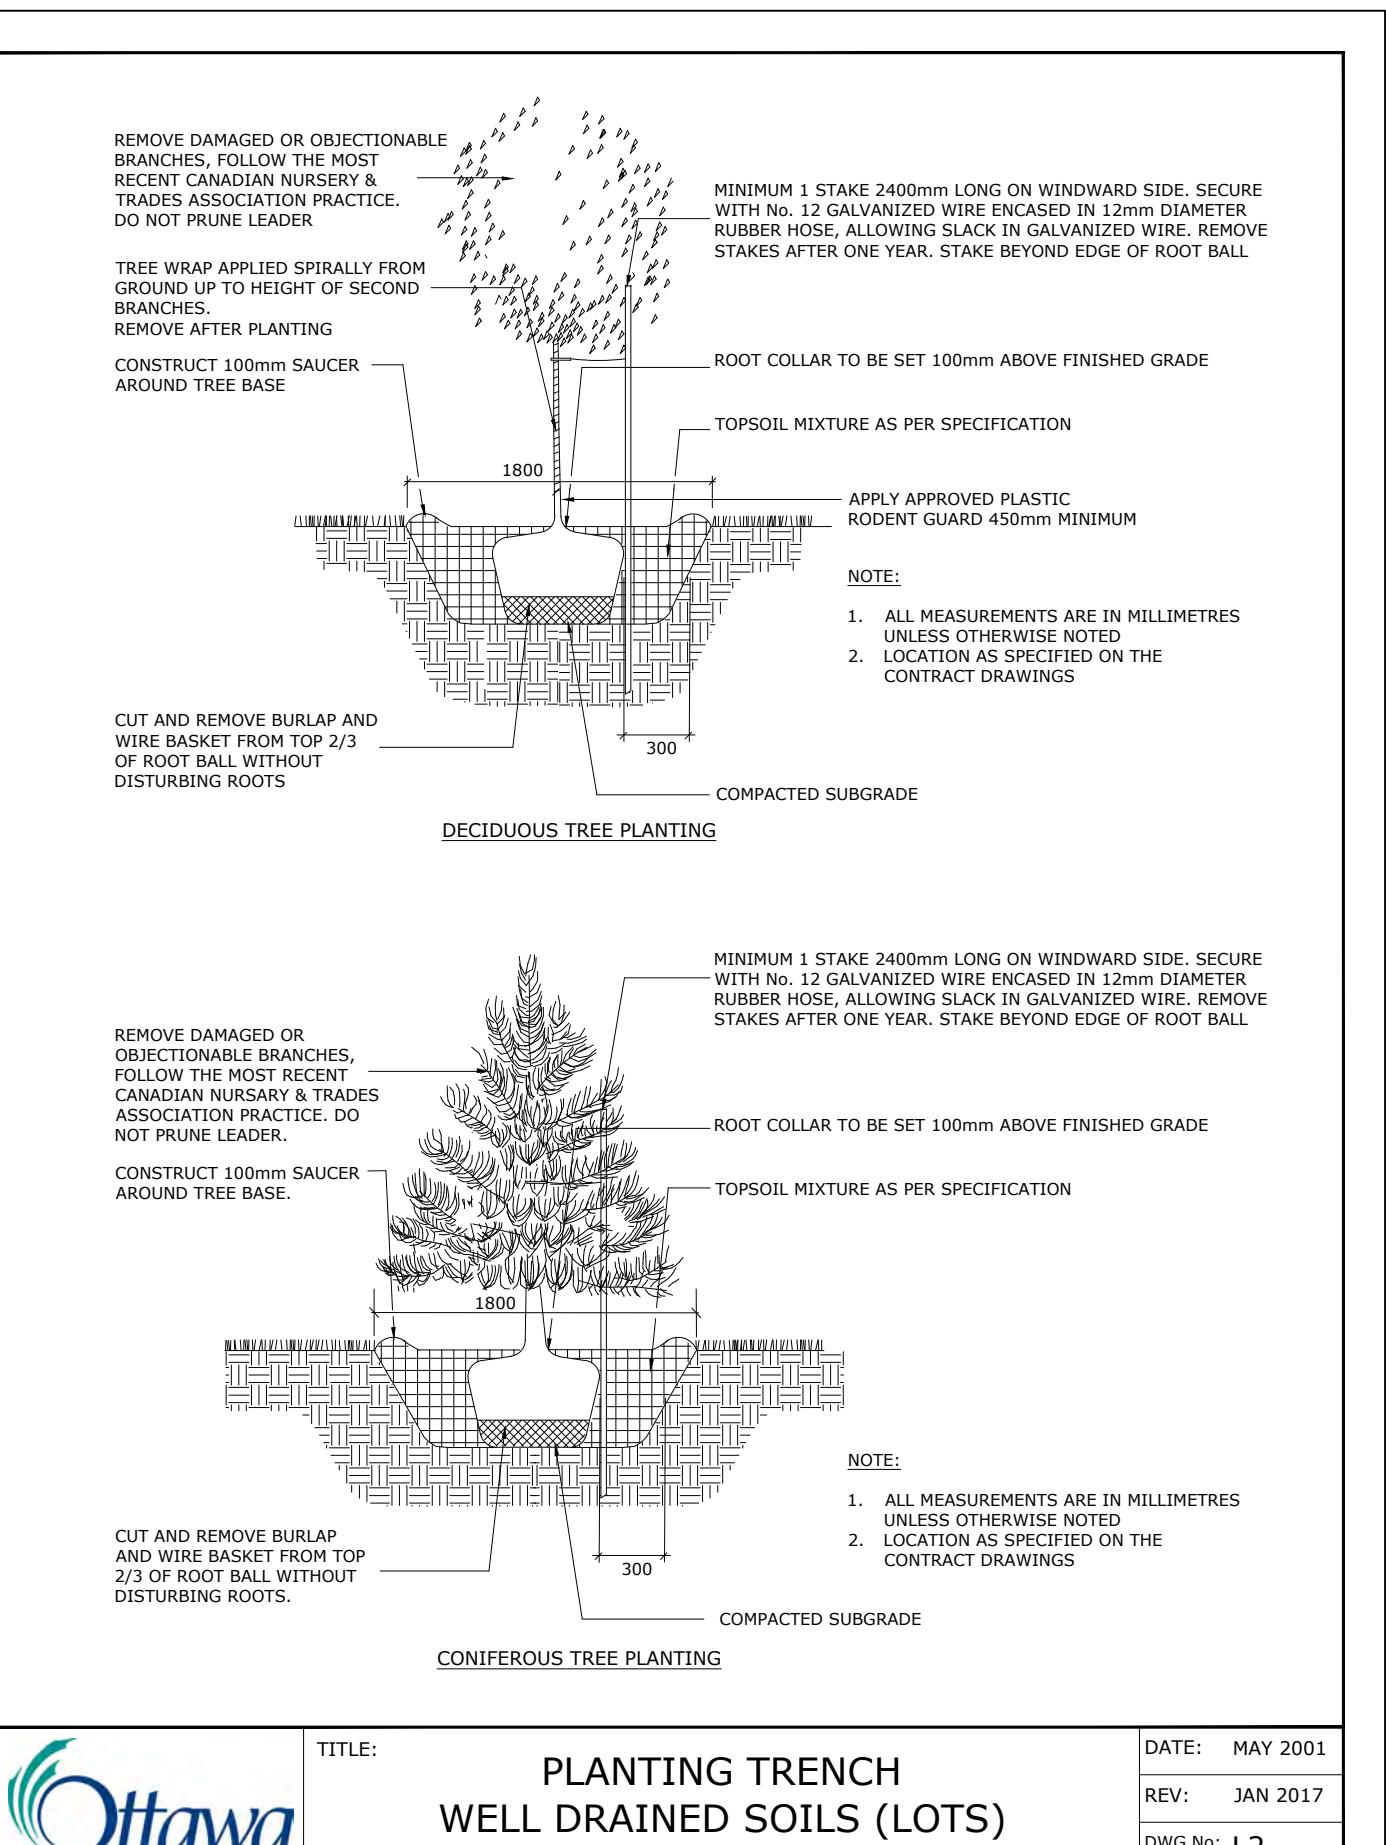
**.3 WHERE SOIL VOLUMES INCLUDE SOIL VOLUMES ON ADJACENT PROPERTY AT PROPERTY LINE**  
ADJACENT PROPERTY AND WITHIN SUBJECT PROPERTY:  
ASSUME ALL SOIL VOLUME REQUIREMENTS ARE MET WITHIN THE ADJACENT PROPERTY AREA. REINSTATE ANY DISTURBED AREAS ON ADJACENT PROPERTY OUTSIDE THE 2m RADIUS TREE PITS WITH 100-150mm TOPSOIL AND SOD.  
PLACE PLANTING MEDIUM (TO DEPTH INDICATED ON SOIL VOLUME CHART) AT ALL DISTURBED AREAS WHERE EXISTING SOILS ARE REMOVED, OR WHERE EXISTING SOILS ARE NOT CONDUCIVE TO PLANT GROWTH.  
ADDITIONAL PLANTING MEDIUM IS NOT REQUIRED WHERE EXISTING SOIL IS PRESENT IN OR ADJACENT TO THE ADJACENT PROPERTY. THIS DOES NOT INCLUDE TOPSOIL REQUIRED FOR SODDING.  
WHERE SUBSOIL BELOW THE INDICATED DEPTH OF PLANTING MEDIUM IS NOT CONDUCIVE TO PLANT GROWTH, REPLACE WITH APPROVED SUBSOIL TO A FURTHER DEPTH OF 300mm.  
BASE CONTRACT TO ASSUME SUBSOIL IS CONDUCIVE TO PLANT GROWTH.

**.4 AREAS NEAR SOCCER FIELD AND OUTDOOR CLASSROOM**  
ASSUME ALL SOIL VOLUME REQUIREMENTS ARE MET, REINSTATE ANY DISTURBED AREAS ON ADJACENT PROPERTY OUTSIDE THE 2m RADIUS TREE PITS WITH 100-150mm TOPSOIL AND SOD.  
ADDITIONAL PLANTING MEDIUM IS NOT REQUIRED WHERE EXISTING SOIL IS PRESENT IN OR ADJACENT TO THE ADJACENT PROPERTY. THIS DOES NOT INCLUDE TOPSOIL REQUIRED FOR SODDING.  
WHERE SUBSOIL BELOW THE INDICATED DEPTH OF PLANTING MEDIUM IS NOT CONDUCIVE TO PLANT GROWTH, REPLACE WITH APPROVED SUBSOIL TO A FURTHER DEPTH OF 300mm.  
BASE CONTRACT TO ASSUME SUBSOIL IS CONDUCIVE TO PLANT GROWTH.

**NOTES:**  
**TREE SOIL VOLUME REQUIREMENTS:**  
STANDARD TREE SOIL VOLUMES QUANTITIES INCLUDE THE TOP 900-1000mm OF SOIL/EXISTING SUBSOIL LAYER TO CALCULATE TOTAL SOIL VOLUMES REQUIRED BY CITY OF OTTAWA FOR SUSTAINABLE TREE GROWTH. WHERE LARGER SOFT AREAS ARE AVAILABLE, THE TOP 400-500mm LAYER IS USED TO CALCULATE SOIL VOLUMES (AS PER CITY DETAIL L1).

WHERE EXISTING MATERIAL BELOW THE SPECIFIED IMPORTED TOPSOIL IS NOT CONDUCIVE TO TREE GROWTH, AN ADDITIONAL LAYER OF PLANTING MEDIUM IS TO BE INSTALLED BELOW SPECIFIED TOPSOIL DEPTH TO OBTAIN THE SOIL VOLUME DEPTH REQUIRED.

REFER TO SOIL VOLUME CHART AND PLANS ON L-02 FOR AREAS WHERE TREE SOIL VOLUMES ARE REQUIRED.





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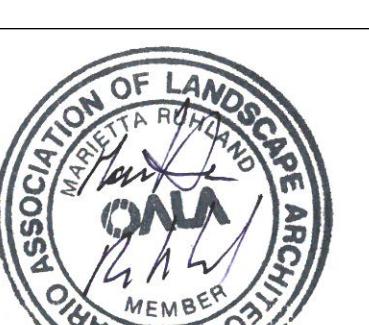
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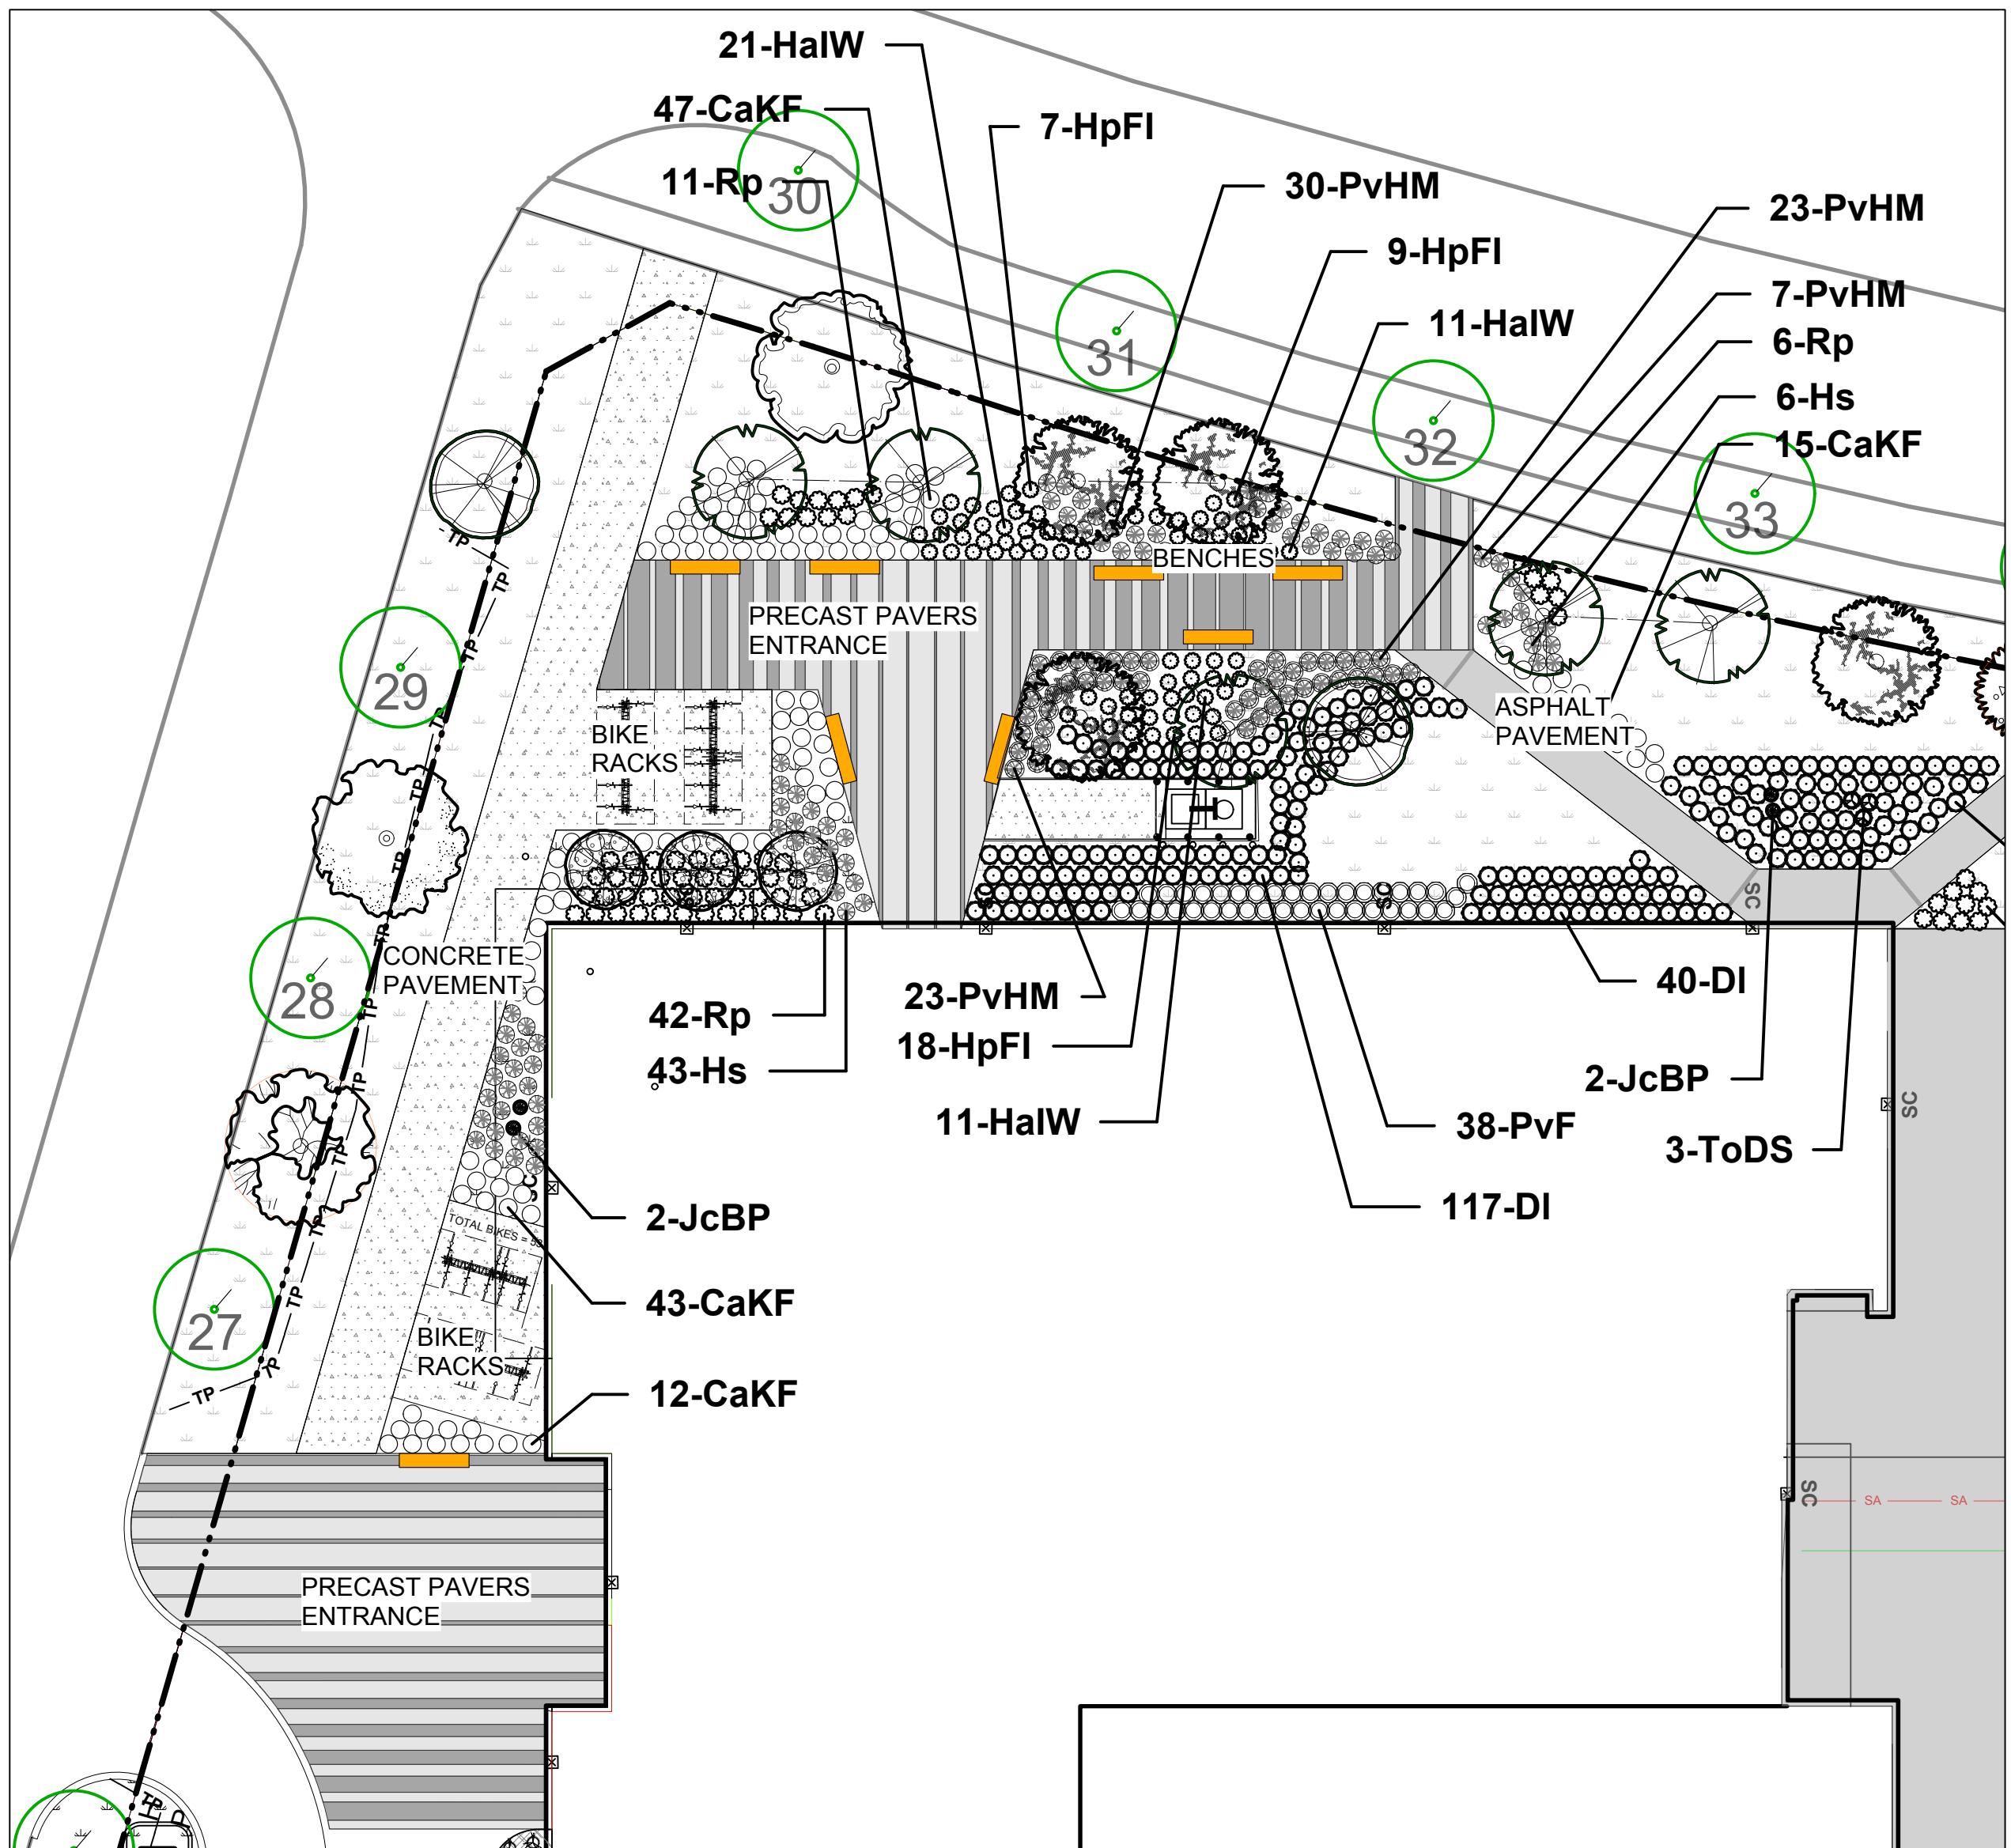
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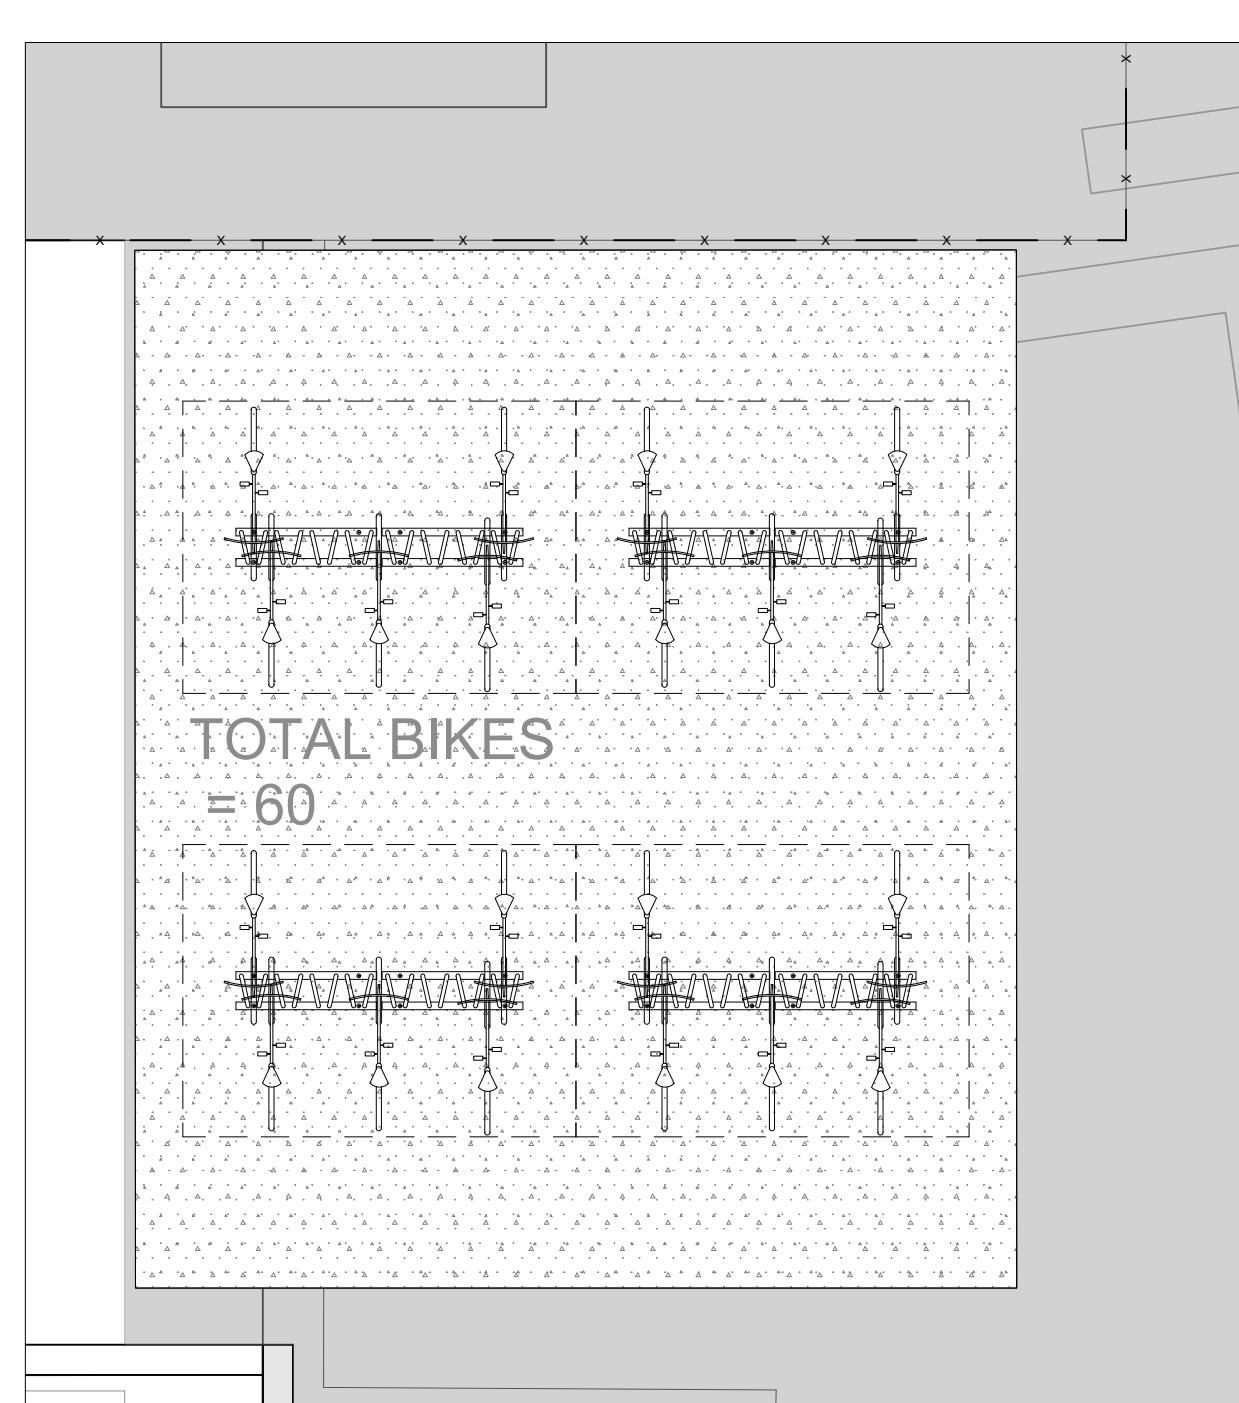
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date checked by M.R.  
project number N45 drawing number  
RA 24-1743  
CONTRACTOR TO VERIFY ALL DIMENSIONS AND NOTIFY THE ARCHITECT OF ANY DISCREPANCIES BEFORE WORK COMMENCES.  
revision  
DO NOT SCALE DRAWINGS

**L - 03**

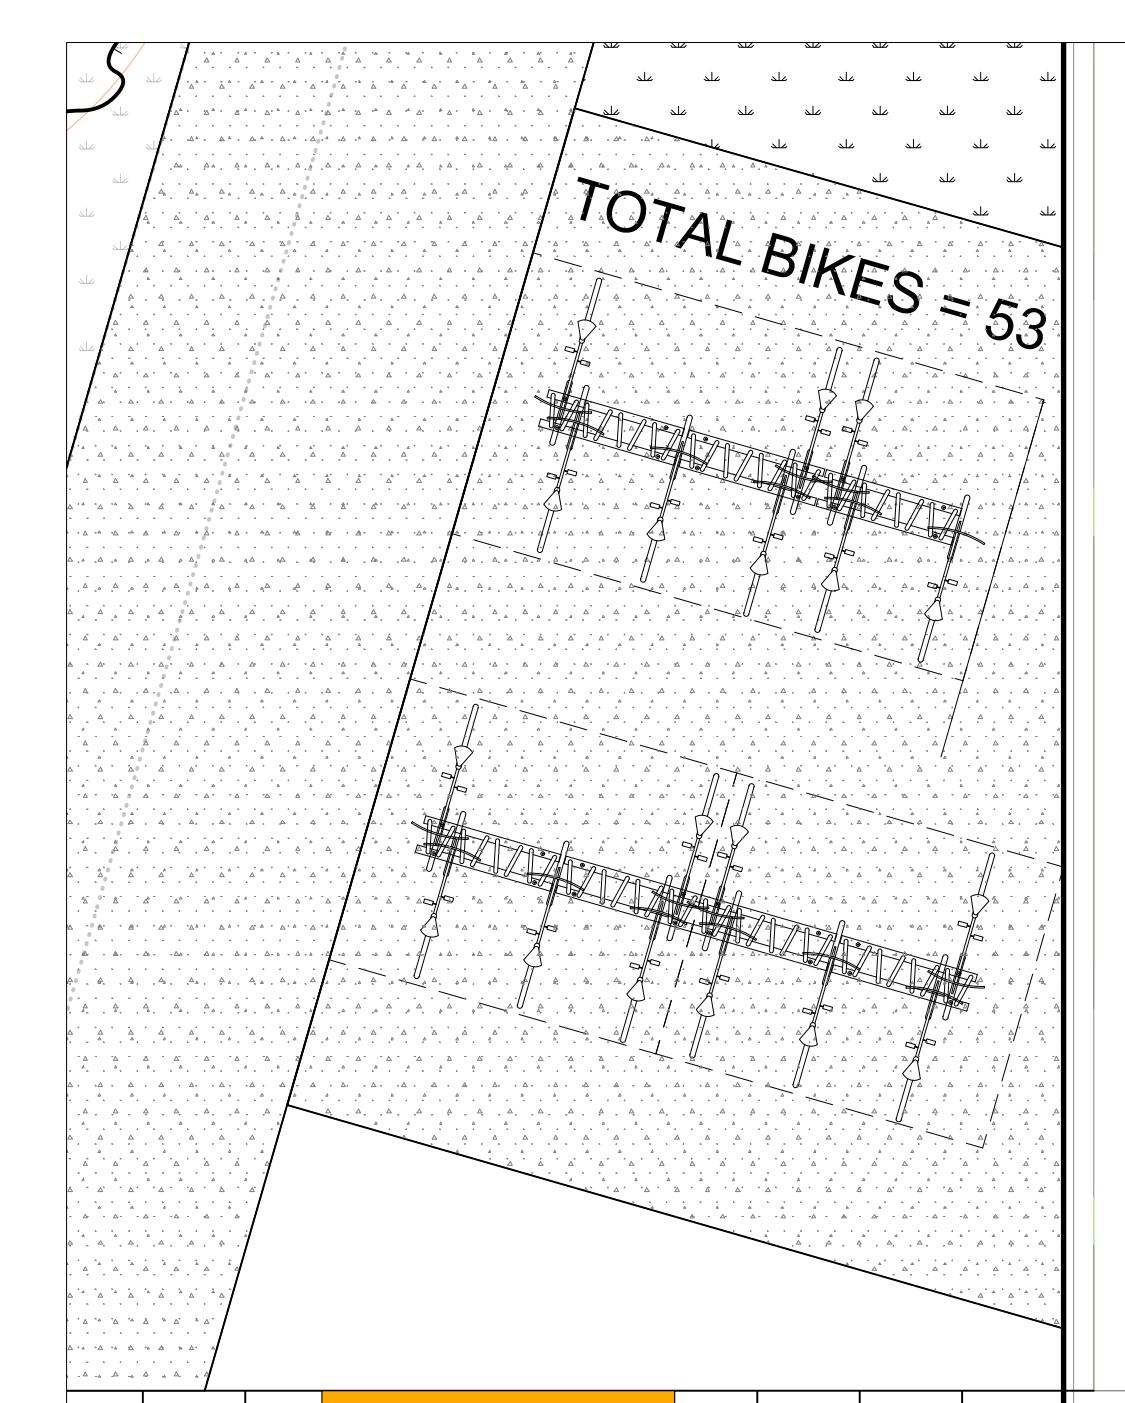
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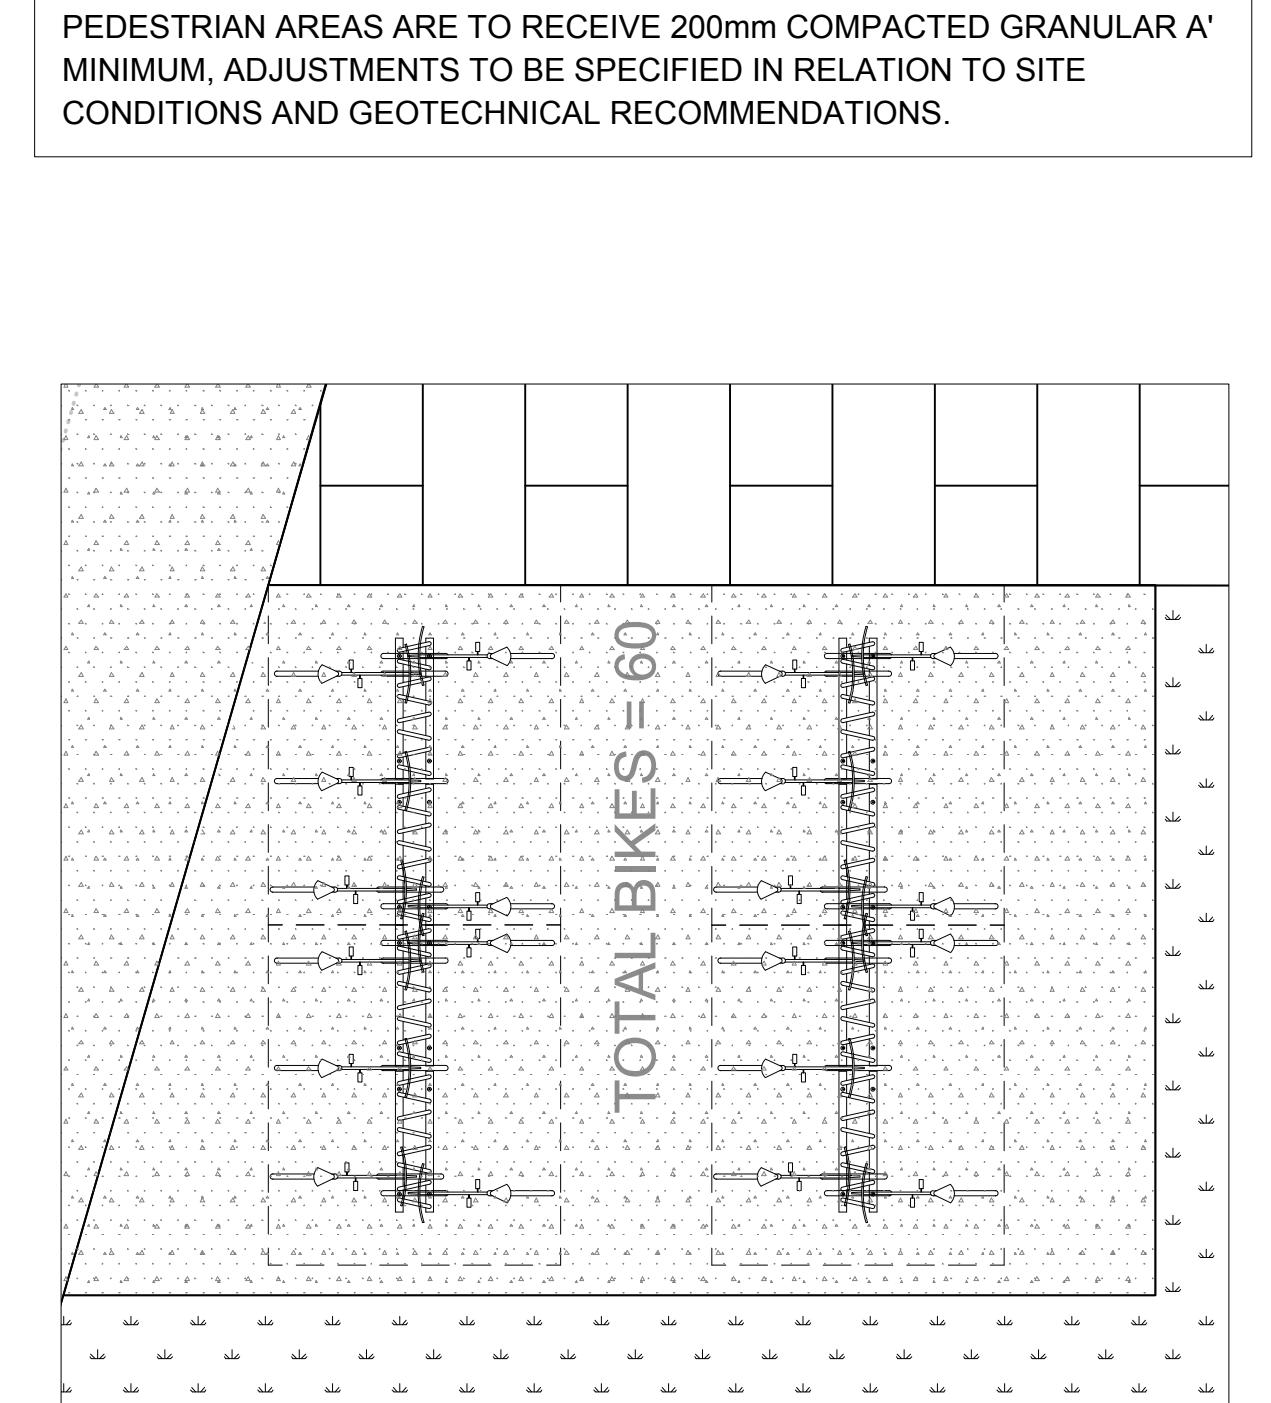
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L - 03 Scale: 1:300



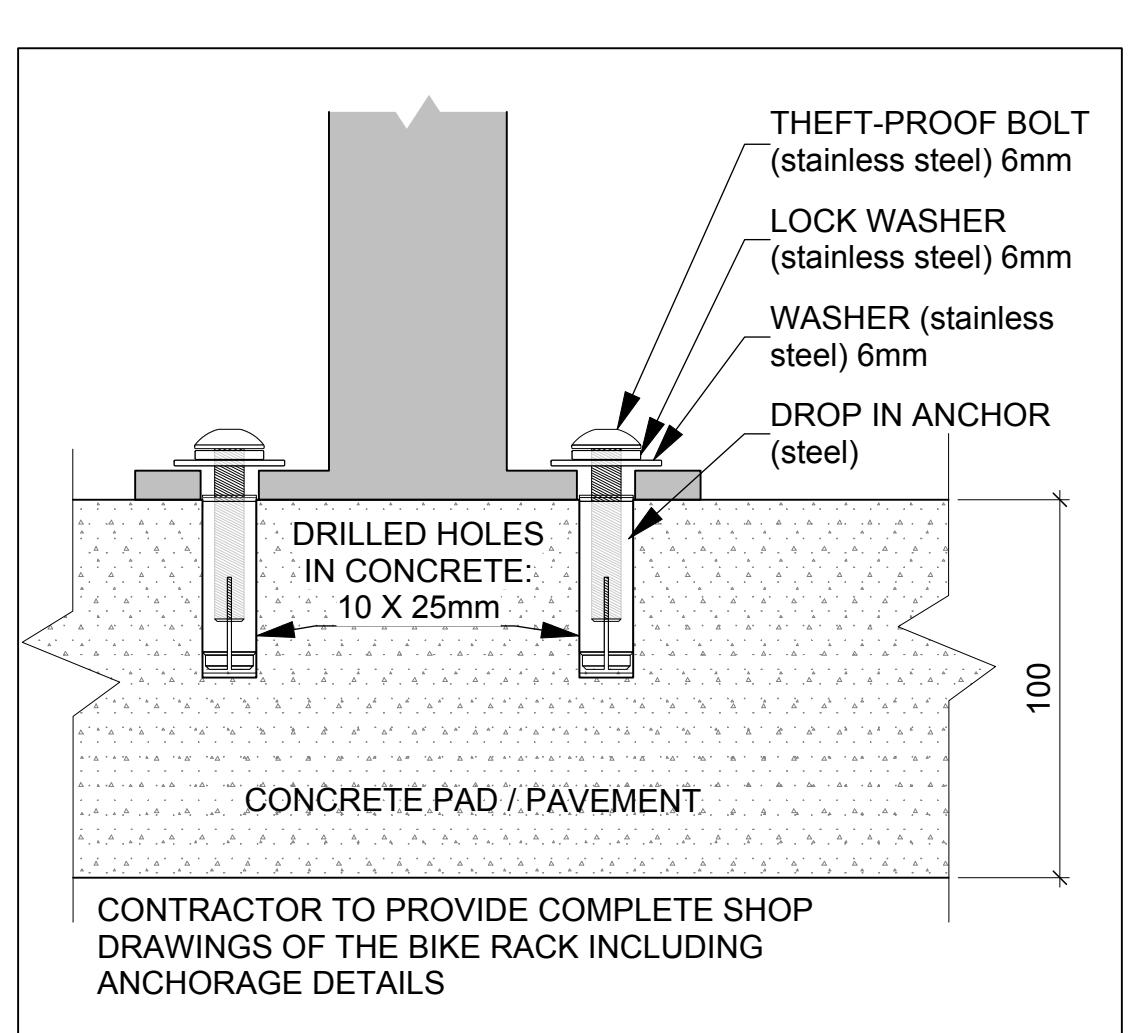
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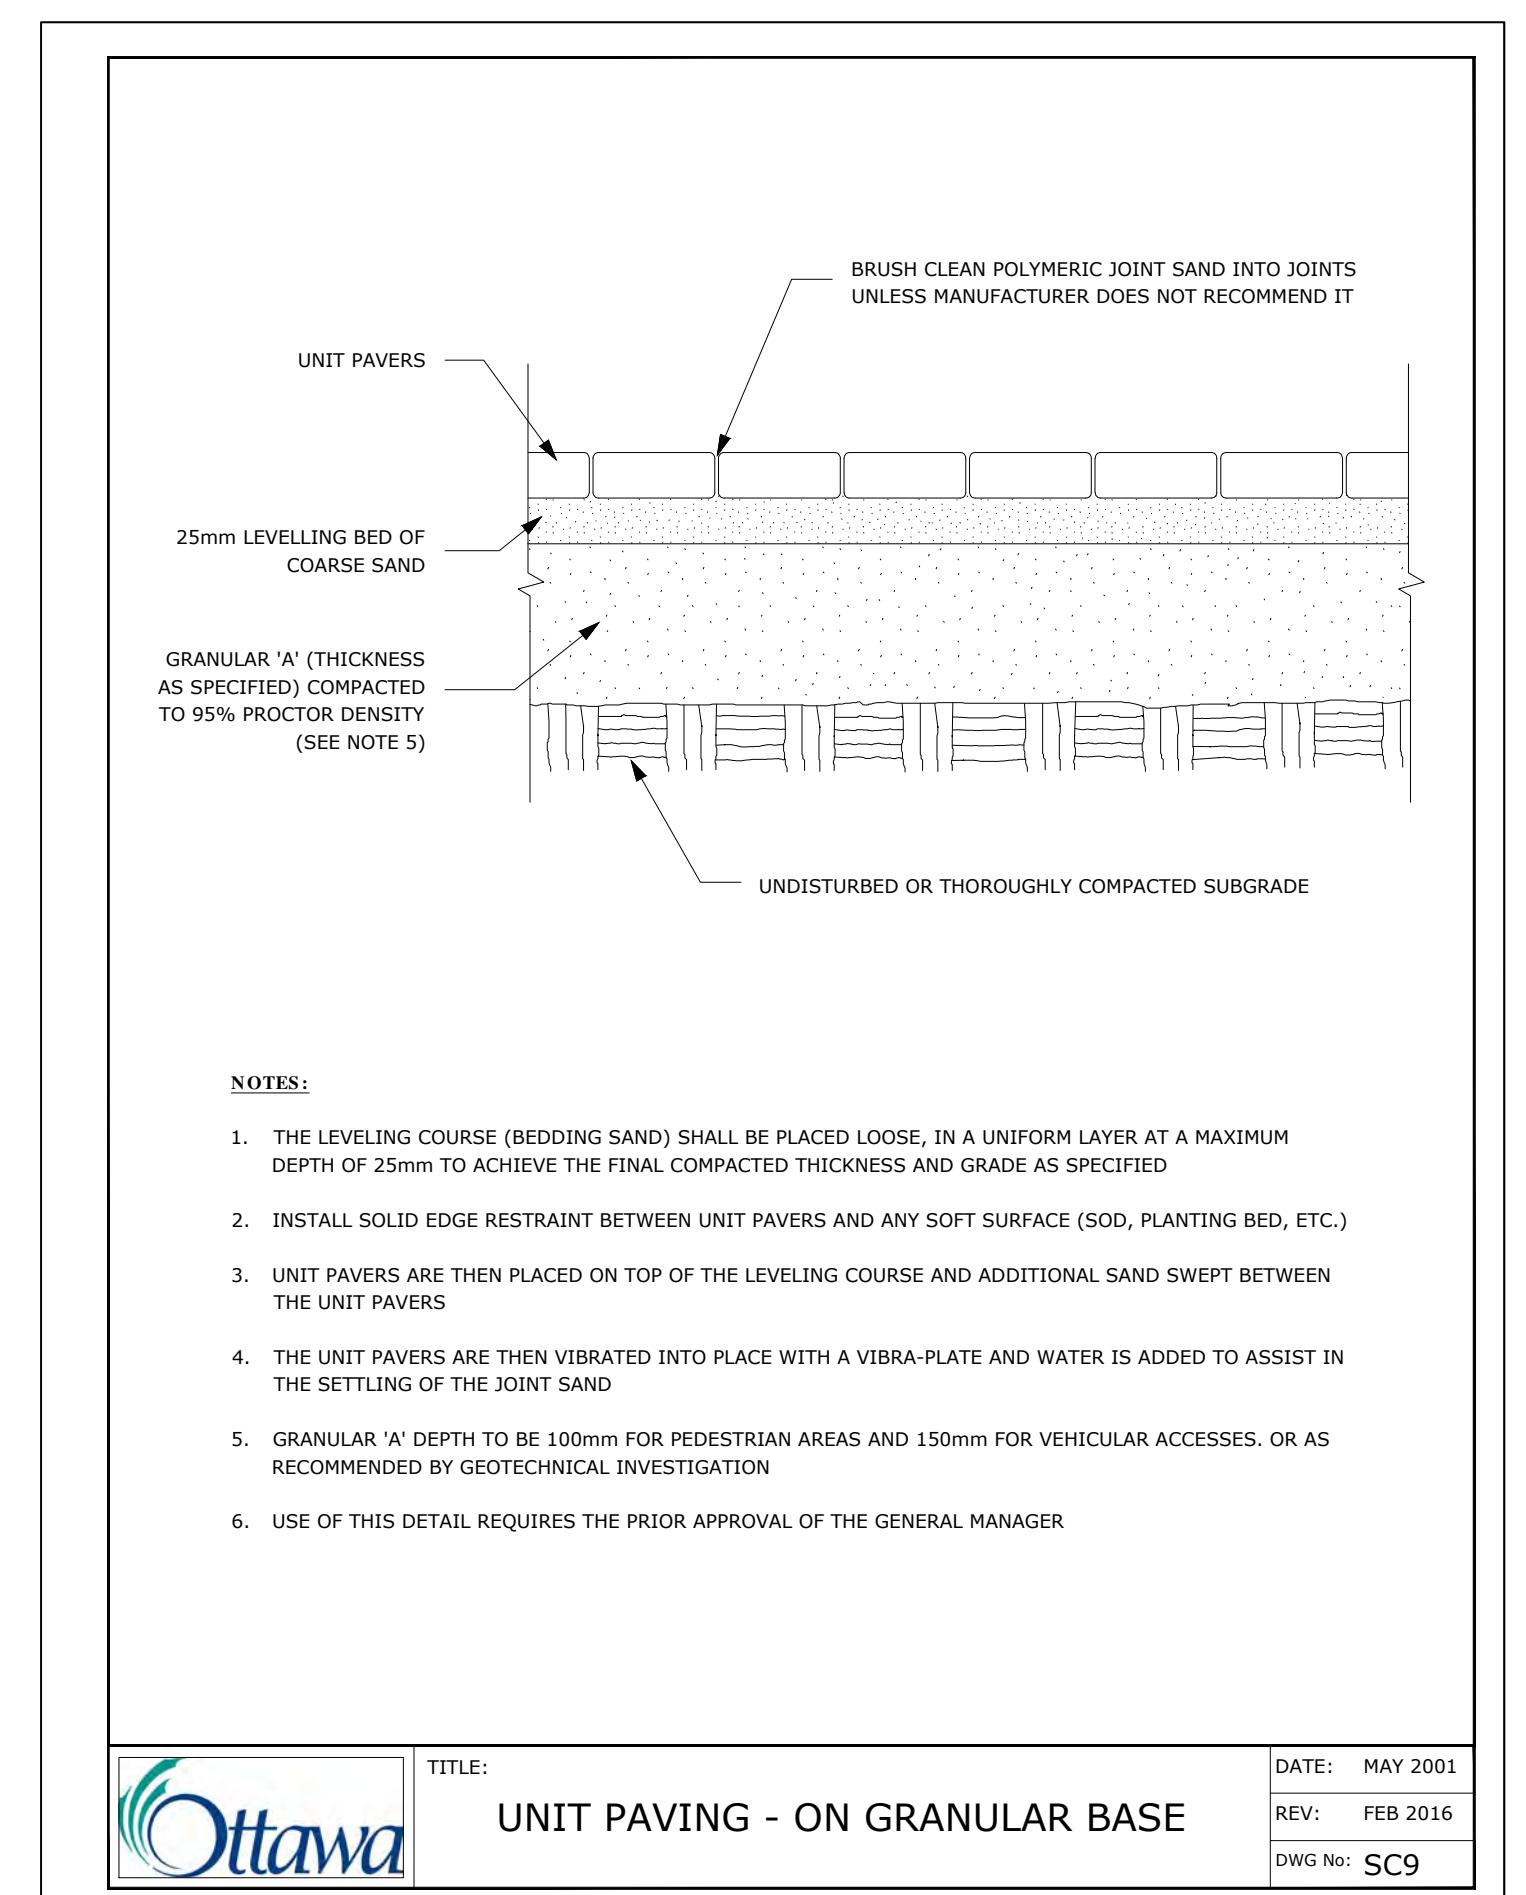
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L - 03 Scale: 1:75



4 ENLARGEMENT - BIKE RACK 3  
L - 03 Scale: 1:75



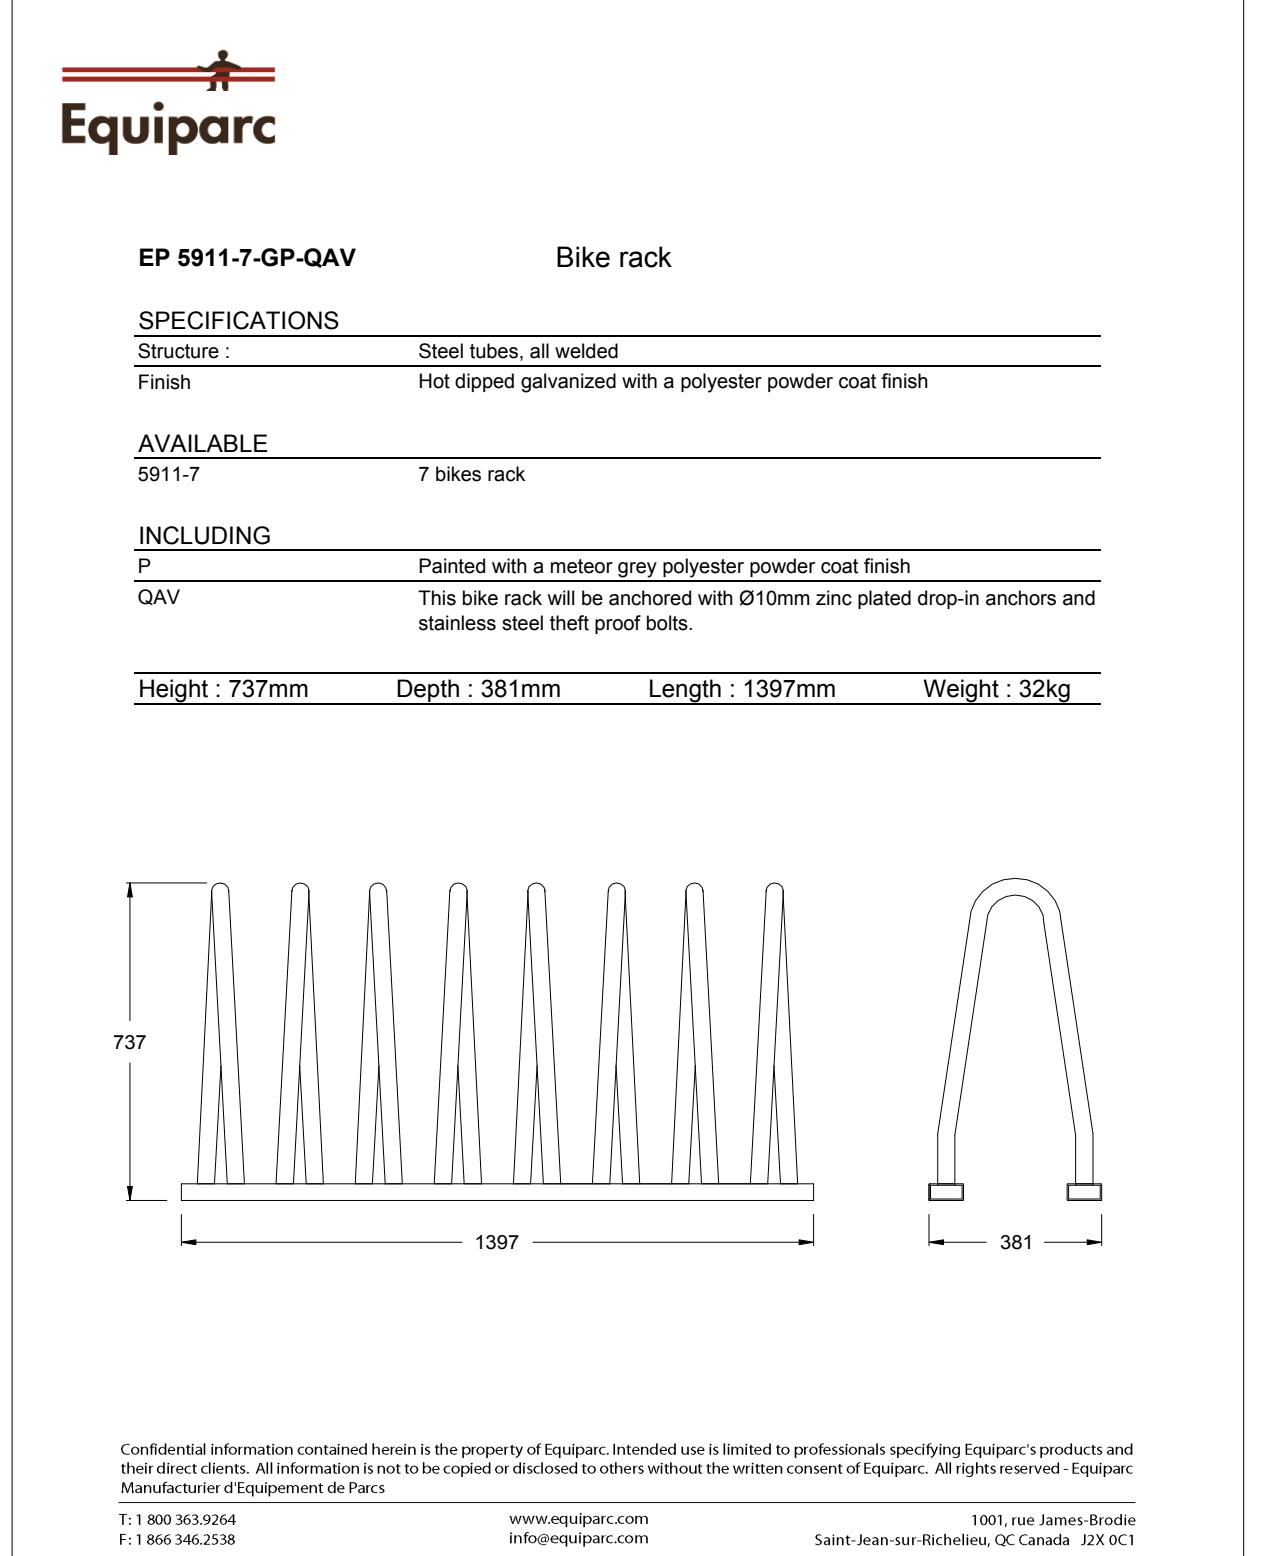
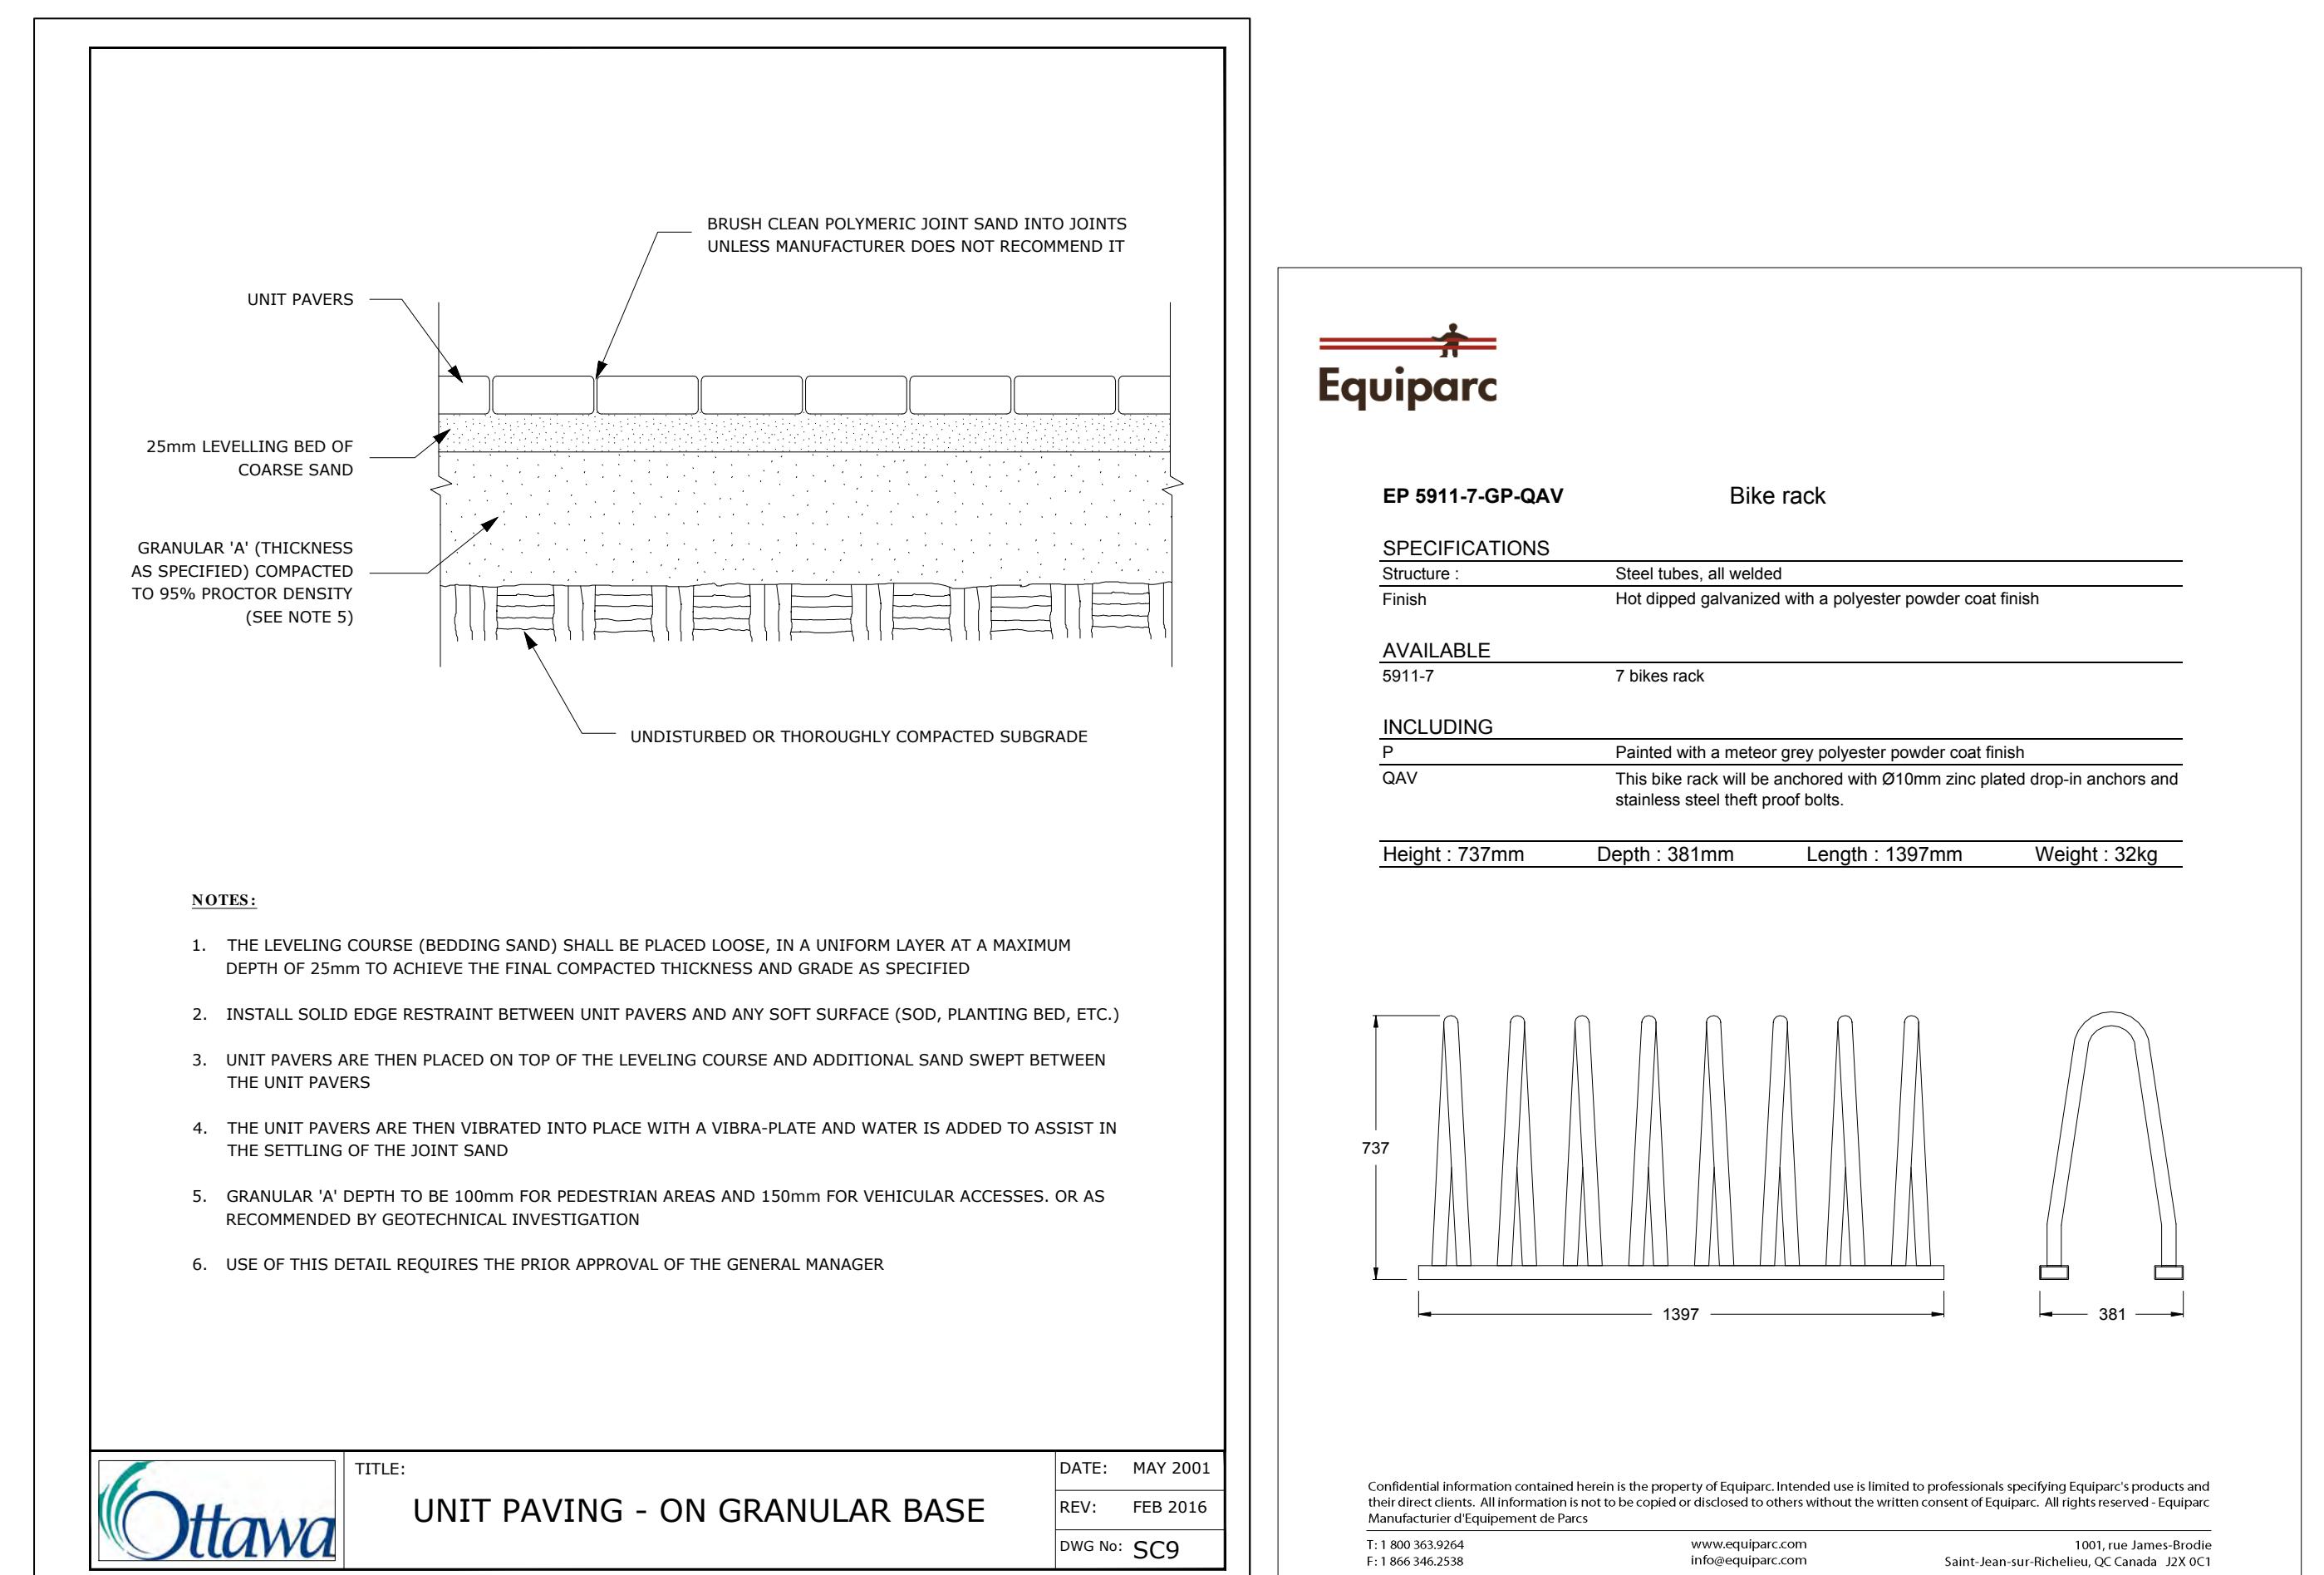
5 BIKE RACK ANCHORING  
L - 03 Scale: NTS



**ADDITIONAL NOTES :**  
PRECAST PAVERS IN VEHICULAR AREAS TO  
RECEIVE SAME BASE STRUCTURES FOR GRANULAR A' AND B'  
AS GEOTECHNICAL RECOMMENDATIONS FOR HEAVY DUTY PAVEMENT.  
PEDESTRIAN AREAS ARE TO RECEIVE 200mm COMPACTED GRANULAR A'  
MINIMUM, ADJUSTMENTS TO BE SPECIFIED IN RELATION TO SITE  
CONDITIONS AND GEOTECHNICAL RECOMMENDATIONS.

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