HEAFEY GROUP 768 SAINT-JOSEPH BLVD SUITE 100 GATINEAU QC J8Y 4B8









EAST RIDGE ORLEANS SUBDIVISION DRAWING LIST						
Sheet Number	Sheet Title					
LEGEND	LEGEND SHEET					
OS	OVERALL SERVICING					
S1	SITE SERVICING PLAN					
S2	SITE SERVICING PLAN					
01	PALEO DRIVE					
02	PALEO DRIVE					
03	ROSALIA STREET					
04	NAVAN ROAD					
05	GAS BAR EASEMENT					
06	STOMPIN' TOM LANE & EASEMET					
07	BRIAN COBURN BOULEVARD					
G1	GRADING PLAN					
POND	SPILL OVER POND					
DST	STORM DRAINAGE PLAN					
DSAN	SANITARY DRAINAGE PLAN					
SWM	PONDING PLAN					
ESC	EROSION AND SEDIMENT CONTROL					
D1	DETAILS AND CROSS SECTIONS					
D2	DETAILS AND CROSS SECTIONS					


EAST RIDGE ORLEANS SUBDIVISION

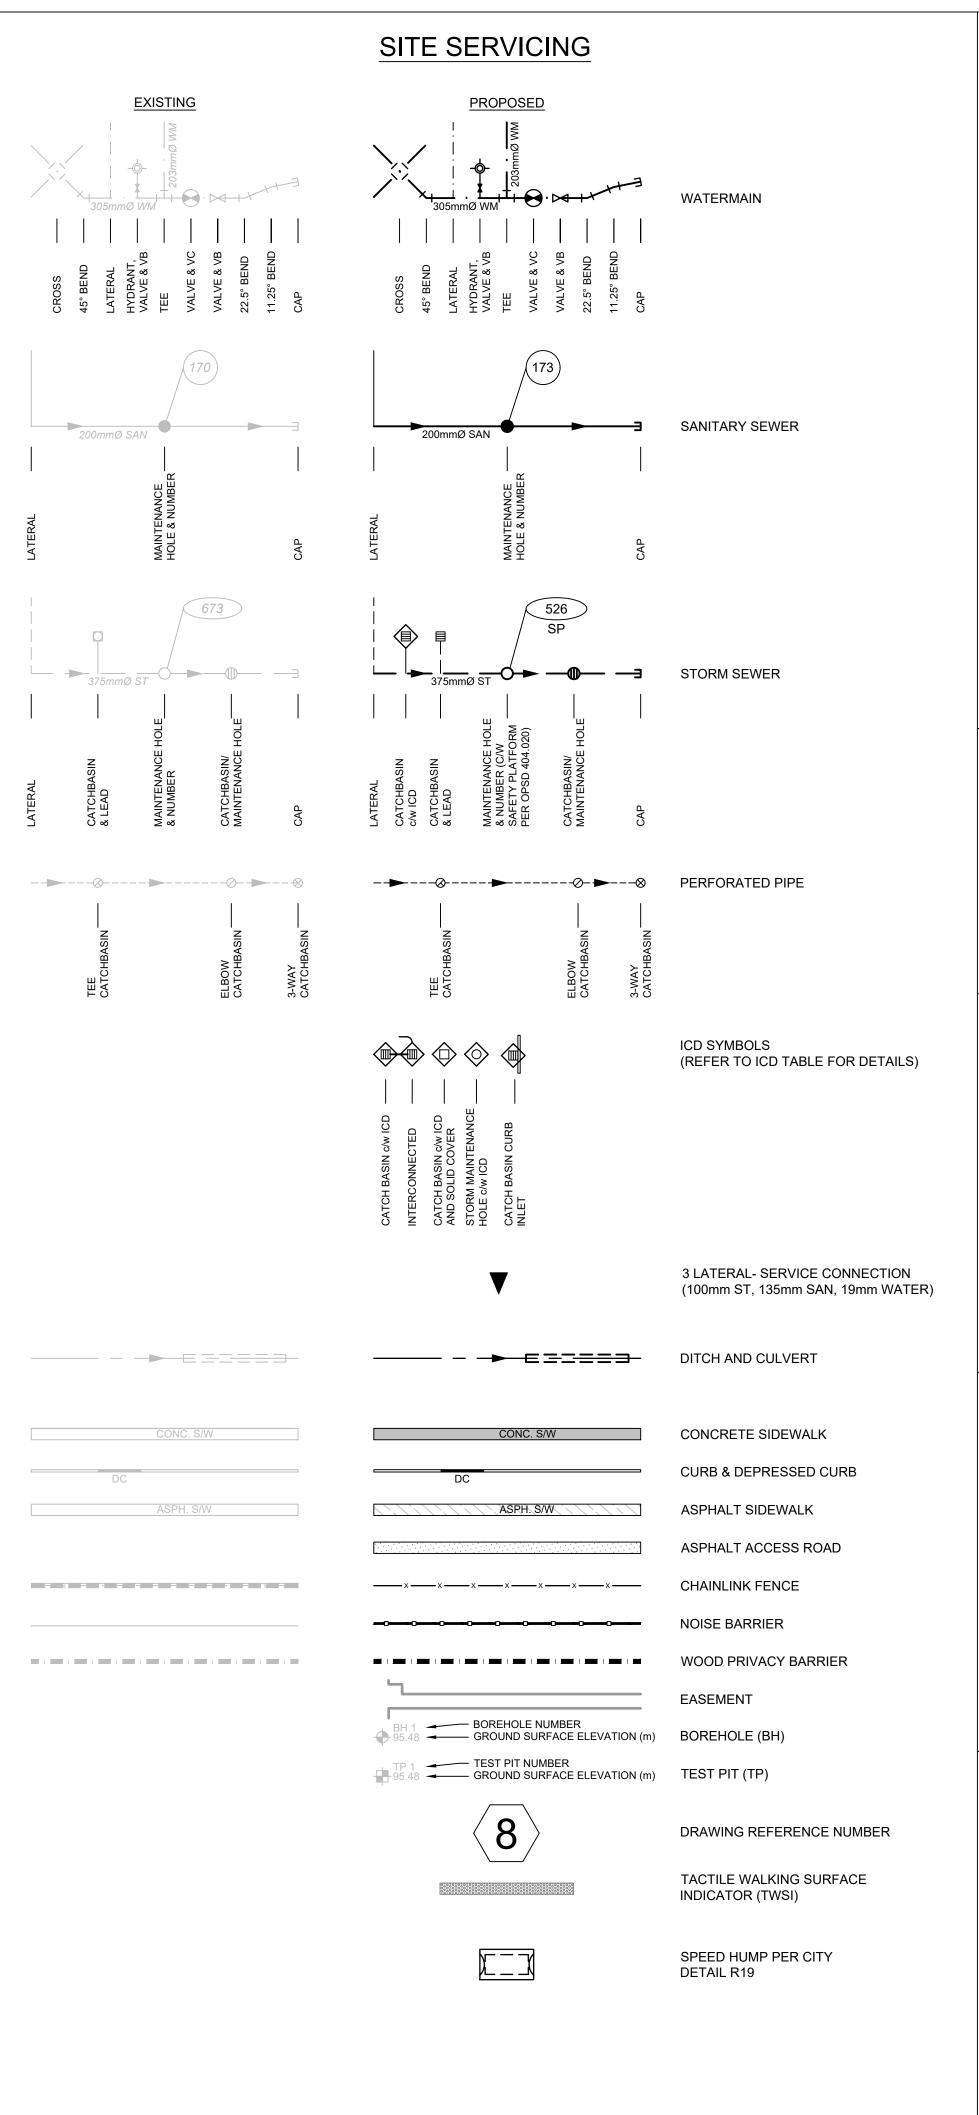


GRADING

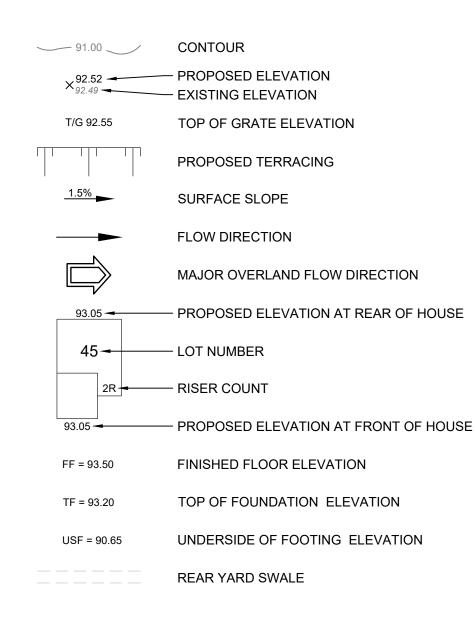


SANITARY DRAINAGE

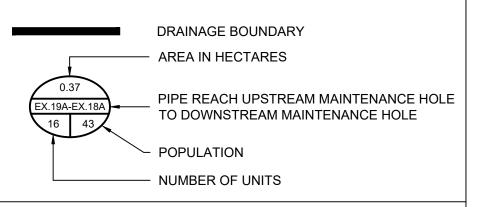


STORM DRAINAGE

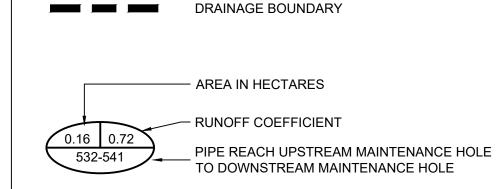

PONDING (URBAN)

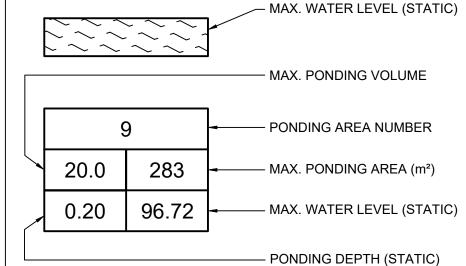

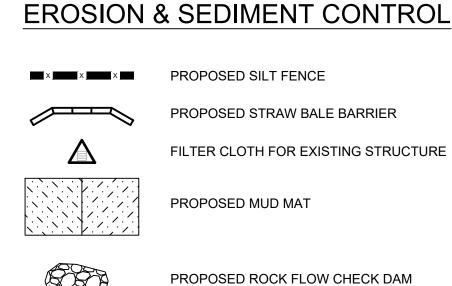

UTILITY

EXISTING	PROPOSED	
——— Н,В,С	——— H,B,C ———	JOINT UTILITY TRENCH (HYDRO, BELL, CABLE)
2H,1B,1C	2H,1B,1C	DENOTES NUMBER OF DUCTS
		CONCRETE ENCASED DUCT
SL	SL	STREET LIGHT CABLE
— G — G —	G G	NATURAL GAS LINE
		SERVICE ENTRANCE HYDRO, BELL, CABLE
	П	END WALL BOX
C	©	CABLE PEDESTAL
	©	CABLE GRADE LEVEL BOX
В	В	BELL PEDESTAL
B	B	BELL GRADE LEVEL BOX FOR SPLICING
BC	BC	BELL CENTRAL SPLITTING POINT
		HYDRO TRANSFORMER
		HYDRO SECTIONALIZER
H	Θ	HYDRO MAINTENANCE HOLE
+	+ []	HYDRO SWITCHING MAINTENANCE HOLE
HP	HP	HYDRO POLE
← HP	C HP ←	HYDRO POLE c/w GUY WIRE
SL	SL	STREET LIGHT CABINET
×—×	≍— ⊗ *	STREET LIGHT POLE & GROUND WIRE
;;;—⊗	⋈- ⊗	PATHWAY LIGHT
□-⊗	□-⊗	PARKING LIGHT
CMB	СМВ	COMMUNITY MAILBOX
BUS	BUS	BUS STOP LOCATION c/w ASPHALT BOULEVARD
*	lacksquare	TREE
	-	
		INERAL NOTES

GENERAL NOTES

- ALL MATERIALS, SERVICES AND CONSTRUCTION METHODS TO BE IN ACCORDANCE WITH THE CITY OF OTTAWA CURRENT STANDARDS AND SPECIFICATIONS.
- 2. ALL DIMENSIONS SHOWN ON PLANS ARE IN METRES UNLESS OTHERWISE NOTED.
- 3 DRAWINGS TO BE READ IN CONJUNCTION WITH:
- 3.1. UPDATED GEOTECHNICAL INVESTIGATION PROPOSED RESIDENTIAL DEVELOPMENT 2983, 3053 AND 3079 NAVAN ROAD OTTAWA, ONTARIO (DATED SEPTEMBER 13, 2024).
- 3.2. GEOTECHNICAL INVESTIGATION NAVAN ROAD SUBDIVISION OFF-SITE SERVICING NAVAN ROAD AND BRIAN COBURN BOULEVARD OTTAWA ONTARIO (DATED SEPTEMBER 16, 2024)
- 3.3. LANDSLIDE HAZARD AND RISK ASSESSMENT REVISION 1, PROPOSED RESIDENTIAL DEVELOPMENT 2983, 3053 AND 3079 NAVAN ROAD OTTAWA, ONTARIO PREPARED BY PATERSON GROUP INC. (DATED JULY 4, 2024); AND
- 3.4. SITE SERVICING REPORT REVISION 3, EAST RIDGE ORLEANS SUBDIVISION, 2983, 3053 AND 3079 NAVAN ROAD & 2690 PAGÉ ROAD, OTTAWA, ONTARIO, PREPARED BY JLR (DATED SEPTEMBER 20, 2024).
- 4. UNLESS OTHERWISE NOTED, DIMENSIONS FROM STREET LINE ARE TO THE CENTRELINE OF SEWER OR MAINTENANCE
- . THE INSIDE DIAMETER OF PIPES ARE REFERRED TO IN PLAN VIEW AND THE OUTSIDE DIAMETER OF PIPES ARE DRAWN IN PROFILE VIEW.
- . THE CONTRACTOR IS RESPONSIBLE TO DETERMINE THE EXACT LOCATION, SIZE, MATERIAL AND ELEVATION OF ALL SERVICES AND UTILITIES PRIOR TO CONSTRUCTION AND SHALL PROTECT AND ASSURE RESPONSIBILITY FOR ALL UTILITIES WHETHER OR NOT SHOWN ON THIS DRAWING.
- . THE CONTRACTOR SHALL BE RESPONSIBLE FOR ALL EXCAVATION, BACKFILL, REINSTATEMENT OF ALL AREAS DISTURBED DURING CONSTRUCTION AND ALL ASSOCIATED WORKS TO THE SATISFACTION OF THE ENGINEER AND THE CITY OF
- 3. THE CONTRACTOR SHALL BE RESPONSIBLE TO DETERMINE, VIA EXCAVATION, THE EXACT LOCATION AND ELEVATION OF THE EXISTING WATERMAINS. SEWERS AND UNDERGROUND STRUCTURES AS REQUIRED FOR ALL CONNECTIONS.
- EXCAVATION FOR THE INSTALLATION OF SERVICES ALONG OR IN PROXIMITY OF A BUILDING OR A STRUCTURE TO BE CONTAINED WITHIN A TRENCH BOX WIDTH AND ENSURE NO CONFLICT WITH ANY FUTURE FOOTINGS. SELECT SUBGRADE MATERIAL, COMPACTED TO 100% SPMDD TO 1.0m BELOW EXISTING GRADE FOR FULL TRENCH WIDTH OF DISTURBED AREA SHALL BE USED FOR BACKFILL, INCLUDING ALONG ANY SEWERS AND WATERMAINS ADJACENT TO A BUILDING OR
- 10. ANY SERVICE LATERAL REQUIRED IN THE DRIVEWAY MUST BE SLEEVED THROUGH UNDER THE GARAGE FLOOR AREA. 11. A DETAILED CONSTRUCTION AND CONTINGENCY PLAN IS REQUIRED TO BE DEVELOPED BEFORE ANY SEWER WORK IS TO
- 12. UTILITY BOXES (I.E. PEDESTALS, TRANSFORMERS, ETC.) ARE TO BE INSTALLED IN ACCORDANCE WITH THE LATEST

EDITION OF THE CITY OF OTTAWA GUIDELINES "GUIDELINES FOR UTILITY PEDESTALS WITH IN THE RIGHT-OF-WAY".

- 13. $\,$ CLAY SEALS TO BE AS PER CITY OF OTTAWA DETAIL S8 & THE GEOTECHNICAL INVESTIGATION REPORTS PREPARED BY EXP FOR THIS PROJECT DATED SEPTEMBER 13 2024.
- 14. CLAY SEALS IN THE REAR YARD ARE TO BE PLACED TO THE UNDERSIDE OF THE TOPSOIL LAYER.

WATERMAIN NOTES

- 15. EXISTING WATERMAIN INFORMATION SHOWN ON PLANS IS BASED ON BEST CURRENT INFORMATION. CONTRACTOR TO VERIFY EXACT LOCATION OF WATERMAIN AND APPURTENANCES. REPORT ANY DISCREPANCIES TO ENGINEER.
- 16. EXCAVATION, INSTALLATION, BACKFILL AND RESTORATION OF ALL WATERMAINS BY CONTRACTOR. NO WATERMAIN SITE WORK IS TO COMMENCE UNLESS THE CITY OF OTTAWA WATER WORKS INSPECTOR AND/OR CONSULTANT ARE PRESENT ON SITE TO WITNESS WORK.
 - 17. WATERMAIN AND WATER SERVICE TO HAVE A MINIMUM OF 2.4 METERS OF COVER. INSULATION TO BE PROVIDED WHERE MINIMUM COVER CANNOT BE ACHIEVED AS PER CITY STANDARD W22 AND WHERE WHERE WATERMAIN IS IN PROXIMITY TO OPEN STRUCTURES AS PER CITY OF OTTAWA STANDARD W23. WATERMAIN TO BE INSTALLED TO DEPTHS SHOWN ON
- 18. WATER SERVICES TO BE EXTENDED WITH A CONTINUOUS PEX SECTION PAST THE STAND POST AND LEFT COILED 3.0m
- 19. ALL CURB STOPS TO BE LOCATED ON THE PROPERTY LINE UNLESS OTHERWISE NOTED. CURB STOP TO BE STAINLESS
- 20. WATERMAIN THRUST BLOCKS TO BE CONSTRUCTED PER CITY OF OTTAWA DETAILS W25.3 AND W25.4. THRUST BLOCKS ARE REQUIRED AT ALL BENDS, TEES, PLUGS, DEAD END CAPS, VALVES, REDUCERS OR OTHER FITTINGS WHERE CHANGES OCCUR IN PIPE DIAMETER OR DIRECTION ALL IN ACCORDANCE WITH CURRENT CITY OF OTTAWA STANDARDS AND SPECIFICATIONS.
- 21. 19mm WATER SERVICE FOR BLOCK 1 WEST END UNIT SHALL BEND WITHIN THE ROW TO CONNECT DIRECTLY TO THE 150mm WATERMAIN ON STOMPIN' TOM LANE.

STORM SEWER NOTES

- 22. STORM SEWERS TO BE REINFORCED CONCRETE, PVC, OR CITY APPROVED EQUIVALENT.
- 23. STORM SEWERS WITHIN ROADWAY WITH LESS THAN 2.0m COVER SHALL BE INSULATED PER CITY OF OTTAWA DETAIL S35. 24. STORM MAINTENANCE HOLES TO BE PRECAST CONCRETE IN ACCORDANCE WITH ONTARIO PROVINCIAL STANDARD
- DRAWINGS (OPSD).
- 25. ALL STORM MAINTENANCE HOLES SHALL HAVE WATERTIGHT GASKETS AND SHALL HAVE BLUE SKIN MEMBRANE UP TO FIRST JOINT ABOVE THE SEASONAL HIGH GROUNDWATER ELEVATION.
- 26. ALL STORM MAINTENANCE HOLES ARE TO HAVE EXTENDED BASE PER DETAIL PROVIDED ON D1- DETAILS. 27. STORM CATCH BASIN STRUCTURES TO BE 600mm x 600mm PRECAST CONCRETE OR APPROVED EQUIVALENT C/W 600mm

CATCH BASINS TO BE BOSS 2000 MANUFACTURED BY ARMTEC OR APPROVED EQUIVALENT.

SERVICES TO BE EXTENDED 3.0m PAST THE PROPERTY LINE FOR RESIDENCES.

- DEEP SUMP AND FRAME AND COVER PER CITY OF OTTAWA DETAIL S19; UNLESS OTHERWISE NOTED.
- 28. CBMH's PER CITY OF OTTAWA DETAIL S29 SHALL HAVE SOLID FRAME AND COVER PER CITY OF OTTAWA DETAIL S19. 29. REAR YARD CATCH BASIN TEES AND ELBOWS AS PER CITY OF OTTAWA DETAIL DRAWING \$30 AND \$31, 3-WAY REAR YARD
- 30. STREET CATCH BASIN LEADS TO BE INSTALLED WITH 1% GRADIENT MINIMUM, UNLESS SPECIFIED OTHERWISE ON THE
- 31. STORM SERVICES TO BE EXTENDED 1.0m PAST THE PROPERTY LINE FOR FUTURE BLOCKS 14, 15, 16, AND 17. STORM
- 32. 6m SUBDRAIN STUBS, WRAPPED IN FILTER SOCK, TO BE INSTALLED ON EITHER SIDE OF STREET CATCH BASINS LOCATED IN A ROADWAY SAGS AND ON THE HIGH SIDE ONLY (ie. THE UPSTREAM SIDE) FOR STREET CATCH BASINS NOT LOCATED IN
- 33. INLET CONTROL DEVICES TO BE VERTICAL SLIDING TYPE FOR REMOVAL AND CLEANING AS PER CITY OF OTTAWA

SANITARY SEWER NOTES

- 34. SANITARY SEWERS TO BE PVC DR-35.
- 35. SANITARY SERVICES TO BE EXTENDED 1.0m PAST THE PROPERTY LINE FOR FUTURE BLOCKS 14, 15, 16, AND 17. SANITARY SERVICES TO BE EXTENDED 3.0m PAST THE PROPERTY LINE FOR RESIDENCES.
- 36. SANITARY MAINTENANCE HOLES TO BE PRECAST CONCRETE IN ACCORDANCE WITH ONTARIO PROVINCIAL STANDARD DRAWINGS (OPSD). ALL SANITARY MAINTENANCE HOLE COVERS TO BE PER CITY OF OTTAWA DETAIL S24.
- 37. ALL SANITARY MAINTENANCE HOLES SHALL HAVE WATERTIGHT GASKETS AND SHALL HAVE BLUE SKIN MEMBRANE UP TO
- 38. ALL SANITARY MAINTENANCE HOLES ARE TO HAVE EXTENDED BASE PER DETAIL PROVIDED ON D1-DETAILS.

FIRST JOINT ABOVE SEASONAL HIGH GROUNDWATER ELEVATION.

39. CONTRACTOR TO INSTALL TEMPORARY INLET CONTROL DEVICES (ICDs) IN SANITARY MAINTENANCE HOLE 01 ON NAVAN ROAD c/w 48mm ORIFICE DIAMETER. THE ICD SHALL BE INSTALLED AND OPERABLE AT THE ONSET OF SEWER CONSTRUCTION AND SHALL REMAIN IN PLACE UNTIL WRITTEN NOTIFICATION BY THE ENGINEER TO BE REMOVED. REFER TO DRAWING D1 FOR TEMPORARY ICD DETAIL.

GRADING NOTES:

- 40. MATCH EXISTING ELEVATIONS AT ALL EXTERIOR PROPERTY LINES OR AS SHOWN. ENSURE POSITIVE DRAINAGE TOWARD A SUITABLE OUTLET WHETHER INDICATED OR NOT.
- 41. UNDERSIDE OF FOOTING, TOP OF FOUNDATIONS AND FINISHED FLOOR ELEVATIONS HAVE BEEN SET FOR GRADING DRAINAGE PURPOSES ONLY. BUILDERS SHOULD CONSULT THE GEOTECHNICAL REPORT PREPARED FOR THIS SUBDIVISION PRIOR TO CONSTRUCTION. BUILDERS SHOULD OBTAIN A SUBGRADE INSPECTION REPORT FROM A QUALIFIED GEOTECHNICAL ENGINEER PRIOR TO CONCRETE PLACEMENT.
- 42. ROADWAY SUBGRADE SHALL BE INSPECTED BY A QUALIFIED GEOTECHNICAL ENGINEER PRIOR TO PLACEMENT OF GRANULARS, ABOVE WOVEN GEOTEXTILE (IF REQUIRED). ROADWAY MATERIAL AND COMPACTION INSPECTION TO BE CARRIED OUT BY A QUALIFIED GEOTECHNICAL ENGINEER AS REQUIRED BY THE MUNICIPALITY.
- 43. ROAD STRUCTURE SHALL BE CONSTRUCTED IN ACCORDANCE WITH THE GEOTECHNICAL REPORT PREPARED FOR THIS SUBDIVISION AT MINIMUM:

LOCAL ROADS: - 50mm WEAR COURSE - SP 12.5

- 60mm BINDER COURSE - SP 19.0

- 50mm BASE - OPSS GRANULAR 'A' CRUSHED STONE COMPACTED TO 100% SPMDD - 600mm - OPSS GRANULAR 'B' TYPE II COMPACTED TO 100% SPMDD

SUBGRADE - IN SITU SOIL AND/OR WELL COMPACTED INORGANIC EXISTING FILL AND/OR NATIVE TRENCH FILL MATERIALS. ALI GEOTECHNICAL RECOMMENDATIONS TO BE CONFIRMED ON SITE BY GEOTECHNICAL ENGINEER.


- 44. AT ALL CONNECTION POINTS REINSTATE SURFACES TO EXISTING CONDITION OR BETTER: ASPHALT RESTORATION SHALL BE IN ACCORDANCE WITH CITY OF OTTAWA STANDARD DRAWING R10
- PAVEMENT STRUCTURE, ie. THICKNESS OF GRANULARS AND ASPHALT LAYERS SHALL MATCH EXISTING - BOULEVARDS SHALL BE REINSTATED WITH 100mm TOP SOIL AND SOD

45. CURBS TO BE:

- BARRIER TYPE PER CITY OF OTTAWA STANDARD SC1.1. ALL CURBS TO BE BARRIER TYPE
- EXCEPT WEST SIDE OF PALEO STREET FROM STA. 0+180 TO STA. 0+332 - EXCEPT WEST SIDE OF ROSALIA STREET FROM STA. 1+112 TO STA. 1+190 - EXCEPT EAST SIDE OF ROSALIA STREET FROM STA. 1+100 TO STA. 1+215
- MOUNTABLE TYPE PER CITY OF OTTAWA STANDARD SC1.3.
- WEST SIDE OF PALEO STREET FROM STA. 0+180 TO STA. 0+332 WEST SIDE OF ROSALIA STREET FROM STA. 1+112 TO STA. 1+190 - EAST SIDE OF ROSALIA STREET FROM STA. 1+100 TO STA. 1+215
- 46. ALL SIDEWALKS AND CURB RAMPS TO BE CONSTRUCTED IN ACCORDANCE WITH CITY OF OTTAWA STANDARDS SC6, SC7,
- 47. ALL STREETS TO HAVE A CROSS-SECTIONAL SLOPE OF 3.0%

EROSION AND SEDIMENT CONTROL NOTES:

48. DURING CONSTRUCTION ACTIVITIES APPROPRIATE EROSION AND SEDIMENT CONTROL MEASURES, AS OUTLINED IN MNR'S "GUIDELINES ON EROSION AND SEDIMENT CONTROL FOR URBAN CONSTRUCTION SITES", SHALL BE IMPLEMENTED TO TRAP SEDIMENT ON-SITE. (REFER TO EROSION & SEDIMENT CONTROL PLAN, DRAWING ESC.)

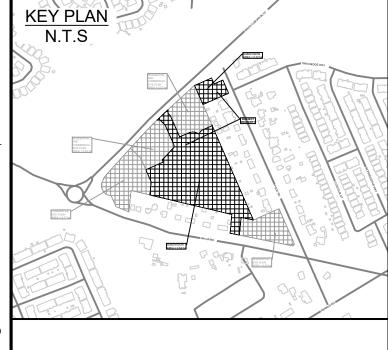

06	RE-ISSUED TO CITY FOR ENGINEERING REVIEW (THIRD RE-SUBMISSION)	20/09/24
05	RE-ISSUED TO CITY FOR ENGINEERING REVIEW (THIRD SUBMISSION)	27/08/24
04	RE-ISSUED FOR MUNICIPAL CONSENT	04/03/24
03	RE-ISSUED TO CITY FOR ENGINEERING REVIEW (SECOND SUBMISSION)	16/02/24
02	ISSUED FOR MUNICIPAL CONSENT	09/02/24
01	ISSUED TO CITY FOR ENGINEERING REVIEW	22/09/23
No.	ISSUE / REVISION	DD/MM/YY

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VERIFY SHEET SIZE AND SCALES. THE BAR TO

PROJECT NORTH


EAST RIDGE ORLEANS **SUBDIVISION**


2983, 3053, & 3079 NAVAN ROAD & 2690 PAGE ROAD OTTAWA, ONTARIO


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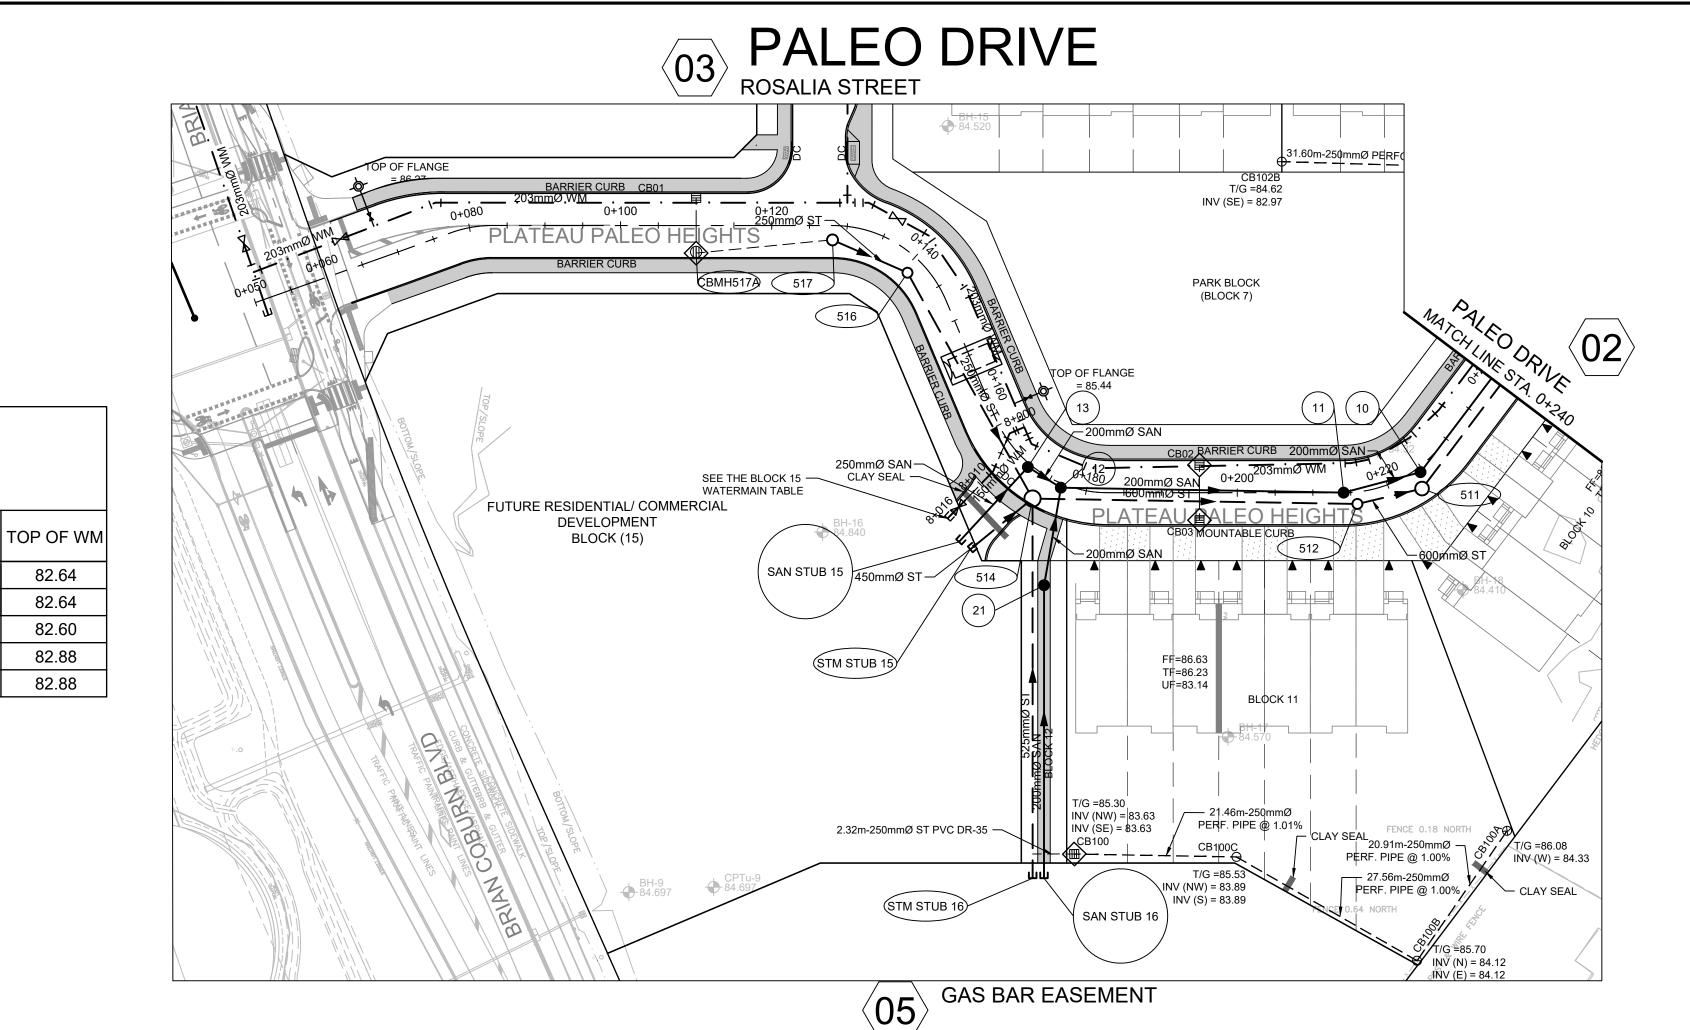
LEGEND SHEET


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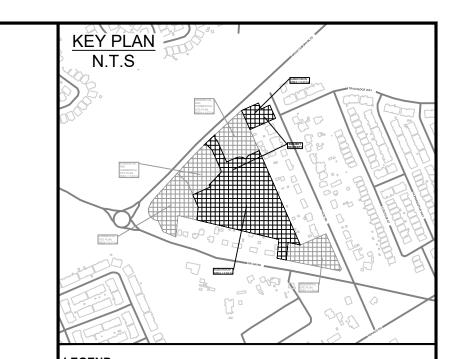




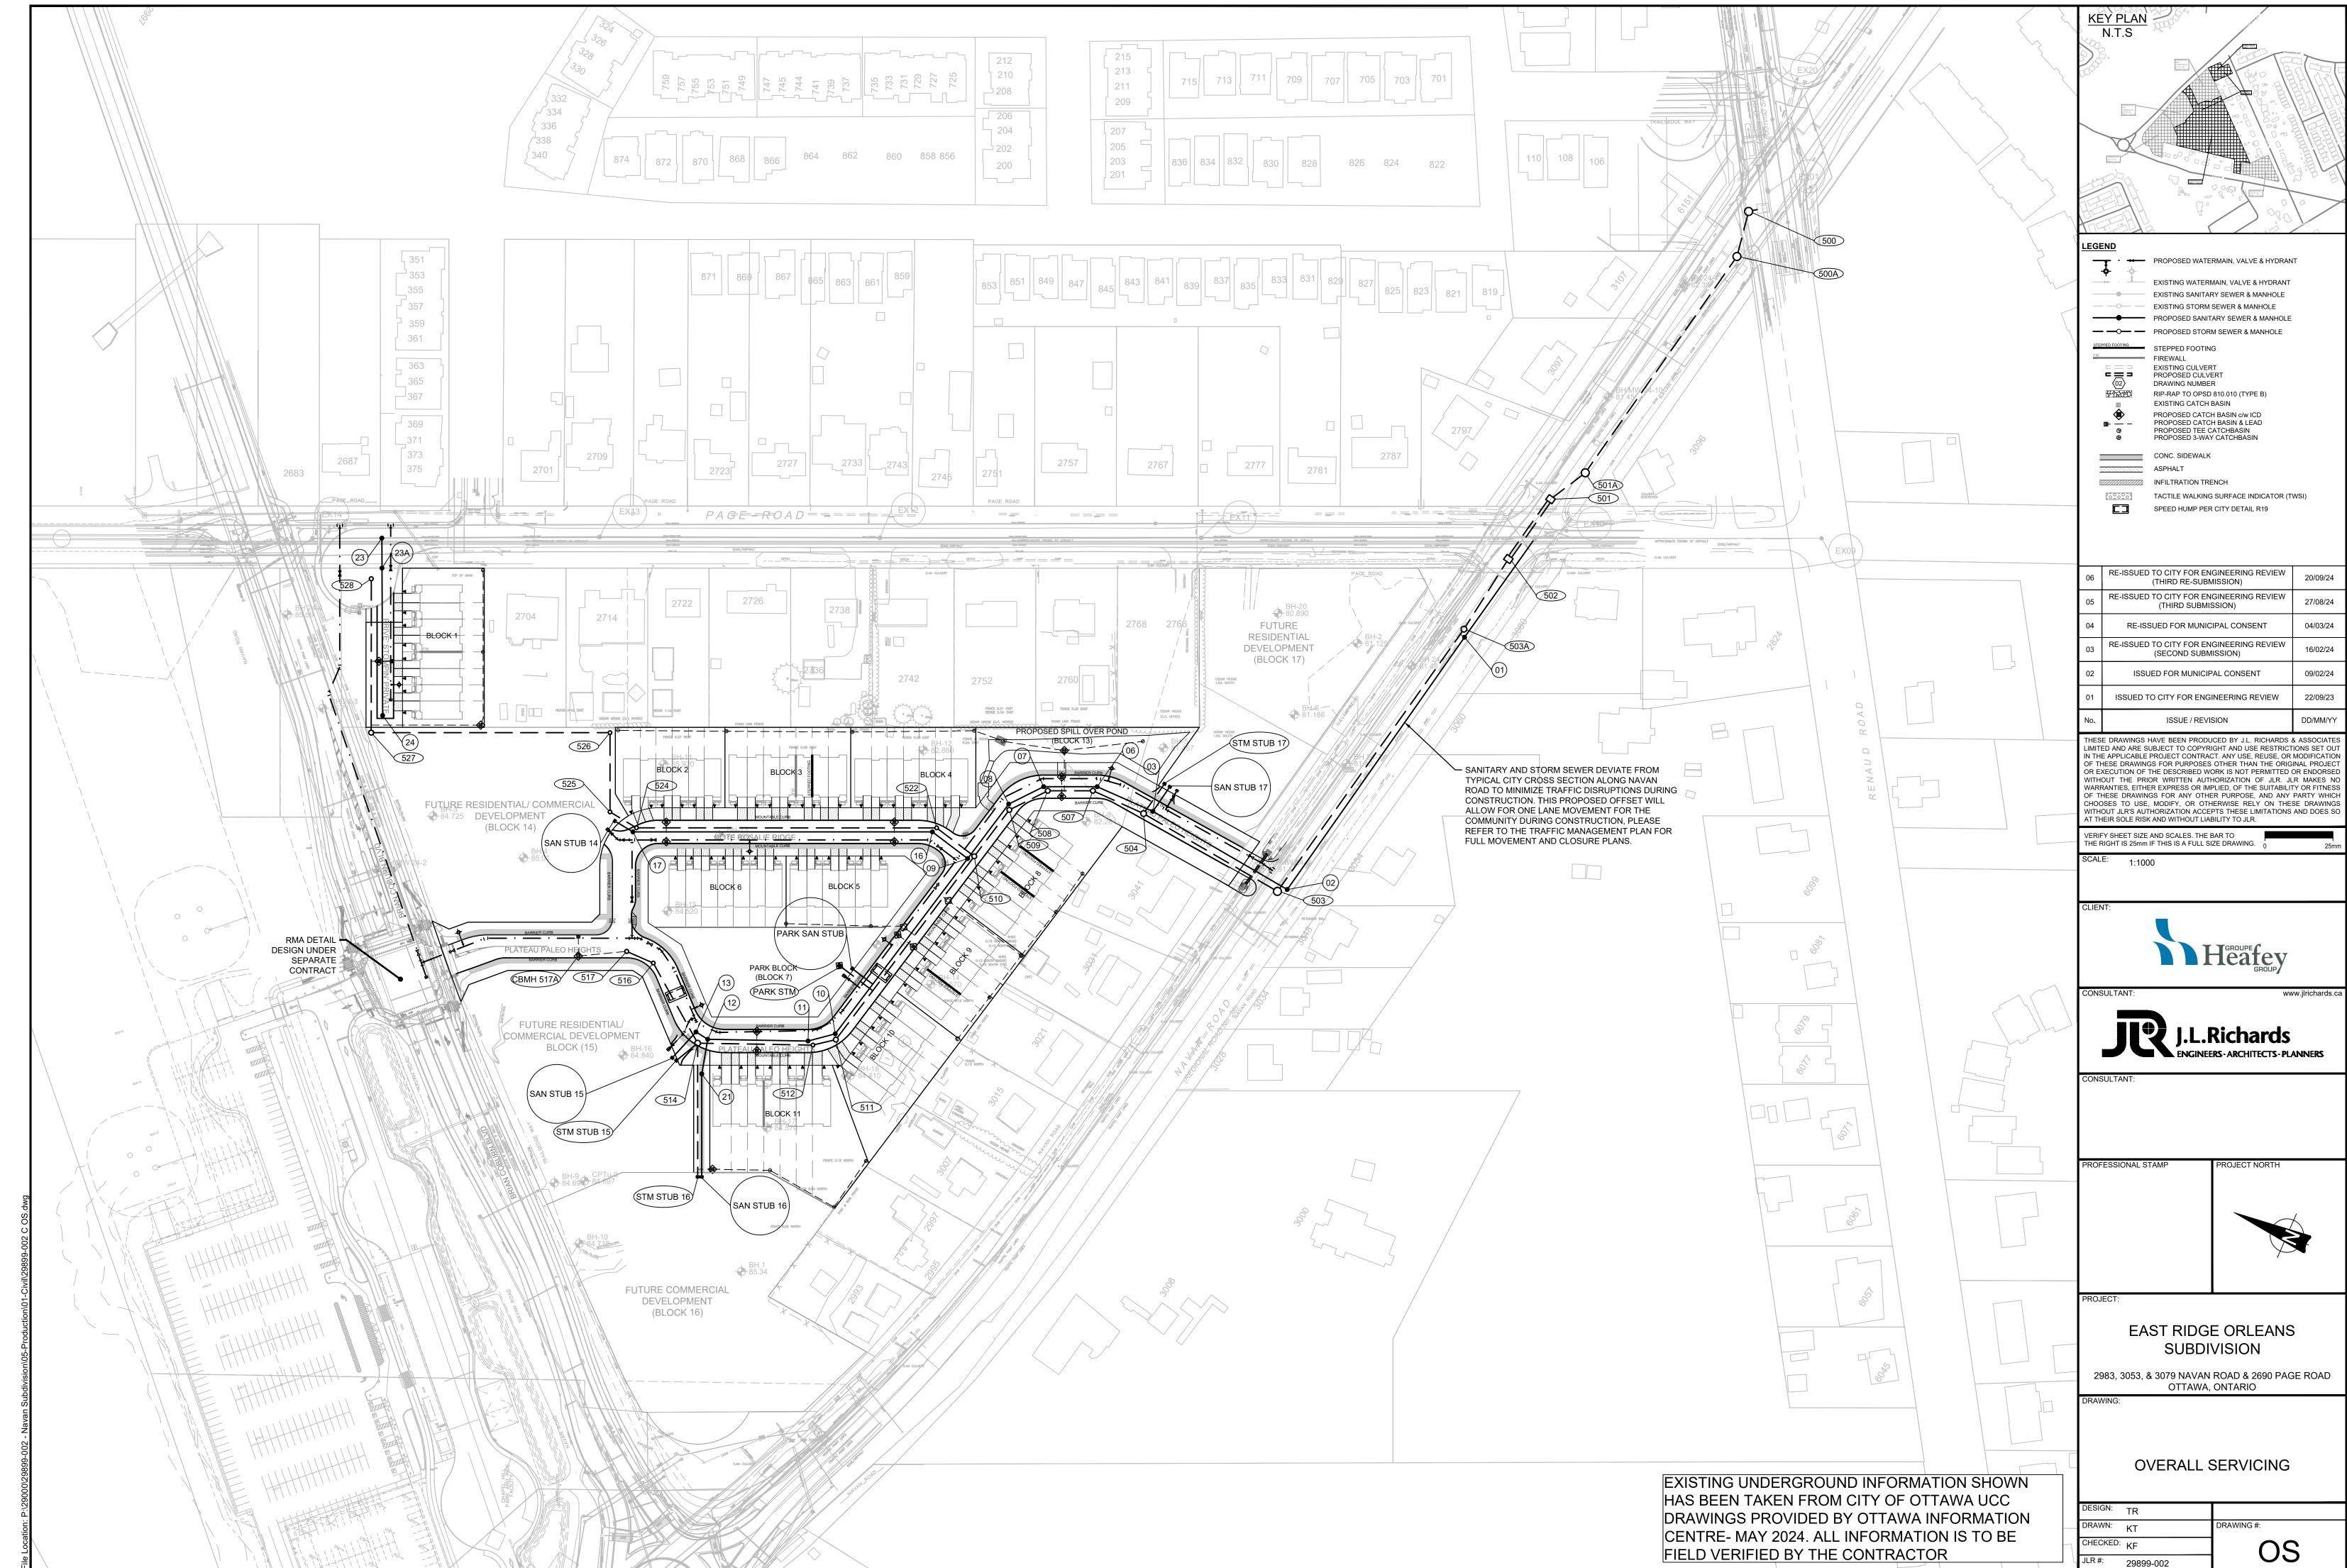

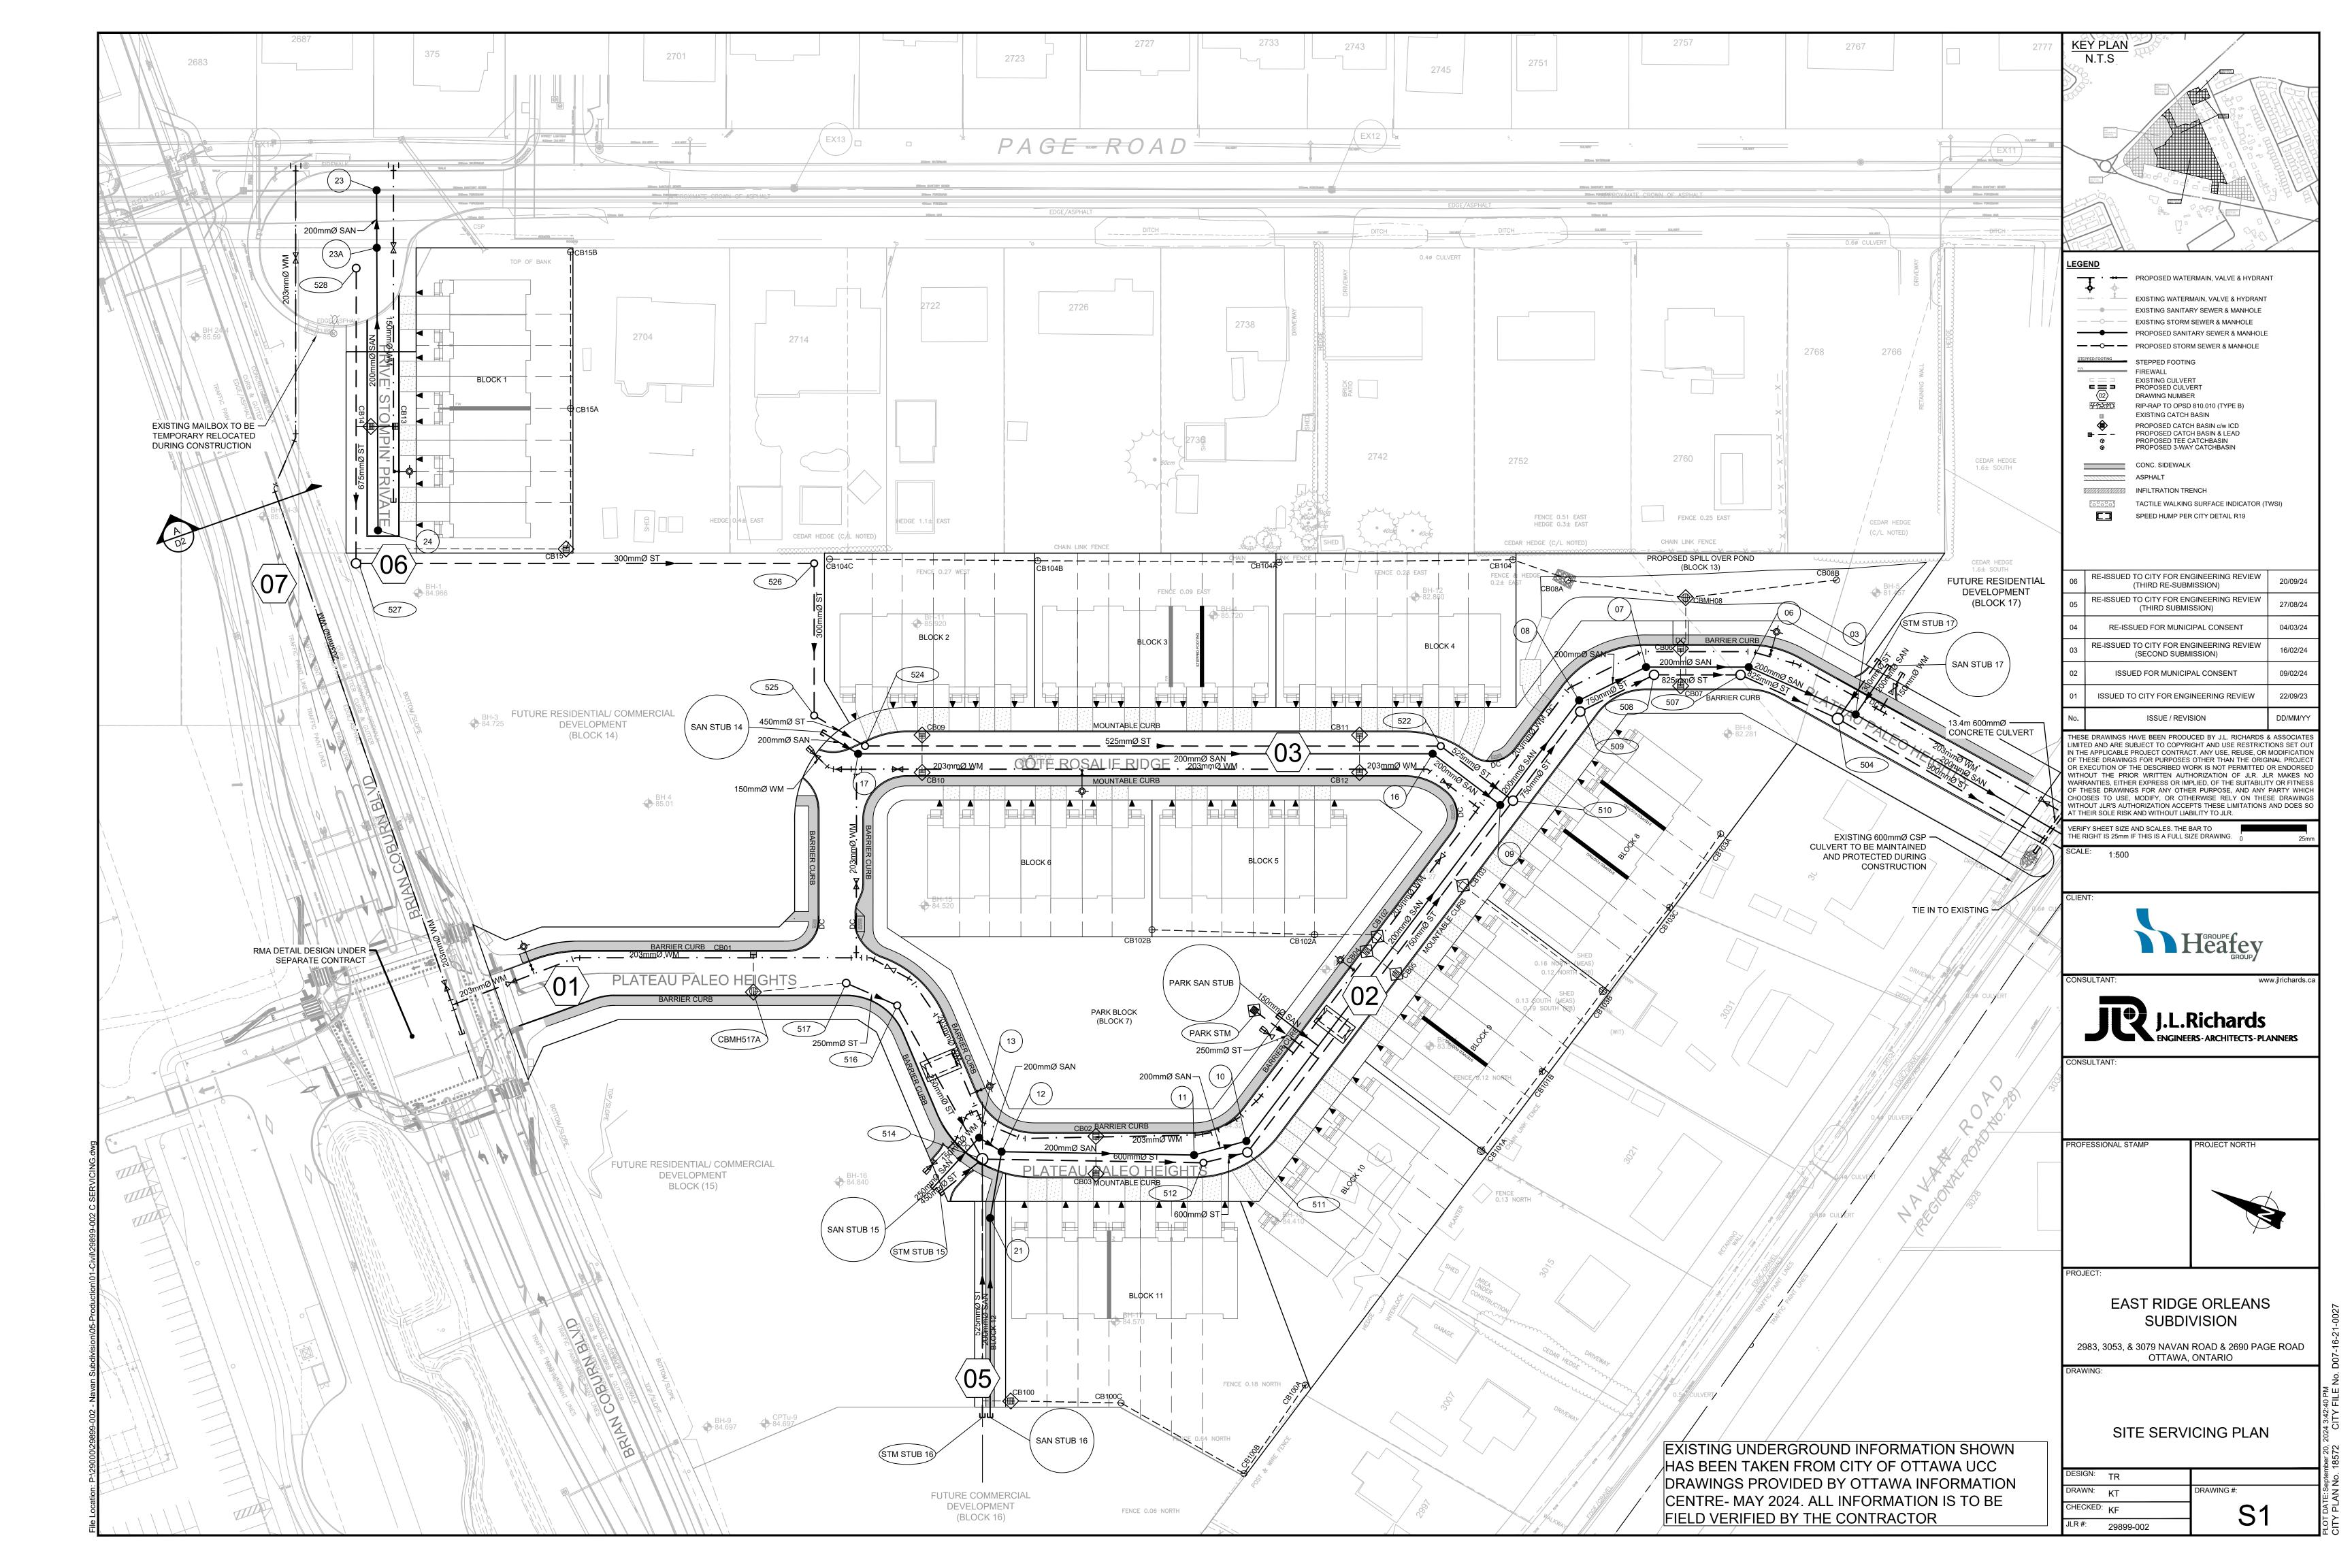

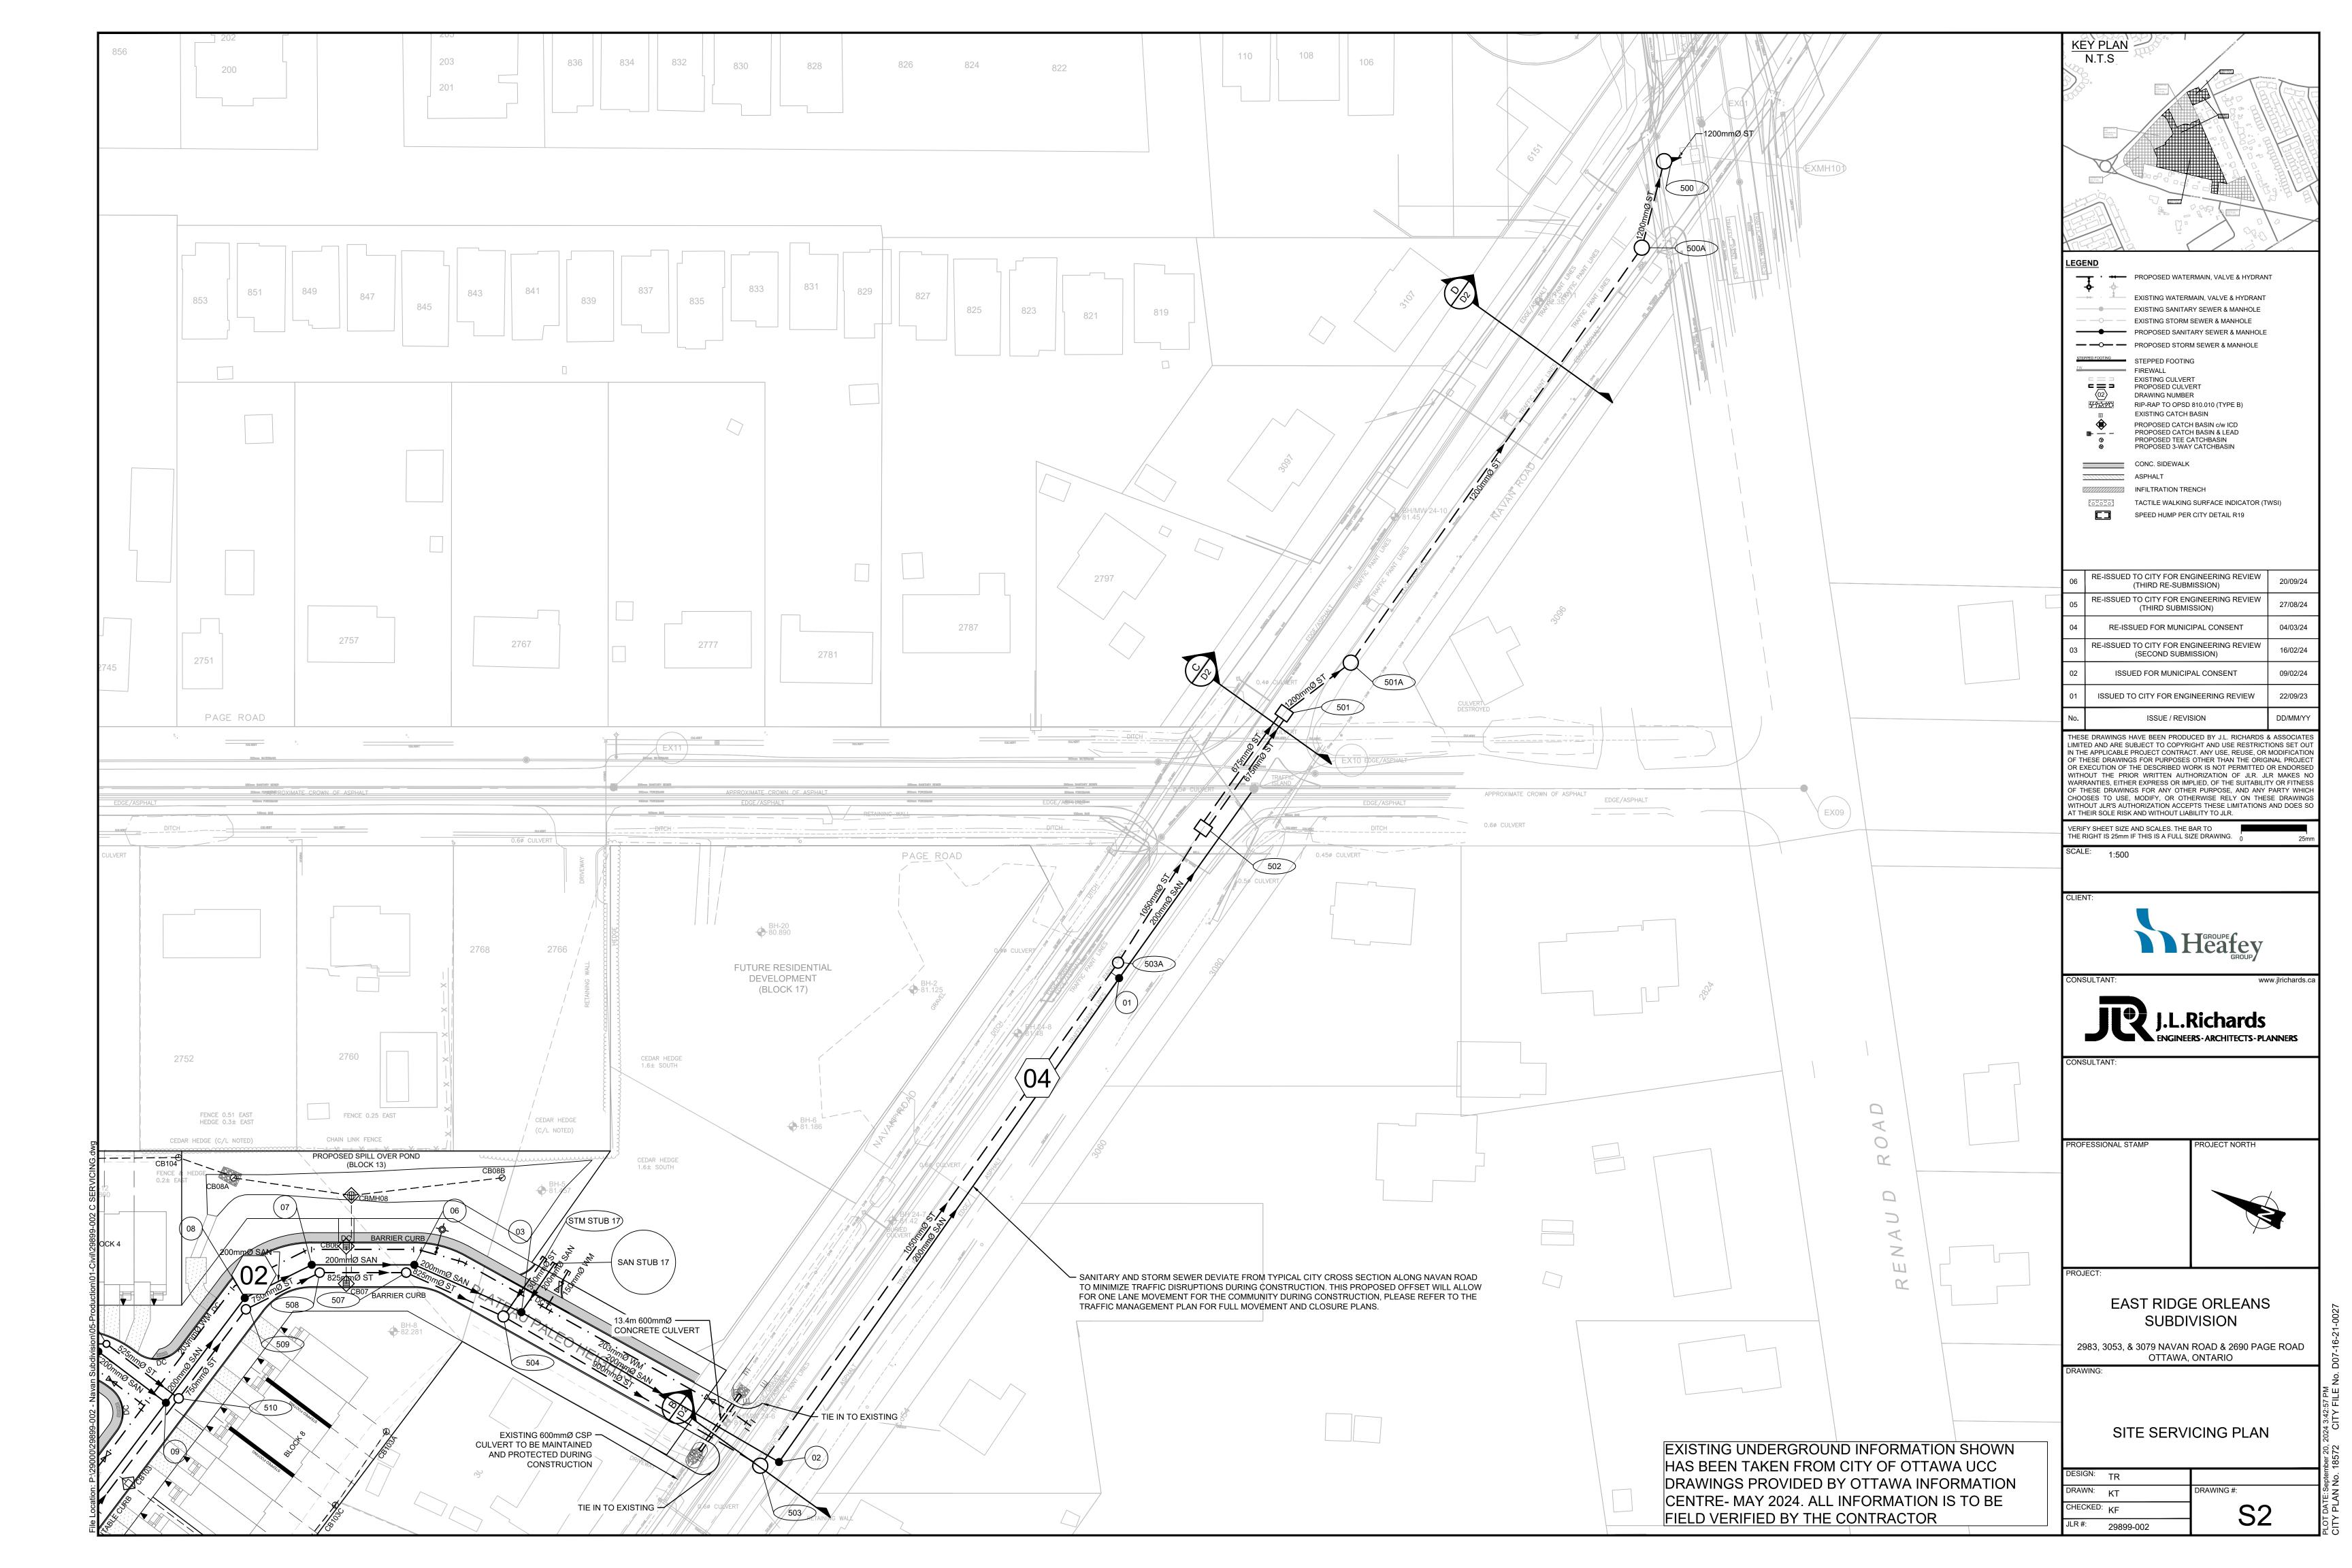

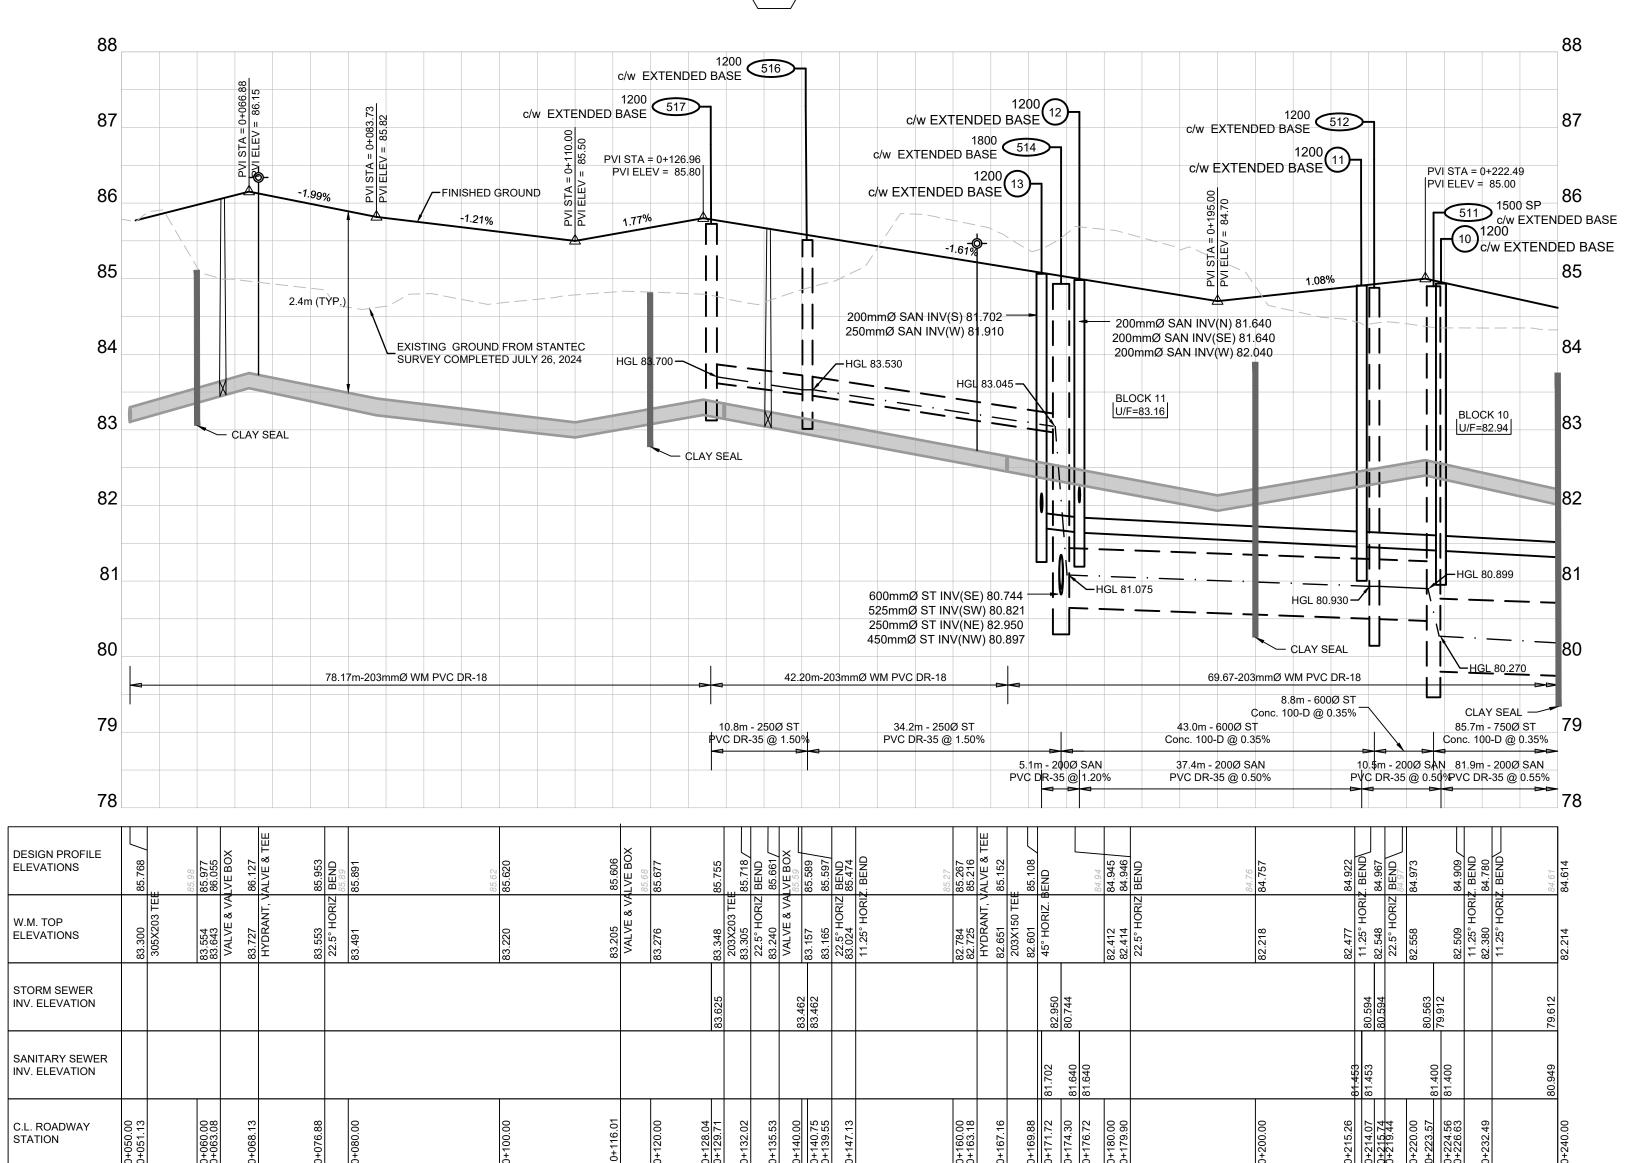

PROPOSED WATERMAIN, VALVE & HYDRANT EXISTING WATERMAIN, VALVE & HYDRANT EXISTING SANITARY SEWER & MANHOLE — — EXISTING STORM SEWER & MANHOLE PROPOSED SANITARY SEWER & MANHOLE — — PROPOSED STORM SEWER & MANHOLE PROPOSED FORCE MAIN — · · · — · · · — HYDRAULIC GRADE LINE (HGL)

STEPPED FOOTING PROPOSED CULVERT DRAWING NUMBER RIP-RAP TO OPSD 810.010 (TYPE B) EXISTING CATCH BASIN

PROPOSED CATCH BASIN c/w ICD PROPOSED CATCH BASIN & LEAD PROPOSED TEE CATCHBASIN PROPOSED 3-WAY CATCHBASIN MANHOLE NUMBER AND SIZE (mm) c/w SAFETY PLATFORM 510 1200 SP PER OPSD 404.020

MANHOLE NUMBER AND SIZE (mm) c/w EXTENDED BASE
PER DETAIL D01 ON D1

3 LATERAL - SERVICE CONNECTION

(100mm ST, 135 SAN, 19 mm Water) TACTILE WALKING INDICATOR STRIP (TWIS) CONC. SIDEWALK

ASPHALT INFILTRATION TRENCH

* REFER TO GEOTECHNICAL REPORTS FOR ALL RECOMMENDATIONS AND COMPLETE GROUNDWATER INFORMATION.

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VERIFY SHEET SIZE AND SCALES. THE BAR TO THE RIGHT IS 25mm IF THIS IS A FULL SIZE DRAWING.

SCALE: 1:500H, 1:50V

Heafey

PROFESSIONAL STAMP



01

EAST RIDGE ORLEANS SUBDIVISION

2983, 3053, & 3079 NAVAN ROAD & 2690 PAGE ROAD OTTAWA, ONTARIO

PLAN AND PROFILE PALEO DRIVE STA. 0+050 TO 0+240

ESIGN:	TR	
RAWN:	KT	DRAWING
HECKED:	KF	
.R #:	29899-002	

WATERMAIN TABLE

STA. 8+000 TO 8+016.95 BLOCK 15

S N DETAIL

4 VALVE

5 CAP

1 200 x 150 TEE

2 45° HORIZONTAL BEND

3 22.5° HORIZONTAL BEND 8+008.22

PVC DR-18 CL.50

STATION

8+000

8+003.21

8+014.99

8+017.04

FINISHED

GRADE

85.04

85.14

85.00

85.30

85.28


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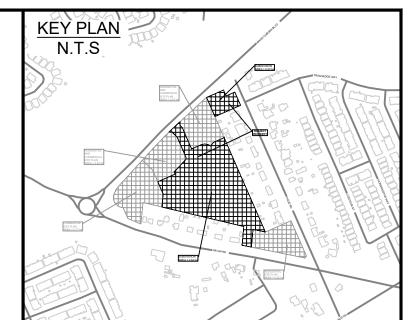
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82.88

82.88





PROPOSED WATERMAIN, VALVE & HYDRANT EXISTING WATERMAIN, VALVE & HYDRANT

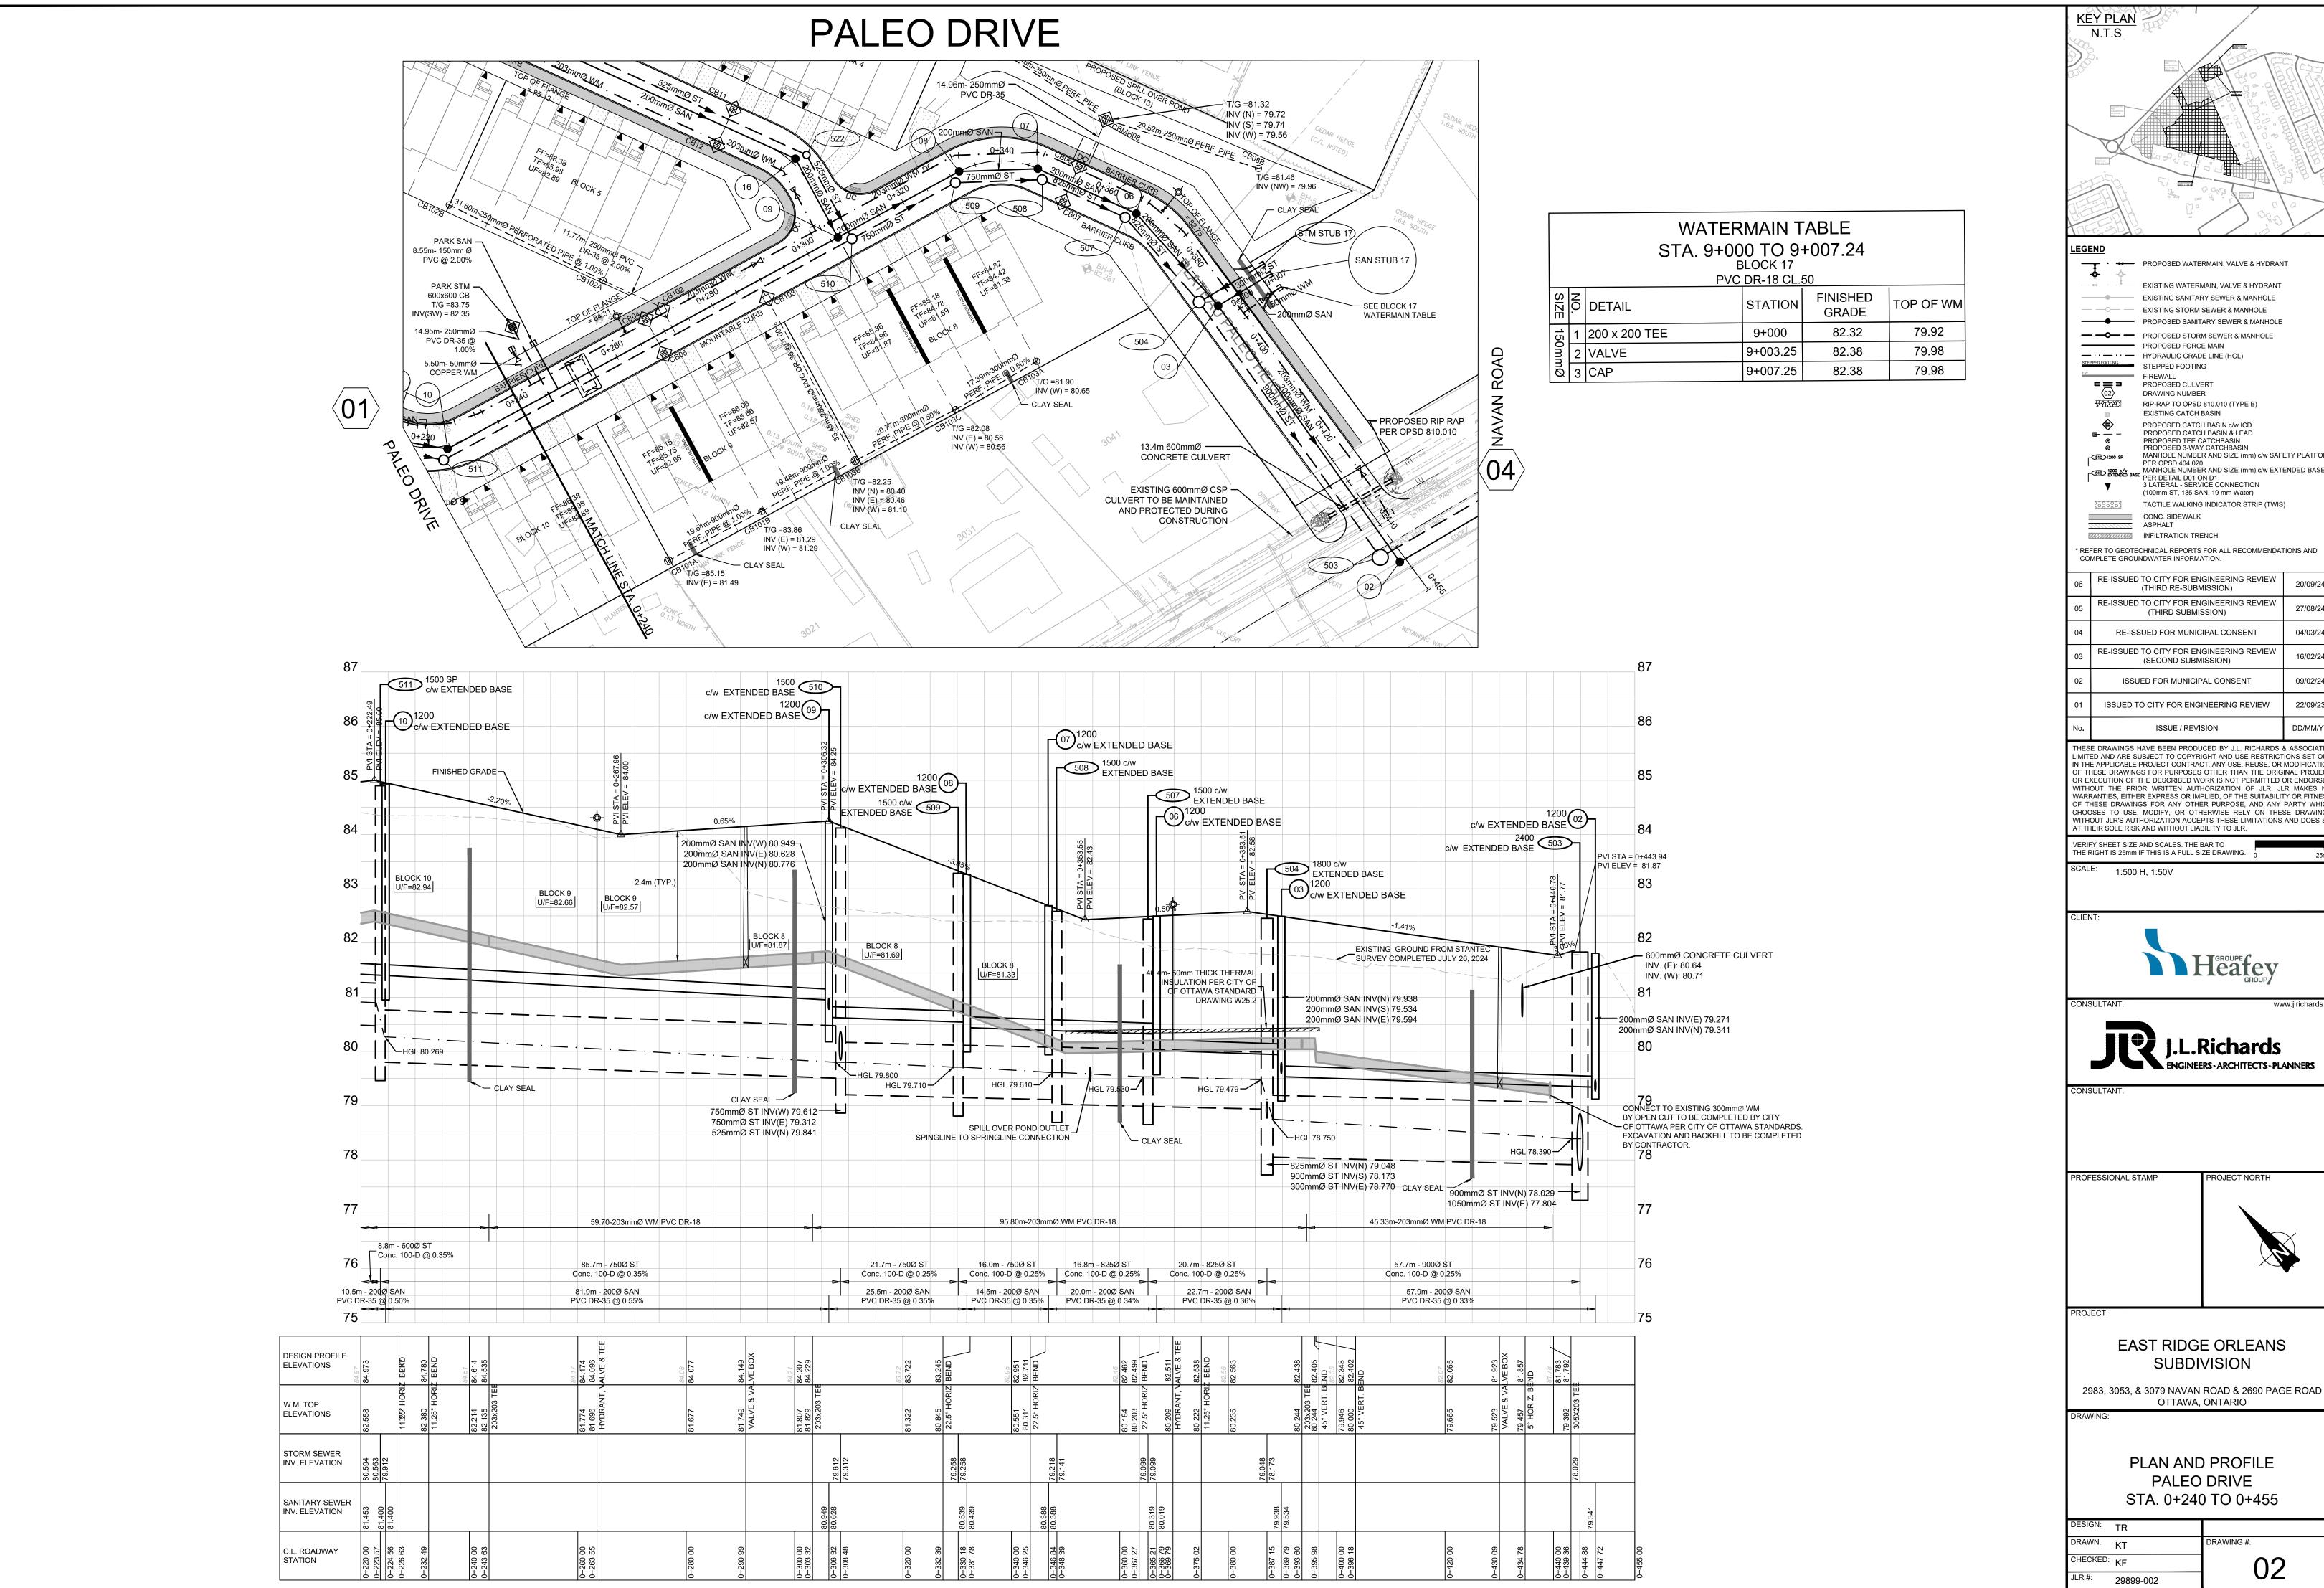EXISTING SANITARY SEWER & MANHOLE EXISTING STORM SEWER & MANHOLE PROPOSED SANITARY SEWER & MANHOLE

— · · · — HYDRAULIC GRADE LINE (HGL) STEPPED FOOTING PROPOSED CULVERT DRAWING NUMBER

RIP-RAP TO OPSD 810.010 (TYPE B) EXISTING CATCH BASIN PROPOSED CATCH BASIN c/w ICD PROPOSED CATCH BASIN & LEAD PROPOSED TEE CATCHBASIN PROPOSED 3-WAY CATCHBASIN

PER OPSD 404.020

MANHOLE NUMBER AND SIZE (mm) c/w EXTENDED BASE
PER DETAIL D01 ON D1

3 LATERAL - SERVICE CONNECTION (100mm ST, 135 SAN, 19 mm Water)

MANHOLE NUMBER AND SIZE (mm) c/w SAFETY PLATFORM

TACTILE WALKING INDICATOR STRIP (TWIS) CONC. SIDEWALK INFILTRATION TRENCH

* REFER TO GEOTECHNICAL REPORTS FOR ALL RECOMMENDATIONS AND COMPLETE GROUNDWATER INFORMATION.


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SCALE: 1:500 H, 1:50V

Heafey





EAST RIDGE ORLEANS SUBDIVISION

2983, 3053, & 3079 NAVAN ROAD & 2690 PAGE ROAD OTTAWA, ONTARIO

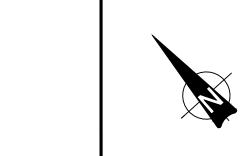PLAN AND PROFILE PALEO DRIVE STA. 0+240 TO 0+455

DRAWN: KT CHECKED: KF JLR #: 29899-002

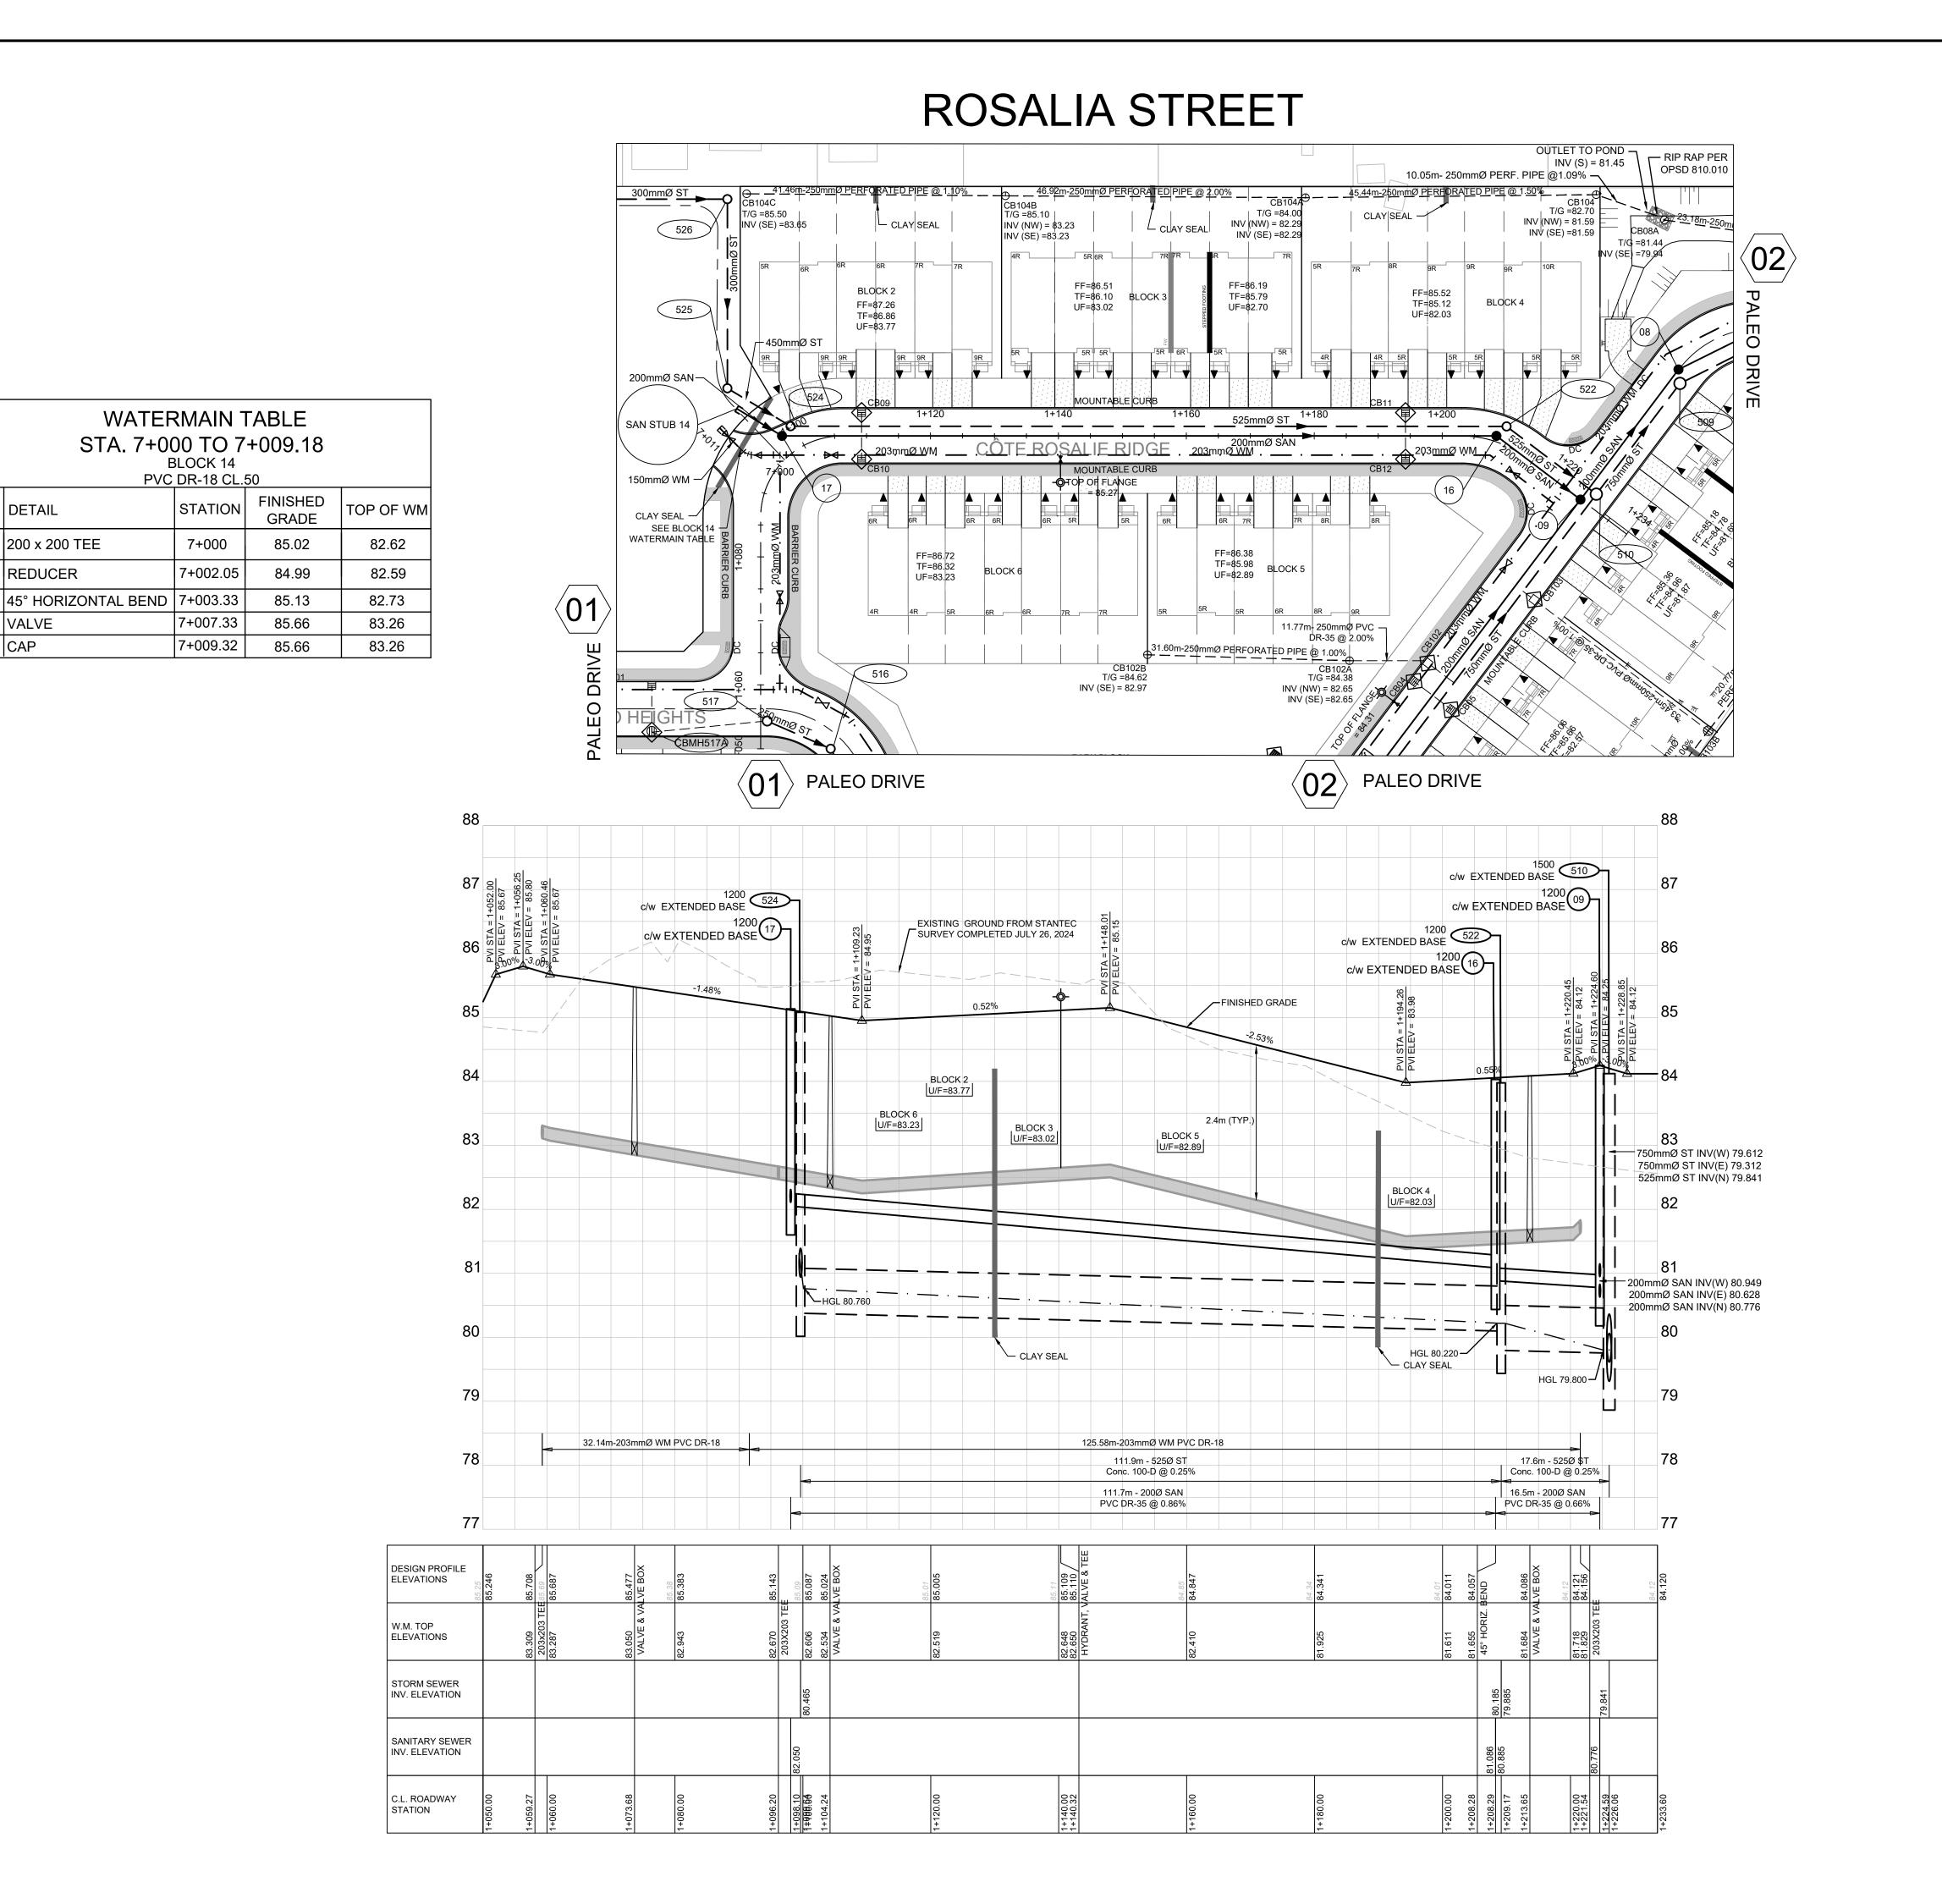

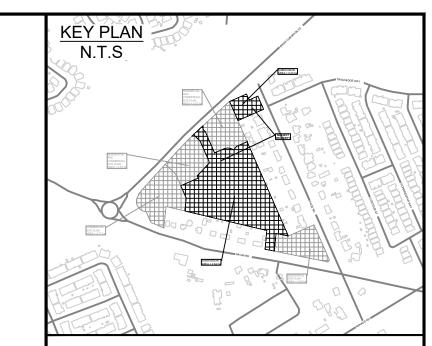

PROPOSED WATERMAIN, VALVE & HYDRANT EXISTING WATERMAIN, VALVE & HYDRANT EXISTING SANITARY SEWER & MANHOLE EXISTING STORM SEWER & MANHOLE PROPOSED SANITARY SEWER & MANHOLE — — PROPOSED STORM SEWER & MANHOLE PROPOSED FORCE MAIN — · · · — · · · — HYDRAULIC GRADE LINE (HGL) PROPOSED CULVERT DRAWING NUMBER RIP-RAP TO OPSD 810.010 (TYPE B) EXISTING CATCH BASIN PROPOSED CATCH BASIN c/w ICD PROPOSED CATCH BASIN & LEAD PROPOSED TEE CATCHBASIN PROPOSED 3-WAY CATCHBASIN

PER OPSD 404.020

MANHOLE NUMBER AND SIZE (mm) c/w EXTENDED BASE
PER DETAIL D01 ON D1

3 LATERAL - SERVICE CONNECTION (100mm ST, 135 SAN, 19 mm Water) TACTILE WALKING INDICATOR STRIP (TWIS)

MANHOLE NUMBER AND SIZE (mm) c/w SAFETY PLATFORM

CONC. SIDEWALK INFILTRATION TRENCH

* REFER TO GEOTECHNICAL REPORTS FOR ALL RECOMMENDATIONS AND COMPLETE GROUNDWATER INFORMATION.

06	RE-ISSUED TO CITY FOR ENGINEERING REVIEW (THIRD RE-SUBMISSION)	20/09/24
05	RE-ISSUED TO CITY FOR ENGINEERING REVIEW (THIRD SUBMISSION)	27/08/24
04	RE-ISSUED FOR MUNICIPAL CONSENT	04/03/24
03	RE-ISSUED TO CITY FOR ENGINEERING REVIEW (SECOND SUBMISSION)	16/02/24
02	ISSUED FOR MUNICIPAL CONSENT	09/02/24
01	ISSUED TO CITY FOR ENGINEERING REVIEW	22/09/23
No.	ISSUE / REVISION	DD/MM/YY

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VERIFY SHEET SIZE AND SCALES. THE BAR TO THE RIGHT IS 25mm IF THIS IS A FULL SIZE DRAWING.

SCALE: 1:500H, 1:50V

Heafey



EAST RIDGE ORLEANS SUBDIVISION

2983, 3053, & 3079 NAVAN ROAD & 2690 PAGE ROAD OTTAWA, ONTARIO

PLAN AND PROFILE **ROSALIA STREET** STA. 1+050 TO 1+233.60

DRAWN: KT CHECKED: KF JLR #: 29899-002

SIZ O DETAIL

200 x 200 TEE

REDUCER

4 VALVE

5 CAP

PROPOSED WATERMAIN, VALVE & HYDRANT EXISTING WATERMAIN, VALVE & HYDRANT EXISTING SANITARY SEWER & MANHOLE EXISTING STORM SEWER & MANHOLE

> — · · · — HYDRAULIC GRADE LINE (HGL) PROPOSED CULVERT DRAWING NUMBER RIP-RAP TO OPSD 810.010 (TYPE B)

PROPOSED CATCH BASIN c/w ICD PROPOSED CATCH BASIN & LEAD PROPOSED TEE CATCHBASIN PROPOSED 3-WAY CATCHBASIN MANHOLE NUMBER AND SIZE (mm) c/w SAFETY PLATFORM PER OPSD 404.020

MANHOLE NUMBER AND SIZE (mm) c/w EXTENDED BASE
PER DETAIL D01 ON D1

3 LATERAL - SERVICE CONNECTION

(100mm ST, 135 SAN, 19 mm Water) TACTILE WALKING INDICATOR STRIP (TWIS) CONC. SIDEWALK

* REFER TO GEOTECHNICAL REPORTS FOR ALL RECOMMENDATIONS AND

RE-ISSUED TO CITY FOR ENGINEERING REVIEW 20/09/24 (THIRD RE-SUBMISSION) RE-ISSUED TO CITY FOR ENGINEERING REVIEW 27/08/24 (THIRD SUBMISSION) RE-ISSUED FOR MUNICIPAL CONSENT 04/03/24 RE-ISSUED TO CITY FOR ENGINEERING REVIEW 16/02/24 (SECOND SUBMISSION) ISSUED FOR MUNICIPAL CONSENT 09/02/24 ISSUED TO CITY FOR ENGINEERING REVIEW 22/09/23 ISSUE / REVISION

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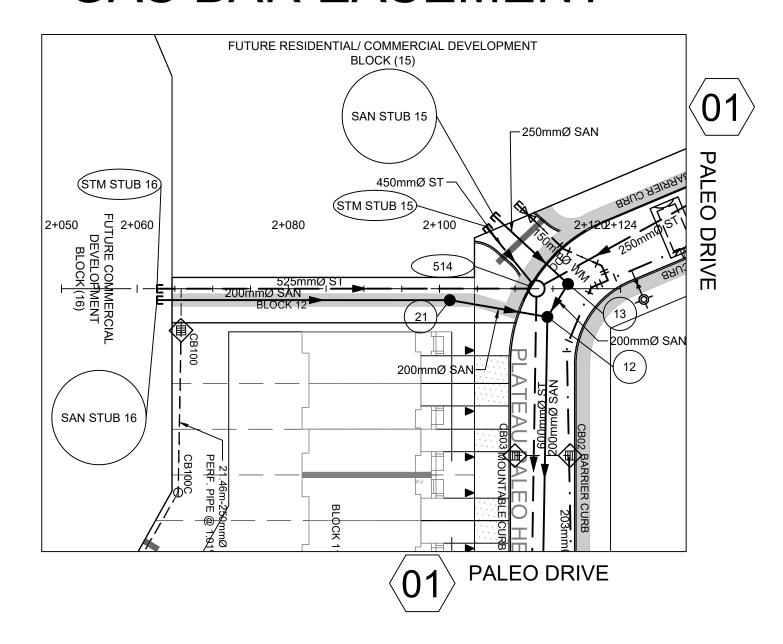
EAST RIDGE ORLEANS SUBDIVISION


2983, 3053, & 3079 NAVAN ROAD & 2690 PAGE ROAD OTTAWA, ONTARIO


> PLAN AND PROFILE NAVAN ROAD STA. 4+280 TO 4+620

JLR #: 29899-002

GAS BAR EASEMENT



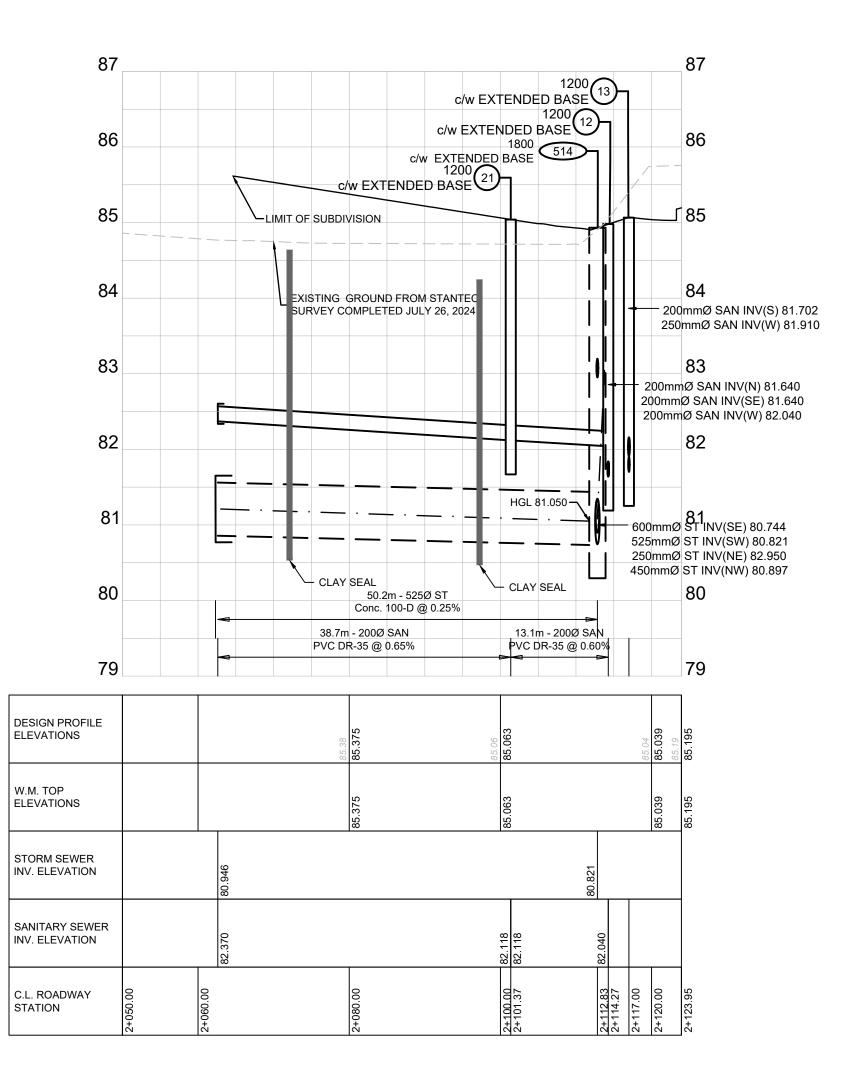

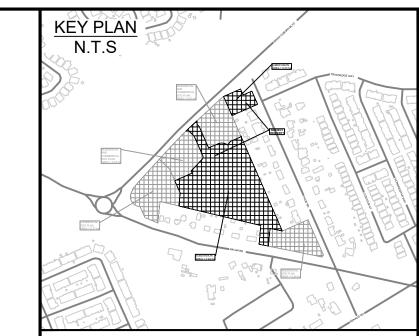

PROPOSED WATERMAIN, VALVE & HYDRANT EXISTING WATERMAIN, VALVE & HYDRANT

EXISTING SANITARY SEWER & MANHOLE — — EXISTING STORM SEWER & MANHOLE PROPOSED SANITARY SEWER & MANHOLE — — PROPOSED STORM SEWER & MANHOLE PROPOSED FORCE MAIN ─ · · · · · · · · HYDRAULIC GRADE LINE (HGL)

STEPPED FOOTING PROPOSED CULVERT DRAWING NUMBER RIP-RAP TO OPSD 810.010 (TYPE B) EXISTING CATCH BASIN

PROPOSED CATCH BASIN c/w ICD PROPOSED CATCH BASIN & LEAD PROPOSED TEE CATCHBASIN PROPOSED 3-WAY CATCHBASIN MANHOLE NUMBER AND SIZE (mm) c/w SAFETY PLATFORM

PER OPSD 404.020
MANHOLE NUMBER AND SIZE (mm) c/w EXTENDED BASE
PER DETAIL D01 ON D1
3 LATERAL - SERVICE CONNECTION (100mm ST, 135 SAN, 19 mm Water)

TACTILE WALKING INDICATOR STRIP (TWIS) CONC. SIDEWALK INFILTRATION TRENCH

* REFER TO GEOTECHNICAL REPORTS FOR ALL RECOMMENDATIONS AND COMPLETE GROUNDWATER INFORMATION.

RE-ISSUED TO CITY FOR ENGINEERING REVIEW (THIRD RE-SUBMISSION)	20/09/24
RE-ISSUED TO CITY FOR ENGINEERING REVIEW (THIRD SUBMISSION)	27/08/24
RE-ISSUED FOR MUNICIPAL CONSENT	04/03/24
RE-ISSUED TO CITY FOR ENGINEERING REVIEW (SECOND SUBMISSION)	16/02/24
ISSUED FOR MUNICIPAL CONSENT	09/02/24
ISSUED TO CITY FOR ENGINEERING REVIEW	22/09/23
ISSUE / REVISION	DD/MM/YY
	(THIRD RE-SUBMISSION) RE-ISSUED TO CITY FOR ENGINEERING REVIEW (THIRD SUBMISSION) RE-ISSUED FOR MUNICIPAL CONSENT RE-ISSUED TO CITY FOR ENGINEERING REVIEW (SECOND SUBMISSION) ISSUED FOR MUNICIPAL CONSENT ISSUED TO CITY FOR ENGINEERING REVIEW

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SCALE: 1:500 H, 1:50 V




EAST RIDGE ORLEANS SUBDIVISION


2983, 3053, & 3079 NAVAN ROAD & 2690 PAGE ROAD OTTAWA, ONTARIO

PLAN AND PROFILE GAS BAR EASEMENT STA. 2+050 TO 2+123.95


DRAWN: KT CHECKED: KF JLR #: 29899-002


STOMPIN' TOM LANE

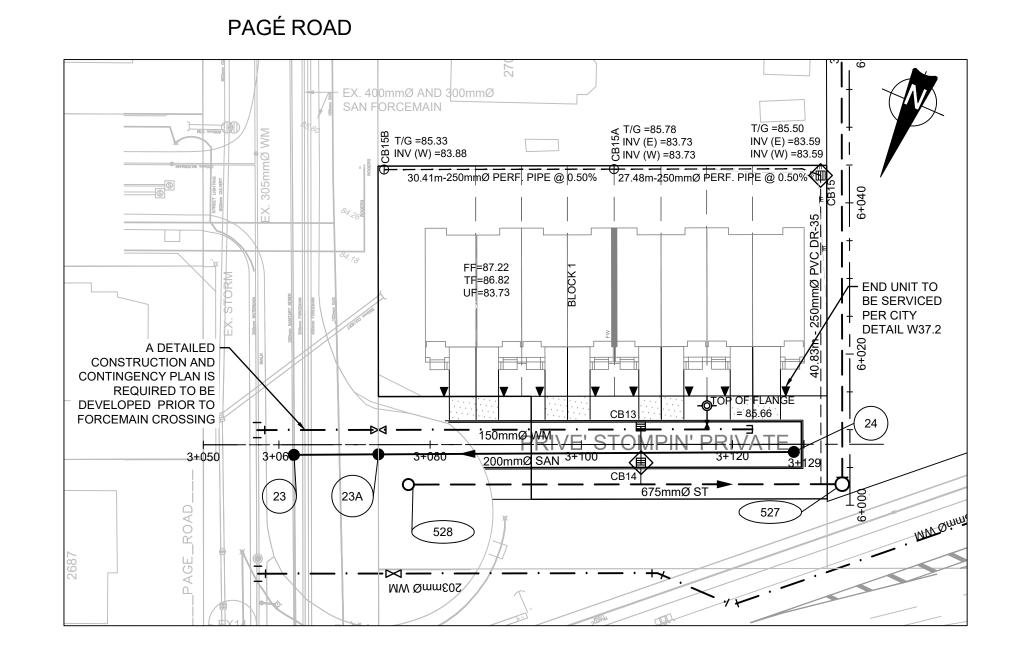


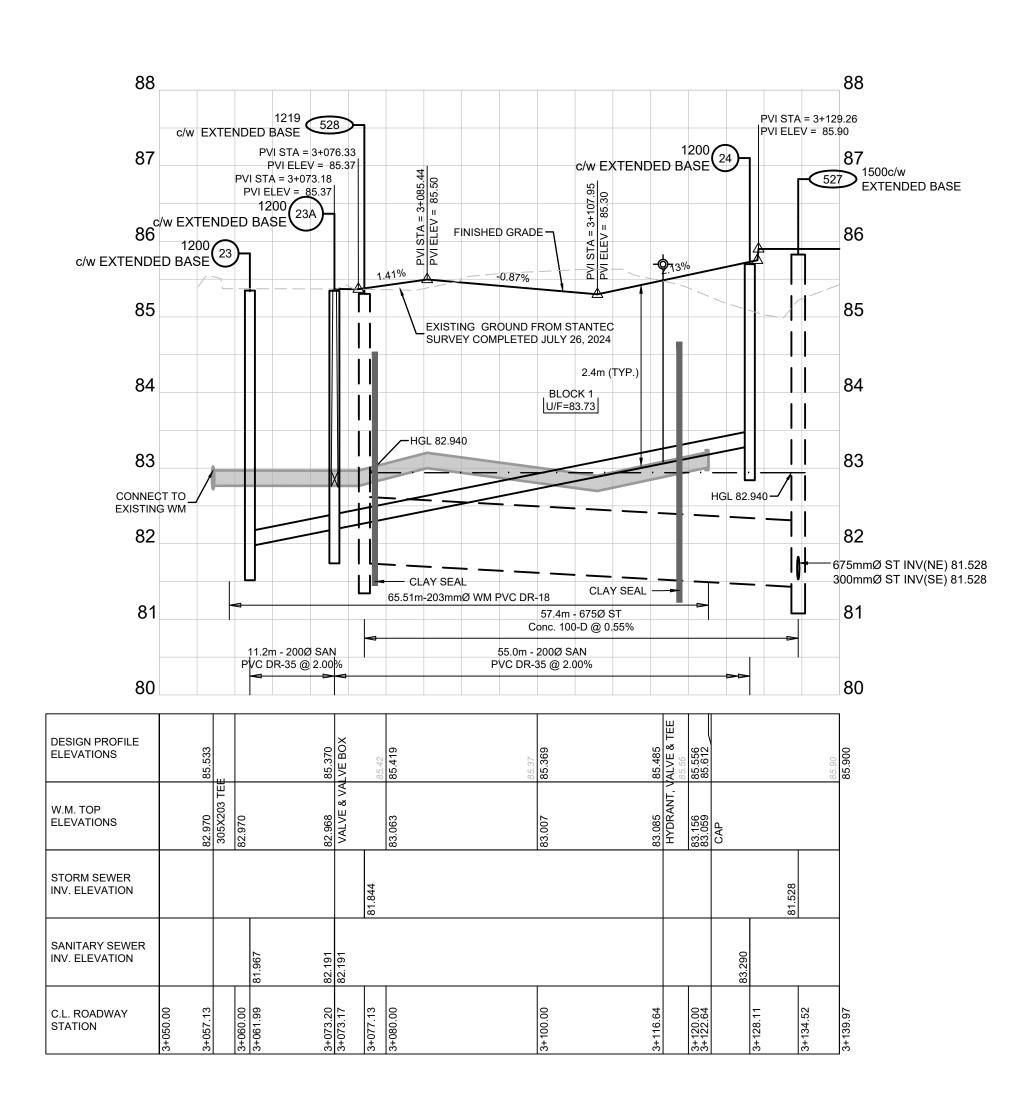

BLOCK 14 EASEMENT

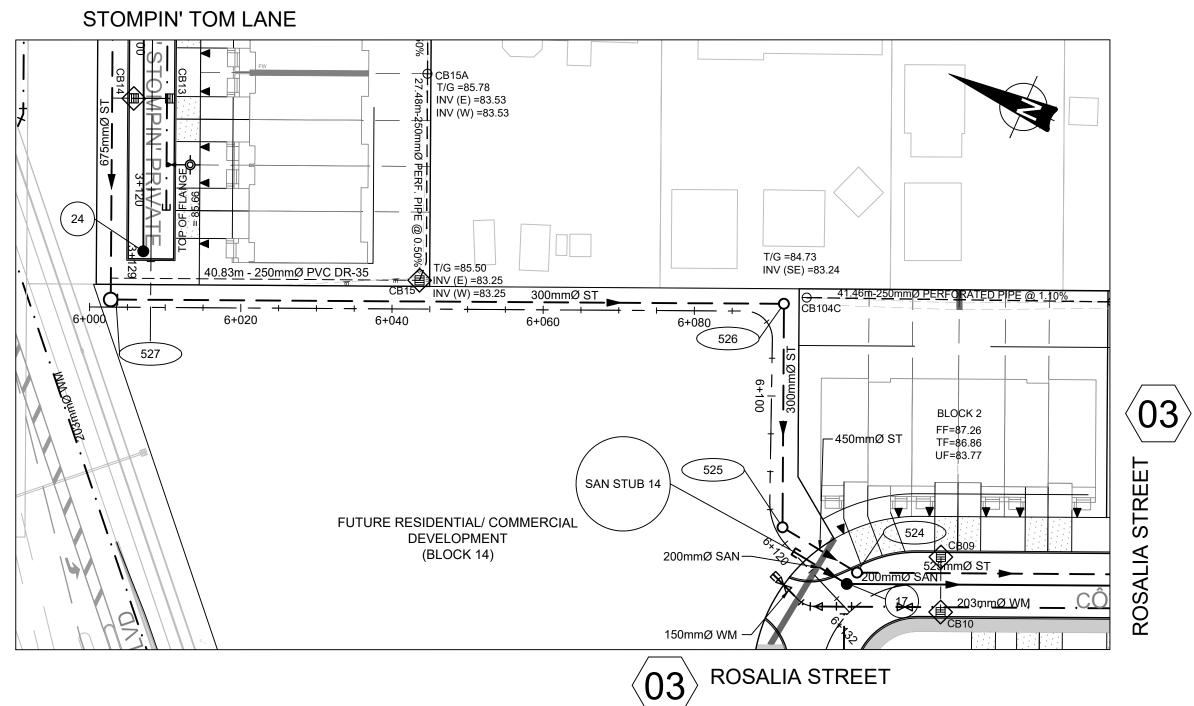

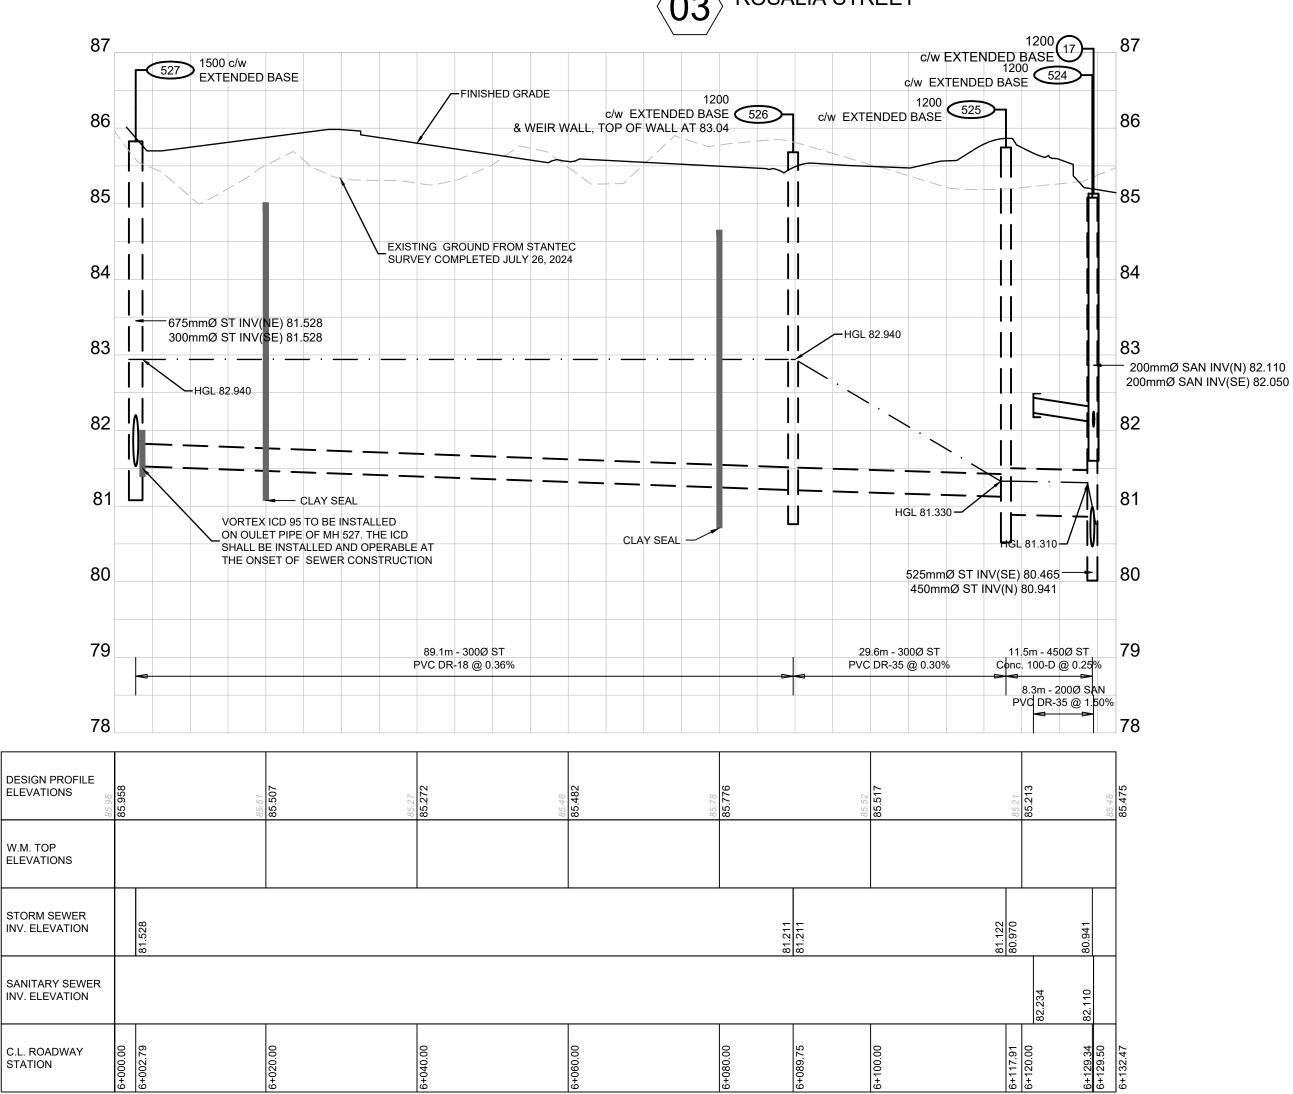

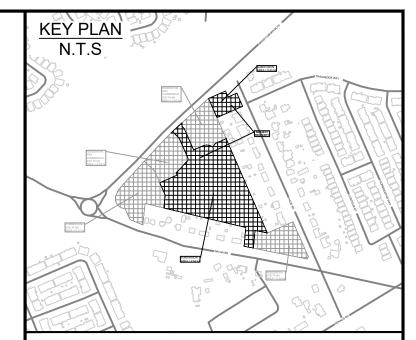

PROPOSED WATERMAIN, VALVE & HYDRANT EXISTING WATERMAIN, VALVE & HYDRANT DRAWING NUMBER RIP-RAP TO OPSD 810.010 (TYPE B) PROPOSED CATCH BASIN c/w ICD PROPOSED CATCH BASIN & LEAD PROPOSED TEE CATCHBASIN PROPOSED 3-WAY CATCHBASIN MANHOLE NUMBER AND SIZE (mm) c/w SAFETY PLATFOR PER OPSD 404.020

MANHOLE NUMBER AND SIZE (mm) c/w EXTENDED BASE
PER DETAIL D01 ON D1

3 LATERAL - SERVICE CONNECTION (100mm ST, 135 SAN, 19 mm Water) TACTILE WALKING INDICATOR STRIP (TWIS) INFILTRATION TRENCH * REFER TO GEOTECHNICAL REPORTS FOR ALL RECOMMENDATIONS AND COMPLETE GROUNDWATER INFORMATION. RE-ISSUED TO CITY FOR ENGINEERING REVIEW (THIRD RE-SUBMISSION) RE-ISSUED TO CITY FOR ENGINEERING REVIEW (THIRD SUBMISSION) RE-ISSUED FOR MUNICIPAL CONSENT RE-ISSUED TO CITY FOR ENGINEERING REVIEW ISSUED FOR MUNICIPAL CONSENT ISSUED TO CITY FOR ENGINEERING REVIEW ISSUE / REVISION

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SCALE: 1:500 H, 1:50 V

ENT:



1.L.Richards

CONSULTANT:

PROFESSIONAL STAMP PROJECT NORTH

PROJECT:

EAST RIDGE ORLEANS SUBDIVISION

2983, 3053, & 3079 NAVAN ROAD & 2690 PAGE ROAD OTTAWA, ONTARIO

RAWING:

PLAN AND PROFILE STOMPIN' TOM LANE & EASEMET 3+050 TO 3+139.97 & 6+000 TO 6+132.47

DESIGN: TR

DRAWN: KT

CHECKED: KF

JLR #: 29899-002


BRIAN COBURN BOULEVARD

NAVAN ROAD


TRAFFIC PAINT LINES


RMA DESIGNED UNDER SEPARATE COVER

BOTTOM/SLOPE

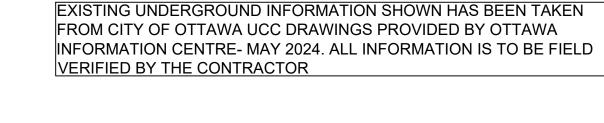

PAGÉ ROAD

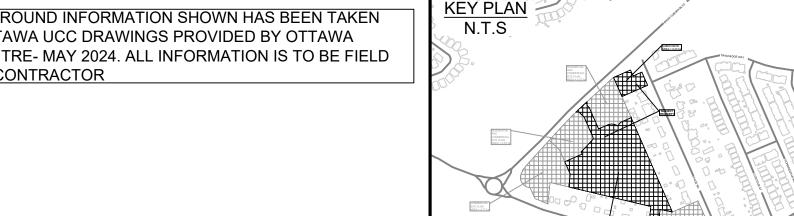

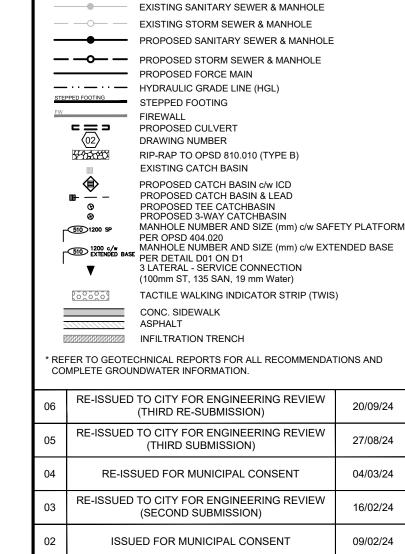

PROPOSED WATERMAIN, VALVE & HYDRANT

EXISTING WATERMAIN, VALVE & HYDRANT

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ISSUED TO CITY FOR ENGINEERING REVIEW

ISSUE / REVISION

22/09/23

VERIFY SHEET SIZE AND SCALES. THE BAR TO

SCALE: 1:500H, 1:50V






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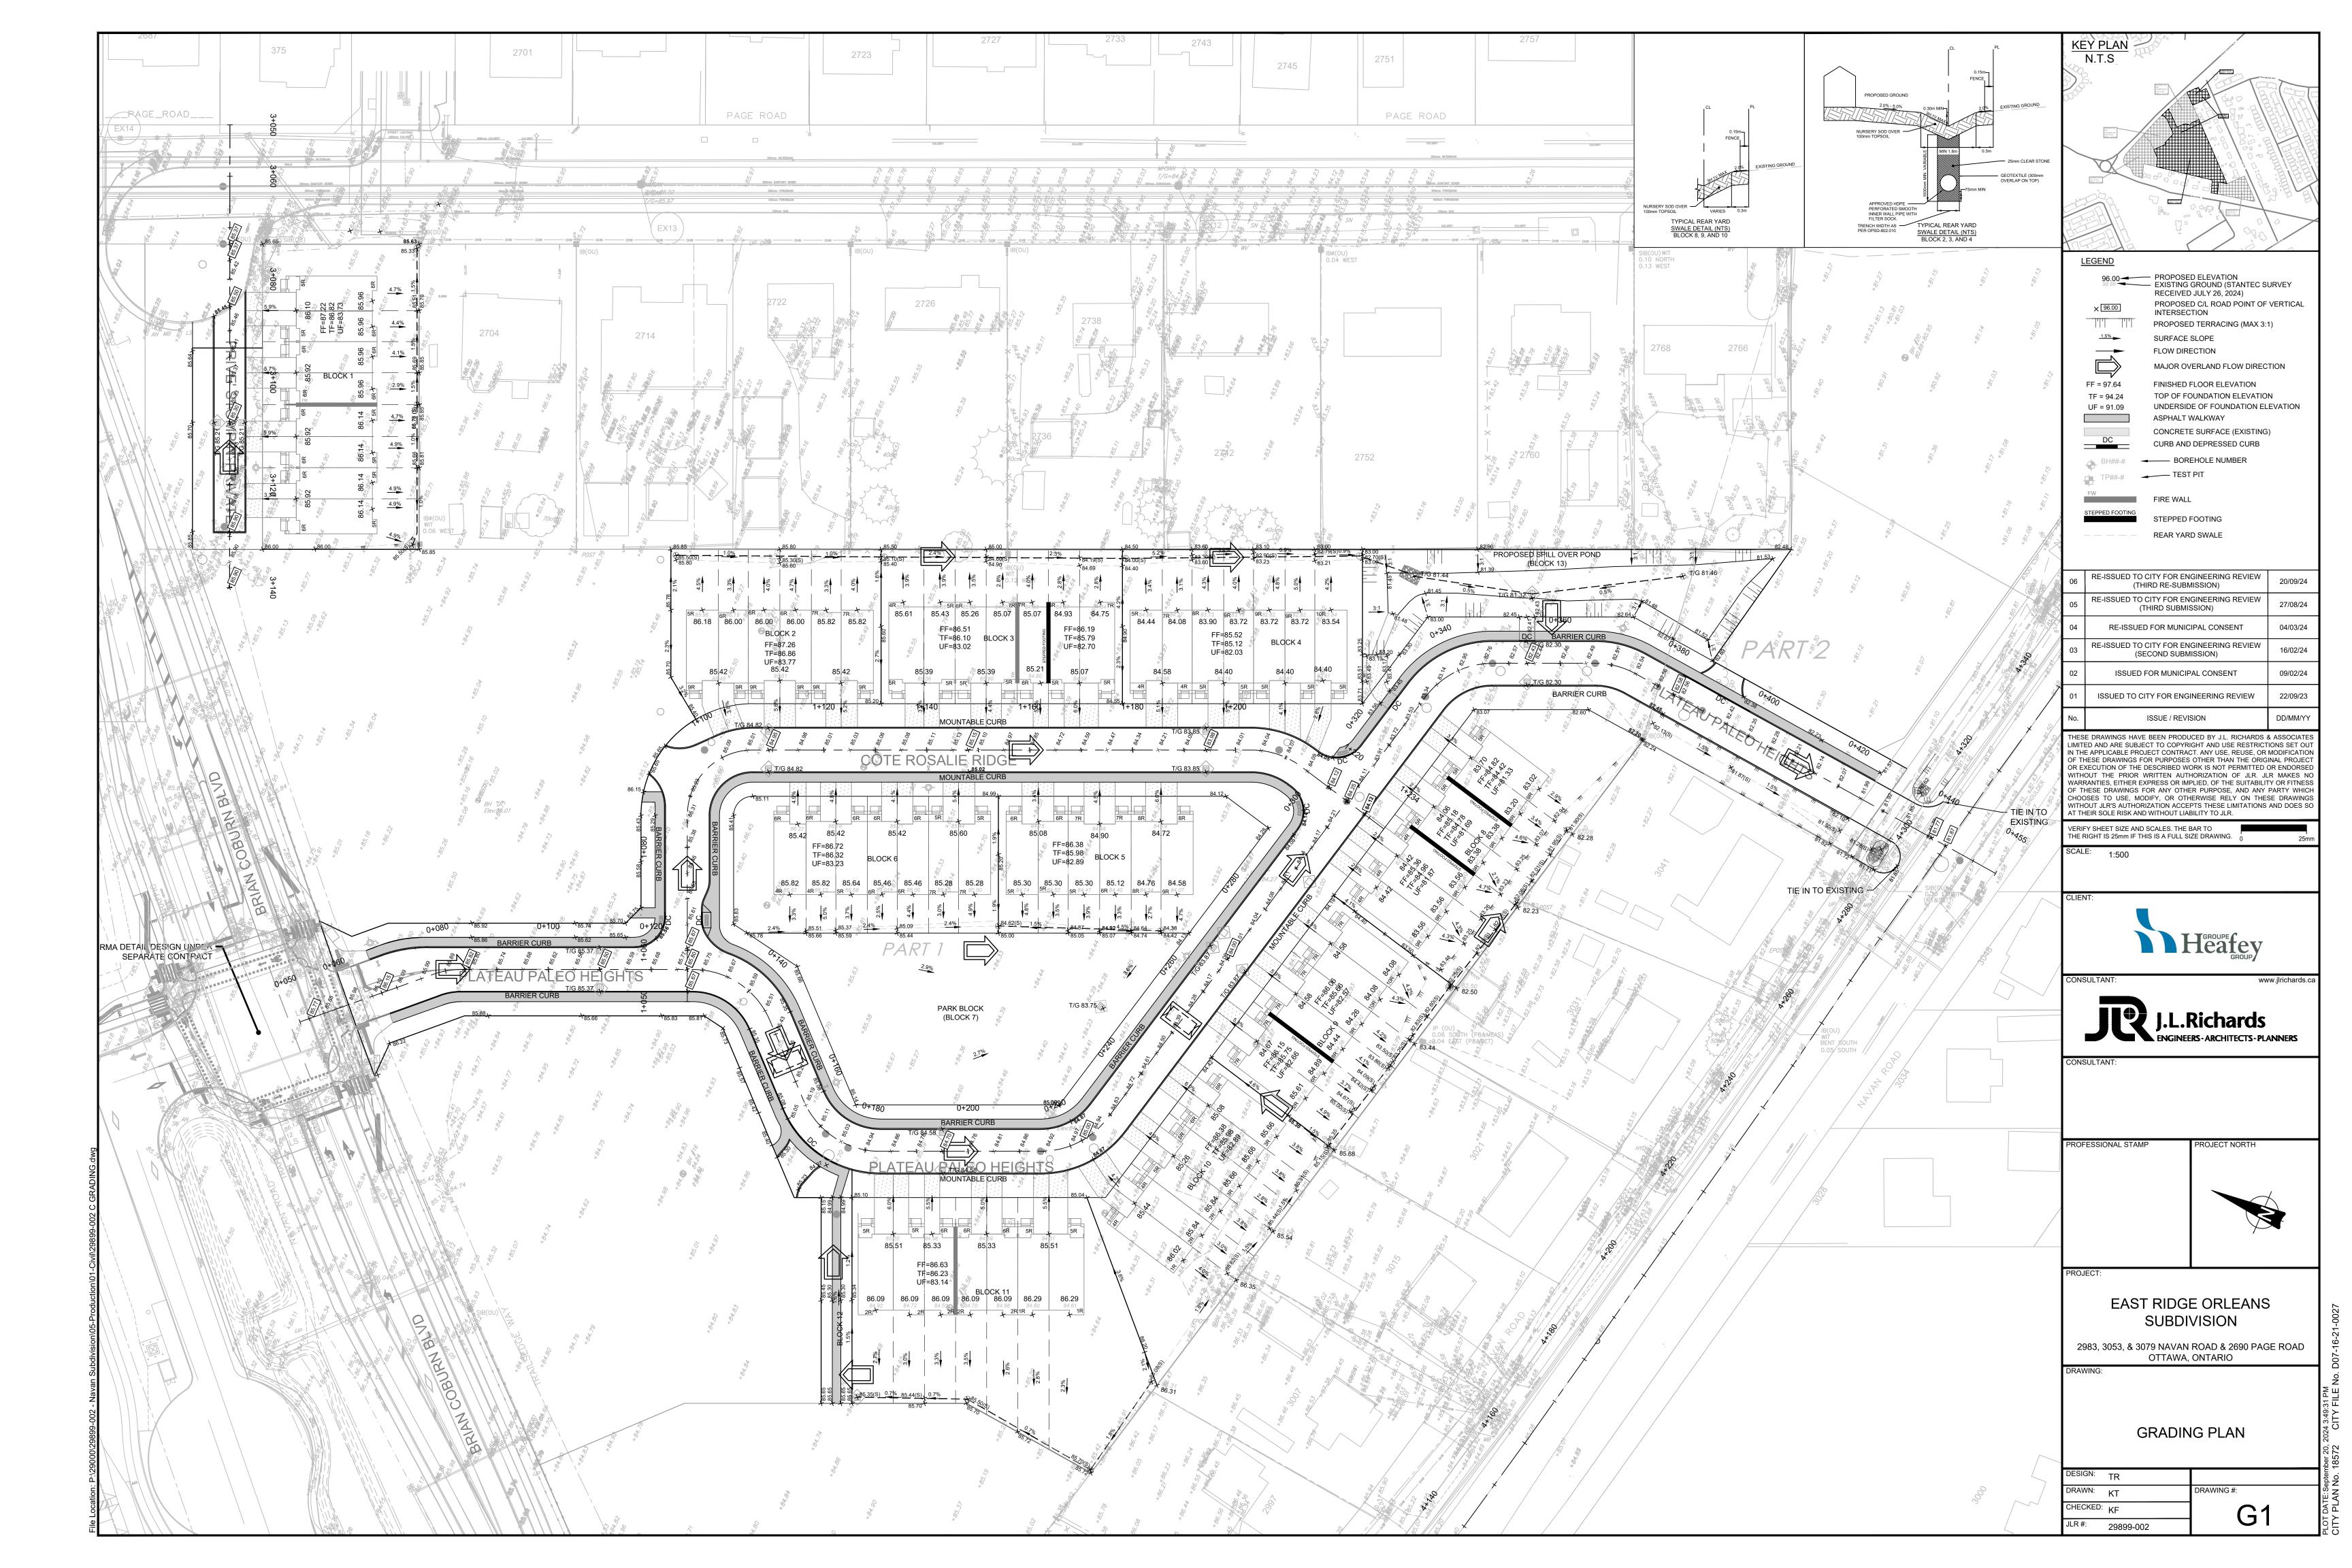
2983, 3053, & 3079 NAVAN ROAD & 2690 PAGE ROAD OTTAWA, ONTARIO


PLAN AND PROFILE BRIAN COBURN BOULEVARD STA. 5+050 TO 5+253.36


07


DRAWN: KT CHECKED: KF JLR #: 29899-002



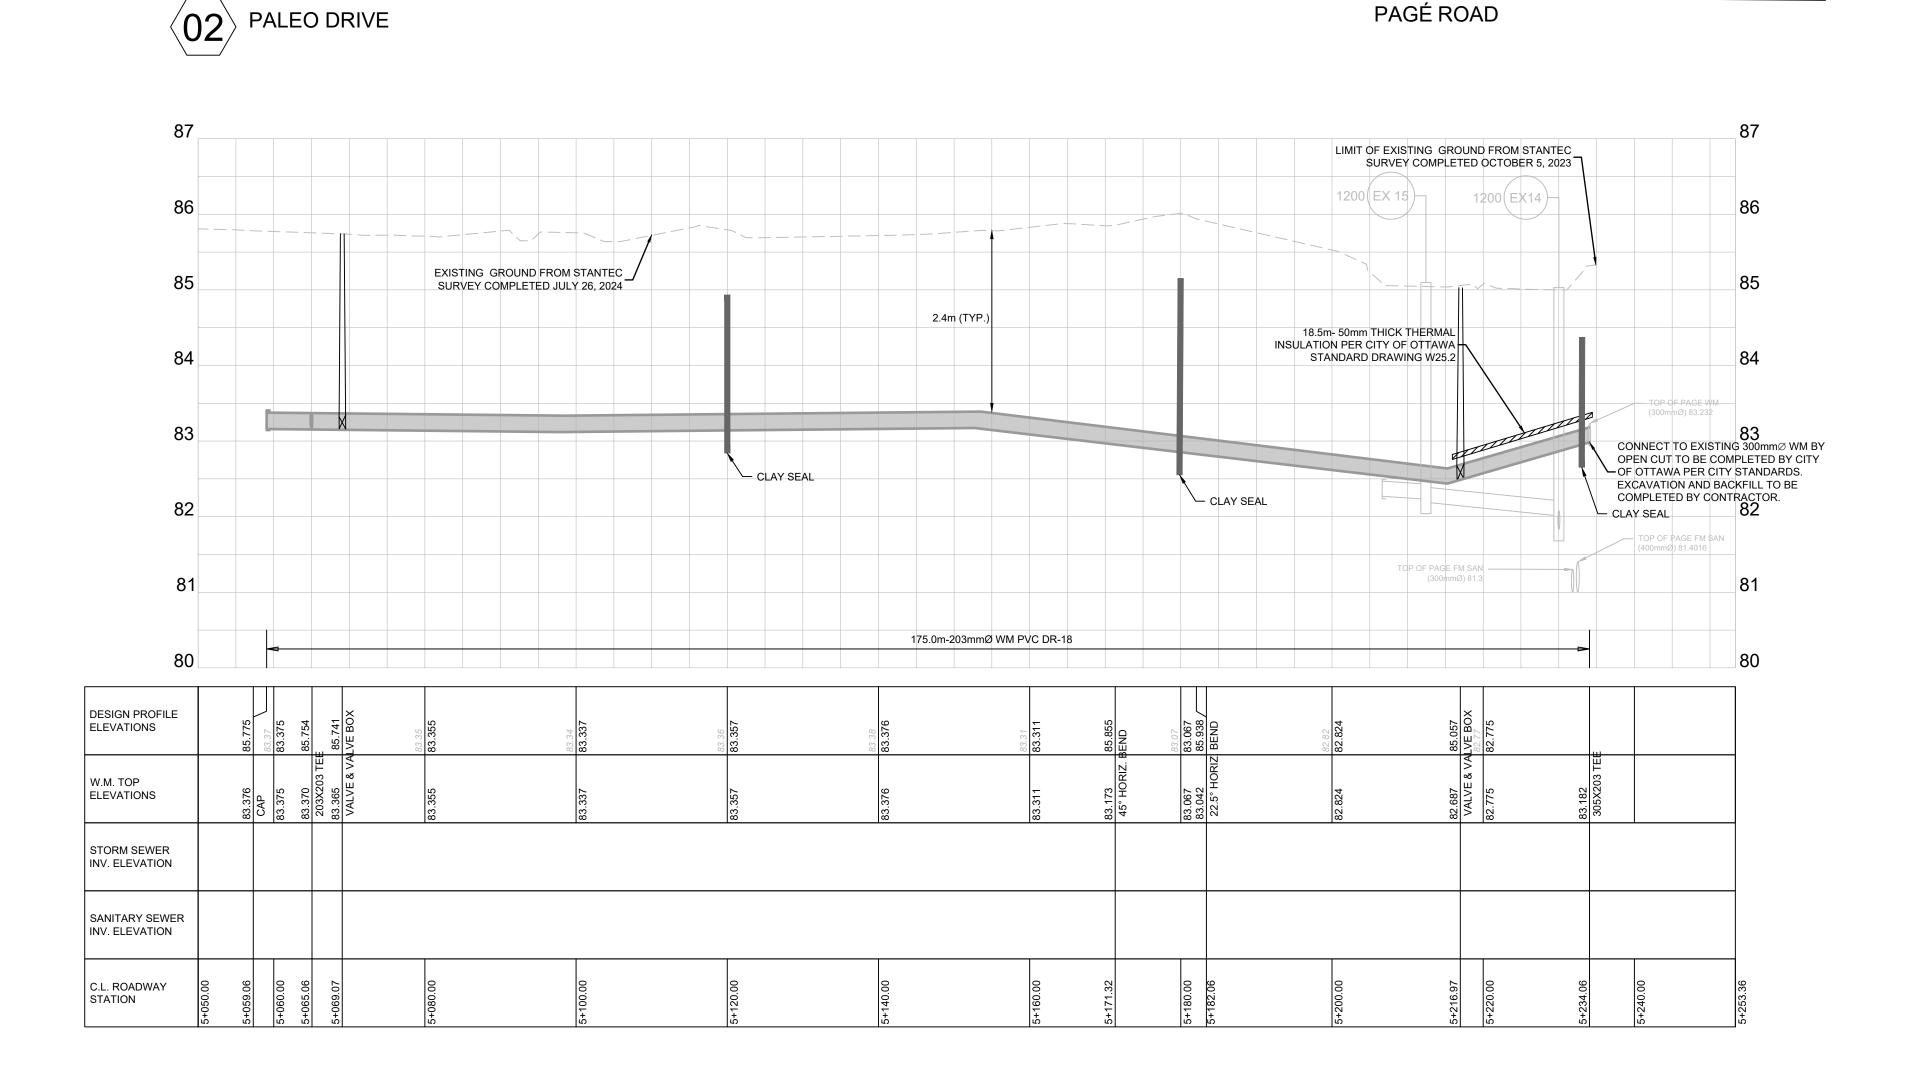


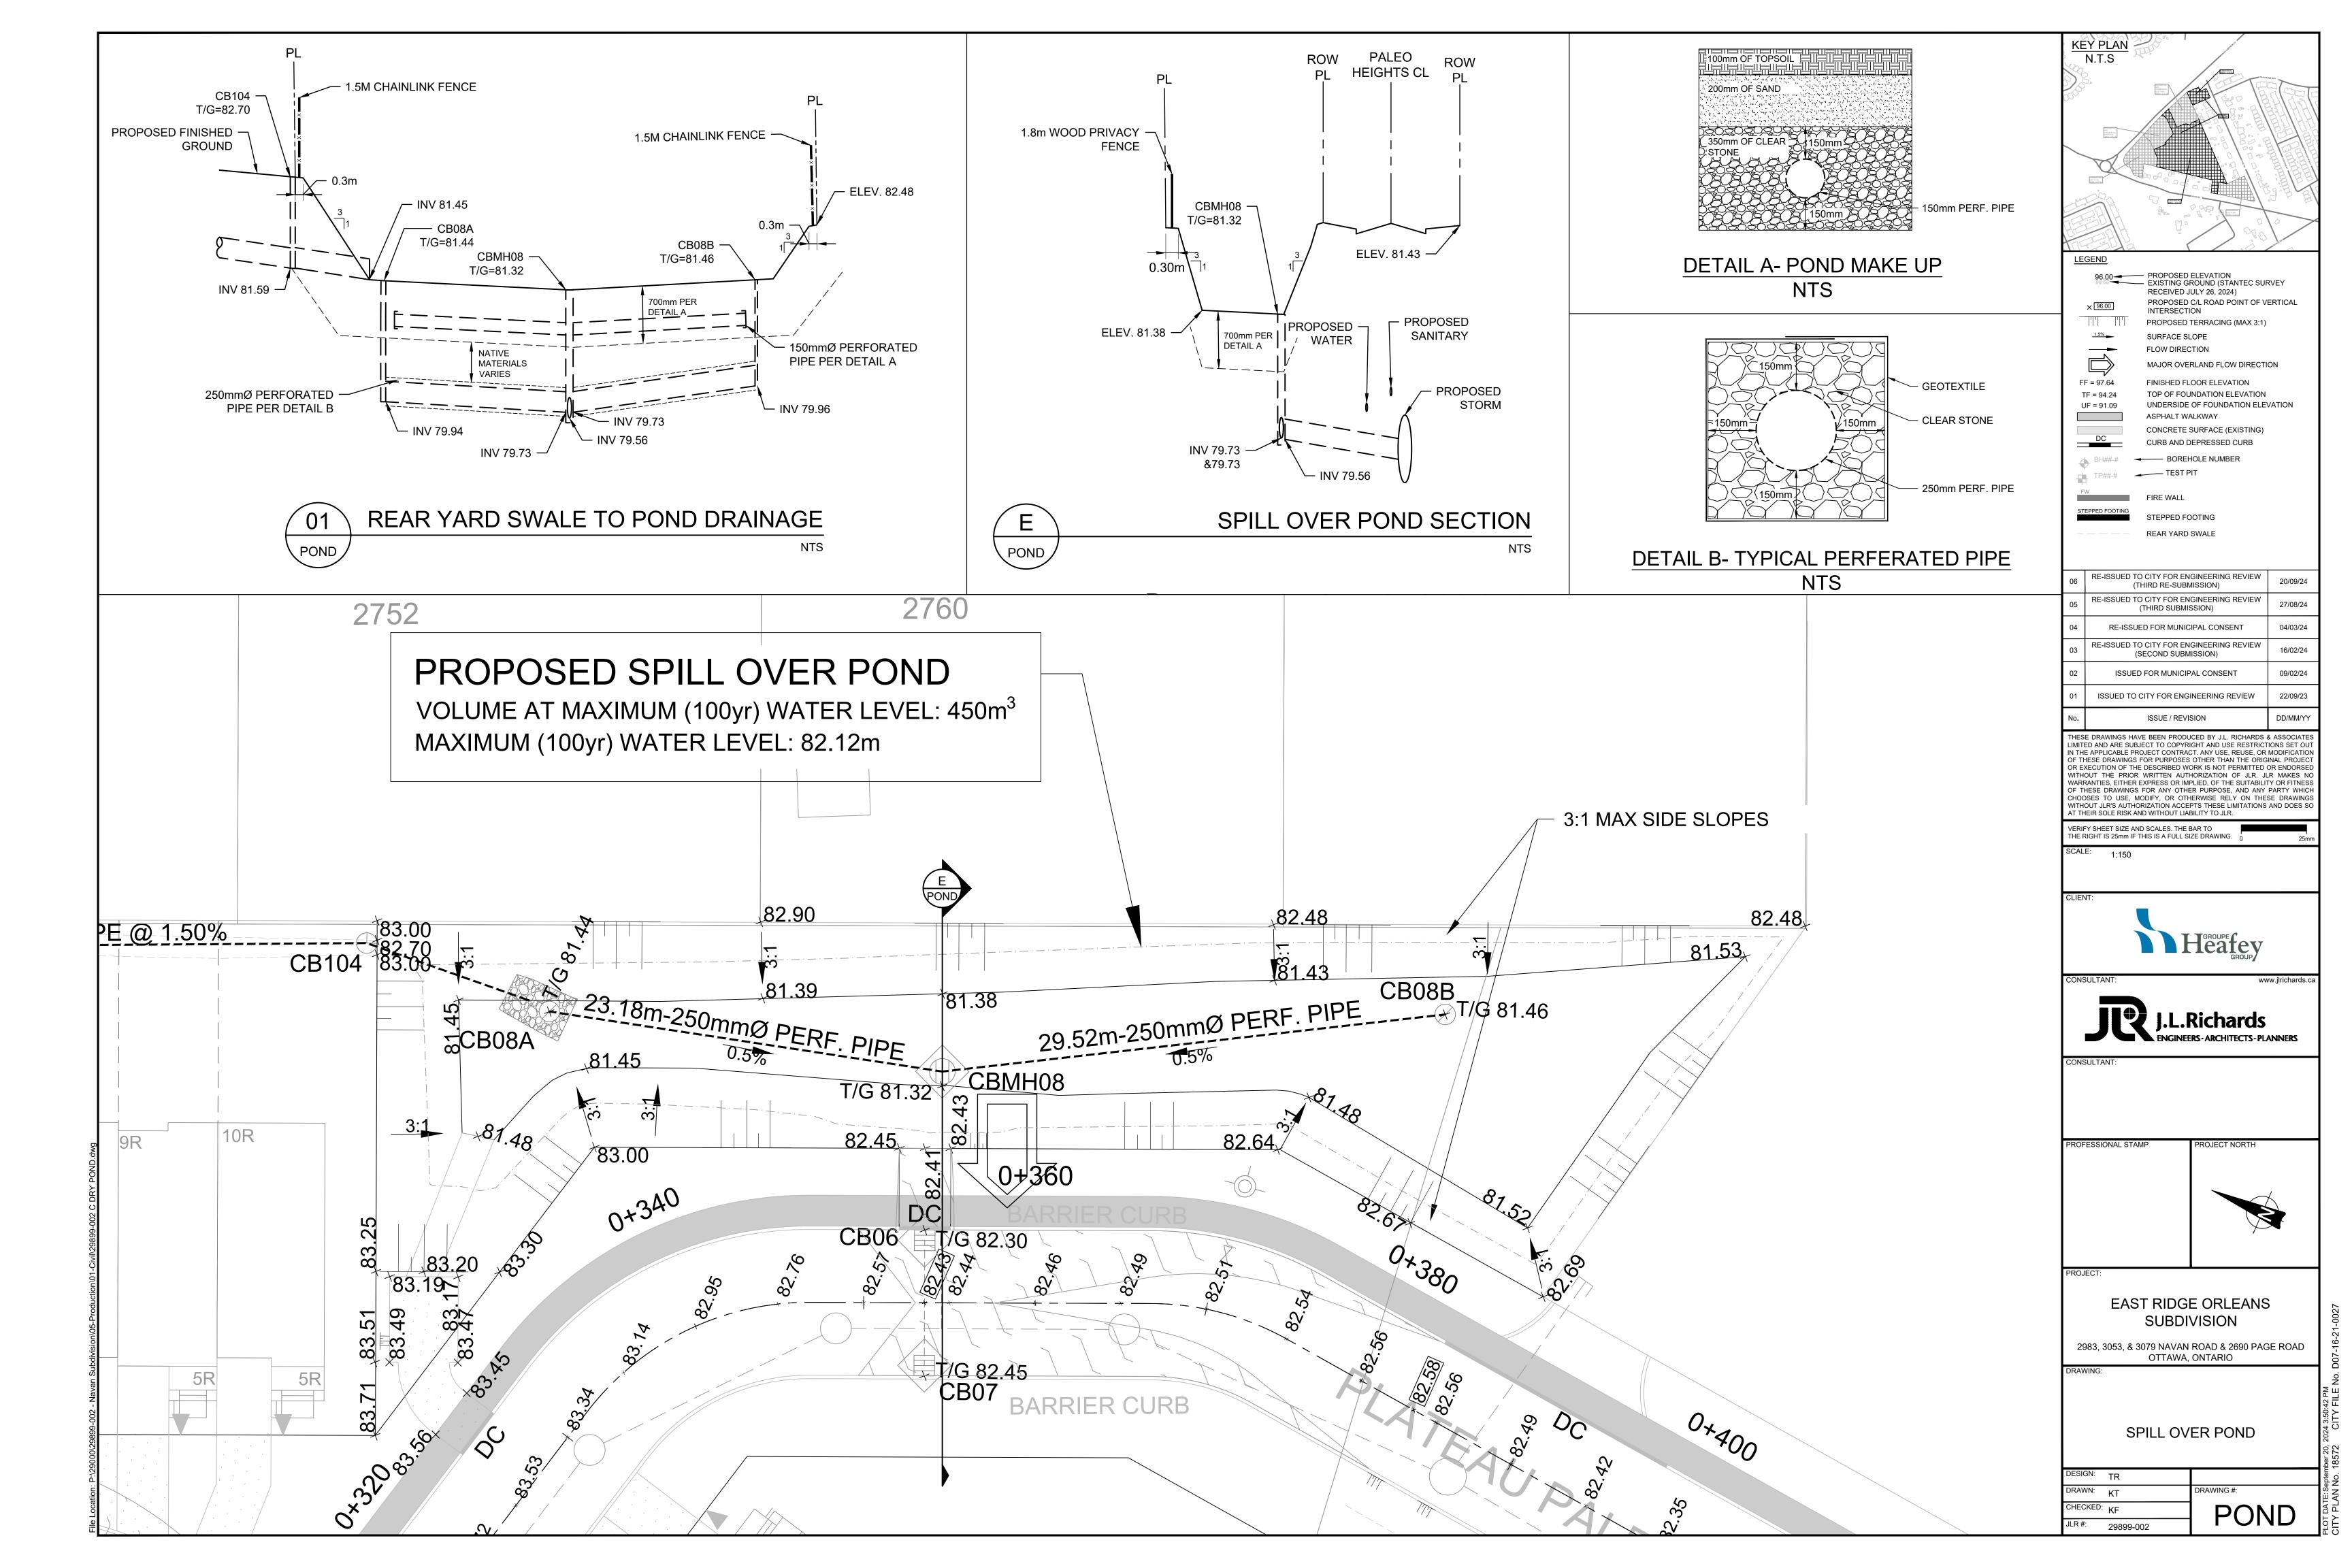


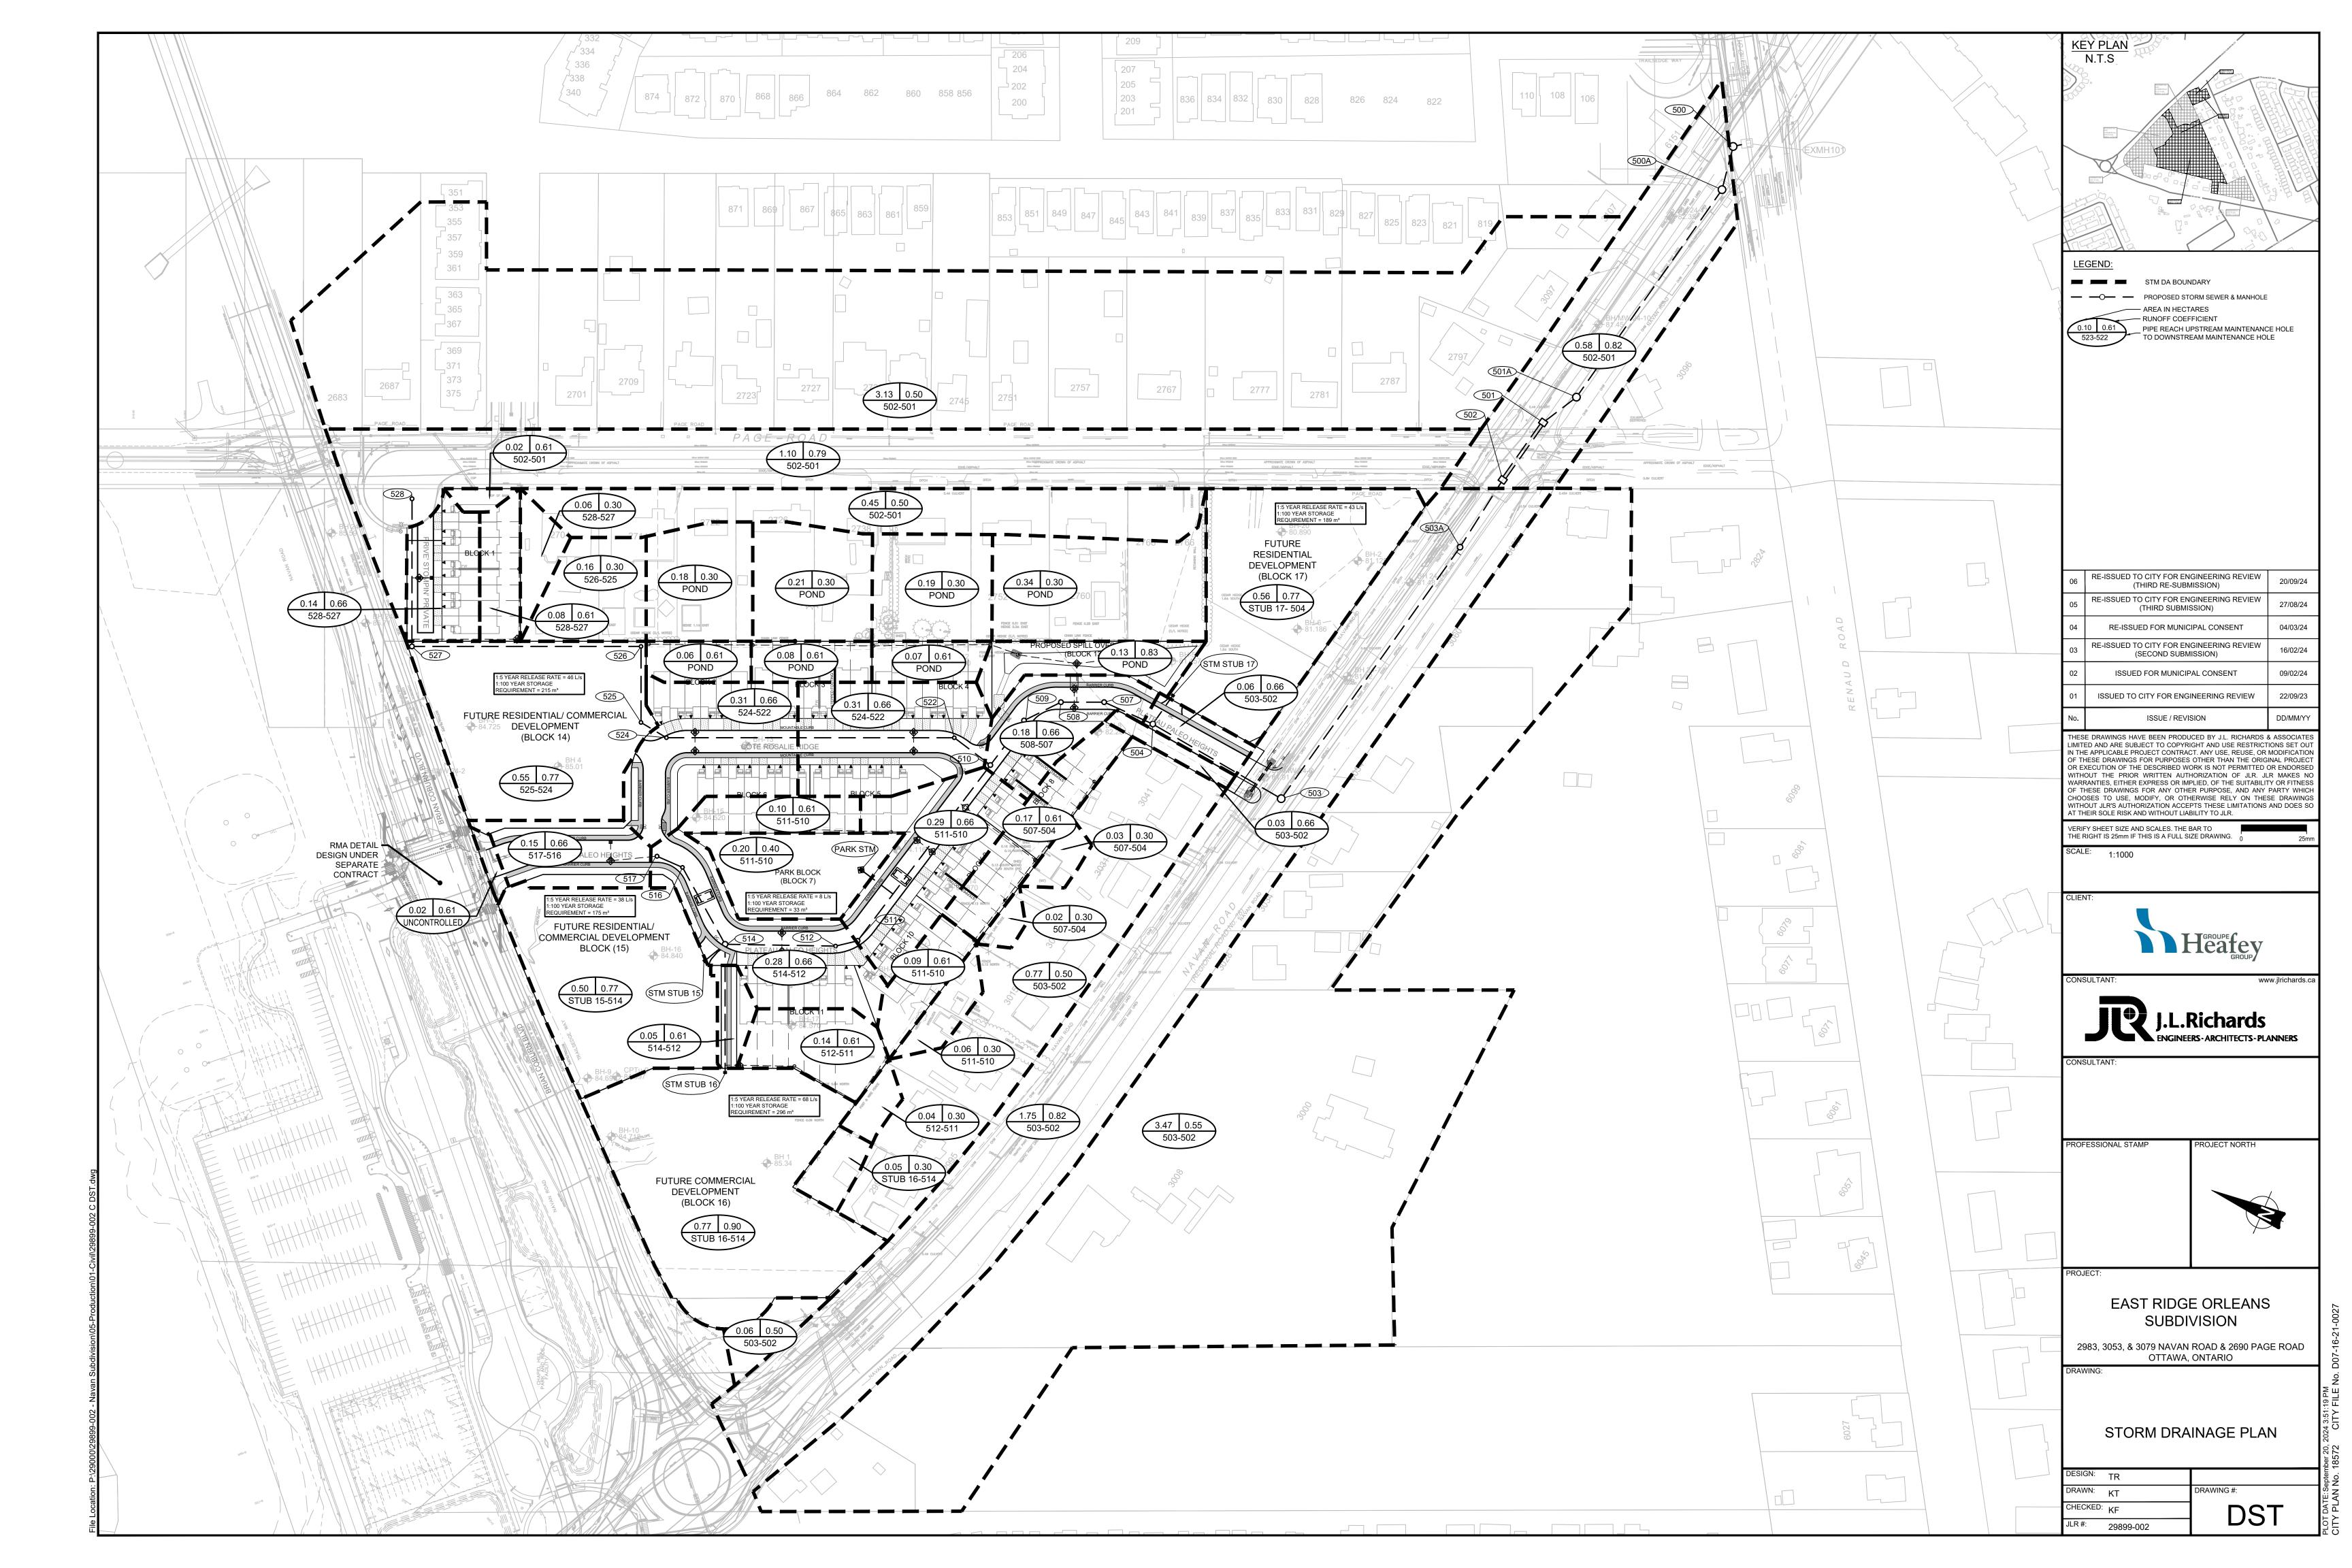

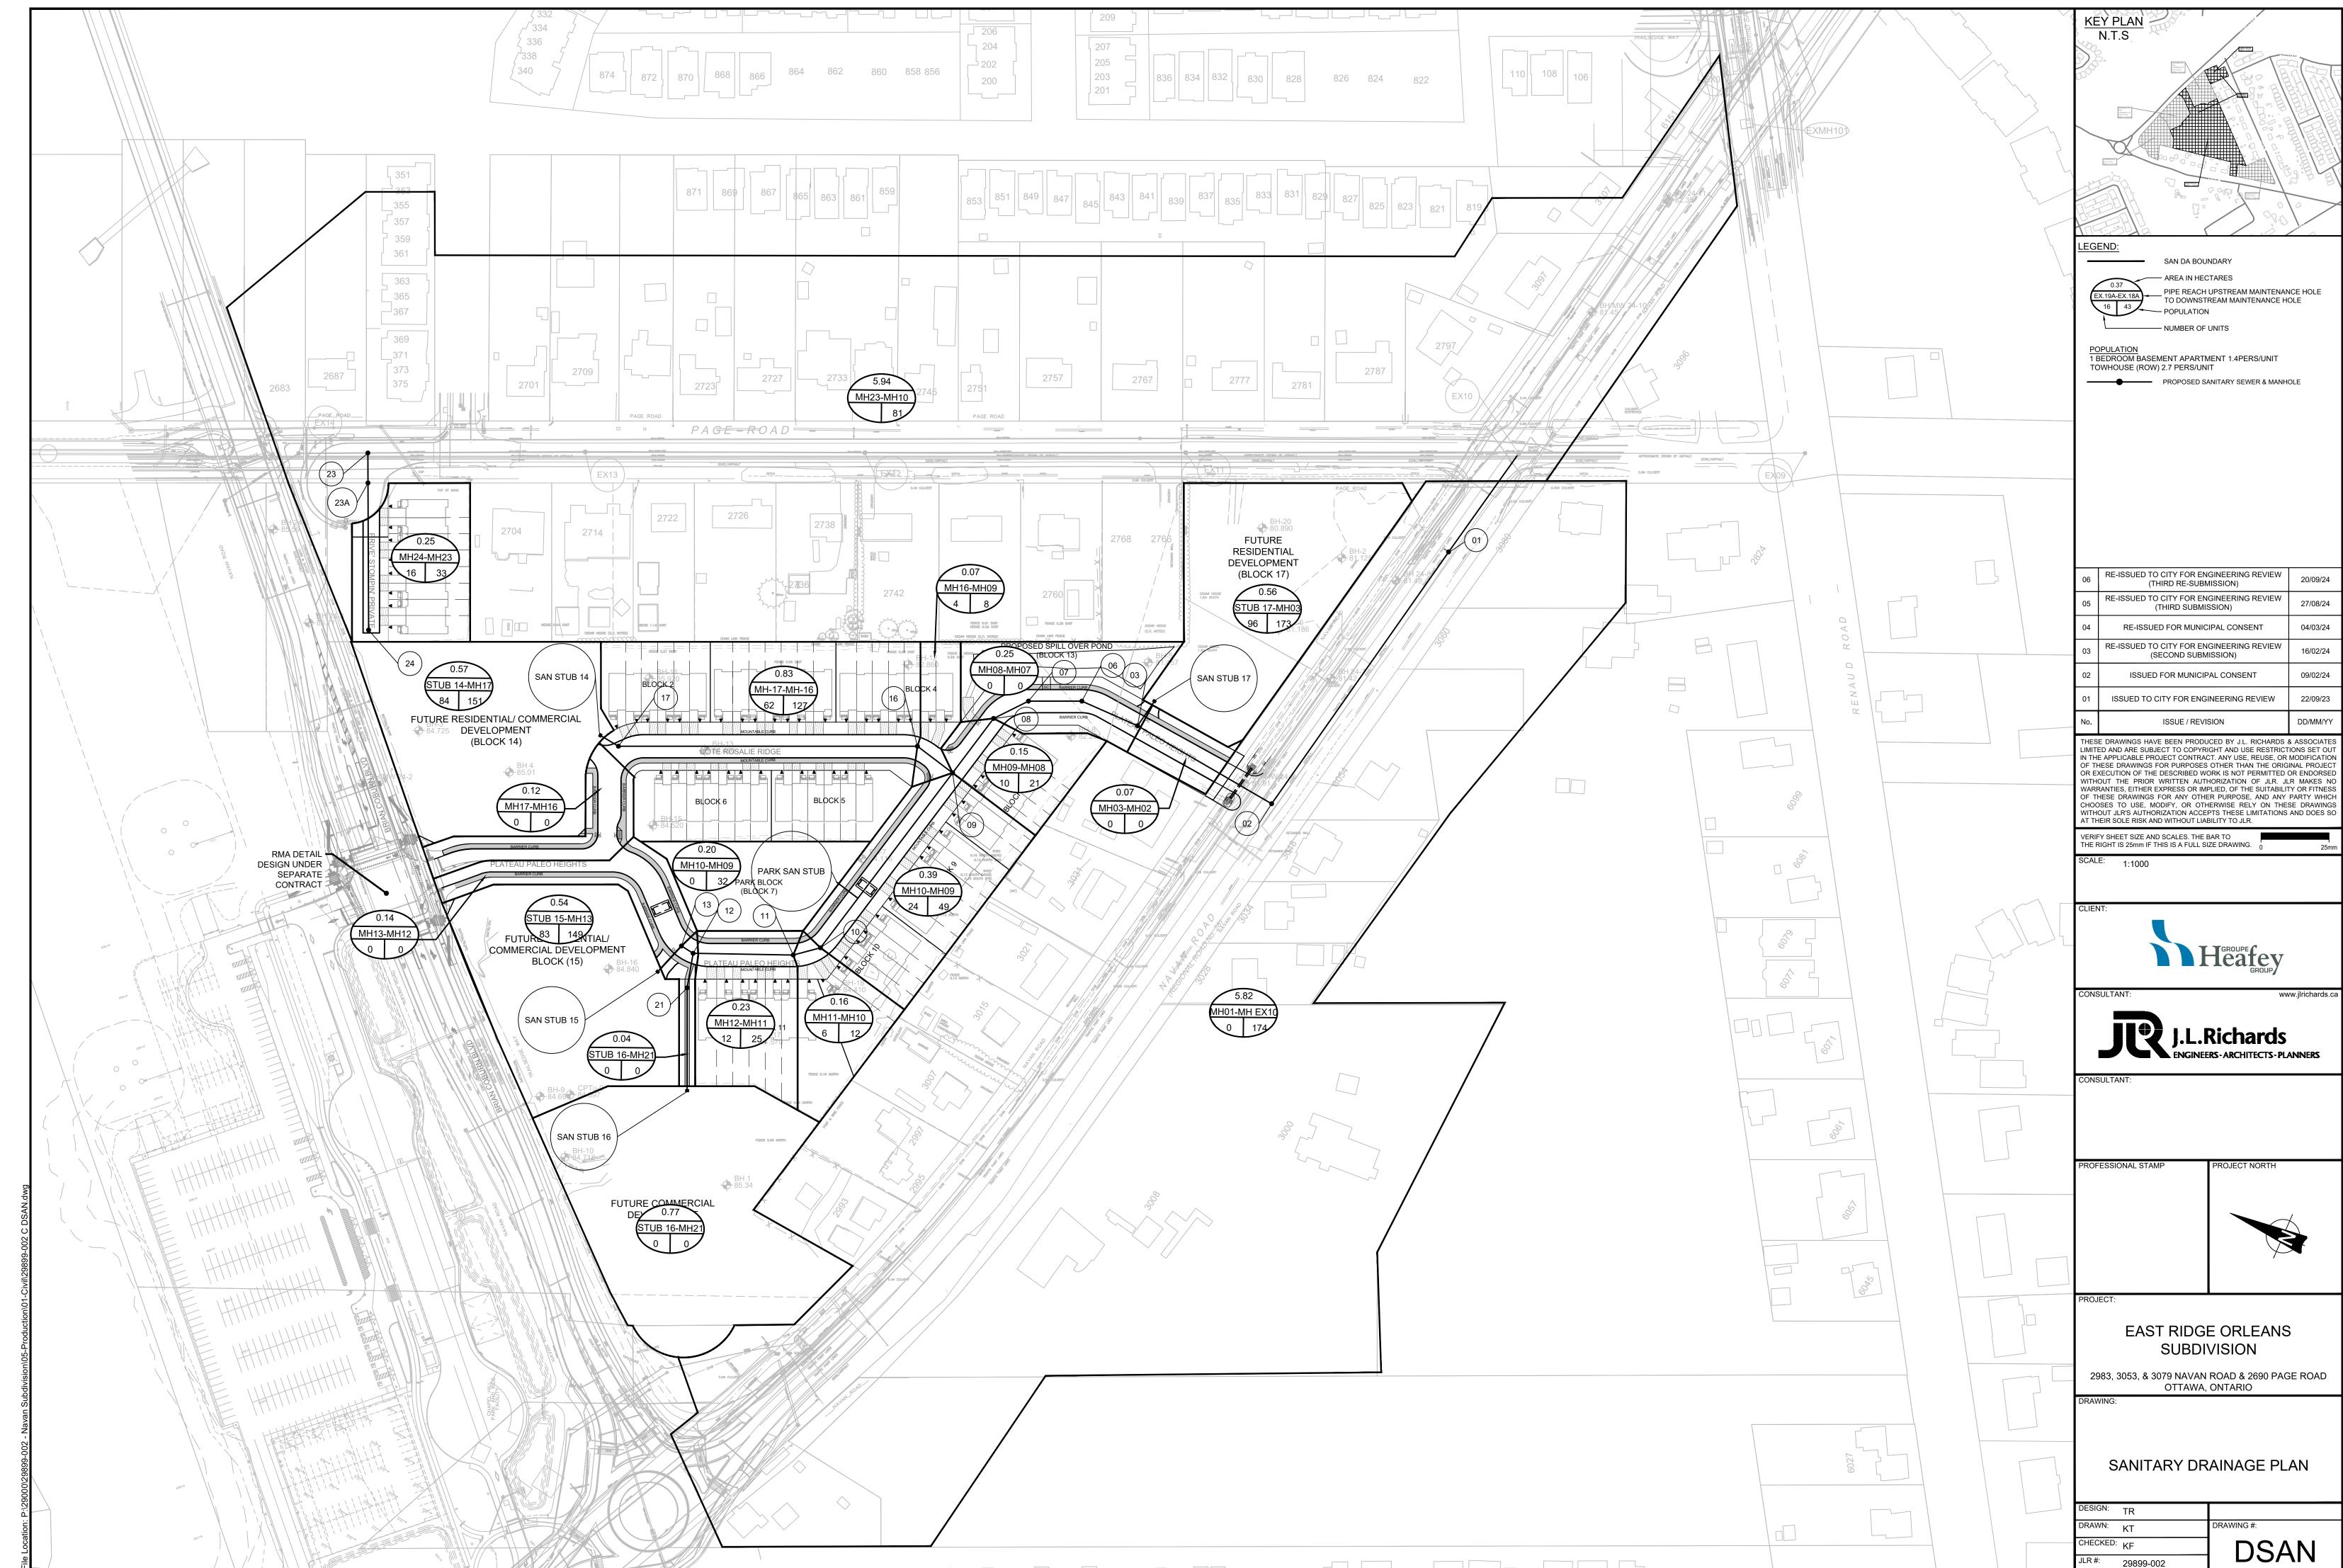


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	29899-002	

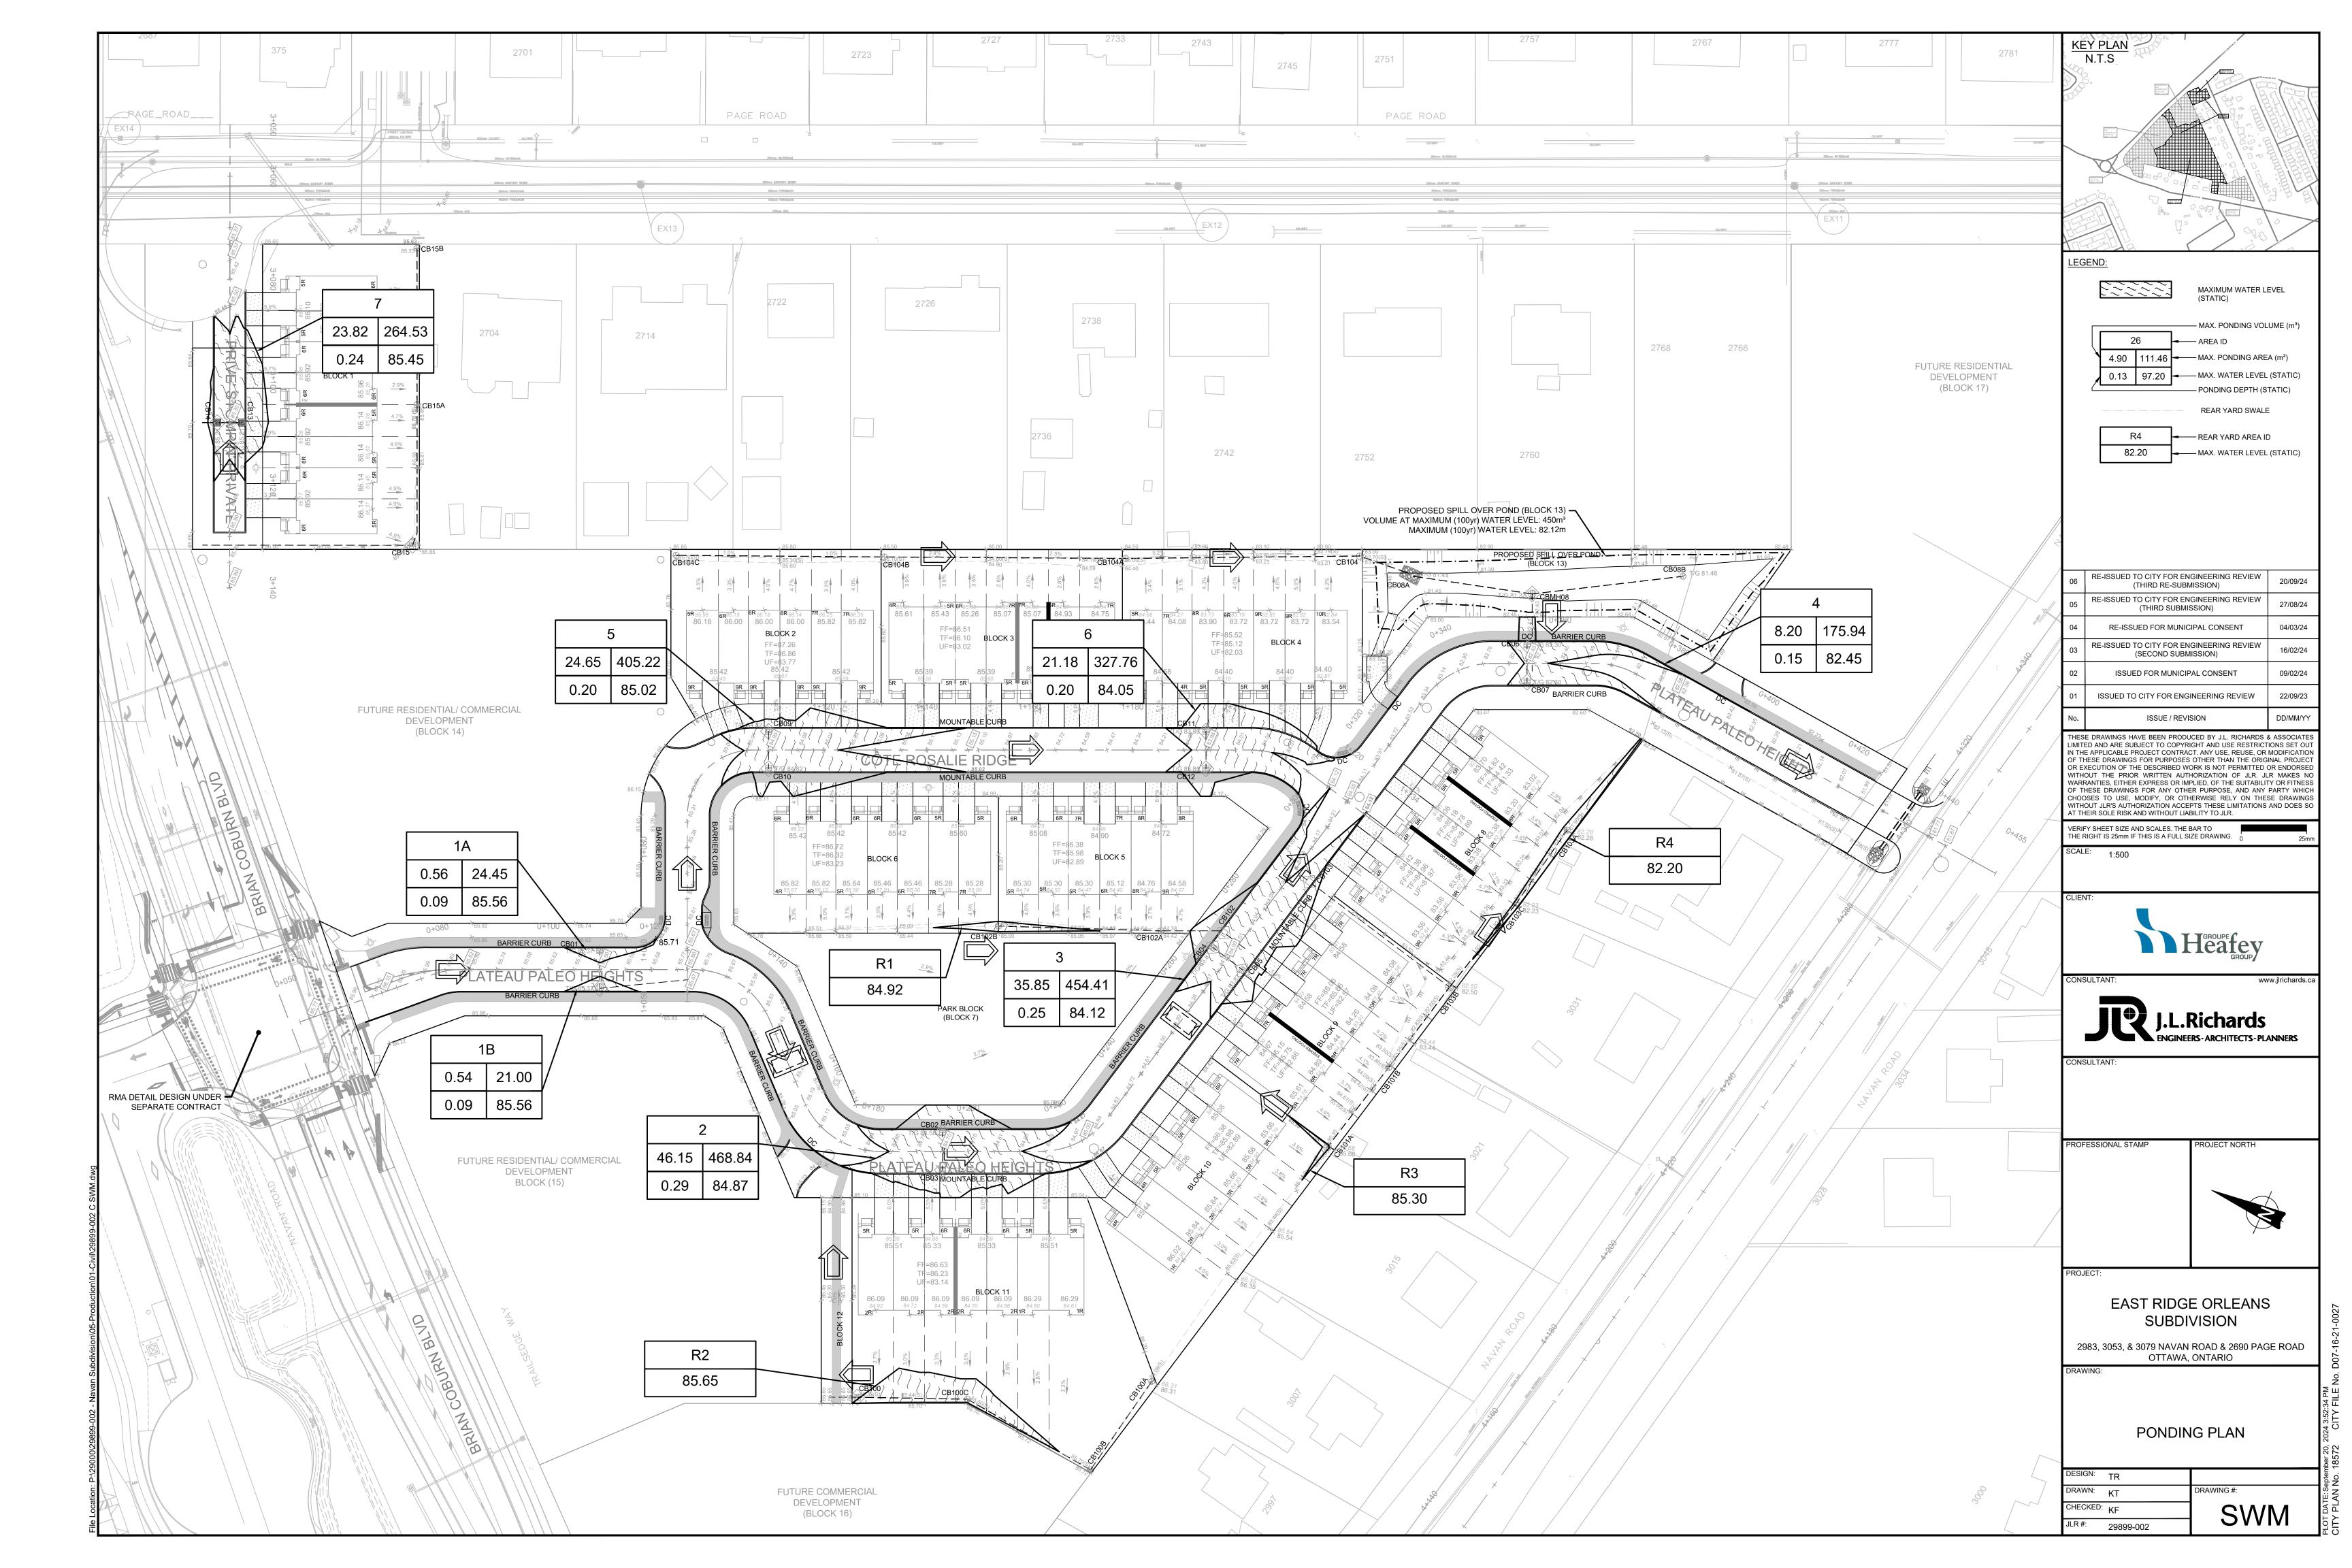


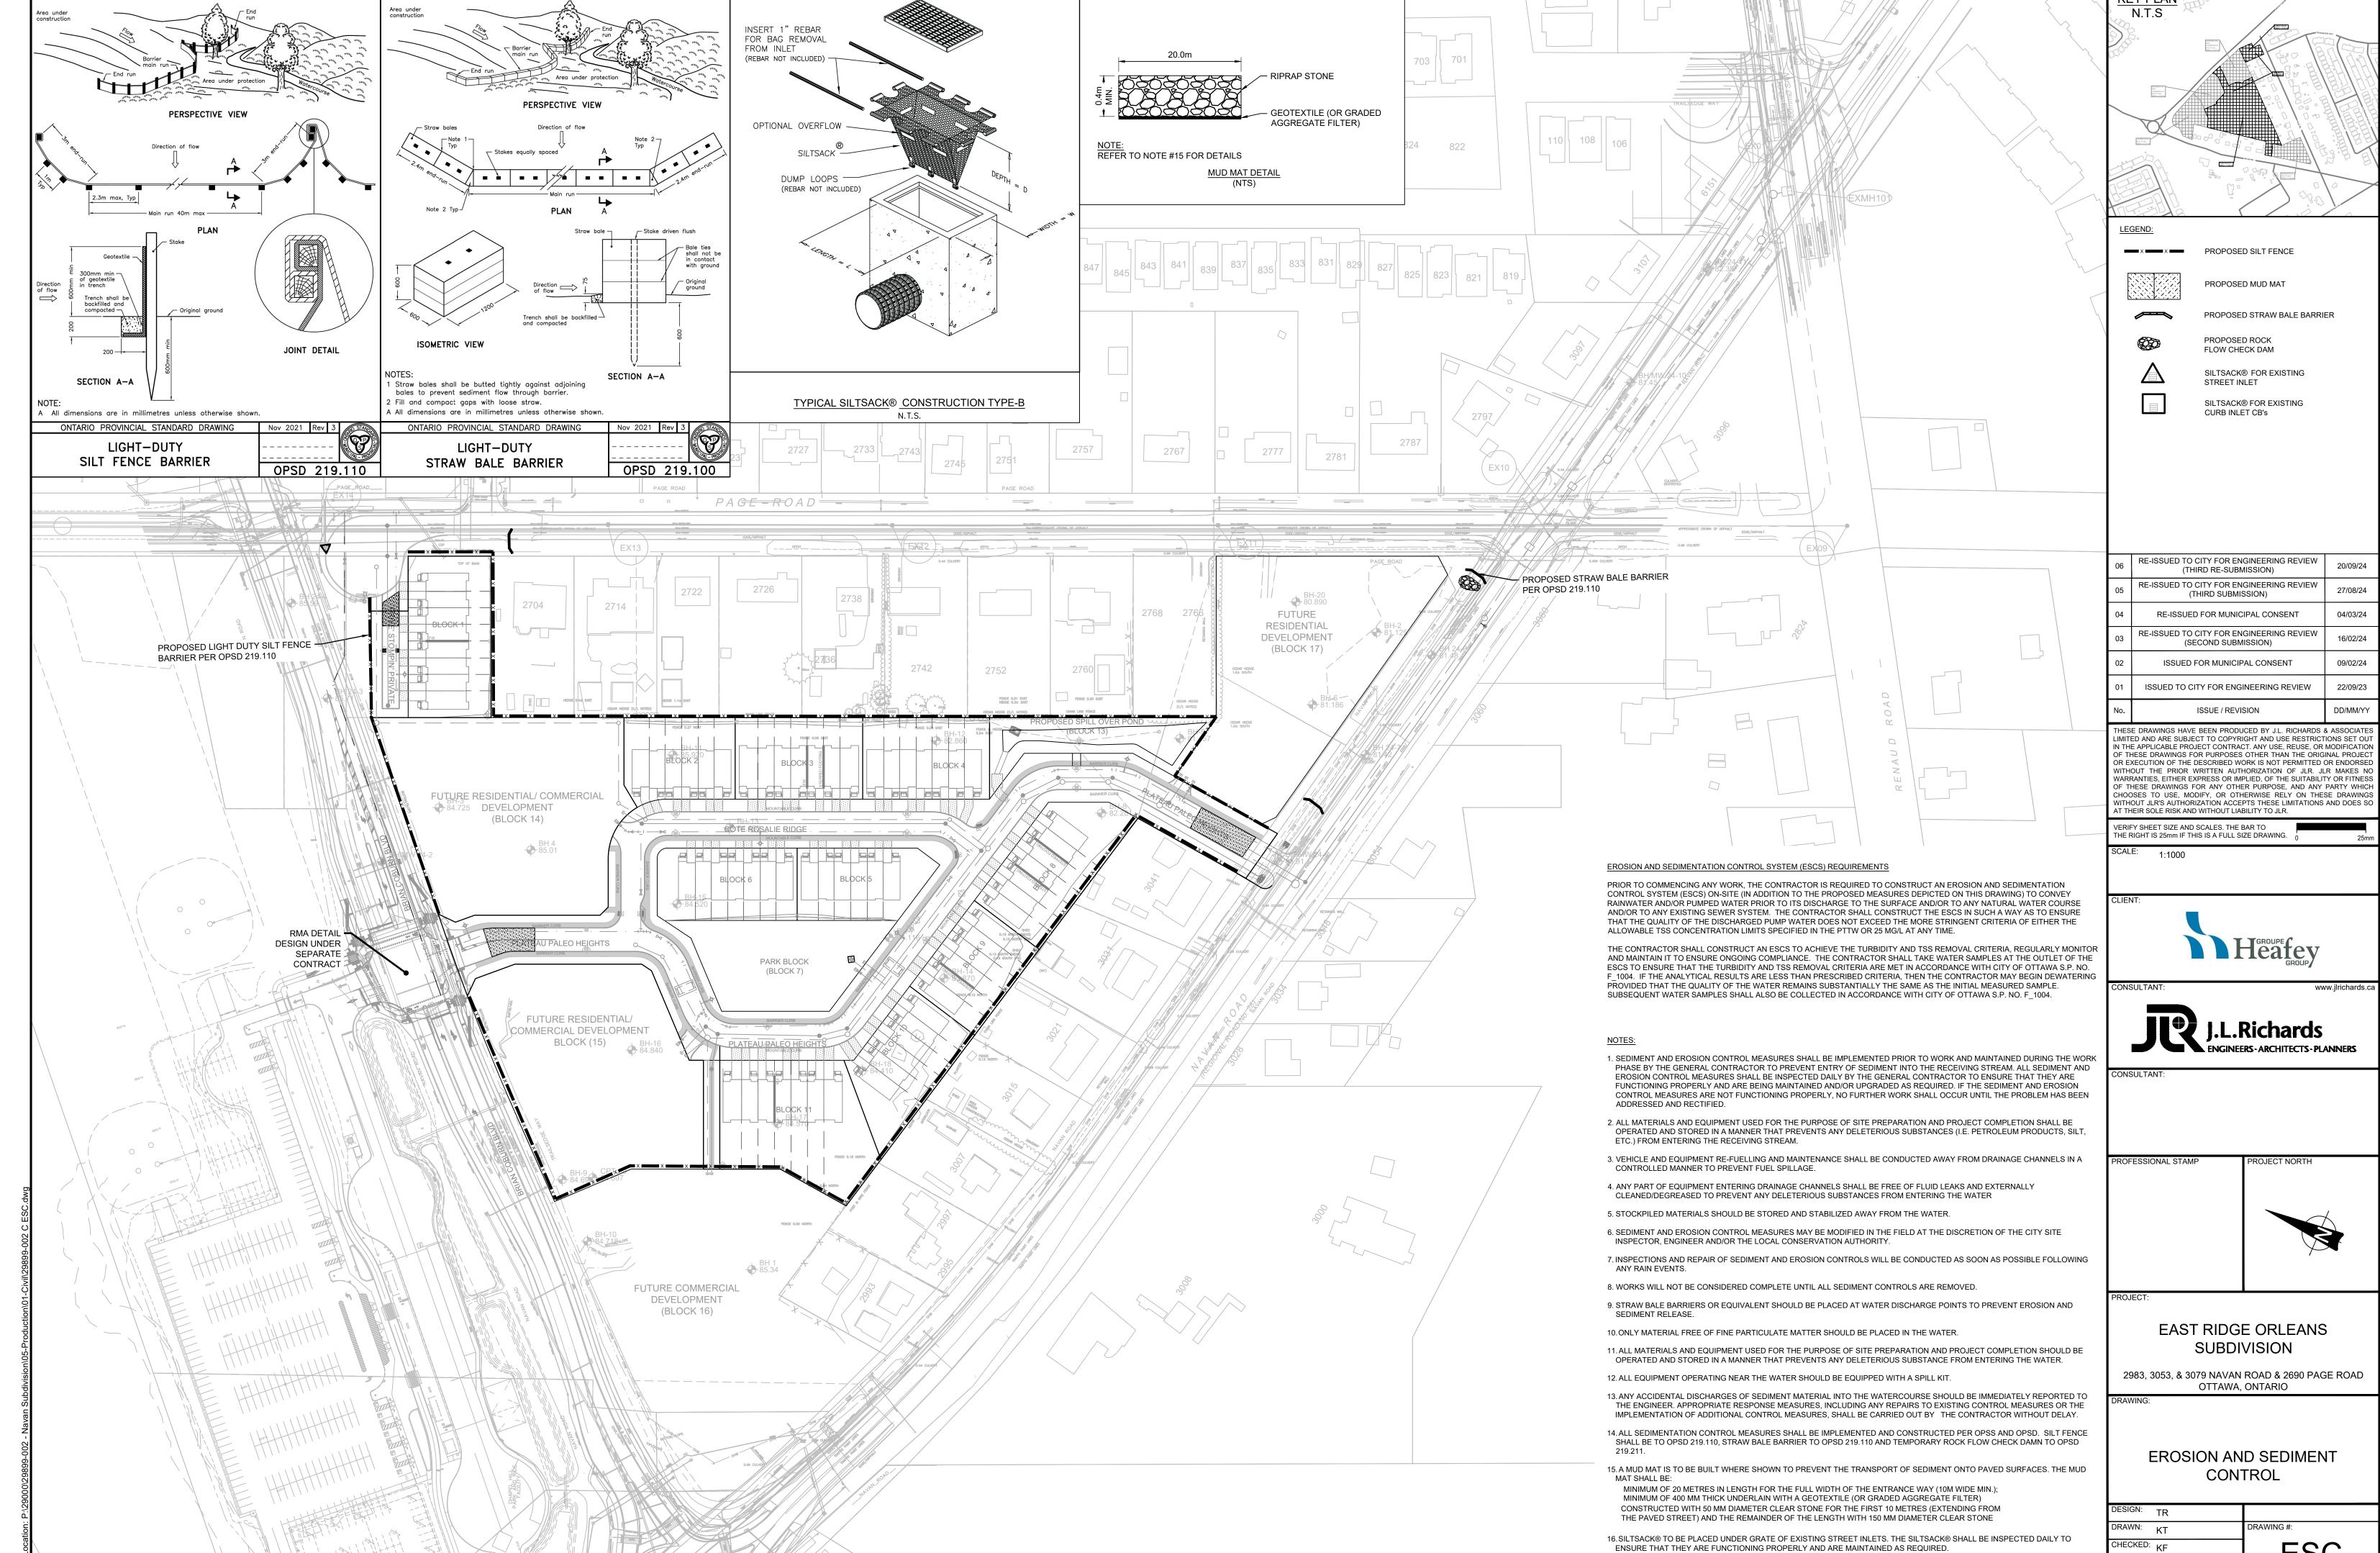



JLR #: 29899-002


ENSURE THAT THEY ARE FUNCTIONING PROPERLY AND ARE MAINTAINED AS REQUIRED.

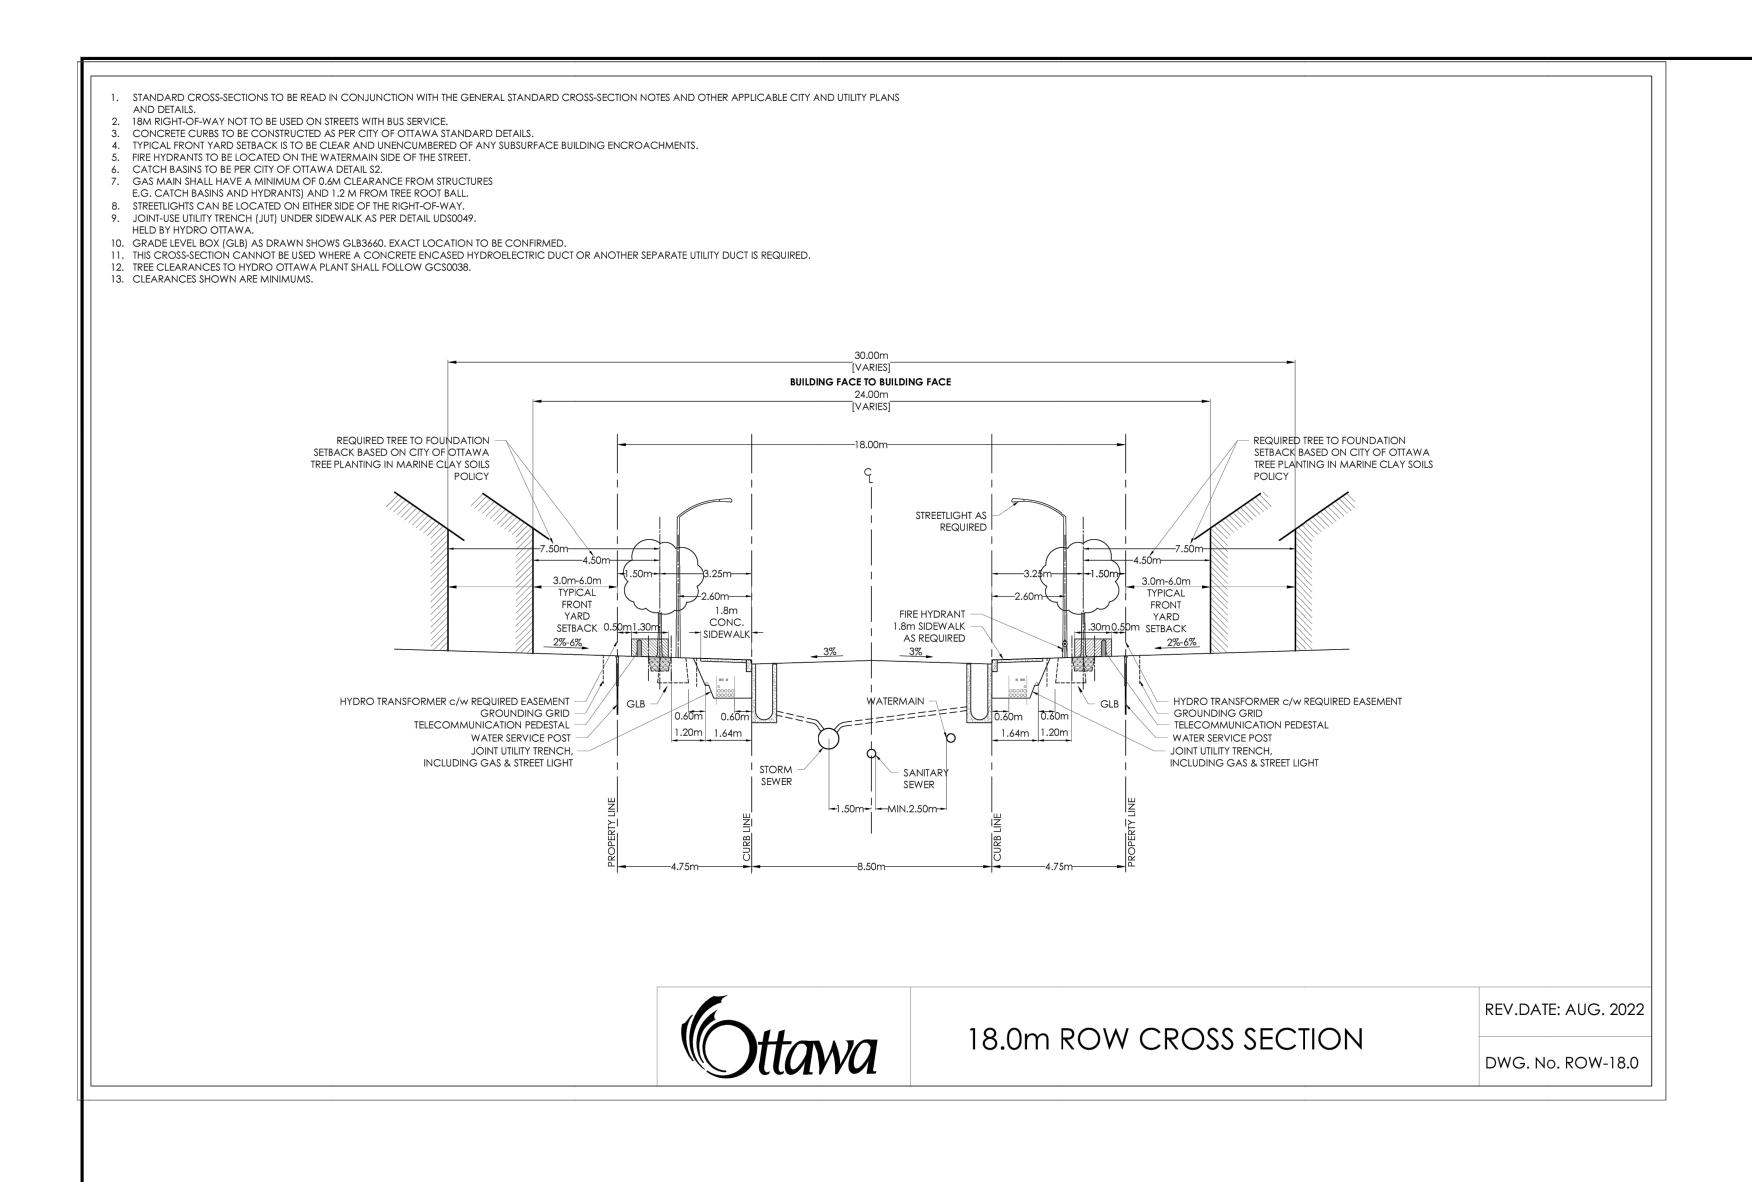


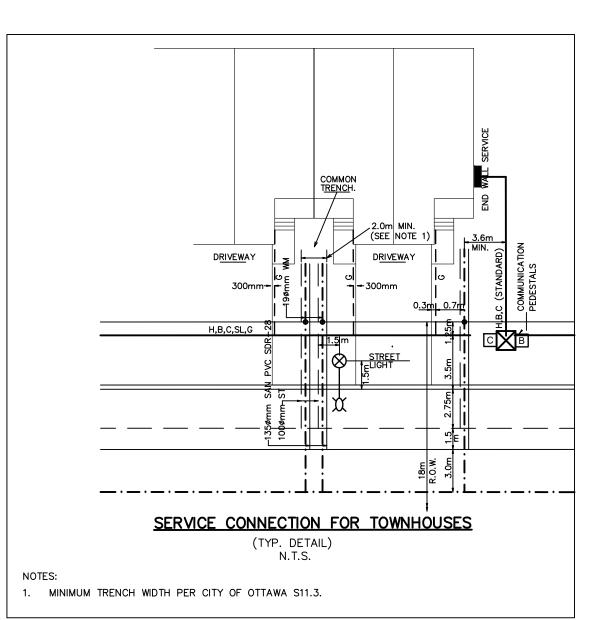


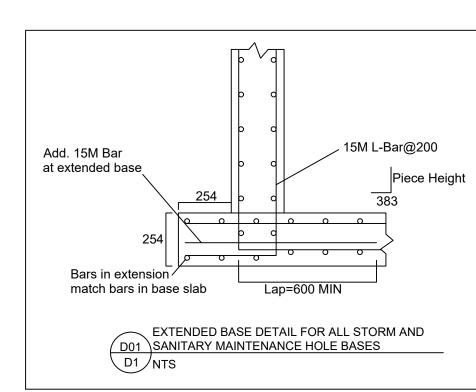


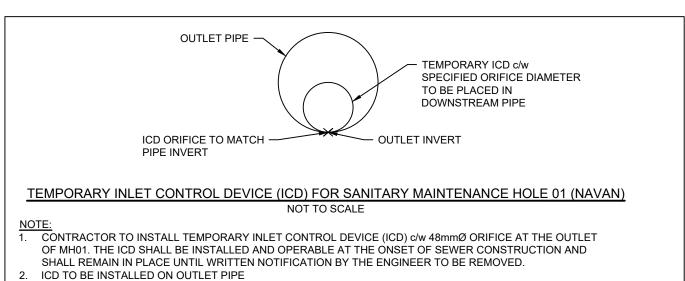

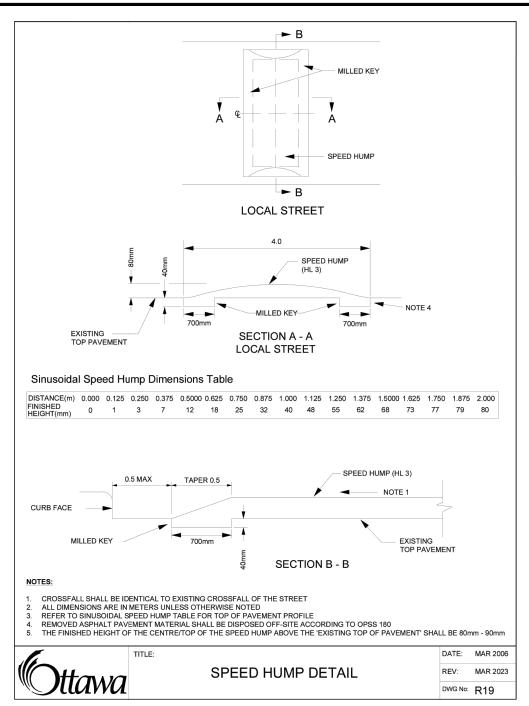

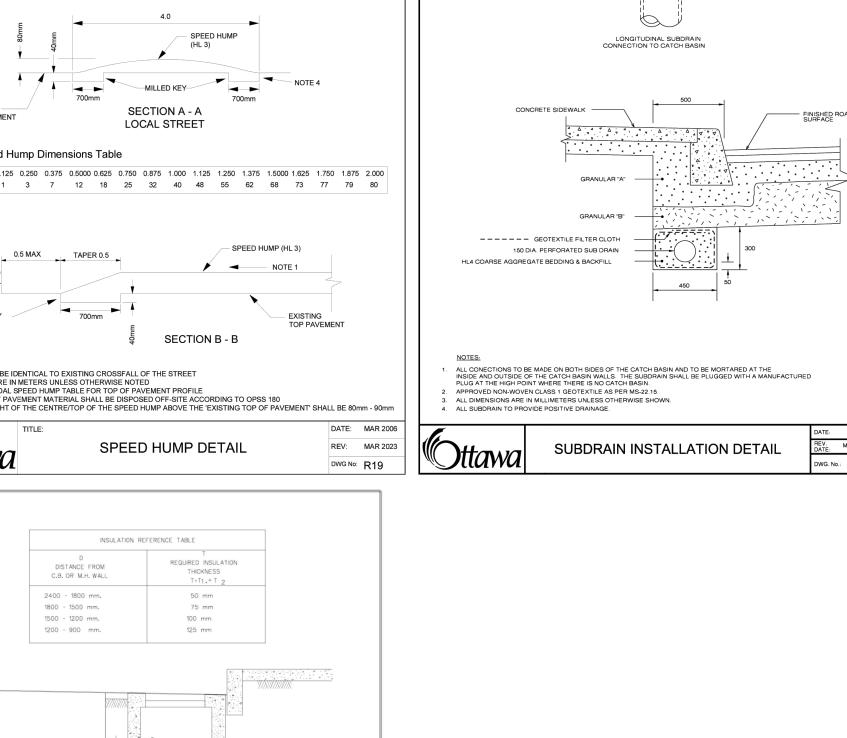


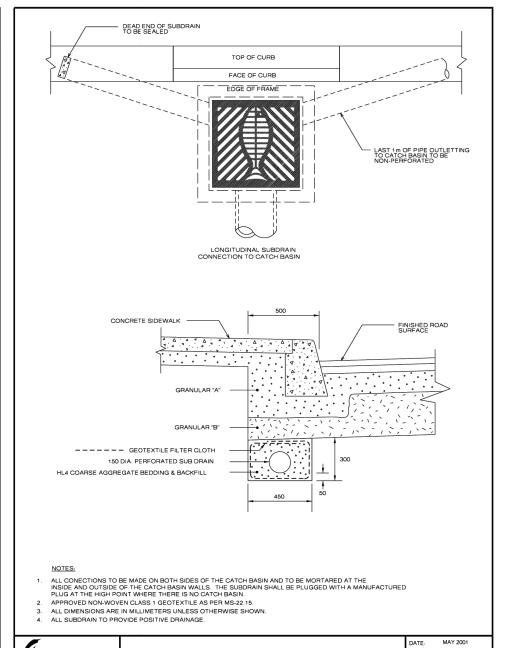

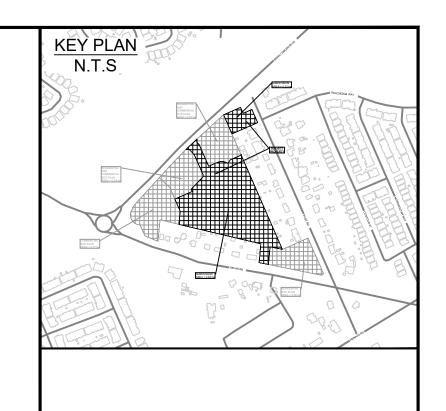

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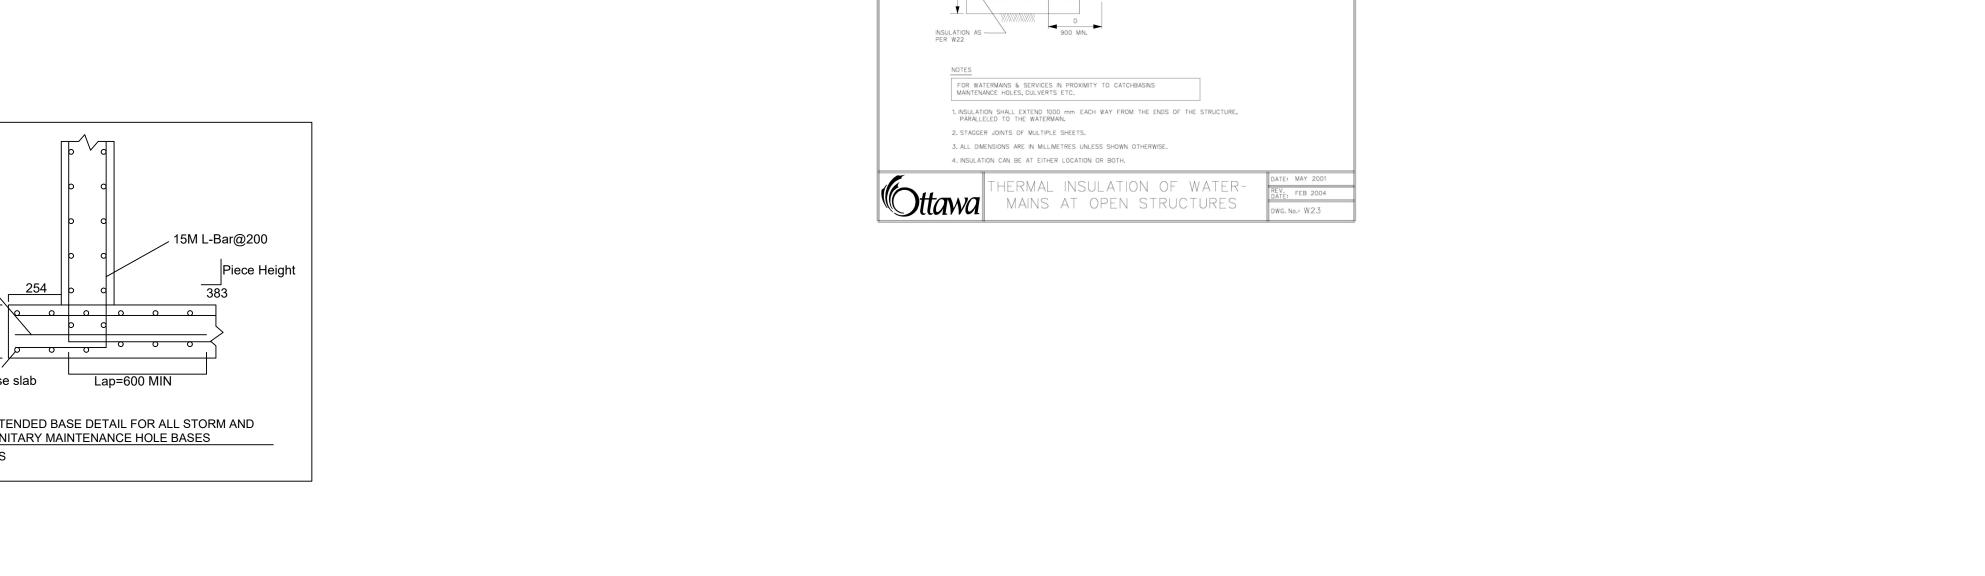
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EAST RIDGE ORLEANS SUBDIVISION

2983, 3053, & 3079 NAVAN ROAD & 2690 PAGE ROAD OTTAWA, ONTARIO

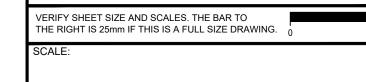
DETAILS AND CROSS SECTIONS

DRAWN: KT RAWING #: CHECKED: KF JLR #: 29899-002



Street Name	CB ID Number	T/G	Inlet		Outlet		Rational Method Capture Rate	Max Depth (100 yr) (m)	1:100 Yr Restricted Capture Rate	ICD TYPE
			Pipe Dia. (mm)	Invert	Pipe Dia. (mm)	Invert	(85 L/s/ha)	(Excel)	(L/s)	
	CB01	85.37	-	-	200	84.07	-	-	-	NO ICD
	CBMH517A	85.37	200	84.00	250	83.94	13.00	1.61	12.00	Vortex_ICD_105
	CB02	84.58	-	-	200	83.18	11.00	1.59	11.00	Vortex_ICD_100
PALEO DRIVE	CB03	84.58	-	-	200	83.18	16.00	1.59	23.00	MHF_IPEX_TYPE_
PALEO DRIVE	CB04	83.87	-	-	200	82.47	12.50	1.64	13.00	Vortex_ICD_105
	CB05	83.87	-	-	200	82.47	12.50	1.64	13.00	Vortex_ICD_105
	CB06	82.3	-	-	200	80.90	7.50	1.54	12.00	Vortex_ICD_105
	CB07	82.3	-	-	200	80.90	7.50	1.54	12.00	Vortex_ICD_105
	CB09	84.82	-	-	200	83.42	13.00	1.63	12.00	Vortex_ICD_105
ROSALIA	CB10	84.82	-	-	200	83.42	13.00	1.63	12.00	Vortex_ICD_105
STREET	CB11	83.85	-	-	200	82.45	13.00	1.64	13.00	Vortex_ICD_105
	CB12	83.85	-	-	200	82.45	13.00	1.64	13.00	Vortex_ICD_105
TOMPIN' TOM	CB13	85.21	-	-	200	83.81	-	-	-	NO ICD
LANE	CB14	85.21	200	83.76	250	83.70	20.00*	1.67	23.00	MHF_IPEX_TYPE_
EASEMENT	STOMP_TOM_ICD	85.68	675	81.53	300	81.53	22.00	3.89	14.00	Vortex ICD 95

REAR YARD CATCH BASIN TABLE														
Street Name	CB ID Number	T/G	Inlet					Outlet				Drop (m)	1:100 Yr Restricted Capture Rate	ICD TYPE
			Pipe Dia. (mm)	Pipe Length (m)	Slope	Invert	Cover	Pipe Dia. (mm)	Pipe Length (m)	Invert	COVER (m)		(L/s)	
BLOCK 1	CB15B	85.33	-	-	-	-	-	250	30.41	83.880	1.20		-	NO ICD
	CB15A	85.78	250	30.41	0.5%	83.728	1.80	250	27.48	83.728	1.80		-	NO ICD
	CB15	85.50	250	27.48	0.5%	83.591	1.66	250	40.83	83.591	1.66		14.00	Vortex_ICD_105
BLOCK 11	CB100A	86.08	-	-	-	-	-	250	20.91	84.330	1.50		-	NO ICD
	CB100B	85.70	250	20.91	1.0%	84.118	1.33	250	27.56	84.118	1.33		-	NO ICD
	CB100C	85.53	250	27.56	0.8%	83.885	1.40	250	21.46	83.885	1.40		-	NO ICD
	CB100	85.30	250	21.46	1.2%	83.627	1.42	250	5.50	83.627	1.42		47.00	MHF_IPEX_TYPE_C
BLOCK 2, 3, 4	CB104C	85.50	-	-	-	-	-	250	40.46	83.650	1.60		-	NO ICD
	CB104B	85.10	250	40.46	1.0%	83.226	1.62	250	46.92	83.226	1.62		-	NO ICD
	CB104A	84.00	250	46.92	2.0%	82.288	1.46	250	46.44	82.288	1.46		ı	NO ICD
	CB104	82.70	250	46.44	1.5%	81.587	0.86	250	10.05	81.587	0.86		ı	NO ICD
POND	CB08A	81.44	-	-	-	-		250	23.18	79.940	1.25		-	NO ICD
	CB08B	81.46	-	-	-	-		250	29.52	79.960	1.25		-	NO ICD
	CBMH08	81.32	250 250	23.18 29.52	0.9% 0.8%	79.728 79.728	1.34 1.34	250	14.99	79.558	1.51	0.17	6.00	Vortex ICD 65
BLOCK 5	CB102B	84.62		-	-	_		250	31.60	82.970	1.40		-	NO ICD
	CB102A	84.38	250	31.60	1.0%	82.654	1.48	250	11.77	82.654	1.48		_	NO ICD
	CB102	83.89	250	11.77	2.0%	82.419	1.22	250	4.51	82.419	1.22		8.00	Vortex_ICD_80
BLOCK 8 & 9	CB101A	85.15	-	-	-	-		900	19.61	81.490	2.76		_	NO ICD
	CB101B	83.86	900	19.61	1.0%	81.294	1.67	900	19.48	81.294	1.67		_	NO ICD
	CB103A	81.90	-	-	=	-		300	17.39	80.650	0.95		_	NO ICD
	CB103C	82.08	300	17.39	0.5%	80.563	1.21	300	20.77	80.563	1.21		_	NO ICD
	CB103B	82.25	900	19.48 20.77	1.0%	81.099 80.459	0.25	250	33.45	80.399	1.60	0.06	-	NO ICD
	CB103	84.01	250	33.45	1.0%	80.057	3.70	250	1.60	80.057	3.70		59.00	MHF_IPEX_TYPE_D

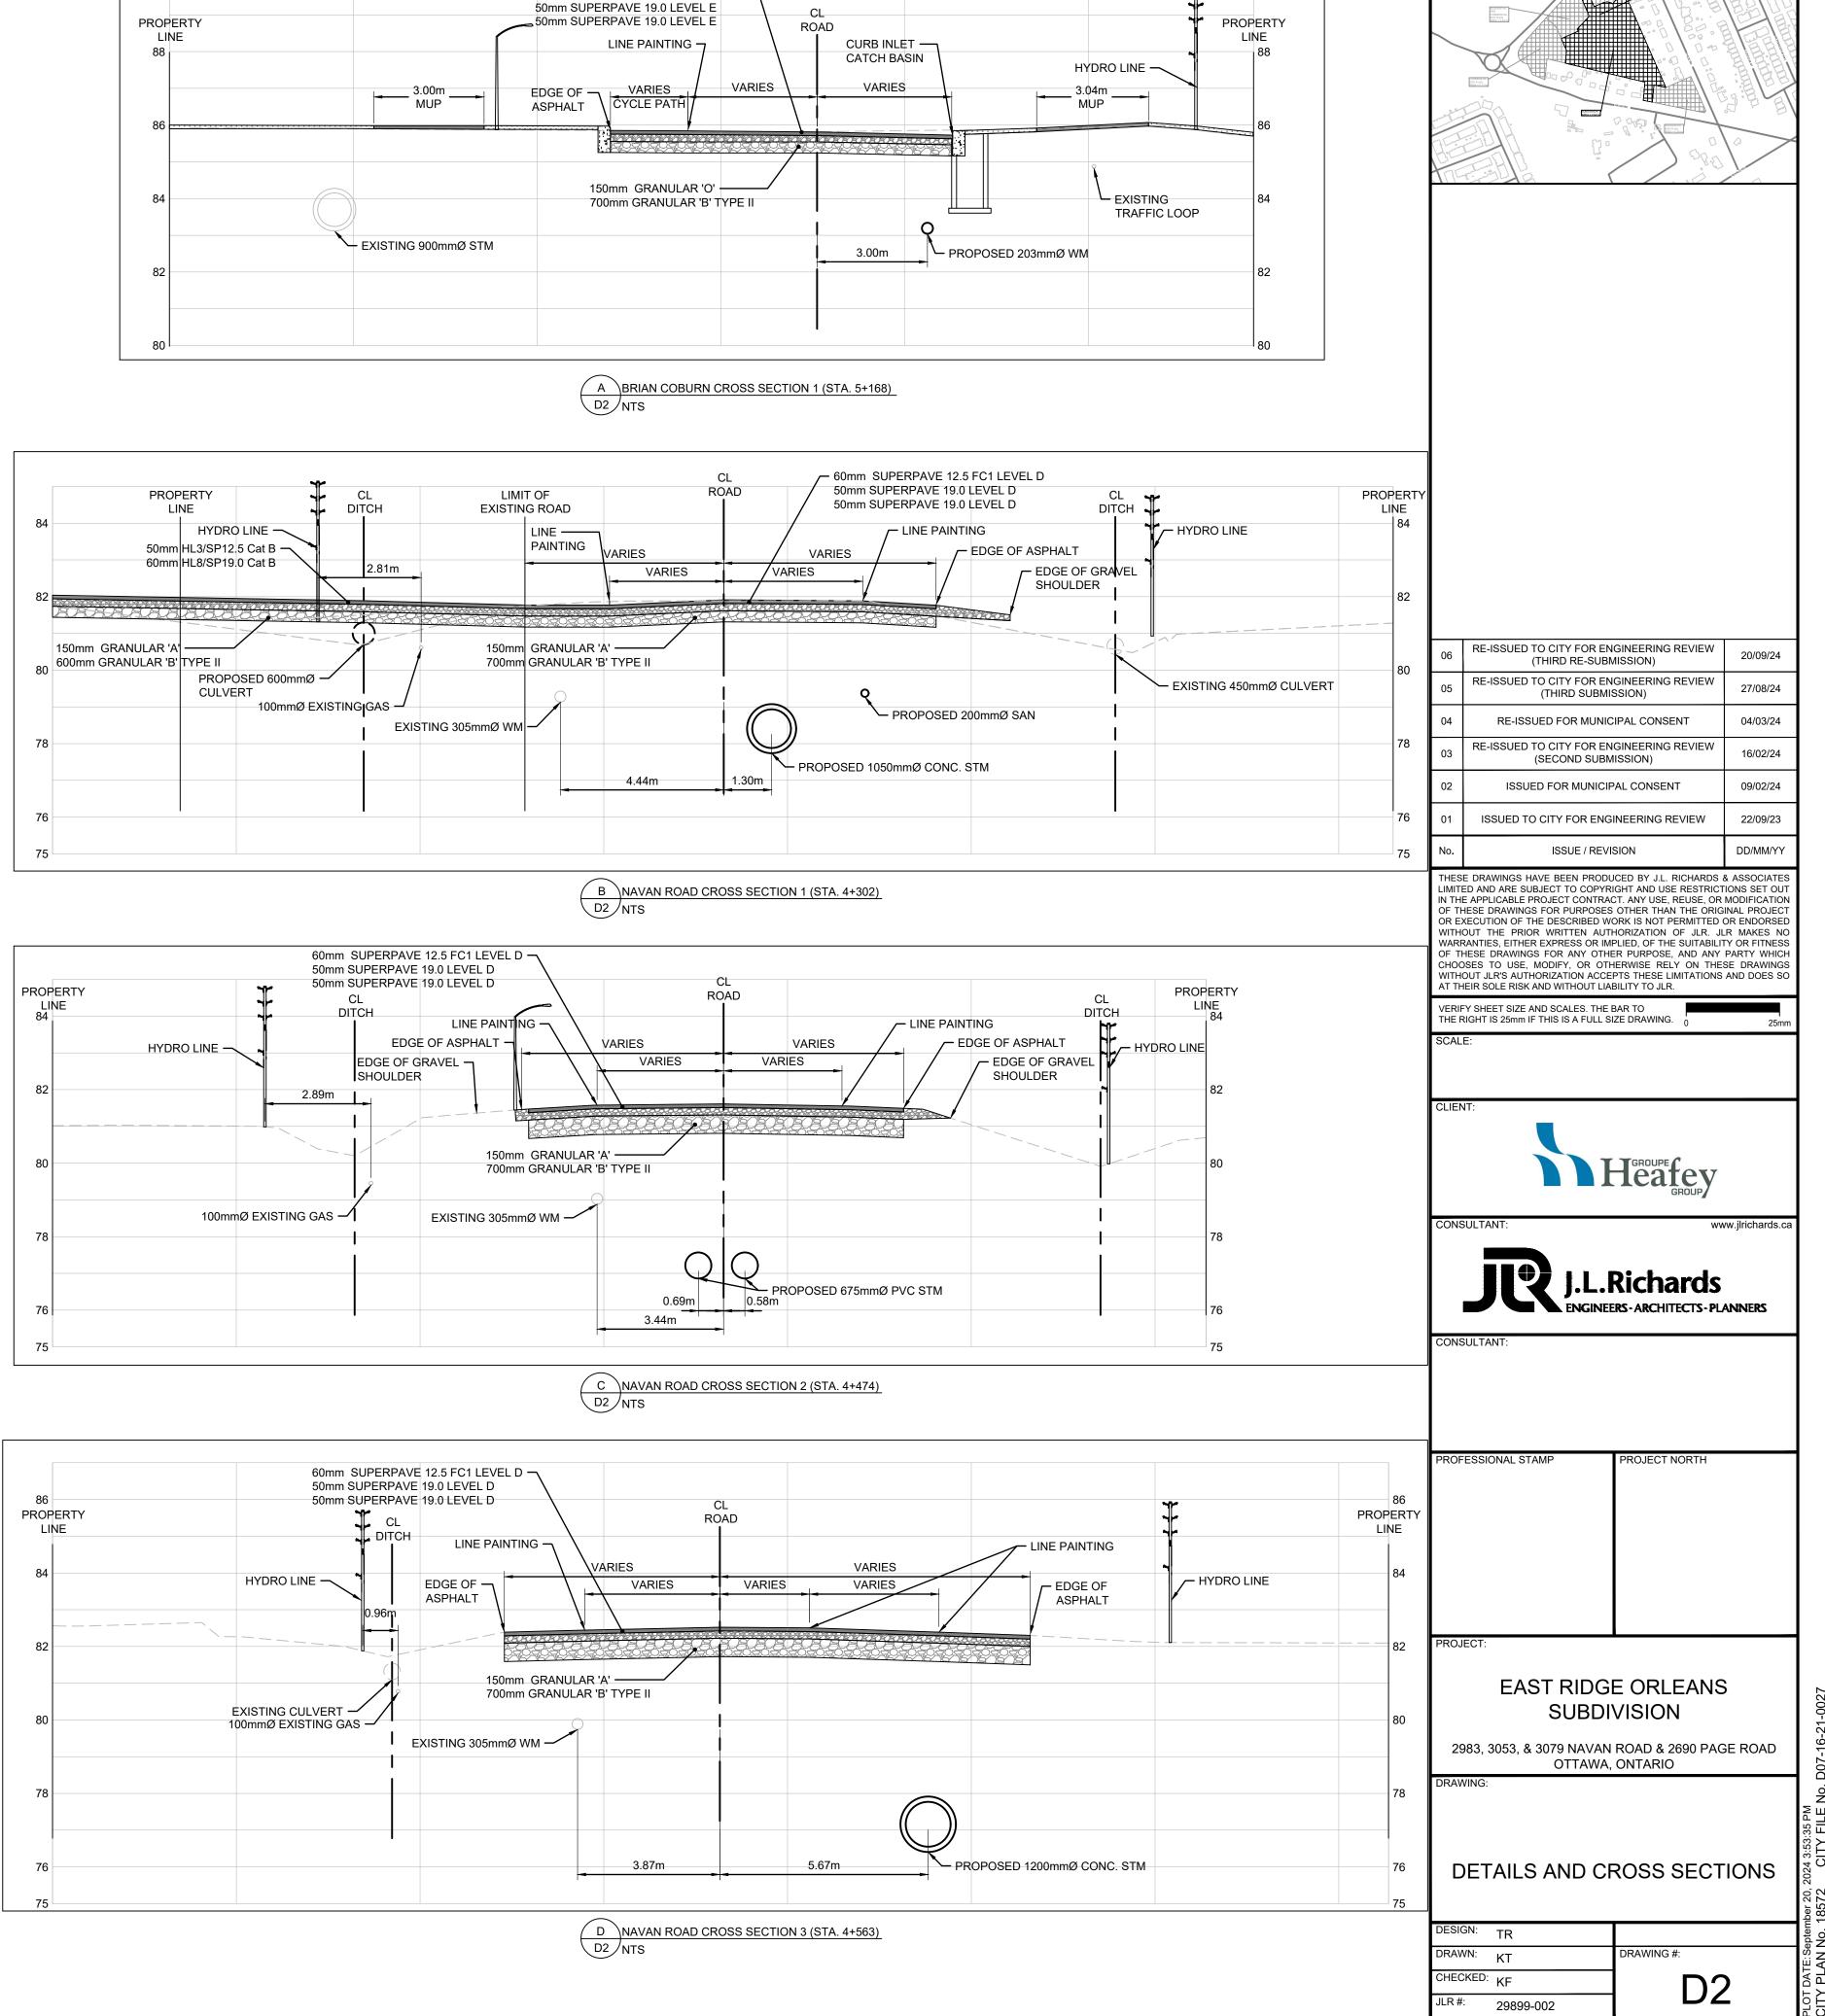

50mm SUPERPAVE 12.5 FC2 LEVEL E —

KEY PLAN N.T.S