HEAFEY GROUP 768 SAINT-JOSEPH BLVD SUITE 100 GATINEAU QC J8Y 4B8









EAST RIDGE ORLEANS SUBDIVISION				
DRAWING LIST				
Sheet Number	Sheet Title			
LEGEND	LEGEND SHEET			
OS	OVERALL SERVICING			
S1	SITE SERVICING PLAN			
S2	SITE SERVICING PLAN			
01	PALEO DRIVE			
02	PALEO DRIVE			
03	ROSALIA STREET			
04	NAVAN ROAD			
05	GAS BAR EASEMENT			
06	STOMPIN' TOM LANE & EASEMET			
07	BRIAN COBURN BOULEVARD			
G1	GRADING PLAN			
POND	SPILL OVER POND			
DST	STORM DRAINAGE PLAN			
DSAN	SANITARY DRAINAGE PLAN			
SWM	PONDING PLAN			
ESC	EROSION AND SEDIMENT CONTROL			
D1	DETAILS AND CROSS SECTIONS			
D2	DETAILS AND CROSS SECTIONS			


EAST RIDGE ORLEANS SUBDIVISION

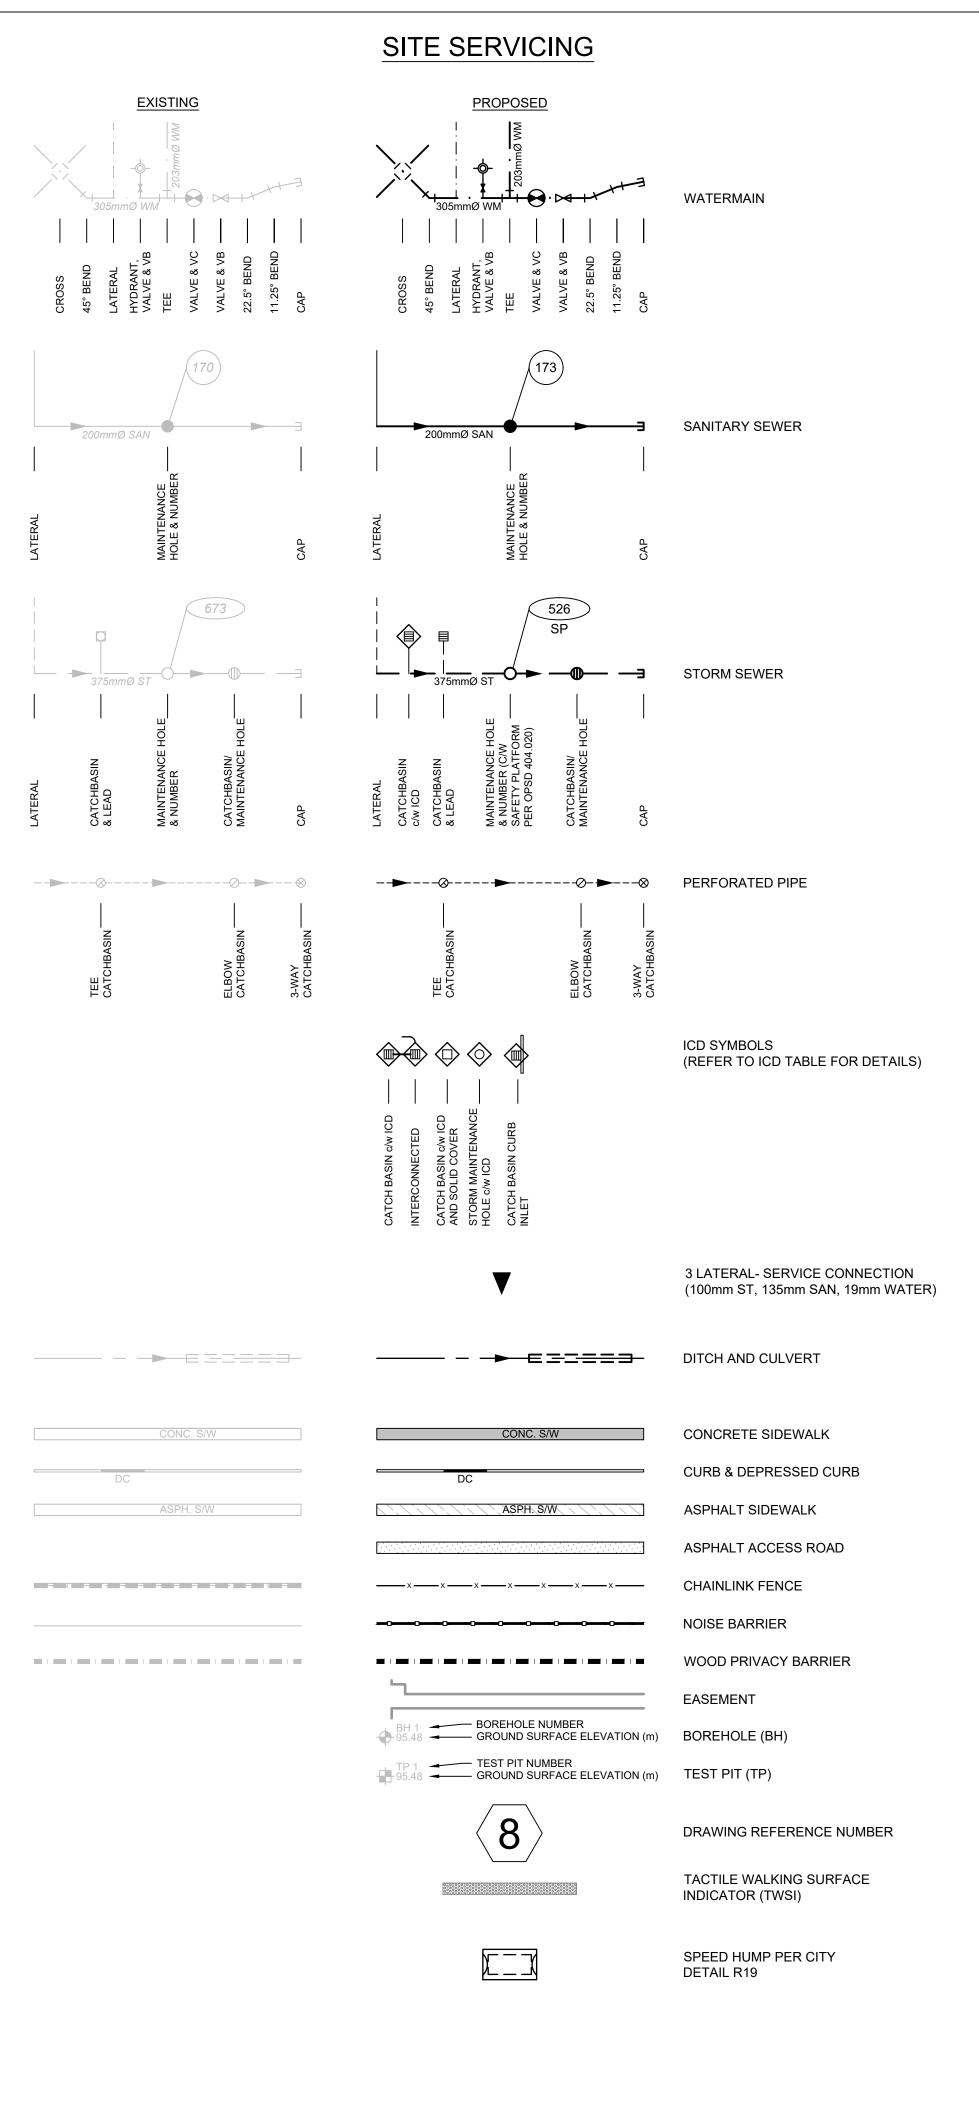


GRADING

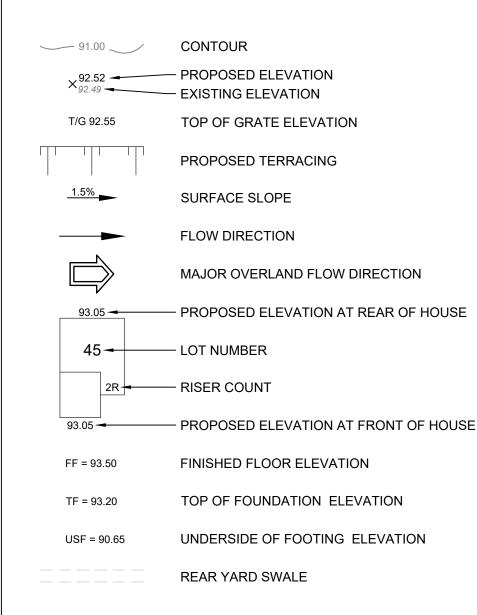


SANITARY DRAINAGE

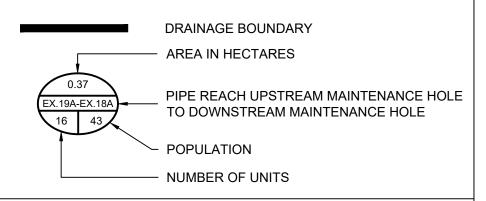


STORM DRAINAGE

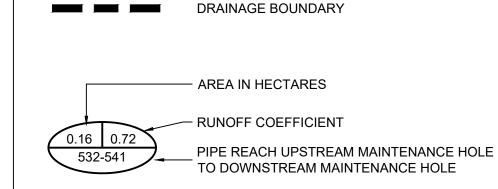

PONDING (URBAN)

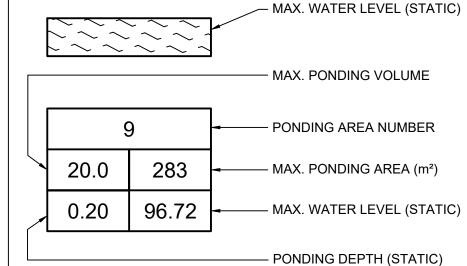

EROSION & SEDIMENT CONTROL

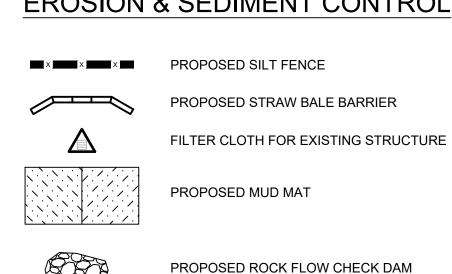

UTILITY

EXISTING	PROPOSED	
——— Н,В,С	—— Н,В,С ——	JOINT UTILITY TRENCH (HYDRO, BELL, CABLE)
2H,1B,1C	2H,1B,1C	DENOTES NUMBER OF DUCTS
		CONCRETE ENCASED DUCT
SL	SL	STREET LIGHT CABLE
— G — G —	G G	NATURAL GAS LINE
		SERVICE ENTRANCE HYDRO, BELL, CABLE
		END WALL BOX
C	C	CABLE PEDESTAL
	©	CABLE GRADE LEVEL BOX
В	В	BELL PEDESTAL
B	B	BELL GRADE LEVEL BOX FOR SPLICING
BC	BC	BELL CENTRAL SPLITTING POINT
		HYDRO TRANSFORMER
		HYDRO SECTIONALIZER
H	lacksquare	HYDRO MAINTENANCE HOLE
+	+ 🗓	HYDRO SWITCHING MAINTENANCE HOLE
HP	НР	HYDRO POLE
(HP	← _{HP} ←	HYDRO POLE c/w GUY WIRE
SL	SL	STREET LIGHT CABINET
×	≍— ⊗ *	STREET LIGHT POLE & GROUND WIRE
;;;—⊗	⋈- ⊗	PATHWAY LIGHT
□-⊗	□-⊗	PARKING LIGHT
CMB	СМВ	COMMUNITY MAILBOX
BUS	BUS	BUS STOP LOCATION c/w ASPHALT BOULEVARD
*	•	TREE
	-	
	CE	NERAL NOTES

GENERAL NOTES

- ALL MATERIALS, SERVICES AND CONSTRUCTION METHODS TO BE IN ACCORDANCE WITH THE CITY OF OTTAWA CURRENT STANDARDS AND SPECIFICATIONS.
- 2. ALL DIMENSIONS SHOWN ON PLANS ARE IN METRES UNLESS OTHERWISE NOTED.
- 3 DRAWINGS TO BE READ IN CONJUNCTION WITH:
- 3.1. UPDATED GEOTECHNICAL INVESTIGATION PROPOSED RESIDENTIAL DEVELOPMENT 2983, 3053 AND 3079 NAVAN ROAD OTTAWA, ONTARIO (DATED SEPTEMBER 13, 2024).
- 3.2. GEOTECHNICAL INVESTIGATION NAVAN ROAD SUBDIVISION OFF-SITE SERVICING NAVAN ROAD AND BRIAN COBURN BOULEVARD OTTAWA, ONTARIO (DATED SEPTEMBER 16, 2024)
- 3.3. LANDSLIDE HAZARD AND RISK ASSESSMENT REVISION 1, PROPOSED RESIDENTIAL DEVELOPMENT 2983, 3053 AND 3079 NAVAN ROAD OTTAWA, ONTARIO PREPARED BY PATERSON GROUP INC. (DATED JULY 4, 2024); AND
- 3.4. SITE SERVICING REPORT REVISION 3, EAST RIDGE ORLEANS SUBDIVISION, 2983, 3053 AND 3079 NAVAN ROAD & 2690 PAGÉ ROAD, OTTAWA, ONTARIO, PREPARED BY JLR (DATED SEPTEMBER 20, 2024).
- 4. UNLESS OTHERWISE NOTED, DIMENSIONS FROM STREET LINE ARE TO THE CENTRELINE OF SEWER OR MAINTENANCE
- . THE INSIDE DIAMETER OF PIPES ARE REFERRED TO IN PLAN VIEW AND THE OUTSIDE DIAMETER OF PIPES ARE DRAWN IN PROFILE VIEW.
- . THE CONTRACTOR IS RESPONSIBLE TO DETERMINE THE EXACT LOCATION, SIZE, MATERIAL AND ELEVATION OF ALL SERVICES AND UTILITIES PRIOR TO CONSTRUCTION AND SHALL PROTECT AND ASSURE RESPONSIBILITY FOR ALL UTILITIES WHETHER OR NOT SHOWN ON THIS DRAWING.
- . THE CONTRACTOR SHALL BE RESPONSIBLE FOR ALL EXCAVATION, BACKFILL, REINSTATEMENT OF ALL AREAS DISTURBED DURING CONSTRUCTION AND ALL ASSOCIATED WORKS TO THE SATISFACTION OF THE ENGINEER AND THE CITY OF
- 3. THE CONTRACTOR SHALL BE RESPONSIBLE TO DETERMINE, VIA EXCAVATION, THE EXACT LOCATION AND ELEVATION OF THE EXISTING WATERMAINS. SEWERS AND UNDERGROUND STRUCTURES AS REQUIRED FOR ALL CONNECTIONS.
- EXCAVATION FOR THE INSTALLATION OF SERVICES ALONG OR IN PROXIMITY OF A BUILDING OR A STRUCTURE TO BE CONTAINED WITHIN A TRENCH BOX WIDTH AND ENSURE NO CONFLICT WITH ANY FUTURE FOOTINGS. SELECT SUBGRADE MATERIAL, COMPACTED TO 100% SPMDD TO 1.0m BELOW EXISTING GRADE FOR FULL TRENCH WIDTH OF DISTURBED AREA SHALL BE USED FOR BACKFILL, INCLUDING ALONG ANY SEWERS AND WATERMAINS ADJACENT TO A BUILDING OR
- 10. ANY SERVICE LATERAL REQUIRED IN THE DRIVEWAY MUST BE SLEEVED THROUGH UNDER THE GARAGE FLOOR AREA. 11. A DETAILED CONSTRUCTION AND CONTINGENCY PLAN IS REQUIRED TO BE DEVELOPED BEFORE ANY SEWER WORK IS TO
- 12. UTILITY BOXES (I.E. PEDESTALS, TRANSFORMERS, ETC.) ARE TO BE INSTALLED IN ACCORDANCE WITH THE LATEST

EDITION OF THE CITY OF OTTAWA GUIDELINES "GUIDELINES FOR UTILITY PEDESTALS WITH IN THE RIGHT-OF-WAY".

- 13. $\,$ CLAY SEALS TO BE AS PER CITY OF OTTAWA DETAIL S8 & THE GEOTECHNICAL INVESTIGATION REPORTS PREPARED BY EXP FOR THIS PROJECT DATED SEPTEMBER 13 2024.
- 14. CLAY SEALS IN THE REAR YARD ARE TO BE PLACED TO THE UNDERSIDE OF THE TOPSOIL LAYER.

WATERMAIN NOTES

- 15. EXISTING WATERMAIN INFORMATION SHOWN ON PLANS IS BASED ON BEST CURRENT INFORMATION. CONTRACTOR TO VERIFY EXACT LOCATION OF WATERMAIN AND APPURTENANCES. REPORT ANY DISCREPANCIES TO ENGINEER.
- 16. EXCAVATION, INSTALLATION, BACKFILL AND RESTORATION OF ALL WATERMAINS BY CONTRACTOR. NO WATERMAIN SITE WORK IS TO COMMENCE UNLESS THE CITY OF OTTAWA WATER WORKS INSPECTOR AND/OR CONSULTANT ARE PRESENT ON SITE TO WITNESS WORK.
- 17. WATERMAIN AND WATER SERVICE TO HAVE A MINIMUM OF 2.4 METERS OF COVER. INSULATION TO BE PROVIDED WHERE MINIMUM COVER CANNOT BE ACHIEVED AS PER CITY STANDARD W22 AND WHERE WHERE WATERMAIN IS IN PROXIMITY TO OPEN STRUCTURES AS PER CITY OF OTTAWA STANDARD W23. WATERMAIN TO BE INSTALLED TO DEPTHS SHOWN ON
- 18. WATER SERVICES TO BE EXTENDED WITH A CONTINUOUS PEX SECTION PAST THE STAND POST AND LEFT COILED 3.0m
- 19. ALL CURB STOPS TO BE LOCATED ON THE PROPERTY LINE UNLESS OTHERWISE NOTED. CURB STOP TO BE STAINLESS
- 20. WATERMAIN THRUST BLOCKS TO BE CONSTRUCTED PER CITY OF OTTAWA DETAILS W25.3 AND W25.4. THRUST BLOCKS ARE REQUIRED AT ALL BENDS. TEES. PLUGS. DEAD END CAPS, VALVES, REDUCERS OR OTHER FITTINGS WHERE CHANGES OCCUR IN PIPE DIAMETER OR DIRECTION ALL IN ACCORDANCE WITH CURRENT CITY OF OTTAWA STANDARDS AND SPECIFICATIONS.
- 21. 19mm WATER SERVICE FOR BLOCK 1 WEST END UNIT SHALL BEND WITHIN THE ROW TO CONNECT DIRECTLY TO THE 150mm WATERMAIN ON STOMPIN' TOM LANE.

STORM SEWER NOTES

- 22. STORM SEWERS TO BE REINFORCED CONCRETE, PVC, OR CITY APPROVED EQUIVALENT.
- 23. STORM SEWERS WITHIN ROADWAY WITH LESS THAN 2.0m COVER SHALL BE INSULATED PER CITY OF OTTAWA DETAIL S35.
- 24. STORM MAINTENANCE HOLES TO BE PRECAST CONCRETE IN ACCORDANCE WITH ONTARIO PROVINCIAL STANDARD DRAWINGS (OPSD).

26. ALL STORM MAINTENANCE HOLES ARE TO HAVE EXTENDED BASE PER DETAIL PROVIDED ON D1- DETAILS.

CATCH BASINS TO BE BOSS 2000 MANUFACTURED BY ARMTEC OR APPROVED EQUIVALENT.

SERVICES TO BE EXTENDED 3.0m PAST THE PROPERTY LINE FOR RESIDENCES.

- 25. ALL STORM MAINTENANCE HOLES SHALL HAVE WATERTIGHT GASKETS AND SHALL HAVE BLUE SKIN MEMBRANE UP TO FIRST JOINT ABOVE THE SEASONAL HIGH GROUNDWATER ELEVATION.
- 27. STORM CATCH BASIN STRUCTURES TO BE 600mm x 600mm PRECAST CONCRETE OR APPROVED EQUIVALENT C/W 600mm
- DEEP SUMP AND FRAME AND COVER PER CITY OF OTTAWA DETAIL S19; UNLESS OTHERWISE NOTED. 28. CBMH's PER CITY OF OTTAWA DETAIL S29 SHALL HAVE SOLID FRAME AND COVER PER CITY OF OTTAWA DETAIL S19.
- 29. REAR YARD CATCH BASIN TEES AND ELBOWS AS PER CITY OF OTTAWA DETAIL DRAWING \$30 AND \$31, 3-WAY REAR YARD
- 30. STREET CATCH BASIN LEADS TO BE INSTALLED WITH 1% GRADIENT MINIMUM, UNLESS SPECIFIED OTHERWISE ON THE
- 31. STORM SERVICES TO BE EXTENDED 1.0m PAST THE PROPERTY LINE FOR FUTURE BLOCKS 14, 15, 16, AND 17. STORM
- 32. 6m SUBDRAIN STUBS, WRAPPED IN FILTER SOCK, TO BE INSTALLED ON EITHER SIDE OF STREET CATCH BASINS LOCATED IN A ROADWAY SAGS AND ON THE HIGH SIDE ONLY (ie. THE UPSTREAM SIDE) FOR STREET CATCH BASINS NOT LOCATED IN
- 33. INLET CONTROL DEVICES TO BE VERTICAL SLIDING TYPE FOR REMOVAL AND CLEANING AS PER CITY OF OTTAWA

SANITARY SEWER NOTES

- 34. SANITARY SEWERS TO BE PVC DR-35.
- 35. SANITARY SERVICES TO BE EXTENDED 1.0m PAST THE PROPERTY LINE FOR FUTURE BLOCKS 14, 15, 16, AND 17. SANITARY SERVICES TO BE EXTENDED 3.0m PAST THE PROPERTY LINE FOR RESIDENCES.
- 36. SANITARY MAINTENANCE HOLES TO BE PRECAST CONCRETE IN ACCORDANCE WITH ONTARIO PROVINCIAL STANDARD DRAWINGS (OPSD). ALL SANITARY MAINTENANCE HOLE COVERS TO BE PER CITY OF OTTAWA DETAIL S24.
- 37. ALL SANITARY MAINTENANCE HOLES SHALL HAVE WATERTIGHT GASKETS AND SHALL HAVE BLUE SKIN MEMBRANE UP TO FIRST JOINT ABOVE SEASONAL HIGH GROUNDWATER ELEVATION.
- 38. ALL SANITARY MAINTENANCE HOLES ARE TO HAVE EXTENDED BASE PER DETAIL PROVIDED ON D1-DETAILS.
- 39. CONTRACTOR TO INSTALL TEMPORARY INLET CONTROL DEVICES (ICDs) IN SANITARY MAINTENANCE HOLE 01 ON NAVAN ROAD c/w 48mm ORIFICE DIAMETER. THE ICD SHALL BE INSTALLED AND OPERABLE AT THE ONSET OF SEWER CONSTRUCTION AND SHALL REMAIN IN PLACE UNTIL WRITTEN NOTIFICATION BY THE ENGINEER TO BE REMOVED. REFER TO DRAWING D1 FOR TEMPORARY ICD DETAIL.

GRADING NOTES:

- 40. MATCH EXISTING ELEVATIONS AT ALL EXTERIOR PROPERTY LINES OR AS SHOWN. ENSURE POSITIVE DRAINAGE TOWARD A SUITABLE OUTLET WHETHER INDICATED OR NOT.
- 41. UNDERSIDE OF FOOTING, TOP OF FOUNDATIONS AND FINISHED FLOOR ELEVATIONS HAVE BEEN SET FOR GRADING DRAINAGE PURPOSES ONLY. BUILDERS SHOULD CONSULT THE GEOTECHNICAL REPORT PREPARED FOR THIS SUBDIVISION PRIOR TO CONSTRUCTION. BUILDERS SHOULD OBTAIN A SUBGRADE INSPECTION REPORT FROM A QUALIFIED GEOTECHNICAL ENGINEER PRIOR TO CONCRETE PLACEMENT.
- 42. ROADWAY SUBGRADE SHALL BE INSPECTED BY A QUALIFIED GEOTECHNICAL ENGINEER PRIOR TO PLACEMENT OF GRANULARS, ABOVE WOVEN GEOTEXTILE (IF REQUIRED). ROADWAY MATERIAL AND COMPACTION INSPECTION TO BE CARRIED OUT BY A QUALIFIED GEOTECHNICAL ENGINEER AS REQUIRED BY THE MUNICIPALITY.
- 43. ROAD STRUCTURE SHALL BE CONSTRUCTED IN ACCORDANCE WITH THE GEOTECHNICAL REPORT PREPARED FOR THIS SUBDIVISION AT MINIMUM:

LOCAL ROADS: - 50mm WEAR COURSE - SP 12.5

- 60mm BINDER COURSE - SP 19.0

- 50mm BASE - OPSS GRANULAR 'A' CRUSHED STONE COMPACTED TO 100% SPMDD - 600mm - OPSS GRANULAR 'B' TYPE II COMPACTED TO 100% SPMDD

SUBGRADE - IN SITU SOIL AND/OR WELL COMPACTED INORGANIC EXISTING FILL AND/OR NATIVE TRENCH FILL MATERIALS. ALI GEOTECHNICAL RECOMMENDATIONS TO BE CONFIRMED ON SITE BY GEOTECHNICAL ENGINEER.

44. AT ALL CONNECTION POINTS REINSTATE SURFACES TO EXISTING CONDITION OR BETTER:

 ASPHALT RESTORATION SHALL BE IN ACCORDANCE WITH CITY OF OTTAWA STANDARD DRAWING R10 - PAVEMENT STRUCTURE, ie. THICKNESS OF GRANULARS AND ASPHALT LAYERS SHALL MATCH EXISTING - BOULEVARDS SHALL BE REINSTATED WITH 100mm TOP SOIL AND SOD


45. CURBS TO BE:

BARRIER TYPE PER CITY OF OTTAWA STANDARD SC1.1.

- ALL CURBS TO BE BARRIER TYPE - EXCEPT WEST SIDE OF PALEO STREET FROM STA. 0+180 TO STA. 0+332 - EXCEPT WEST SIDE OF ROSALIA STREET FROM STA. 1+112 TO STA. 1+190 - EXCEPT EAST SIDE OF ROSALIA STREET FROM STA. 1+100 TO STA. 1+215
- MOUNTABLE TYPE PER CITY OF OTTAWA STANDARD SC1.3.
- WEST SIDE OF PALEO STREET FROM STA. 0+180 TO STA. 0+332 WEST SIDE OF ROSALIA STREET FROM STA. 1+112 TO STA. 1+190 - EAST SIDE OF ROSALIA STREET FROM STA. 1+100 TO STA. 1+215
- 46. ALL SIDEWALKS AND CURB RAMPS TO BE CONSTRUCTED IN ACCORDANCE WITH CITY OF OTTAWA STANDARDS SC6, SC7,
- 47. ALL STREETS TO HAVE A CROSS-SECTIONAL SLOPE OF 3.0%

EROSION AND SEDIMENT CONTROL NOTES:

48. DURING CONSTRUCTION ACTIVITIES APPROPRIATE EROSION AND SEDIMENT CONTROL MEASURES, AS OUTLINED IN MNR'S "GUIDELINES ON EROSION AND SEDIMENT CONTROL FOR URBAN CONSTRUCTION SITES", SHALL BE IMPLEMENTED TO TRAP SEDIMENT ON-SITE. (REFER TO EROSION & SEDIMENT CONTROL PLAN, DRAWING ESC.)

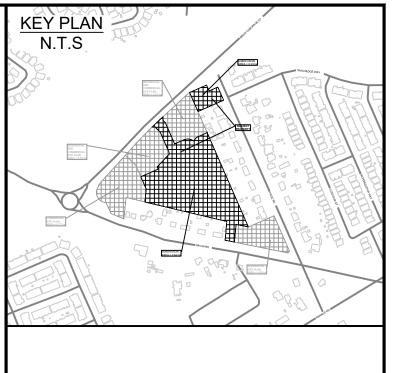

06	RE-ISSUED TO CITY FOR ENGINEERING REVIEW (THIRD RE-SUBMISSION)	20/09/24
05	RE-ISSUED TO CITY FOR ENGINEERING REVIEW (THIRD SUBMISSION)	27/08/24
04	RE-ISSUED FOR MUNICIPAL CONSENT	04/03/24
03	RE-ISSUED TO CITY FOR ENGINEERING REVIEW (SECOND SUBMISSION)	16/02/24
02	ISSUED FOR MUNICIPAL CONSENT	09/02/24
01	ISSUED TO CITY FOR ENGINEERING REVIEW	22/09/23
No.	ISSUE / REVISION	DD/MM/YY

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VERIFY SHEET SIZE AND SCALES. THE BAR TO

THE RIGHT IS 25mm IF THIS IS A FULL SIZE DRAWING.




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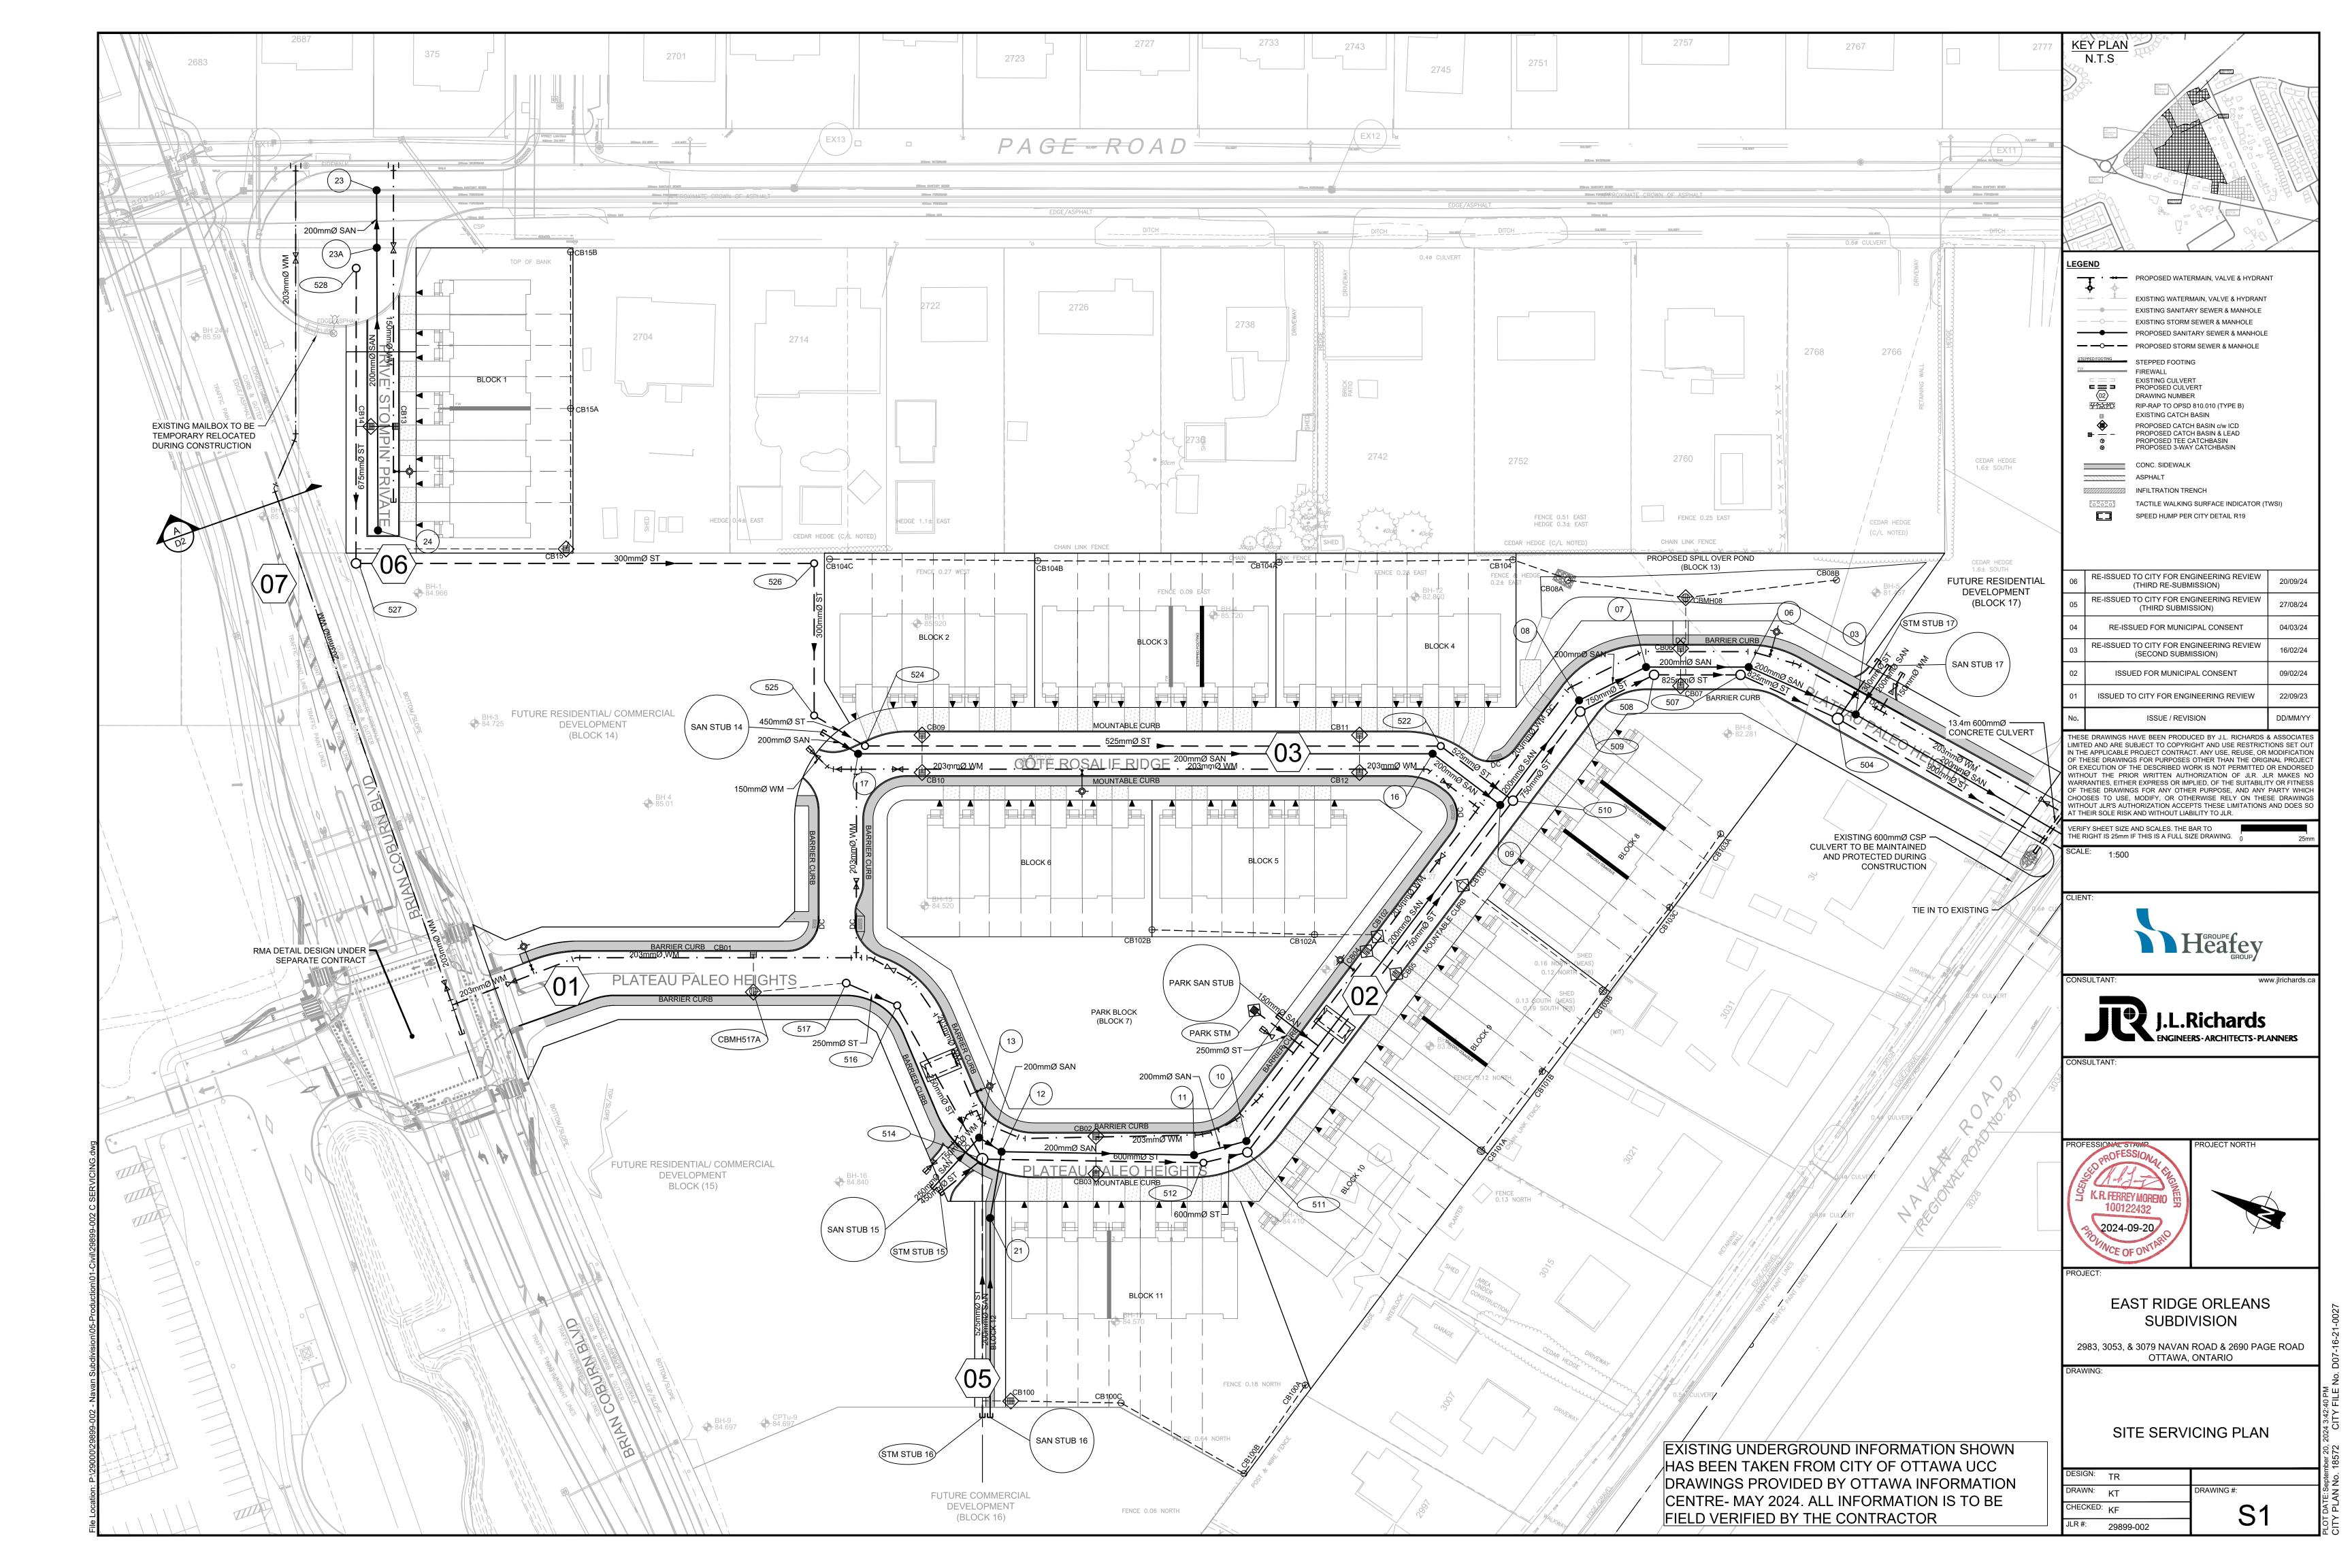
EAST RIDGE ORLEANS **SUBDIVISION**


2983, 3053, & 3079 NAVAN ROAD & 2690 PAGE ROAD OTTAWA, ONTARIO


LEGEND SHEET


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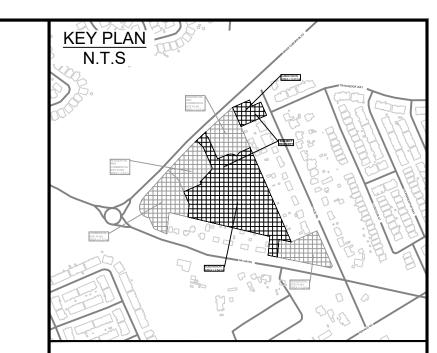




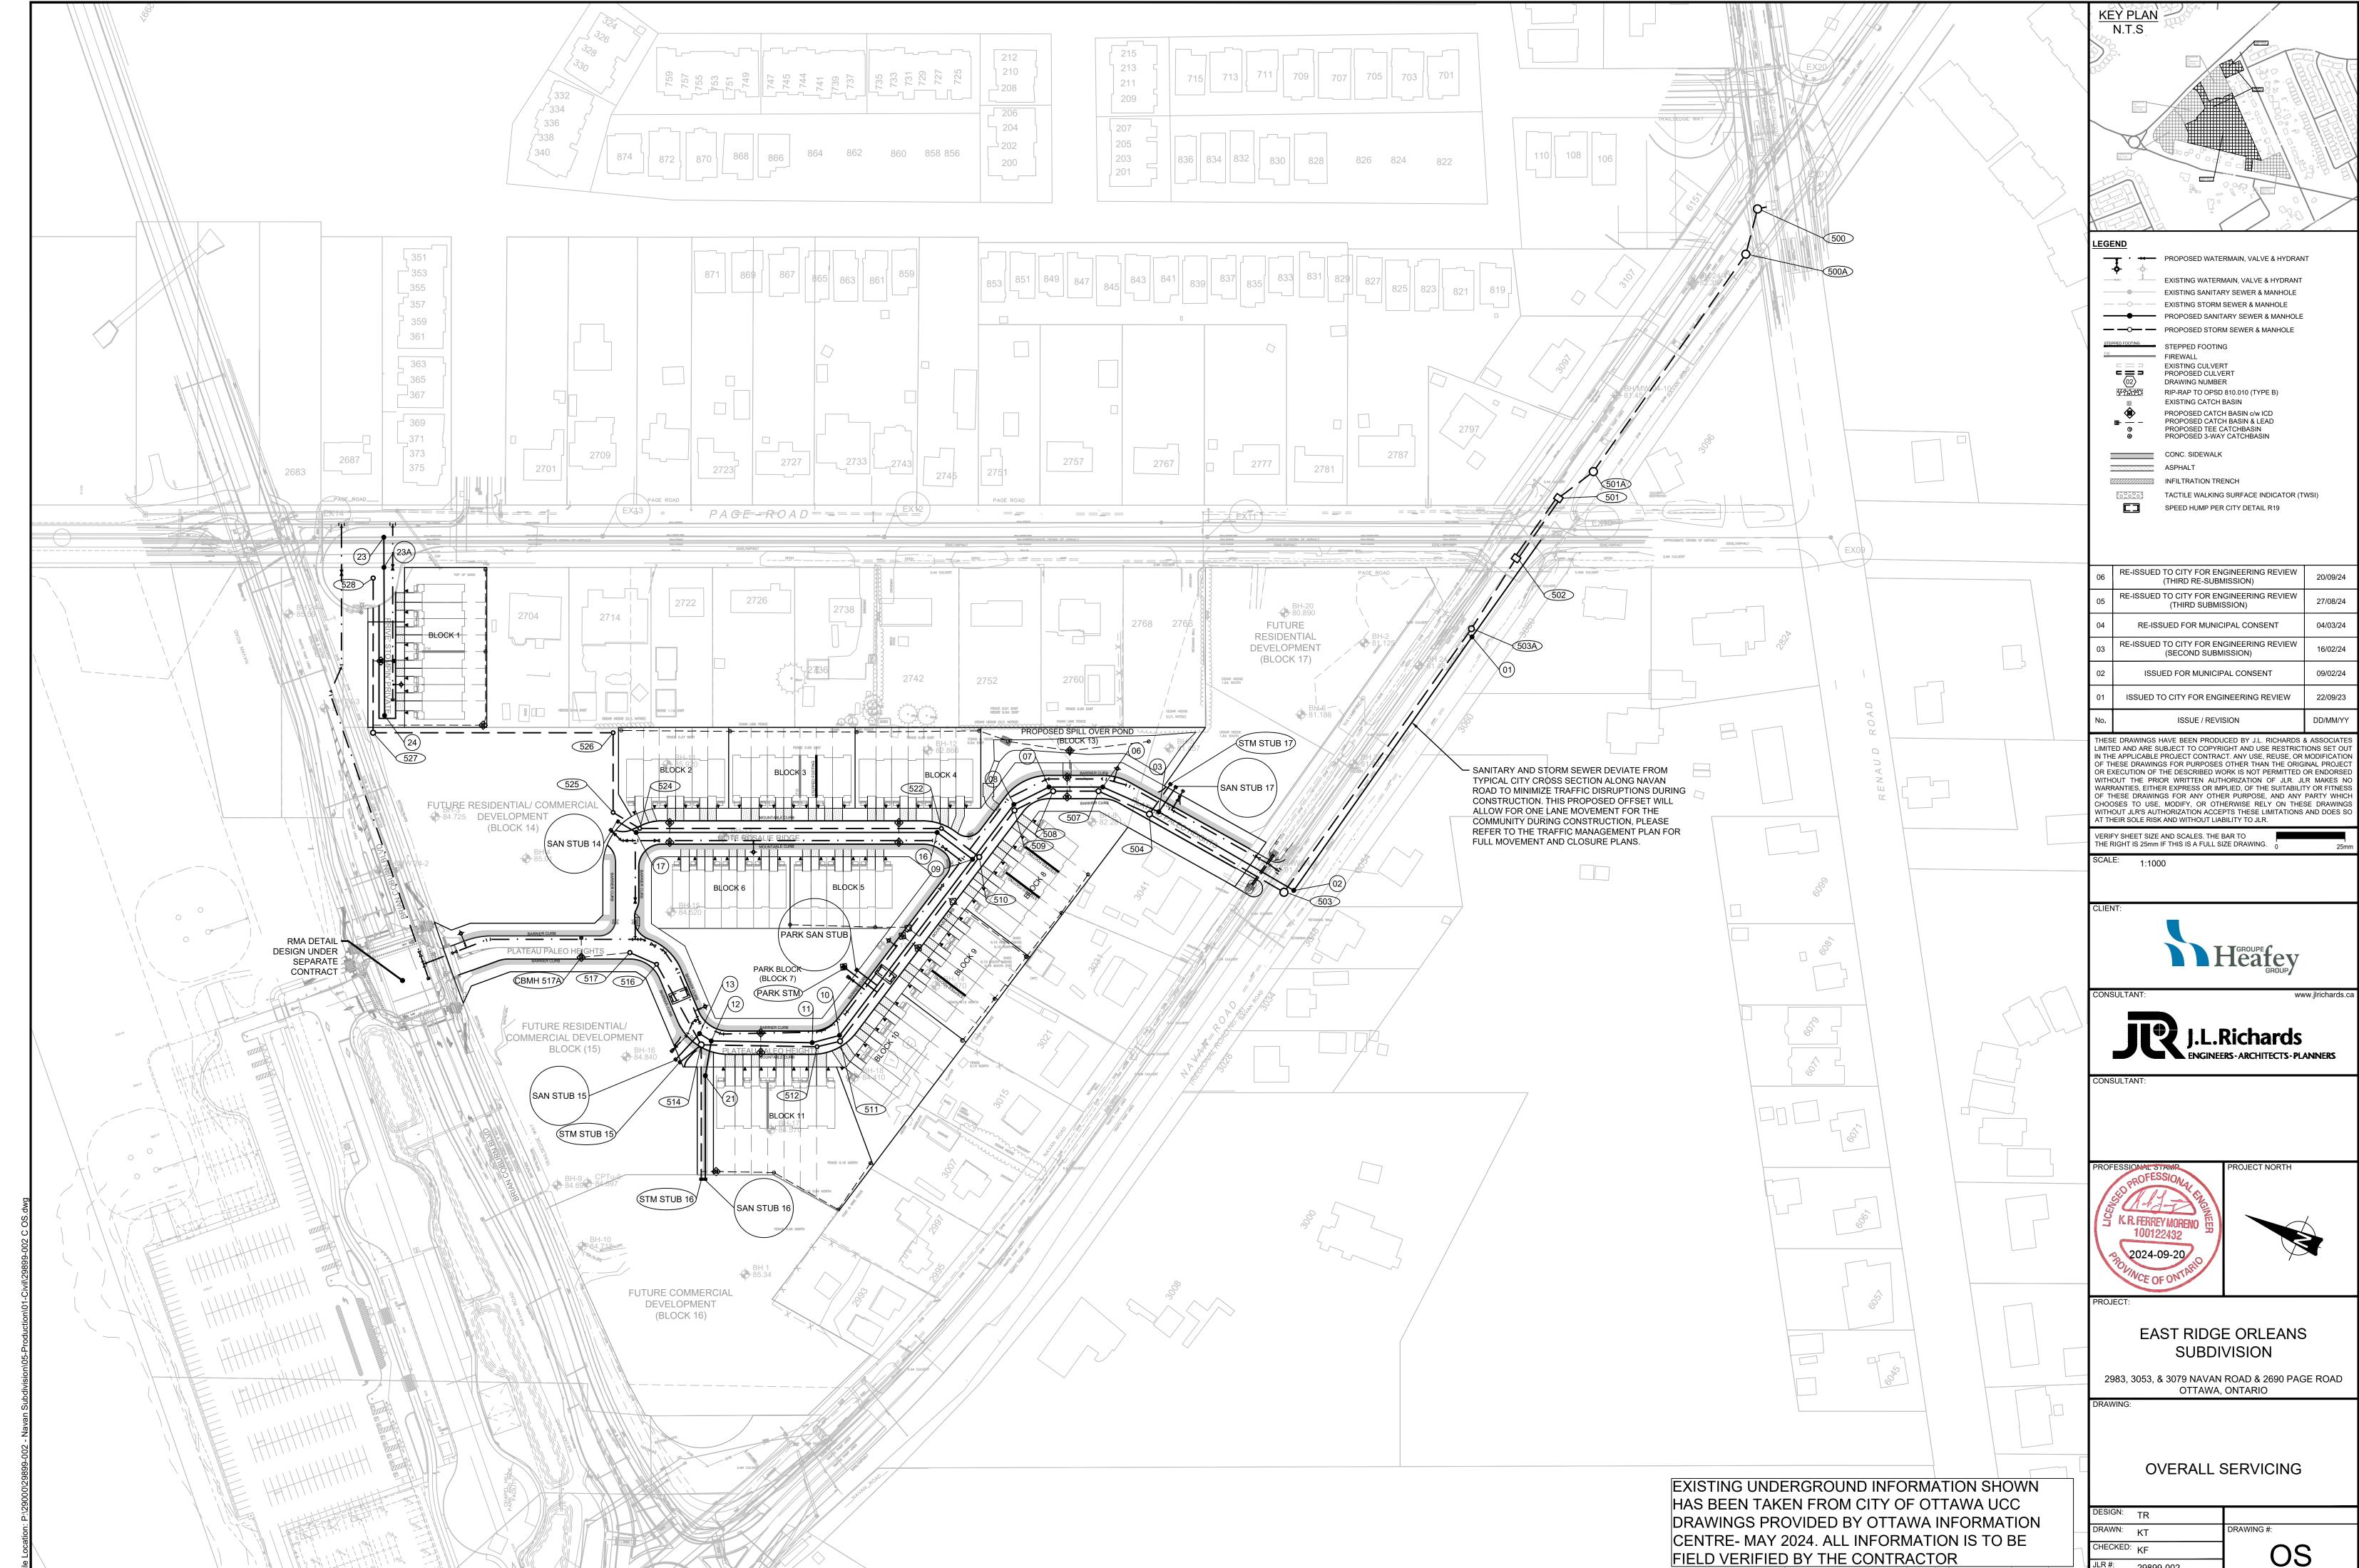

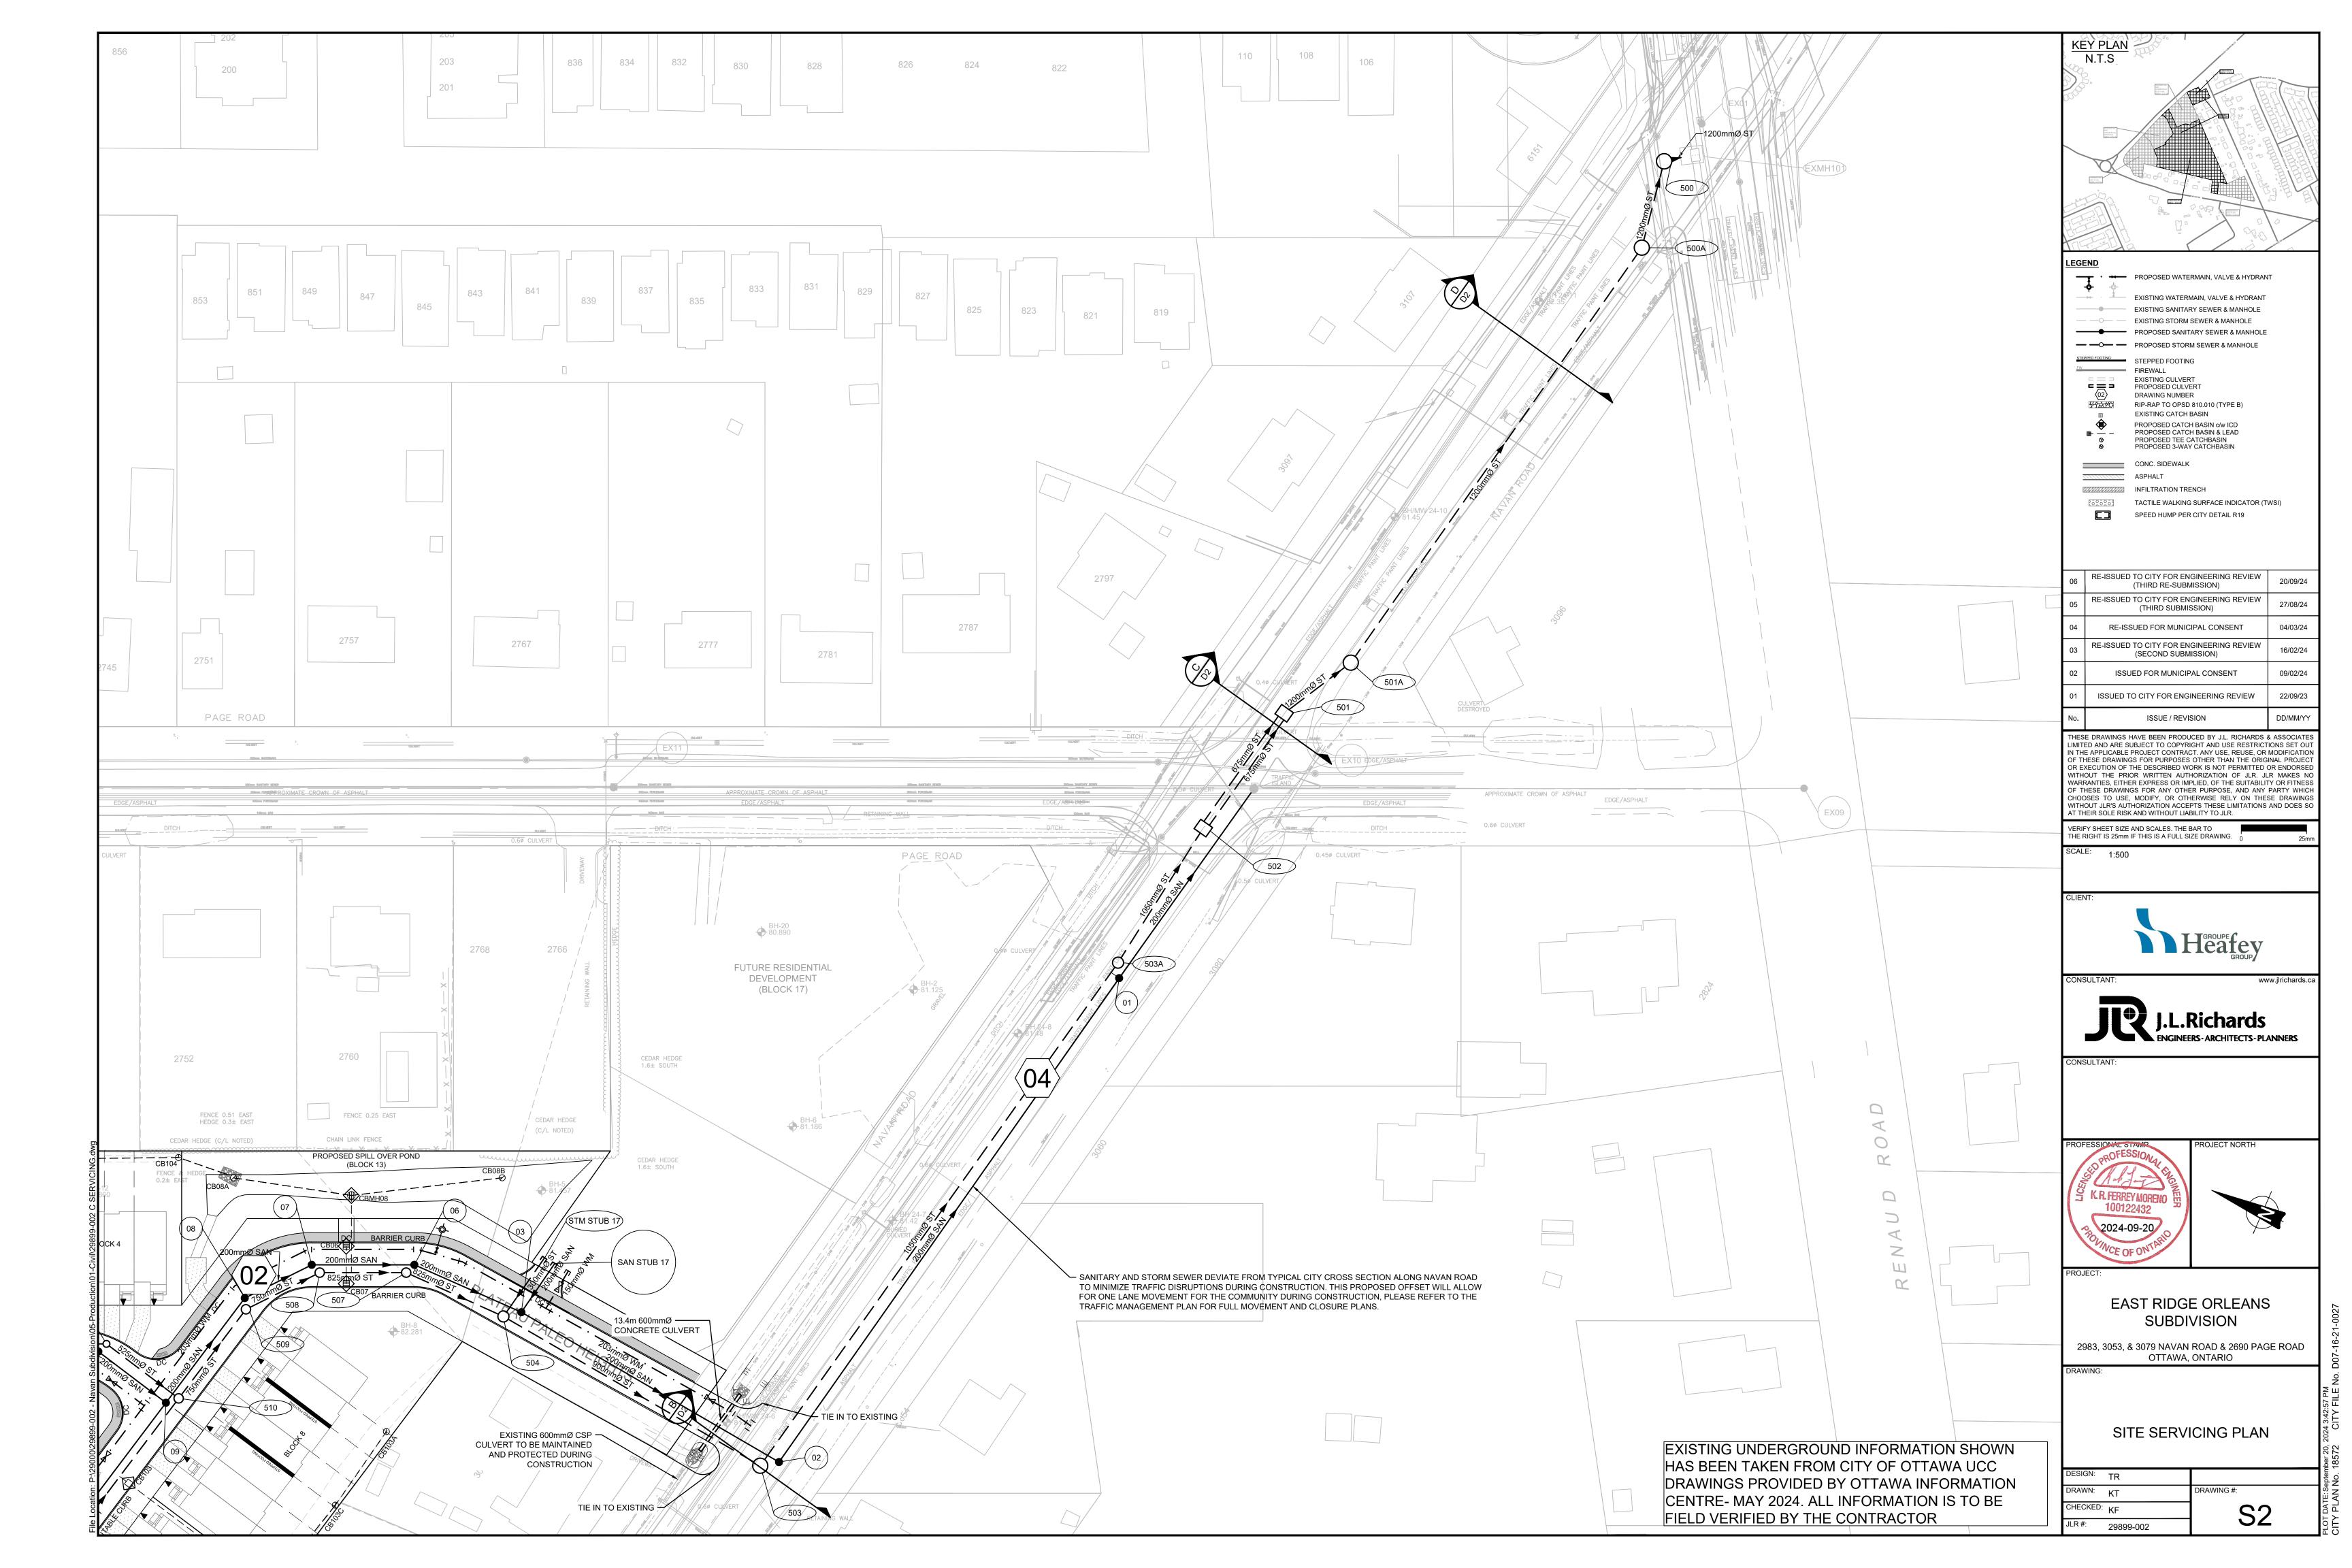

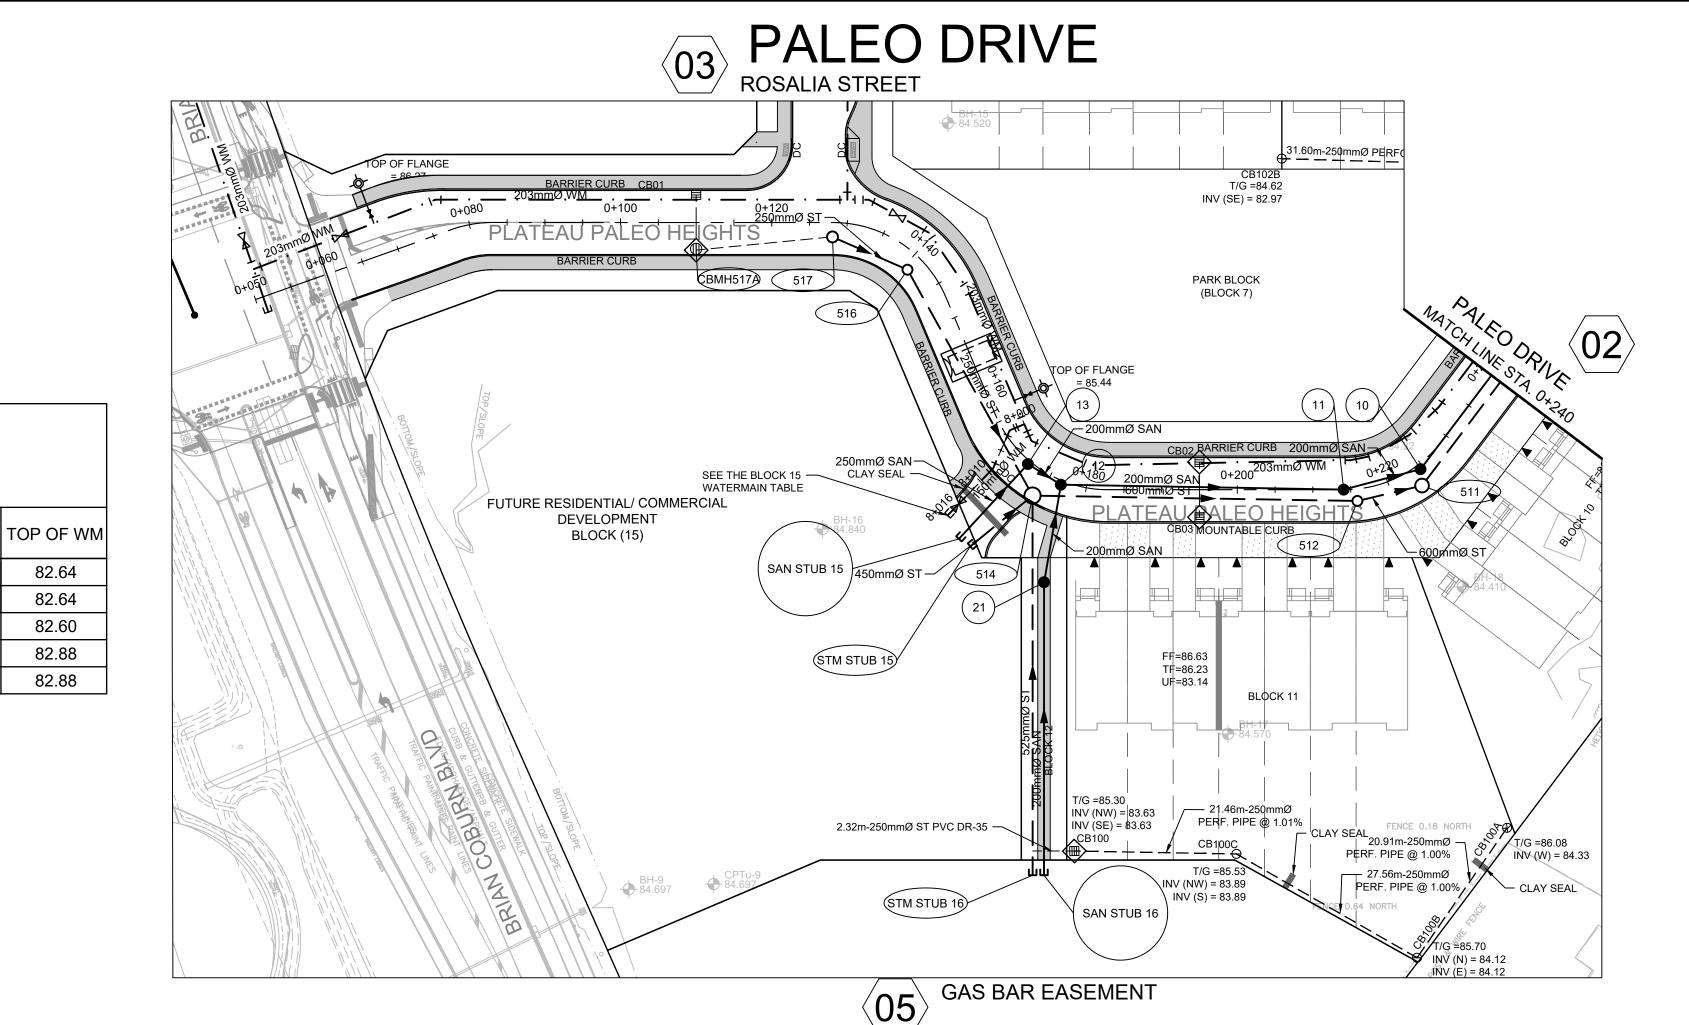

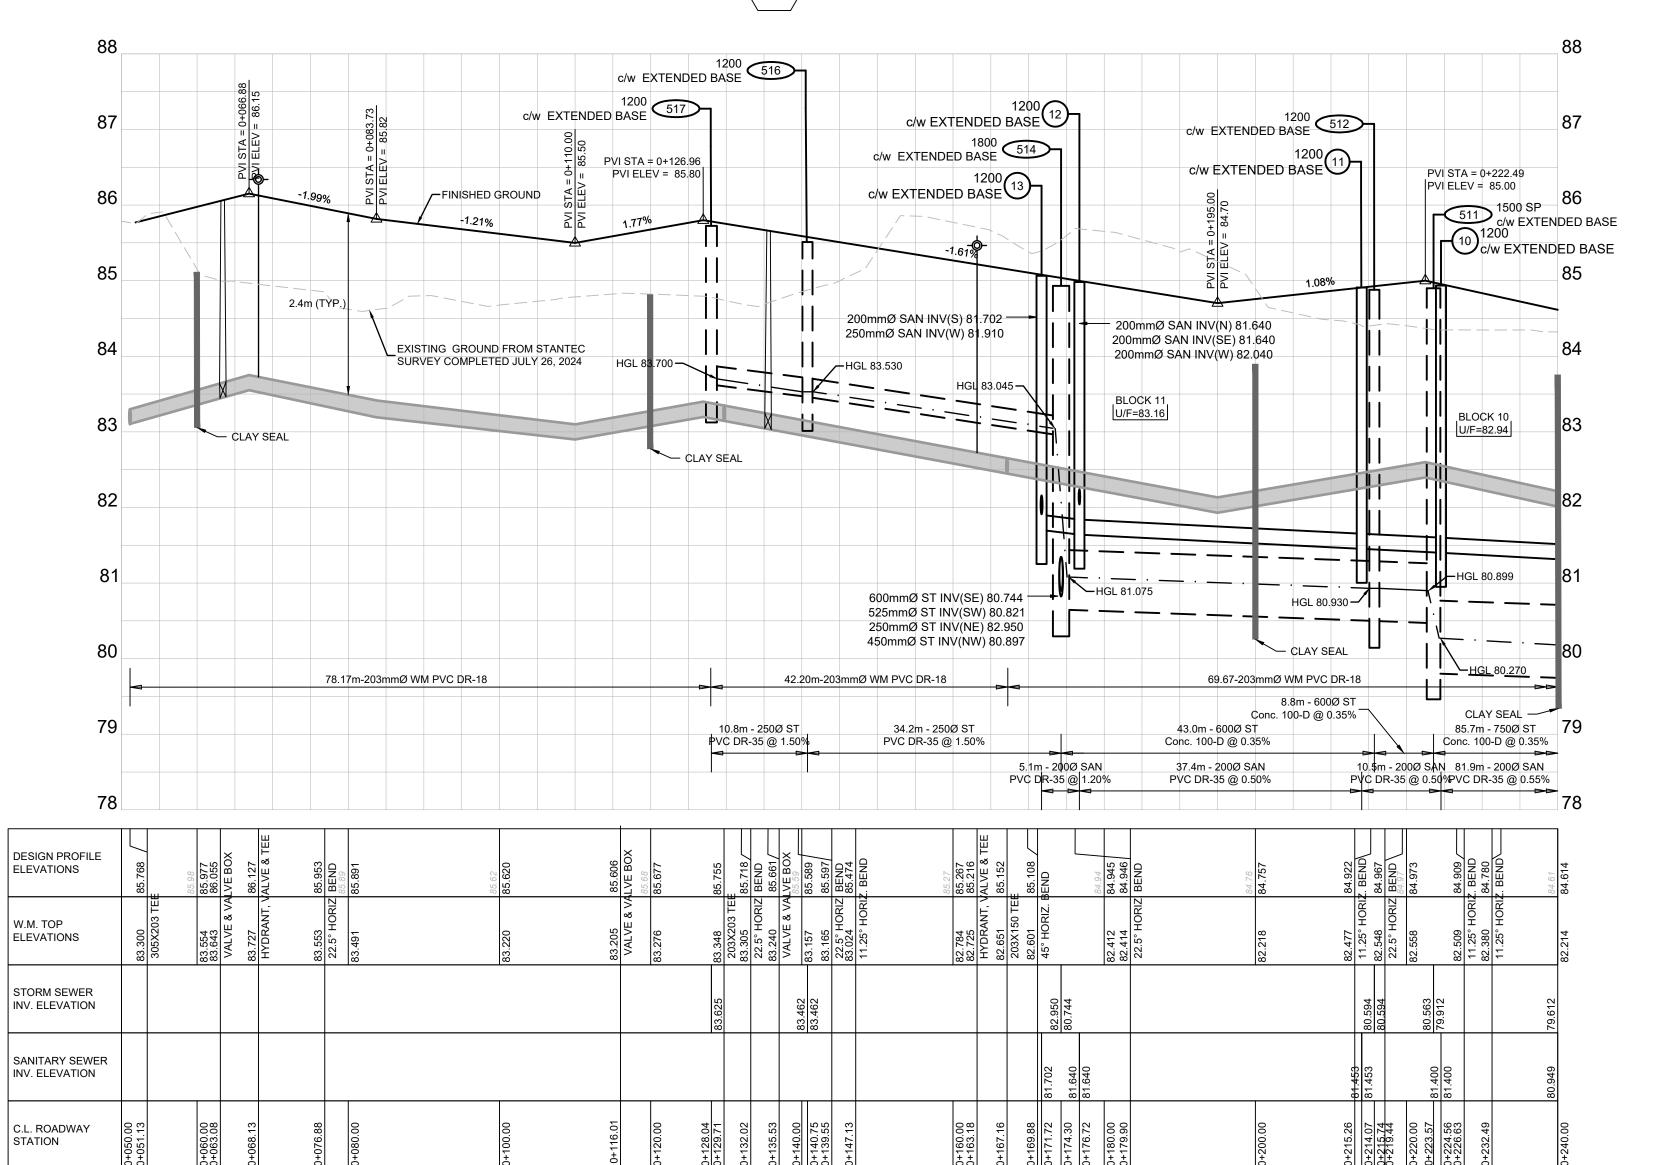

PROPOSED WATERMAIN, VALVE & HYDRANT

EXISTING WATERMAIN, VALVE & HYDRANT
EXISTING SANITARY SEWER & MANHOLE
EXISTING STORM SEWER & MANHOLE
PROPOSED SANITARY SEWER & MANHOLE
PROPOSED STORM SEWER & MANHOLE

HYDRAULIC GRADE LINE (HGL)
STEPPED FOOTING
FIREWALL
PROPOSED CULVERT
DRAWING NUMBER
RIP-RAP TO OPSD 810.010 (TYPE B)

PROPOSED FORCE MAIN

EXISTING CATCH BASIN

PROPOSED CATCH BASIN c/w ICD

PROPOSED CATCH BASIN & LEAD

PROPOSED TEE CATCHBASIN

PROPOSED 3-WAY CATCHBASIN

MANHOLE NUMBER AND SIZE (mm) c/w SAFETY PLATFORM

PER OPSD 404.020

MANHOLE NUMBER AND SIZE (mm) c/w EXTENDED BASE
PER DETAIL D01 ON D1
3 LATERAL - SERVICE CONNECTION
(100mm ST, 135 SAN, 19 mm Water)

TACTILE WALKING INDICATOR STRIP (TWIS)

CONC. SIDEWALK
ASPHALT

ASPHALT

INFILTRATION TRENCH

* REFER TO GEOTECHNICAL REPORTS FOR ALL RECOMMENDATIONS AND COMPLETE GROUNDWATER INFORMATION.

06 RE-ISSUED TO CITY FOR ENGINEERING REVIEW (THIRD RE-SUBMISSION)

05 RE-ISSUED TO CITY FOR ENGINEERING REVIEW (THIRD SUBMISSION)

04 RE-ISSUED FOR MUNICIPAL CONSENT

03 RE-ISSUED TO CITY FOR ENGINEERING REVIEW (SECOND SUBMISSION)

16/02/24

02 ISSUED FOR MUNICIPAL CONSENT

09/02/24

01 ISSUED TO CITY FOR ENGINEERING REVIEW 22/09/23

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ISSUE / REVISION

VERIFY SHEET SIZE AND SCALES. THE BAR TO THE RIGHT IS 25mm IF THIS IS A FULL SIZE DRAWING.

SCALE: 1:500H, 1:50V


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Heafey

CONSULTANT:

J.L.Richards

CONSULTANT:



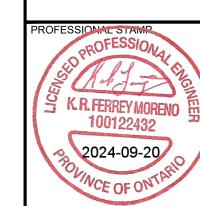

01

OJECT:

EAST RIDGE ORLEANS SUBDIVISION

2983, 3053, & 3079 NAVAN ROAD & 2690 PAGE ROAD OTTAWA, ONTARIO

NG:

PLAN AND PROFILE PALEO DRIVE STA. 0+050 TO 0+240

DESIGN: TR

DRAWN: KT

CHECKED: KF

JLR #: 29899-002

File Location: P:\29000\29899-002 - Navan Subdivision\05-Production\01-Civil\

WATERMAIN TABLE

STA. 8+000 TO 8+016.95 BLOCK 15

S N DETAIL

4 VALVE

5 CAP

1 200 x 150 TEE

2 45° HORIZONTAL BEND

3 22.5° HORIZONTAL BEND 8+008.22

PVC DR-18 CL.50

STATION

8+000

8+003.21

8+014.99

8+017.04

FINISHED

GRADE


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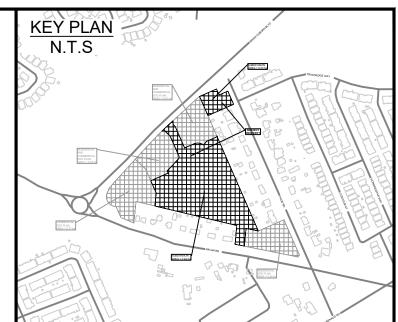
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85.00

85.30

85.28



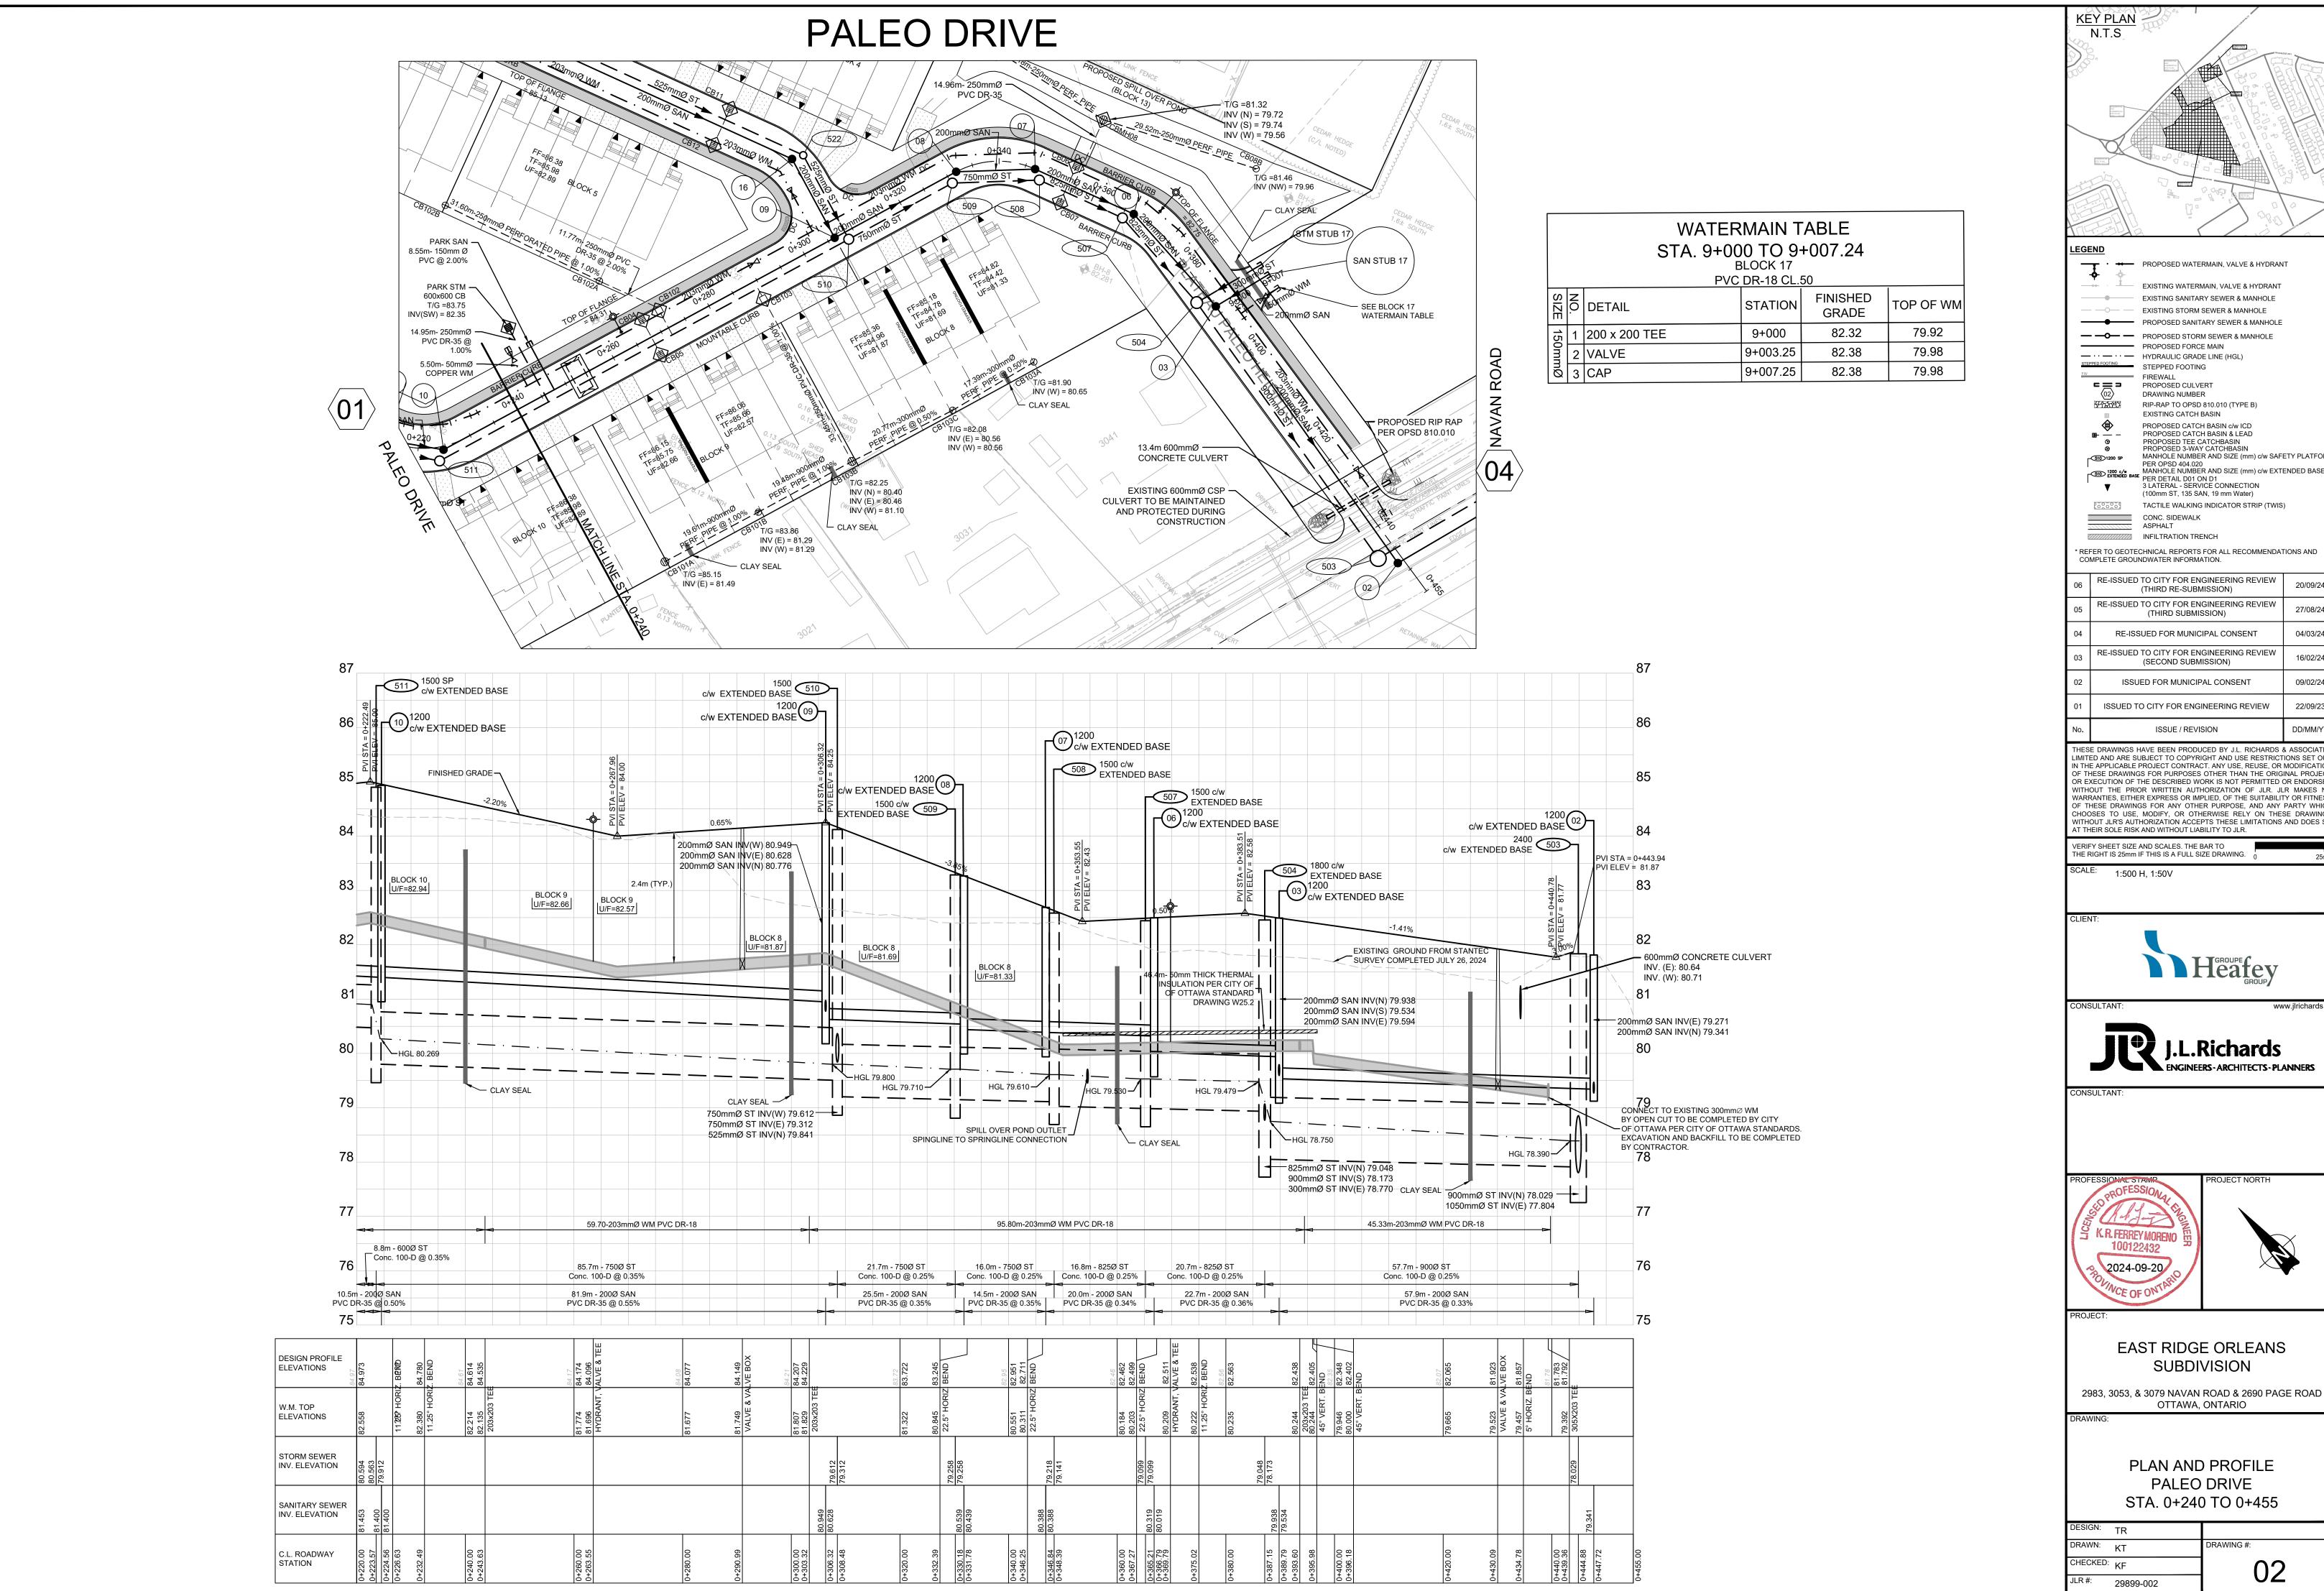

PROPOSED WATERMAIN, VALVE & HYDRANT EXISTING WATERMAIN, VALVE & HYDRANT

EXISTING SANITARY SEWER & MANHOLE EXISTING STORM SEWER & MANHOLE PROPOSED SANITARY SEWER & MANHOLE PROPOSED FORCE MAIN

STEPPED FOOTING PROPOSED CULVERT DRAWING NUMBER RIP-RAP TO OPSD 810.010 (TYPE B) EXISTING CATCH BASIN

PROPOSED TEE CATCHBASIN PROPOSED 3-WAY CATCHBASIN MANHOLE NUMBER AND SIZE (mm) c/w SAFETY PLATFORM PER OPSD 404.020

MANHOLE NUMBER AND SIZE (mm) c/w EXTENDED BASE
PER DETAIL D01 ON D1

3 LATERAL - SERVICE CONNECTION

PROPOSED CATCH BASIN c/w ICD

PROPOSED CATCH BASIN & LEAD

(100mm ST, 135 SAN, 19 mm Water) TACTILE WALKING INDICATOR STRIP (TWIS) CONC. SIDEWALK

INFILTRATION TRENCH

* REFER TO GEOTECHNICAL REPORTS FOR ALL RECOMMENDATIONS AND COMPLETE GROUNDWATER INFORMATION.

06	RE-ISSUED TO CITY FOR ENGINEERING REVIEW (THIRD RE-SUBMISSION)	20/09/24
05	RE-ISSUED TO CITY FOR ENGINEERING REVIEW (THIRD SUBMISSION)	27/08/24
04	RE-ISSUED FOR MUNICIPAL CONSENT	04/03/24
03	RE-ISSUED TO CITY FOR ENGINEERING REVIEW (SECOND SUBMISSION)	16/02/24
02	ISSUED FOR MUNICIPAL CONSENT	09/02/24
01	ISSUED TO CITY FOR ENGINEERING REVIEW	22/09/23
No	ISSUE / PEVISION	

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SCALE: 1:500 H, 1:50V

Heafey






EAST RIDGE ORLEANS SUBDIVISION

2983, 3053, & 3079 NAVAN ROAD & 2690 PAGE ROAD OTTAWA, ONTARIO

PLAN AND PROFILE PALEO DRIVE STA. 0+240 TO 0+455

DRAWN: KT CHECKED: KF JLR #: 29899-002

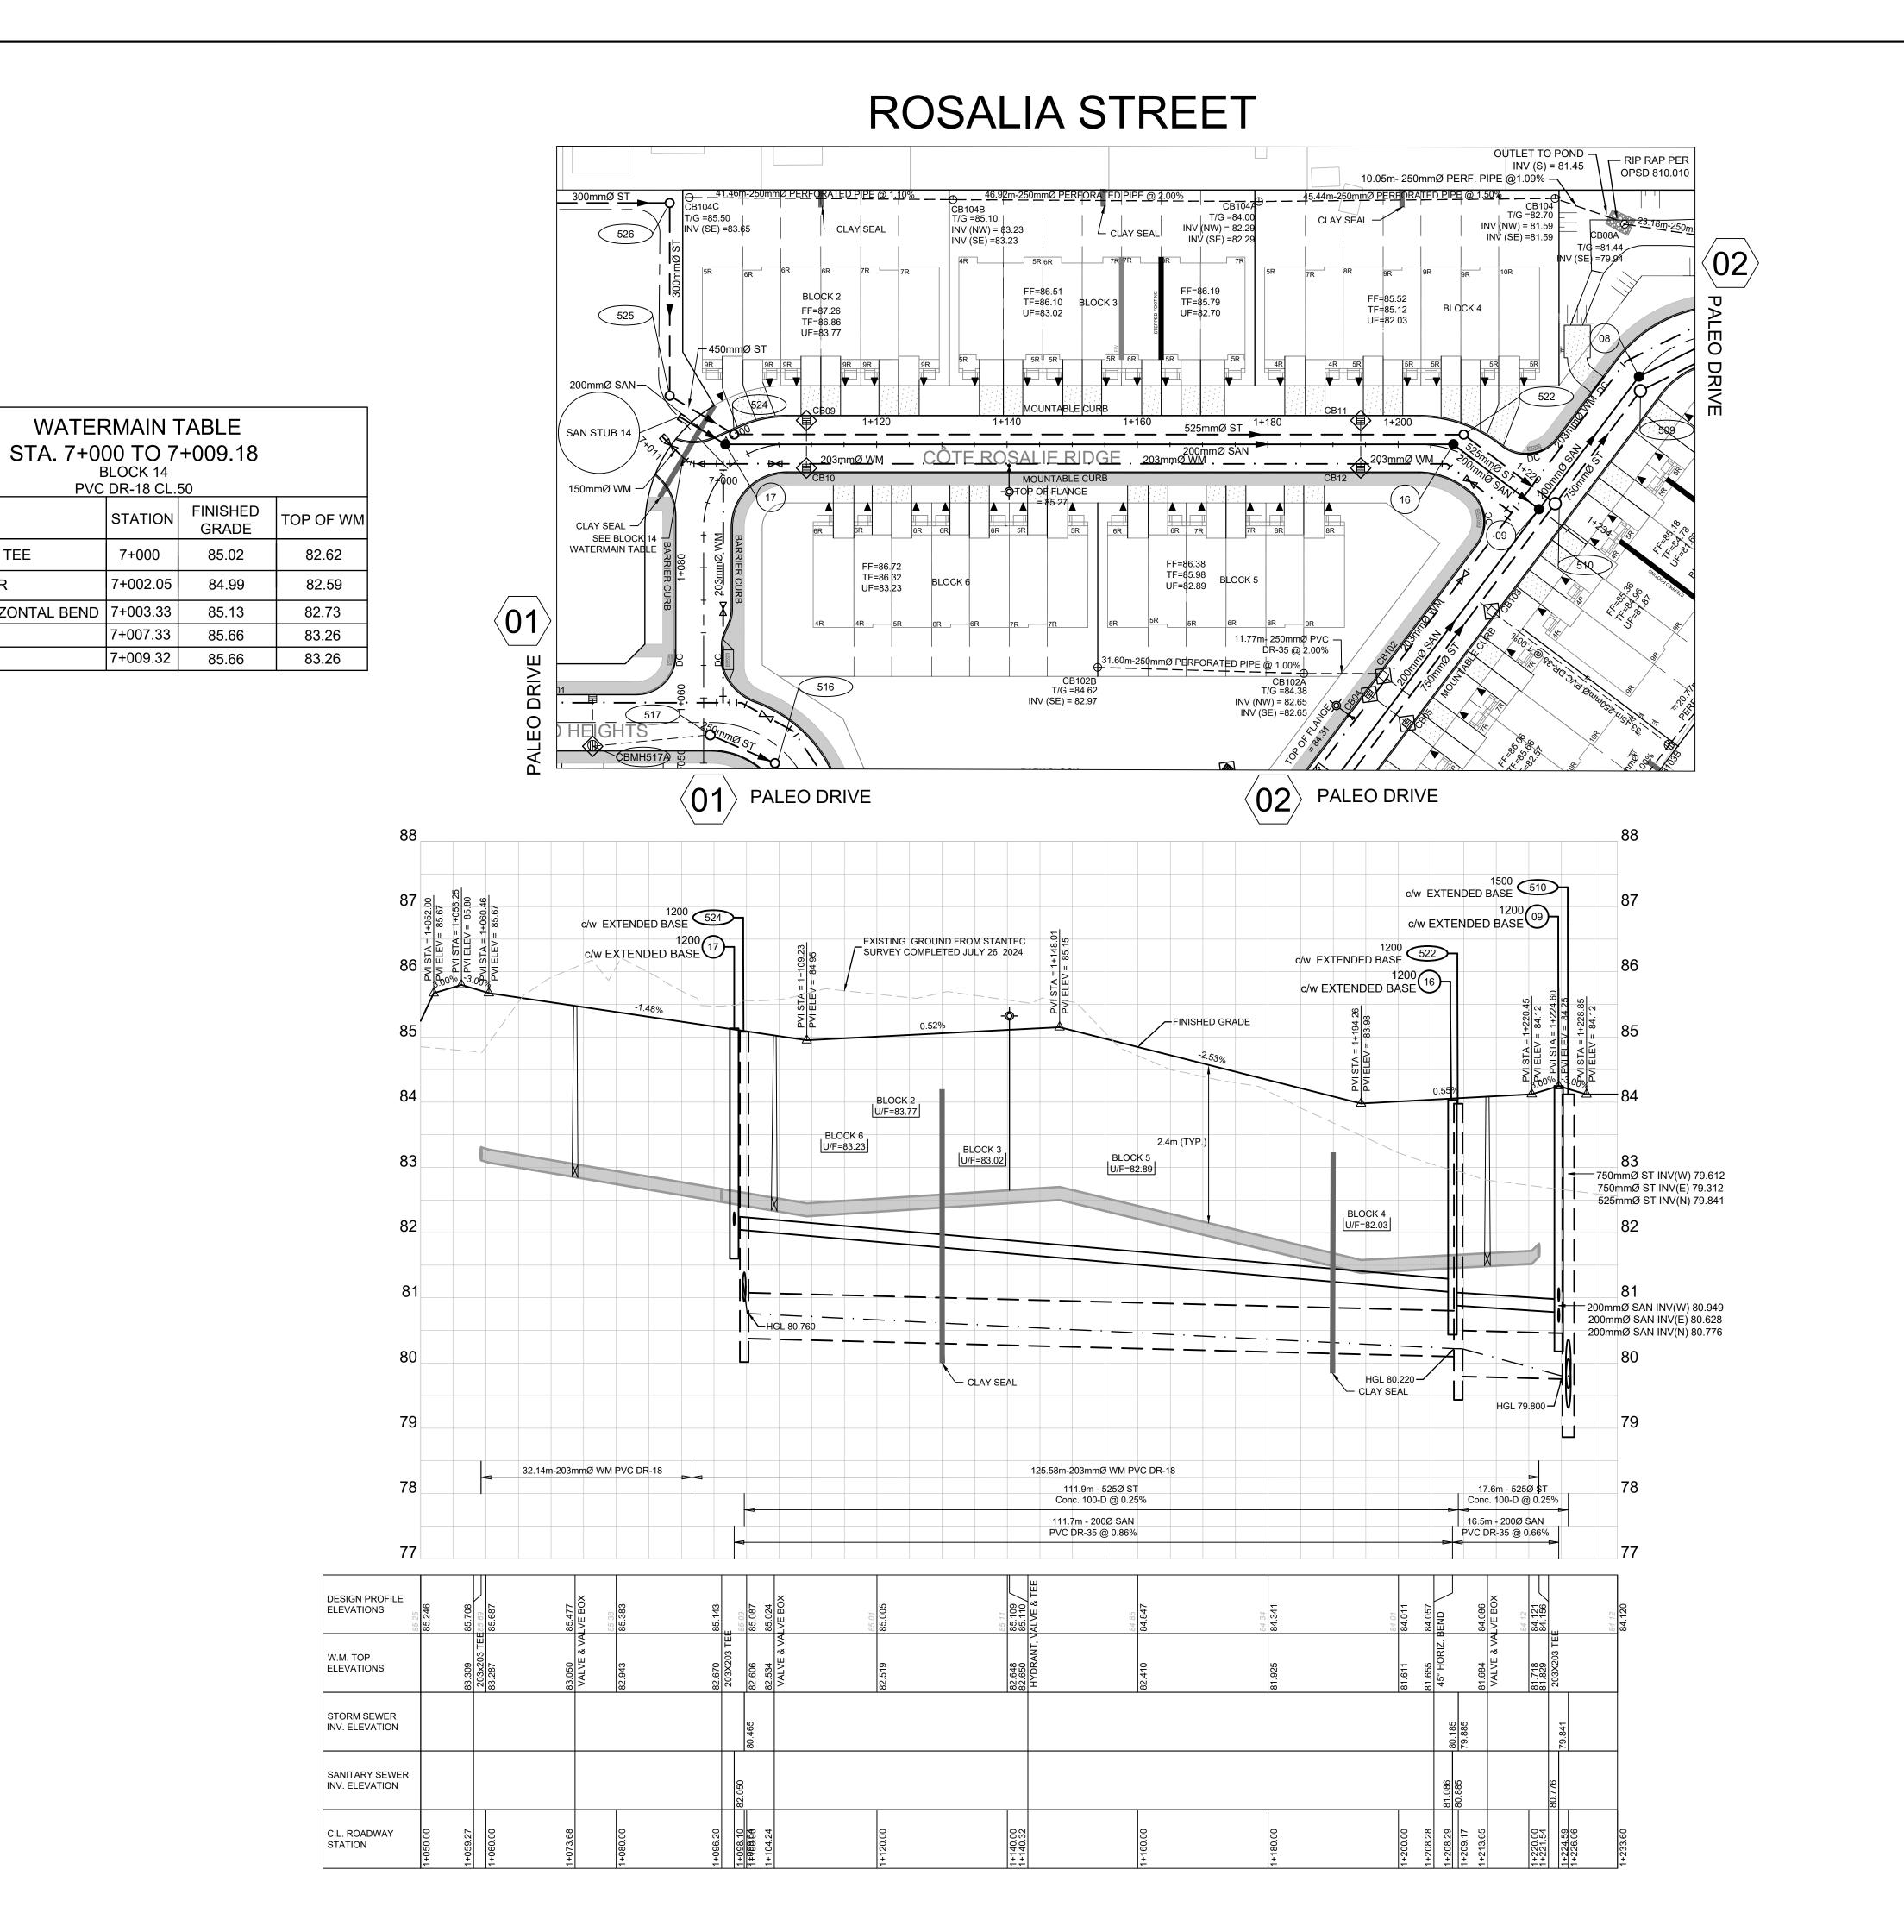

SIZ O DETAIL


200 x 200 TEE

45° HORIZONTAL BEND

REDUCER

4 VALVE

5 CAP

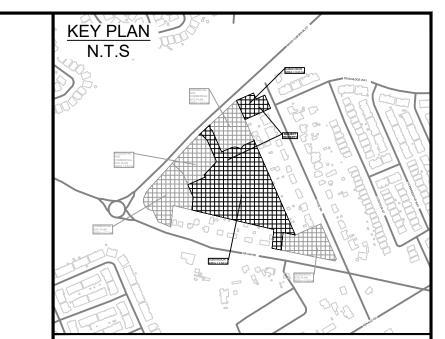

LND	
1	PROPOSED WATERMAIN, VALVE & HYDRANT
* . *	EXISTING WATERMAIN, VALVE & HYDRANT
•	EXISTING SANITARY SEWER & MANHOLE
	EXISTING STORM SEWER & MANHOLE
	PROPOSED SANITARY SEWER & MANHOLE
	PROPOSED STORM SEWER & MANHOLE
	PROPOSED FORCE MAIN
- · · - · · -	HYDRAULIC GRADE LINE (HGL)
PPED FOOTING	STEPPED FOOTING

PROPOSED CULVERT DRAWING NUMBER RIP-RAP TO OPSD 810.010 (TYPE B) EXISTING CATCH BASIN PROPOSED CATCH BASIN c/w ICD PROPOSED CATCH BASIN & LEAD

MANHOLE NUMBER AND SIZE (mm) c/w SAFETY PLATFORM PER OPSD 404.020

MANHOLE NUMBER AND SIZE (mm) c/w EXTENDED BASE
PER DETAIL D01 ON D1
3 LATERAL - SERVICE CONNECTION (100mm ST, 135 SAN, 19 mm Water)

PROPOSED TEE CATCHBASIN PROPOSED 3-WAY CATCHBASIN

TACTILE WALKING INDICATOR STRIP (TWIS) CONC. SIDEWALK

INFILTRATION TRENCH * REFER TO GEOTECHNICAL REPORTS FOR ALL RECOMMENDATIONS AND

COMPLETE GROUNDWATER INFORMATION.

06	RE-ISSUED TO CITY FOR ENGINEERING REVIEW (THIRD RE-SUBMISSION)	20/09/24
05	RE-ISSUED TO CITY FOR ENGINEERING REVIEW (THIRD SUBMISSION)	27/08/24
04	RE-ISSUED FOR MUNICIPAL CONSENT	04/03/24
03	RE-ISSUED TO CITY FOR ENGINEERING REVIEW (SECOND SUBMISSION)	16/02/24
02	ISSUED FOR MUNICIPAL CONSENT	09/02/24

22/09/23

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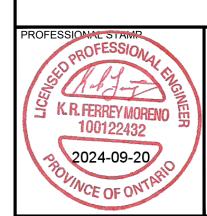
ISSUED TO CITY FOR ENGINEERING REVIEW

ISSUE / REVISION

VERIFY SHEET SIZE AND SCALES. THE BAR TO THE RIGHT IS 25mm IF THIS IS A FULL SIZE DRAWING.

SCALE: 1:500H, 1:50V

Heafey






EAST RIDGE ORLEANS SUBDIVISION

2983, 3053, & 3079 NAVAN ROAD & 2690 PAGE ROAD OTTAWA, ONTARIO

PLAN AND PROFILE **ROSALIA STREET** STA. 1+050 TO 1+233.60

DRAWN: KT CHECKED: KF JLR #: 29899-002

STATION

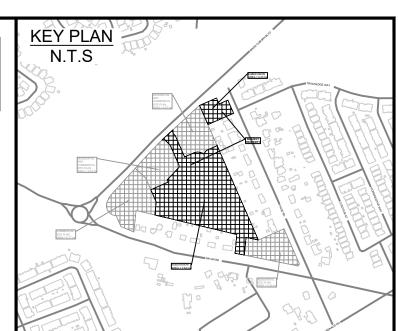

PROPOSED WATERMAIN, VALVE & HYDRANT EXISTING WATERMAIN, VALVE & HYDRANT EXISTING SANITARY SEWER & MANHOLE EXISTING STORM SEWER & MANHOLE PROPOSED FORCE MAIN — · · · — HYDRAULIC GRADE LINE (HGL) PROPOSED CULVERT DRAWING NUMBER

PROPOSED CATCH BASIN & LEAD PROPOSED TEE CATCHBASIN PROPOSED 3-WAY CATCHBASIN MANHOLE NUMBER AND SIZE (mm) c/w SAFETY PLATFORM PER OPSD 404.020

MANHOLE NUMBER AND SIZE (mm) c/w EXTENDED BASE
PER DETAIL D01 ON D1

3 LATERAL - SERVICE CONNECTION (100mm ST, 135 SAN, 19 mm Water)

CONC. SIDEWALK INFILTRATION TRENCH


* REFER TO GEOTECHNICAL REPORTS FOR ALL RECOMMENDATIONS AND COMPLETE GROUNDWATER INFORMATION.

06	RE-ISSUED TO CITY FOR ENGINEERING REVIEW (THIRD RE-SUBMISSION)	20/09/24
05	RE-ISSUED TO CITY FOR ENGINEERING REVIEW (THIRD SUBMISSION)	27/08/24
04	RE-ISSUED FOR MUNICIPAL CONSENT	04/03/24
03	RE-ISSUED TO CITY FOR ENGINEERING REVIEW (SECOND SUBMISSION)	16/02/24
02	ISSUED FOR MUNICIPAL CONSENT	09/02/24
01	ISSUED TO CITY FOR ENGINEERING REVIEW	22/09/23
No.	ISSUE / REVISION	DD/MM/Y\

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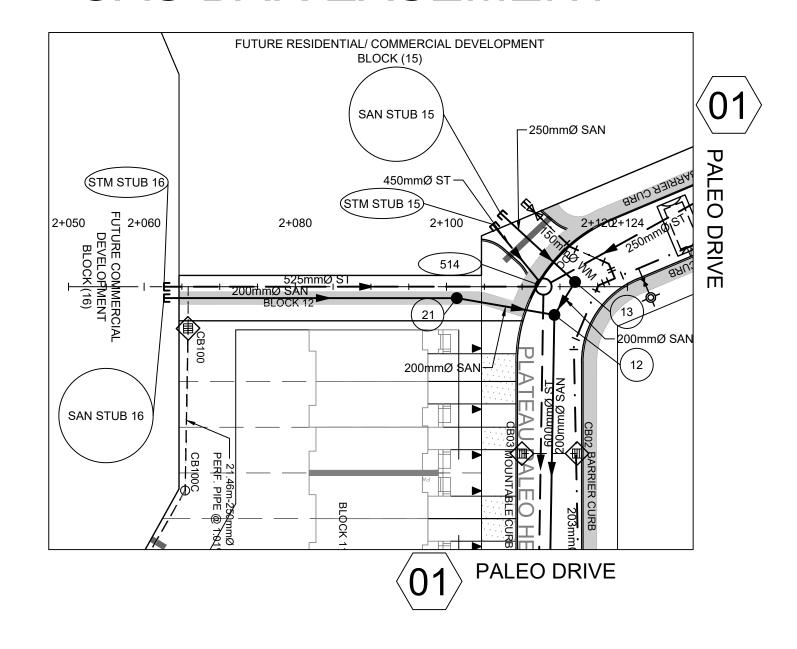
EAST RIDGE ORLEANS


2983, 3053, & 3079 NAVAN ROAD & 2690 PAGE ROAD OTTAWA, ONTARIO


> PLAN AND PROFILE NAVAN ROAD STA. 4+280 TO 4+620

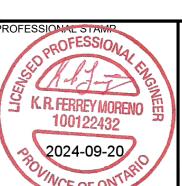JRAWN: KT CHECKED: KF JLR #: 29899-002

GAS BAR EASEMENT



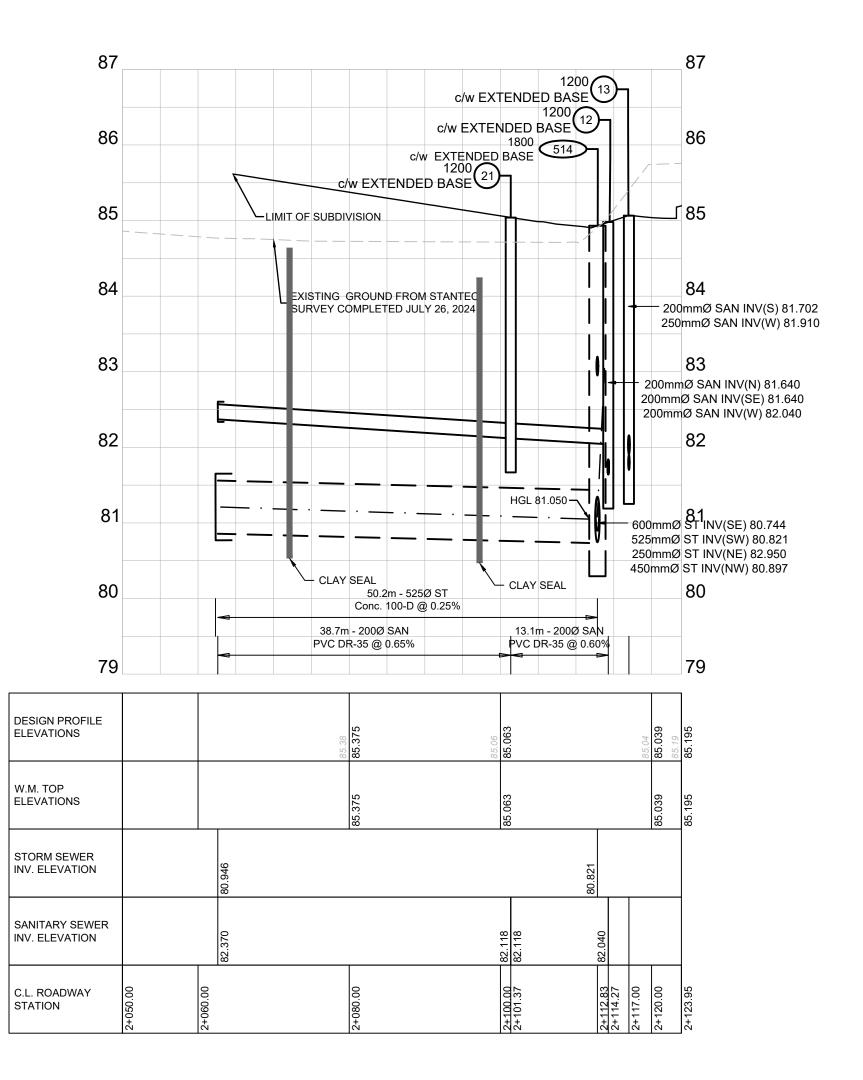

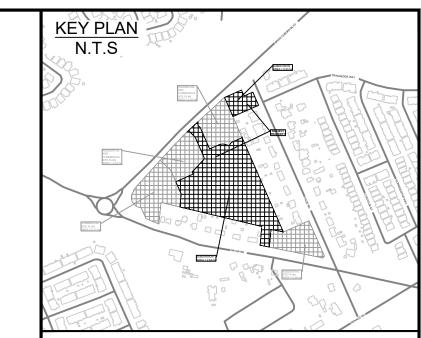

PROPOSED WATERMAIN, VALVE & HYDRANT EXISTING WATERMAIN, VALVE & HYDRANT

EXISTING SANITARY SEWER & MANHOLE — — EXISTING STORM SEWER & MANHOLE PROPOSED SANITARY SEWER & MANHOLE — — PROPOSED STORM SEWER & MANHOLE PROPOSED FORCE MAIN

STEPPED FOOTING PROPOSED CULVERT DRAWING NUMBER RIP-RAP TO OPSD 810.010 (TYPE B)

─ · · · · · · · · HYDRAULIC GRADE LINE (HGL)

EXISTING CATCH BASIN PROPOSED CATCH BASIN c/w ICD PROPOSED CATCH BASIN & LEAD PROPOSED TEE CATCHBASIN PROPOSED 3-WAY CATCHBASIN MANHOLE NUMBER AND SIZE (mm) c/w SAFETY PLATFORM

PER OPSD 404.020
MANHOLE NUMBER AND SIZE (mm) c/w EXTENDED BASE
PER DETAIL D01 ON D1
3 LATERAL - SERVICE CONNECTION (100mm ST, 135 SAN, 19 mm Water) TACTILE WALKING INDICATOR STRIP (TWIS)

CONC. SIDEWALK INFILTRATION TRENCH

* REFER TO GEOTECHNICAL REPORTS FOR ALL RECOMMENDATIONS AND

CO	11011071112	
06	RE-ISSUED TO CITY FOR ENGINEERING REVIEW (THIRD RE-SUBMISSION)	20/09/24
05	RE-ISSUED TO CITY FOR ENGINEERING REVIEW (THIRD SUBMISSION)	27/08/24
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02	ISSUED FOR MUNICIPAL CONSENT	09/02/24
01	ISSUED TO CITY FOR ENGINEERING REVIEW	22/09/23
No.	ISSUE / REVISION	DD/MM/YY

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SCALE: 1:500 H, 1:50 V








EAST RIDGE ORLEANS SUBDIVISION


2983, 3053, & 3079 NAVAN ROAD & 2690 PAGE ROAD OTTAWA, ONTARIO

PLAN AND PROFILE GAS BAR EASEMENT STA. 2+050 TO 2+123.95


DRAWN: KT CHECKED: KF JLR #: 29899-002


STOMPIN' TOM LANE

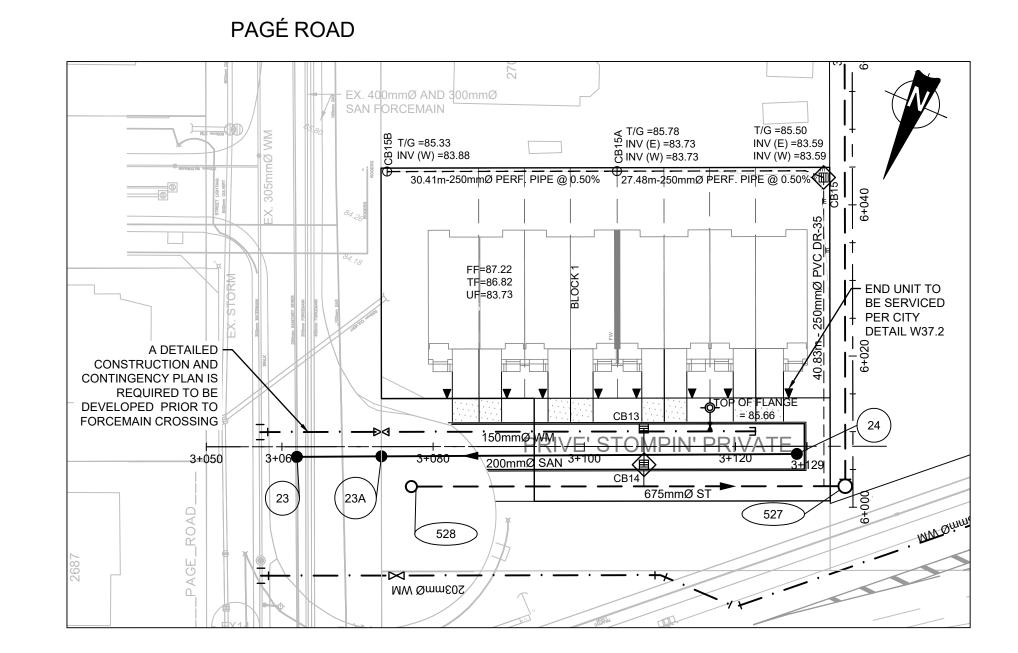


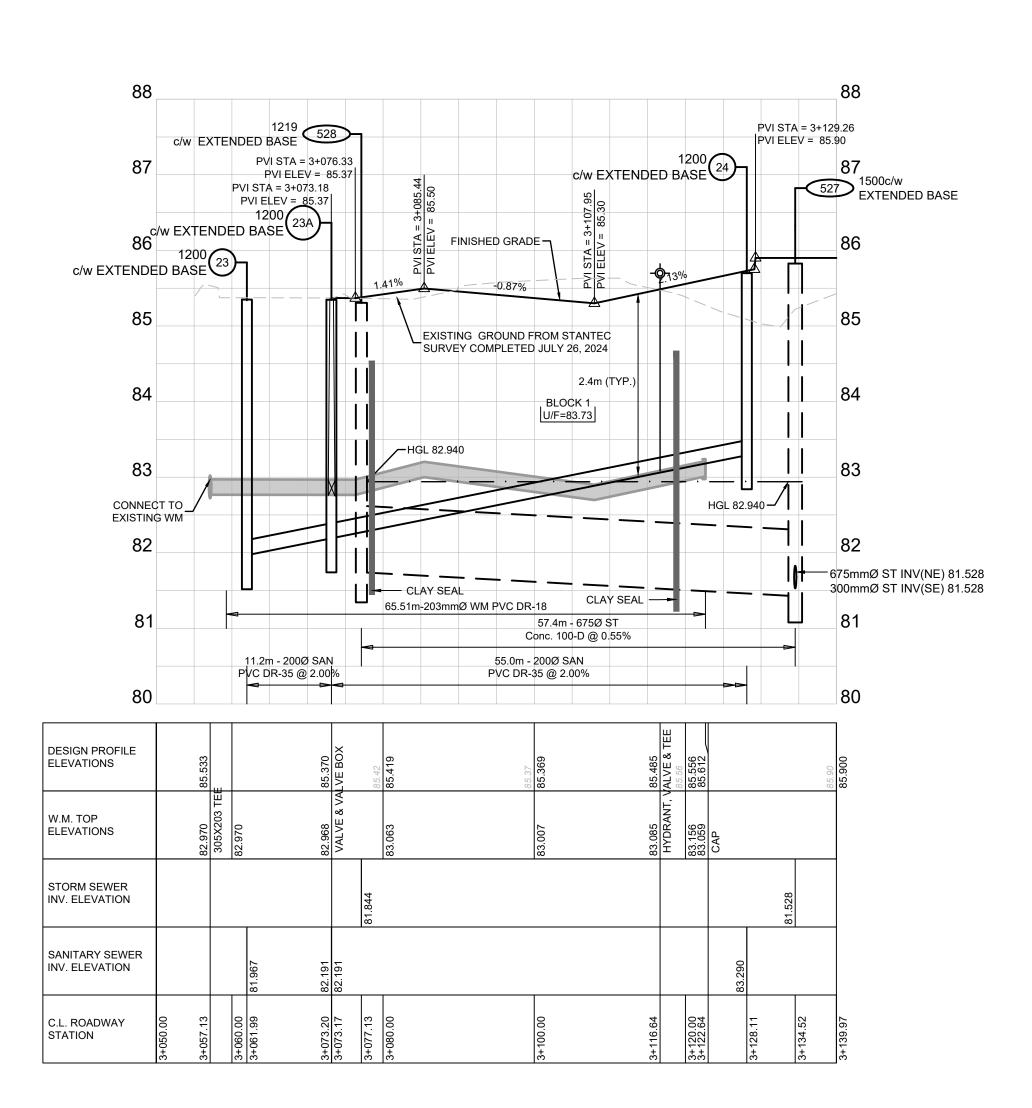

BLOCK 14 EASEMENT

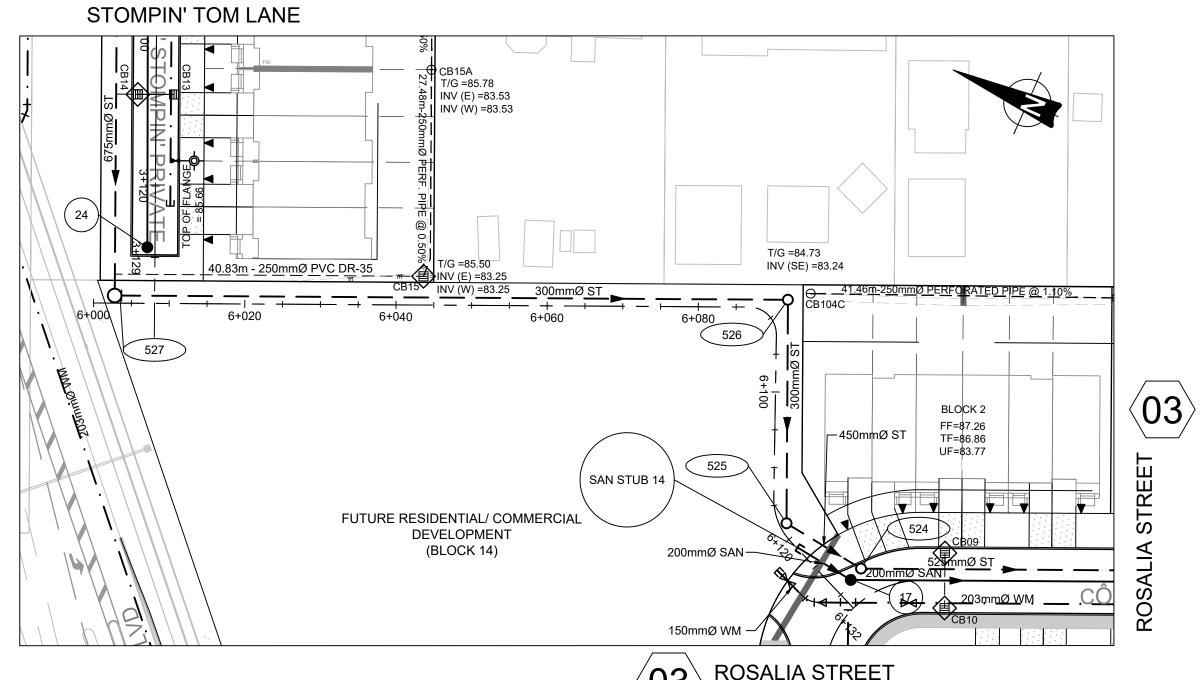

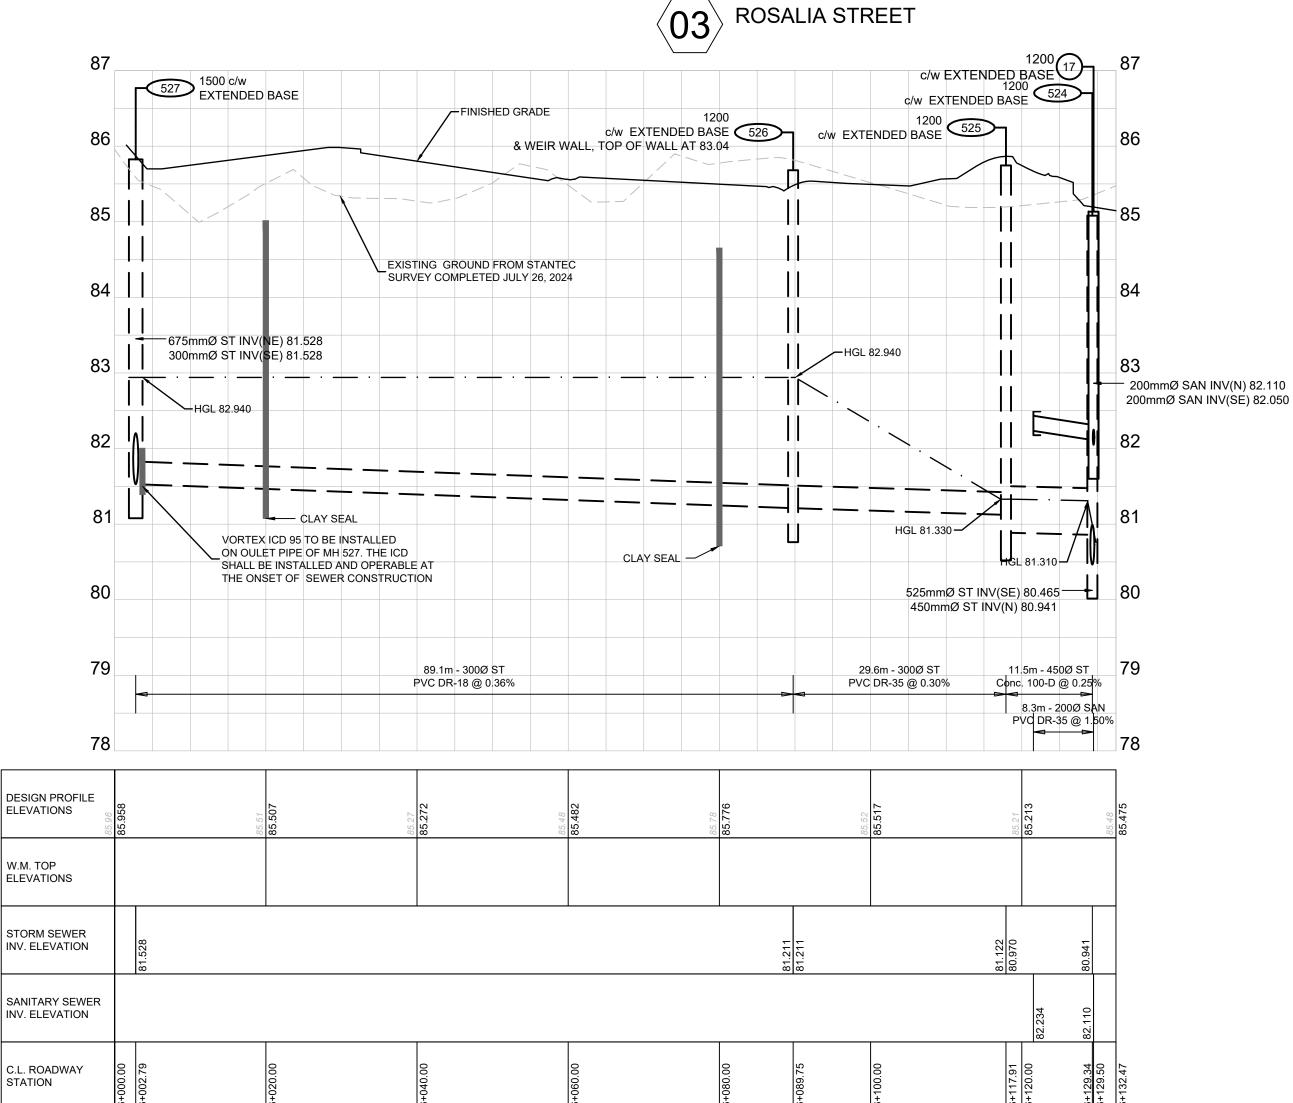

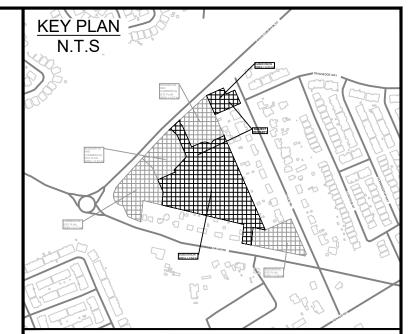

PROPOSED WATERMAIN, VALVE & HYDRANT

EXISTING WATERMAIN, VALVE & HYDRANT

EXISTING SANITARY SEWER & MANHOLE

PROPOSED SANITARY SEWER & MANHOLE

PROPOSED STORM SEWER & MANHOLE

PROPOSED FORCE MAIN

HYDRAULIC GRADE LINE (HGL)

STEPPED FOOTING

FIREWALL

PROPOSED CULVERT

DRAWING NUMBER

RIP-RAP TO OPSD 810.010 (TYPE B)

EXISTING CATCH BASIN C/W ICD

PROPOSED TEC CATCHBASIN

PROPOSED TEC CATCHBASIN

PROPOSED TE CATCHBASIN

PROPOSED TE CATCHBASIN

MANHOLE NUMBER AND SIZE (mm) c/w EXTENDED BASE

PER DETAIL DO1 ON D1

3 LATERAL - SERVICE CONNECTION

(100mm ST, 135 SAN, 19 mm Water)

TACTILE WALKING INDICATOR STRIP (TWIS)

CONC. SIDEWALK

ASPHALT

INFILTRATION TRENCH

—	FER TO GEOTECHNICAL REPORTS FOR ALL RECOMMENDAT MPLETE GROUNDWATER INFORMATION.	TIONS AND
06	RE-ISSUED TO CITY FOR ENGINEERING REVIEW (THIRD RE-SUBMISSION)	20/09/24
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SCALE: 1:500 H, 1:50 V



CONSULTANT:

J.L.Richards
ENGINEERS-ARCHITECTS-PLANNERS

CONSULTANT:



EAST RIDGE ORLEANS

2983, 3053, & 3079 NAVAN ROAD & 2690 PAGE ROAD OTTAWA, ONTARIO

SUBDIVISION

RAWING:

PLAN AND PROFILE STOMPIN' TOM LANE & EASEMET 3+050 TO 3+139.97 & 6+000 TO 6+132.47

DESIGN: TR

DRAWN: KT


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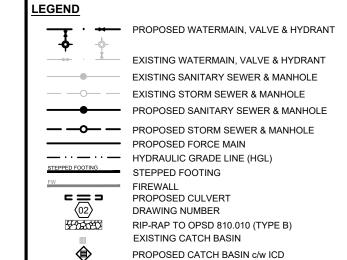
JLR #: 29899-002

LOT DATE: September 20, 2024 3:47:27 PM :ITY PLAN No. 18572 CITY FILE No. D07-16-21-0027

BRIAN COBURN BOULEVARD

EXISTING UNDERGROUND INFORMATION SHOWN HAS BEEN TAKEN FROM CITY OF OTTAWA UCC DRAWINGS PROVIDED BY OTTAWA INFORMATION CENTRE- MAY 2024. ALL INFORMATION IS TO BE FIELD VERIFIED BY THE CONTRACTOR



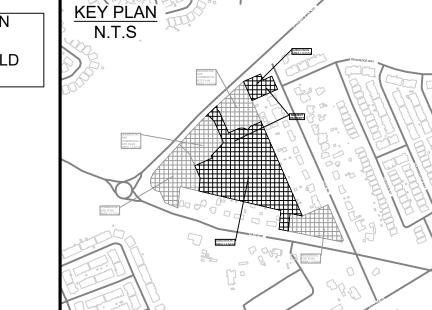

PROPOSED CATCH BASIN & LEAD
PROPOSED TEE CATCHBASIN
PROPOSED 3-WAY CATCHBASIN
MANHOLE NUMBER AND SIZE (mm) c/w SAFETY PLATFORM
PER OPSD 404.020
MANHOLE NUMBER AND SIZE (mm) c/w EXTENDED BASE
PER DETAIL D01 ON D1
3 LATERAL - SERVICE CONNECTION
(100mm ST, 135 SAN, 19 mm Water)

TACTILE WALKING INDICATOR STRIP (TWIS)

CONC. SIDEWALK
ASPHALT
INFILTRATION TRENCH

* REFER TO GEOTECHNICAL REPORTS FOR ALL RECOMMENDATIONS AND COMPLETE GROUNDWATER INFORMATION. 06 RE-ISSUED TO CITY FOR ENGINEERING REVIEW (THIRD RE-SUBMISSION) 20/09/24

06	(THIRD RE-SUBMISSION)	20/09/24
05	RE-ISSUED TO CITY FOR ENGINEERING REVIEW (THIRD SUBMISSION)	27/08/24
04	RE-ISSUED FOR MUNICIPAL CONSENT	04/03/24
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02	ISSUED FOR MUNICIPAL CONSENT	09/02/24
01	ISSUED TO CITY FOR ENGINEERING REVIEW	22/09/23
No.	ISSUE / REVISION	DD/MM/YY

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VERIFY SHEET SIZE AND SCALES. THE BAR TO

SCALE: 1:500H, 1:50V

=NT·



ONSULTANT:

J.L.Richards

CONSULTANT:





07

PROJECT:


EAST RIDGE ORLEANS SUBDIVISION


2983, 3053, & 3079 NAVAN ROAD & 2690 PAGE ROAD OTTAWA, ONTARIO

WING:

PLAN AND PROFILE BRIAN COBURN BOULEVARD STA. 5+050 TO 5+253.36

DESIGN:	TR	
DRAWN:	KT	DRAW
CHECKED:	KF	
JLR #:	29899-002	

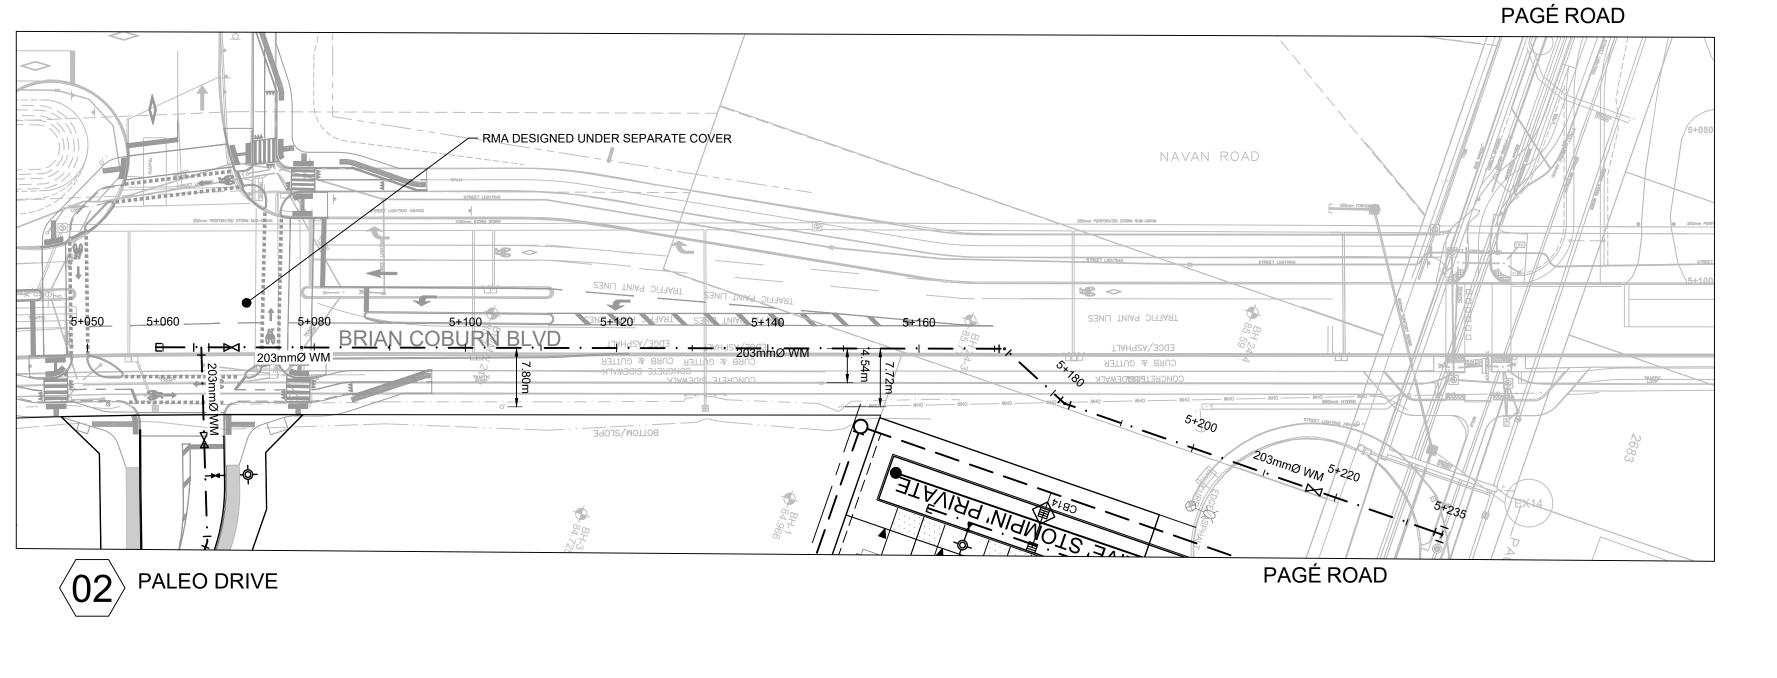


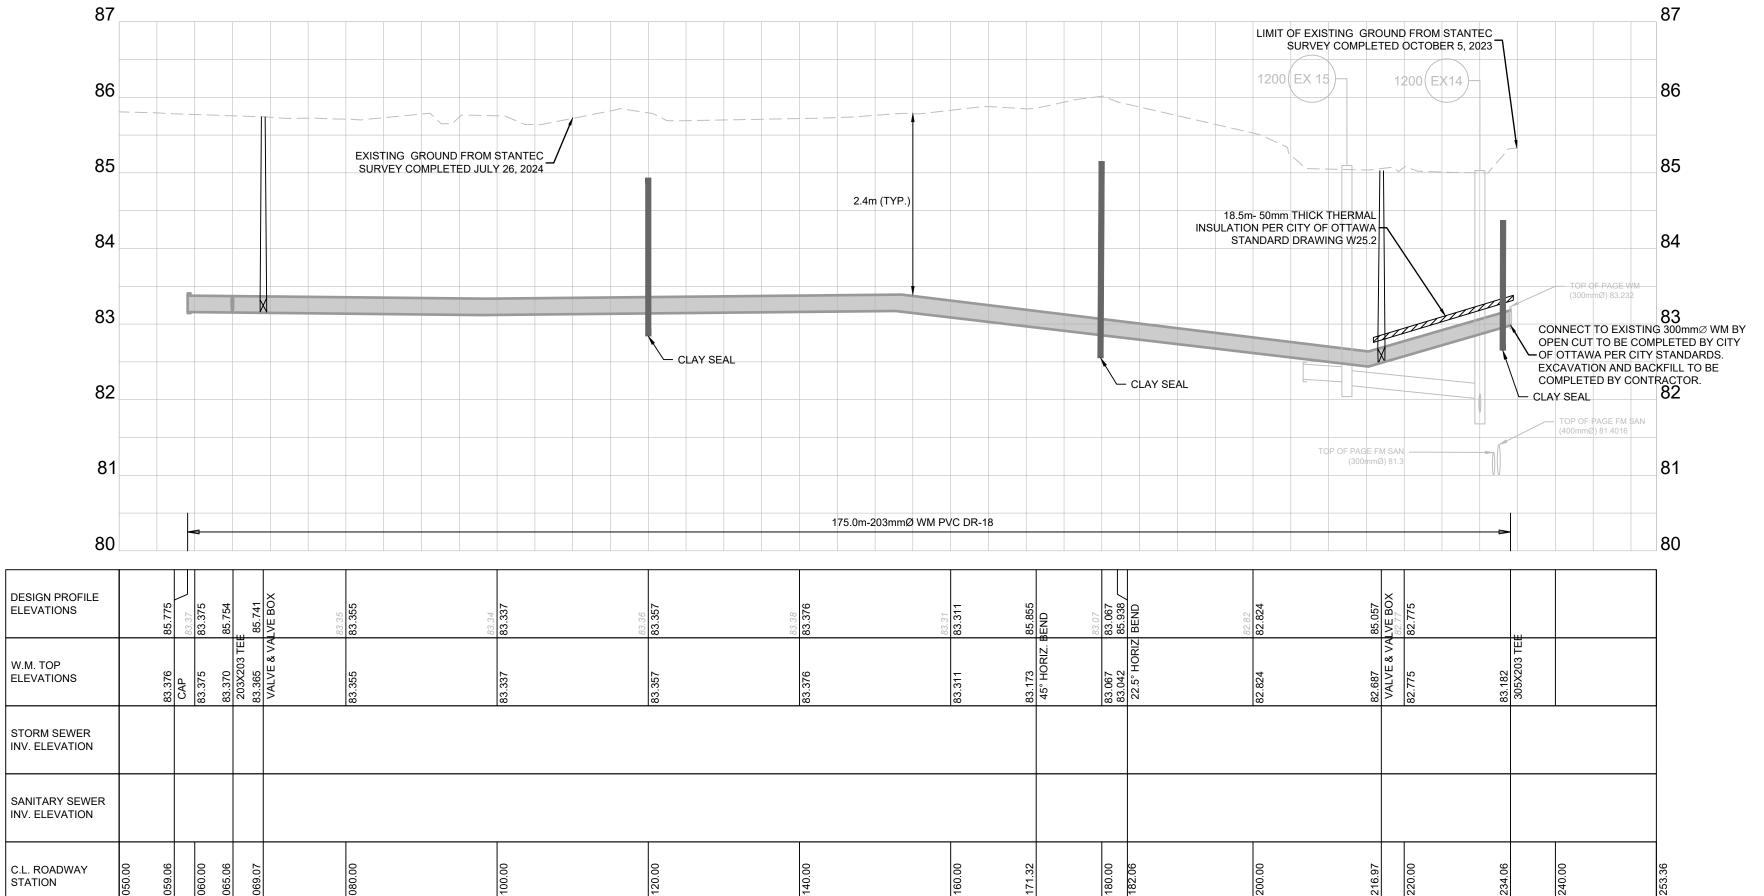



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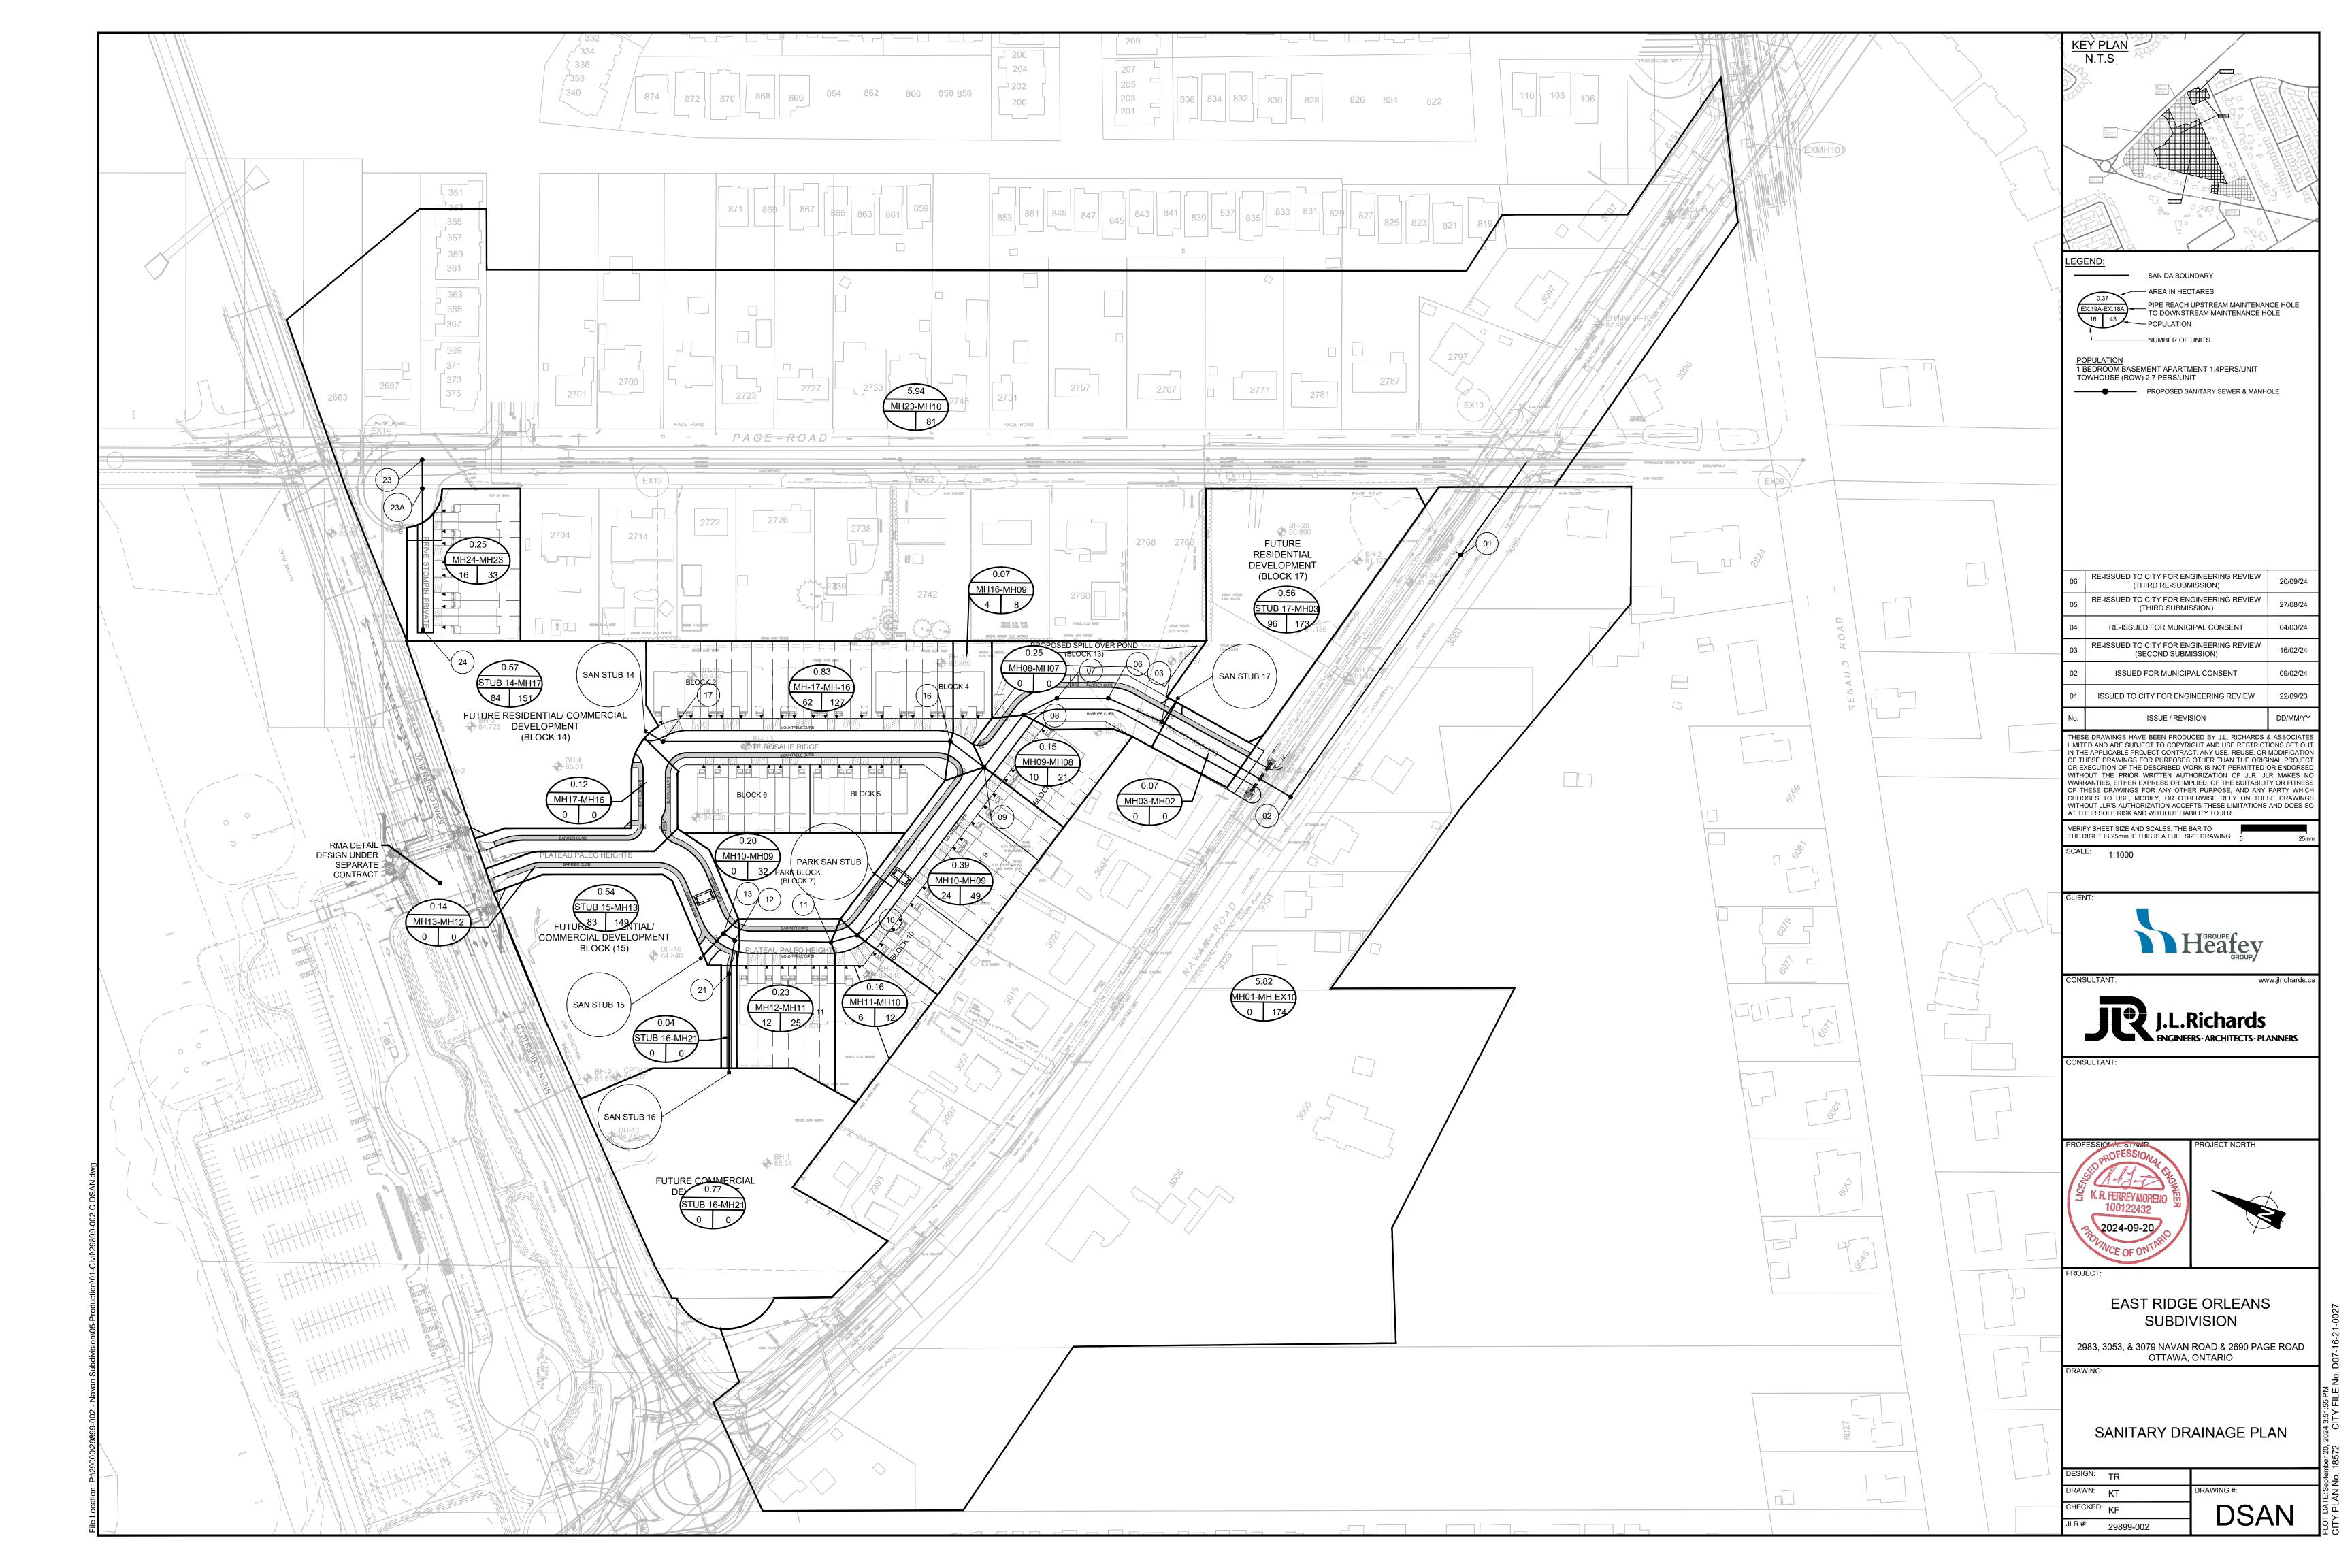
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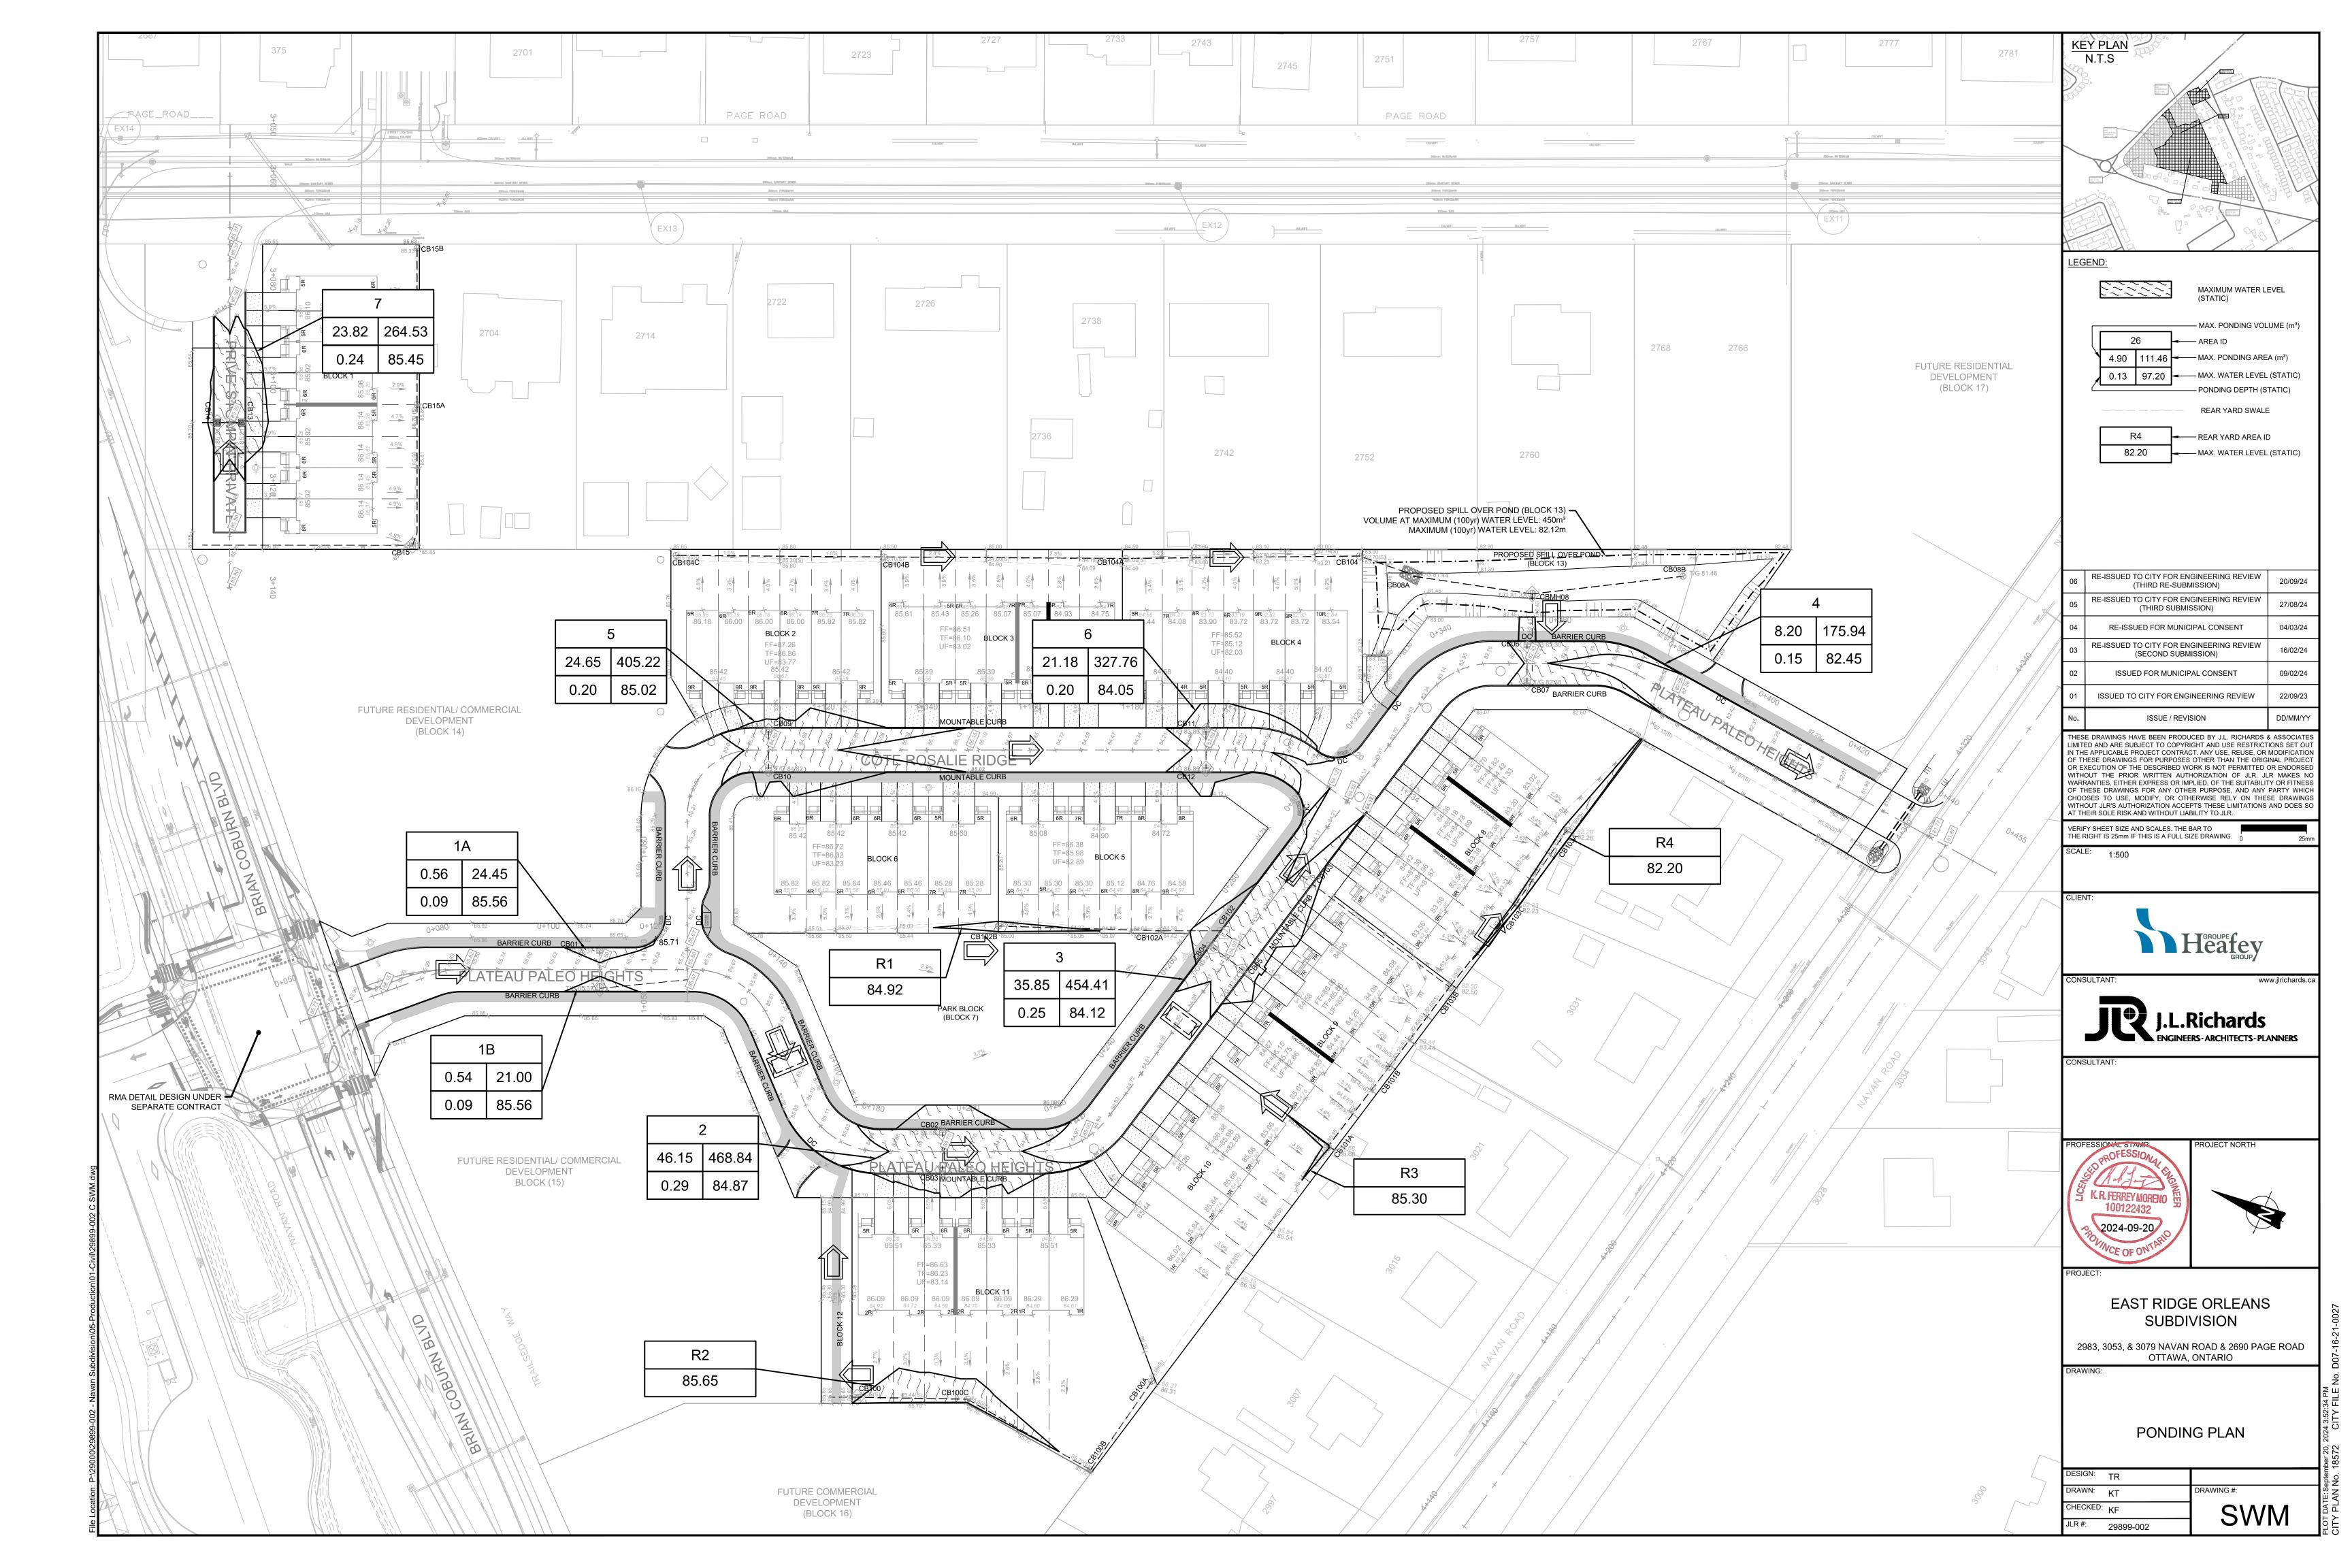
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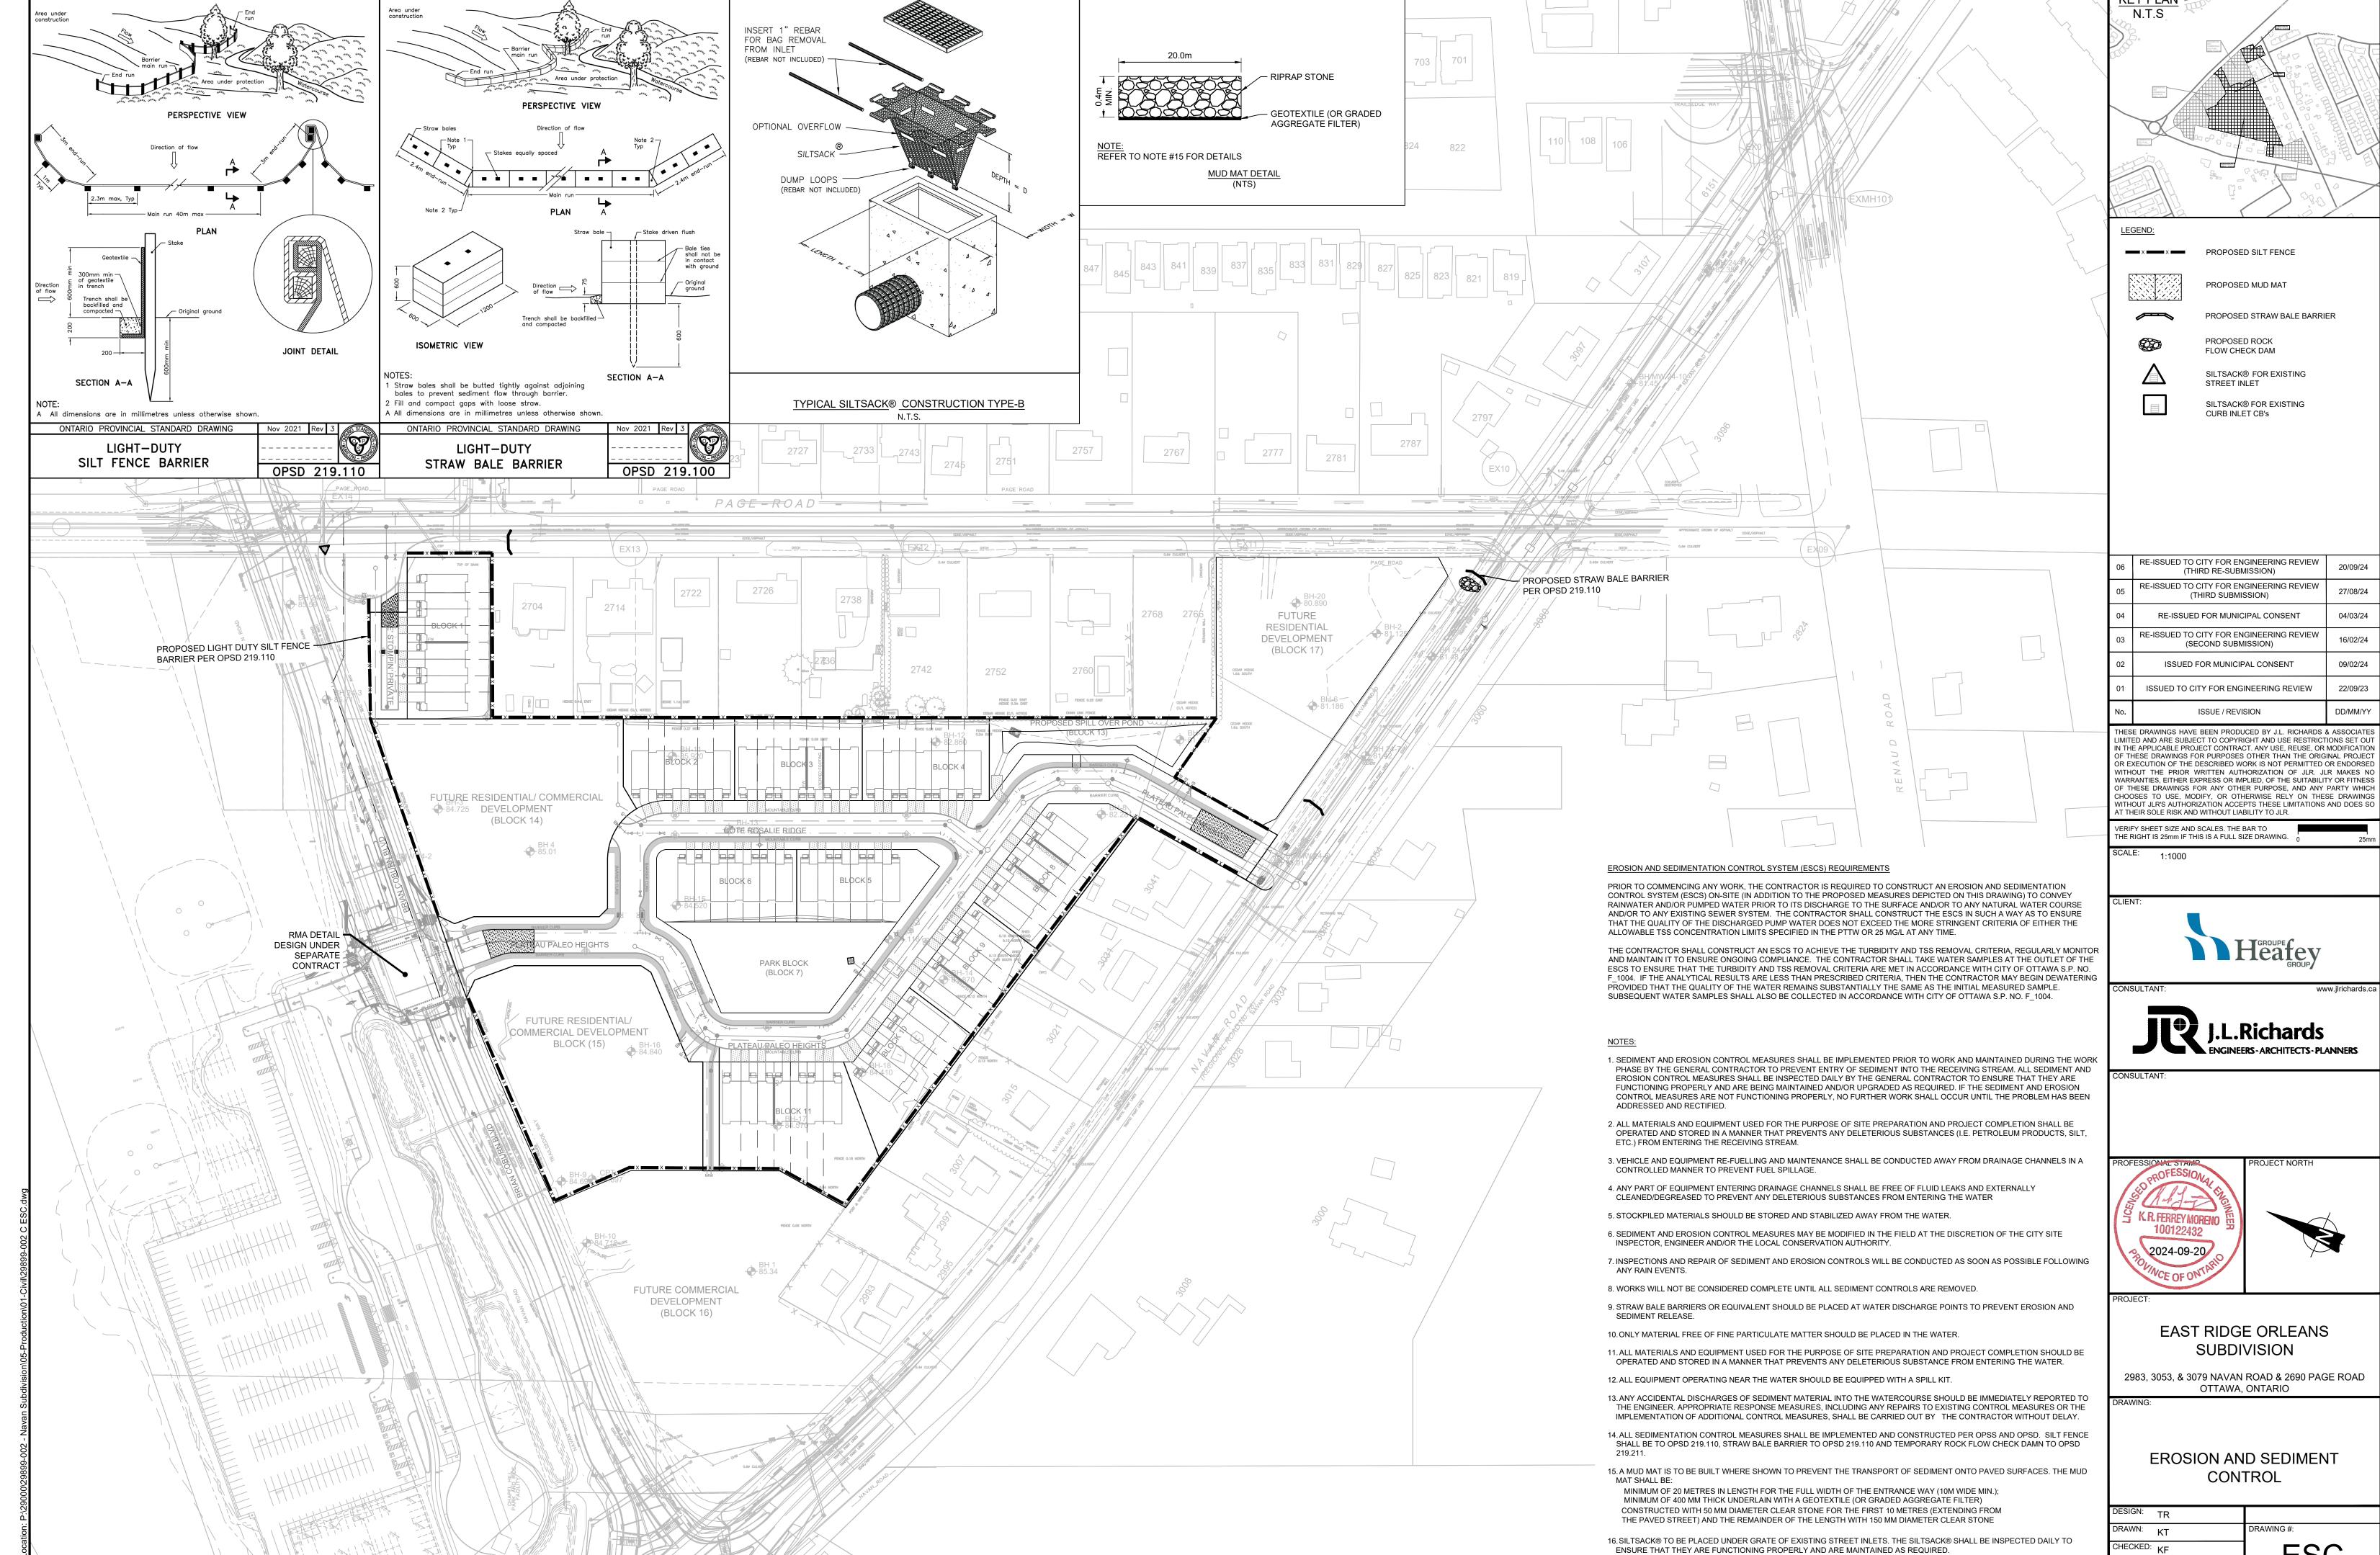







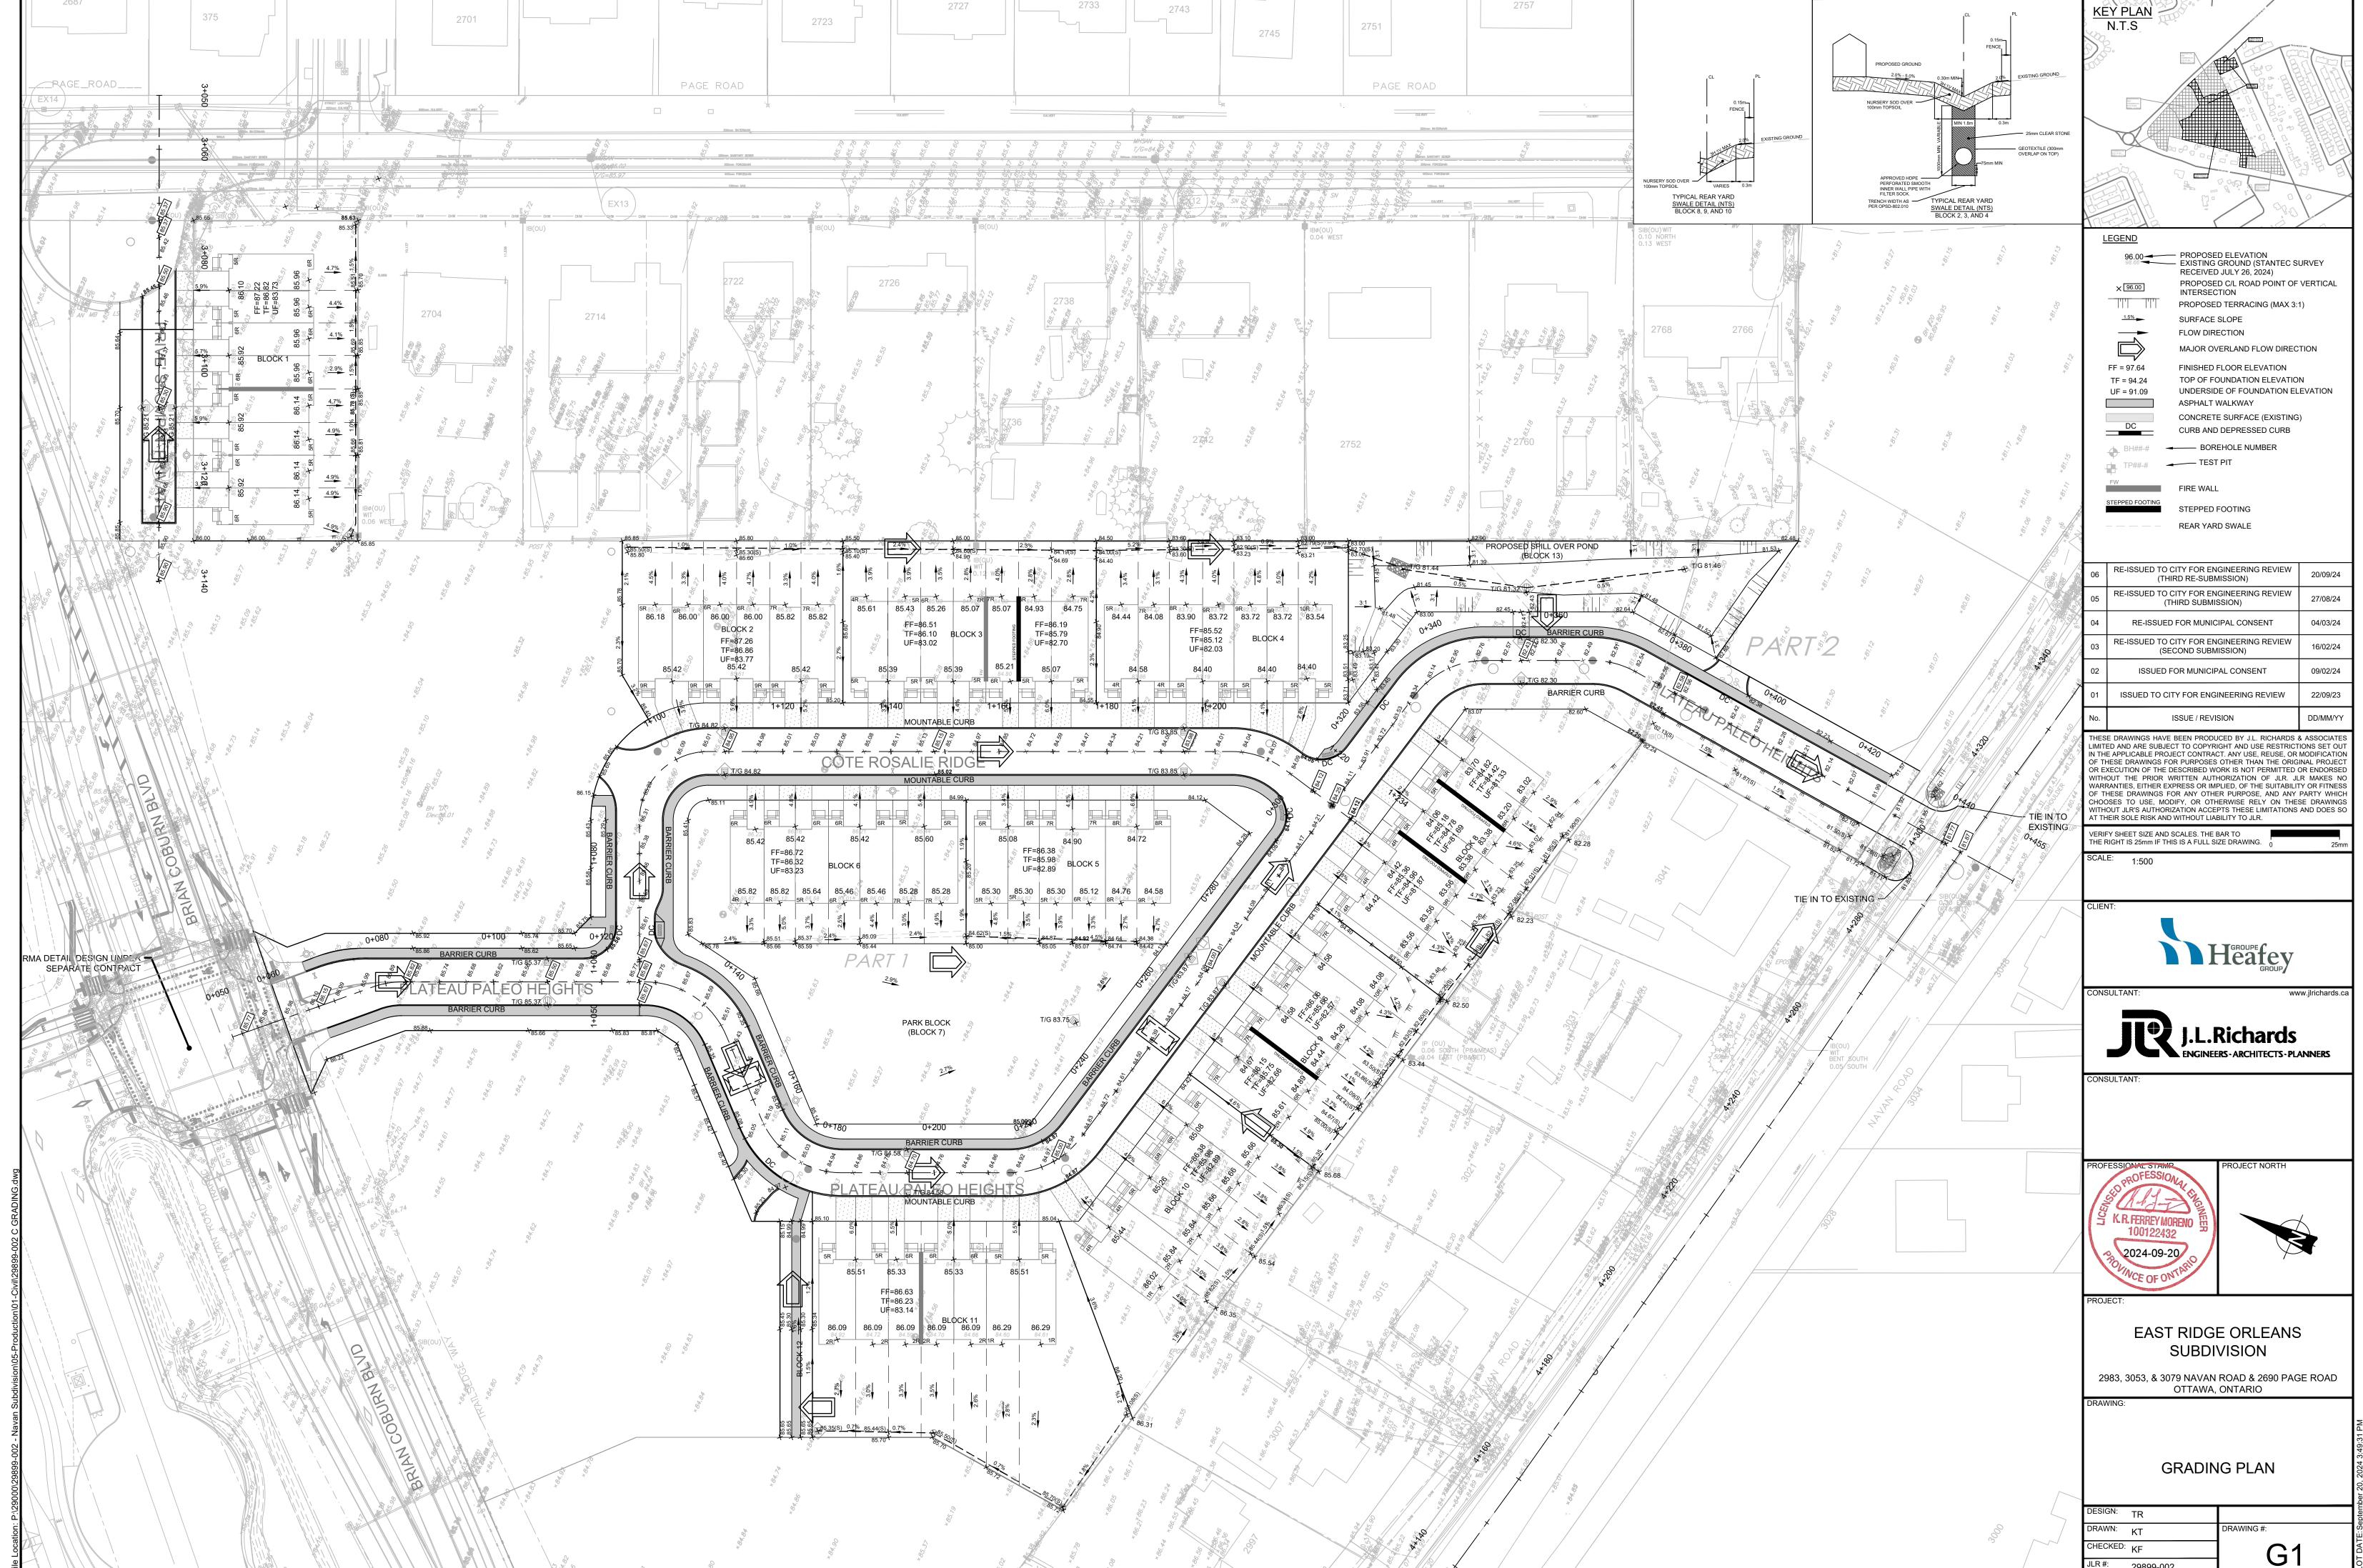


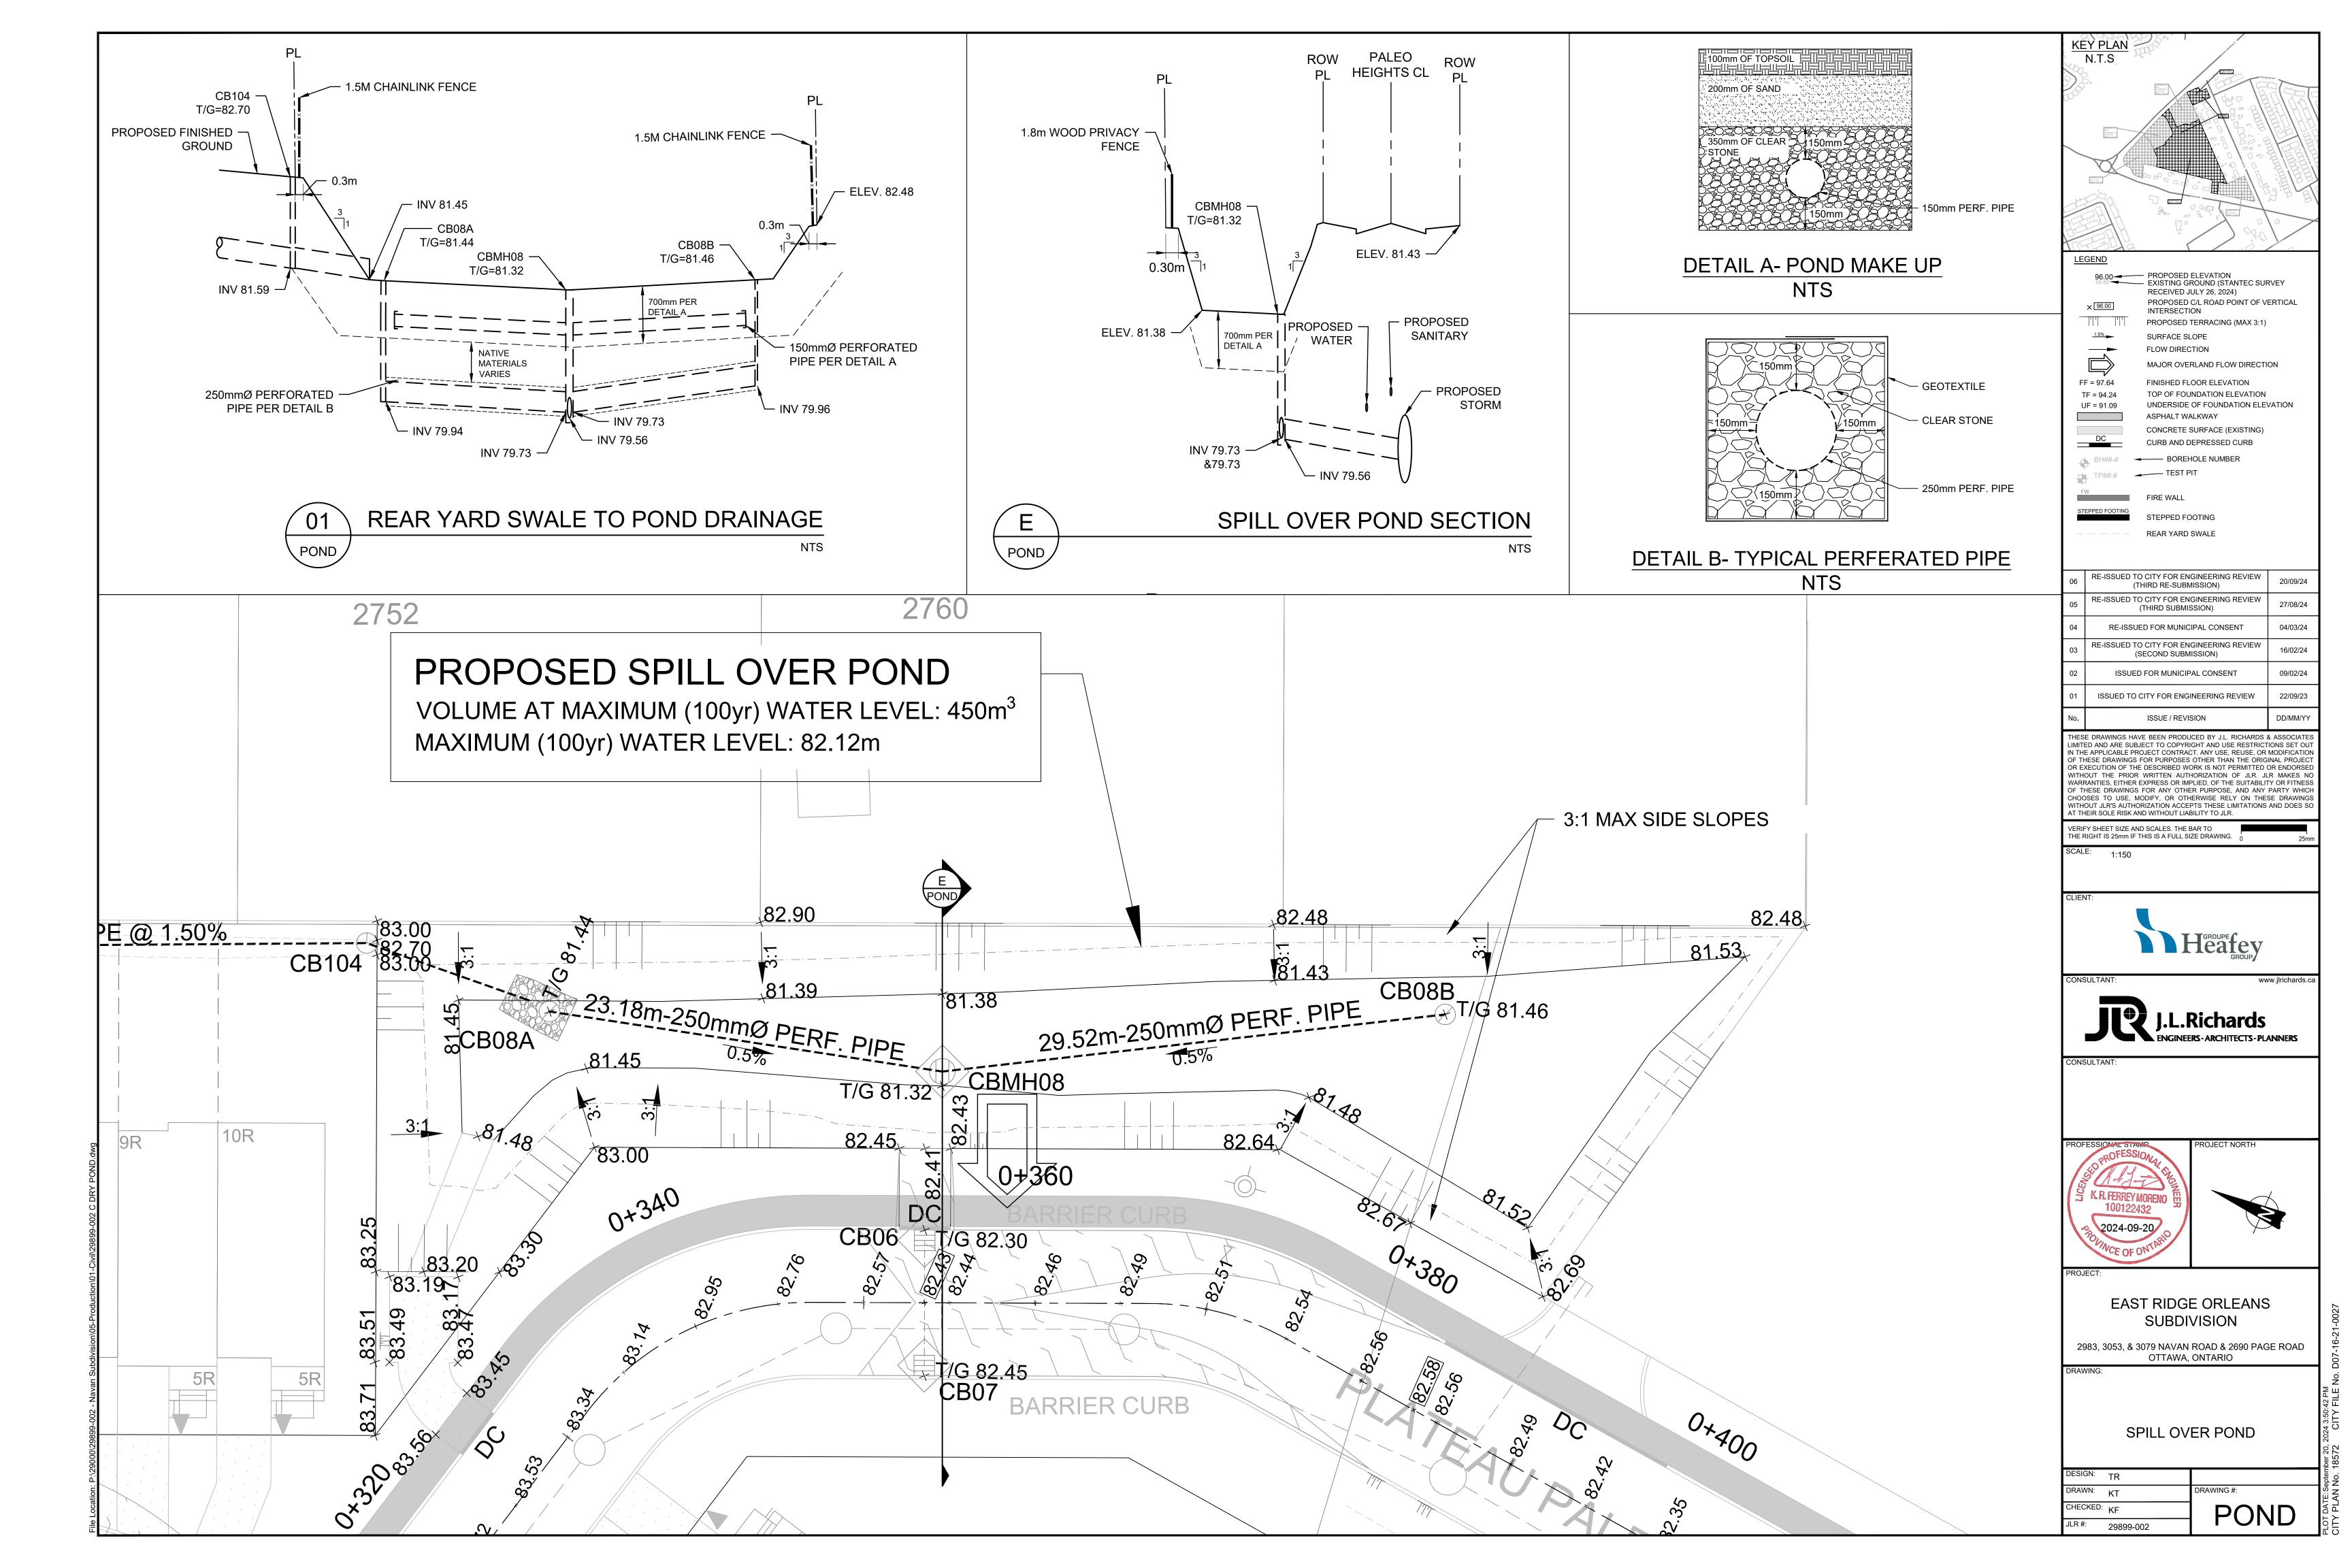


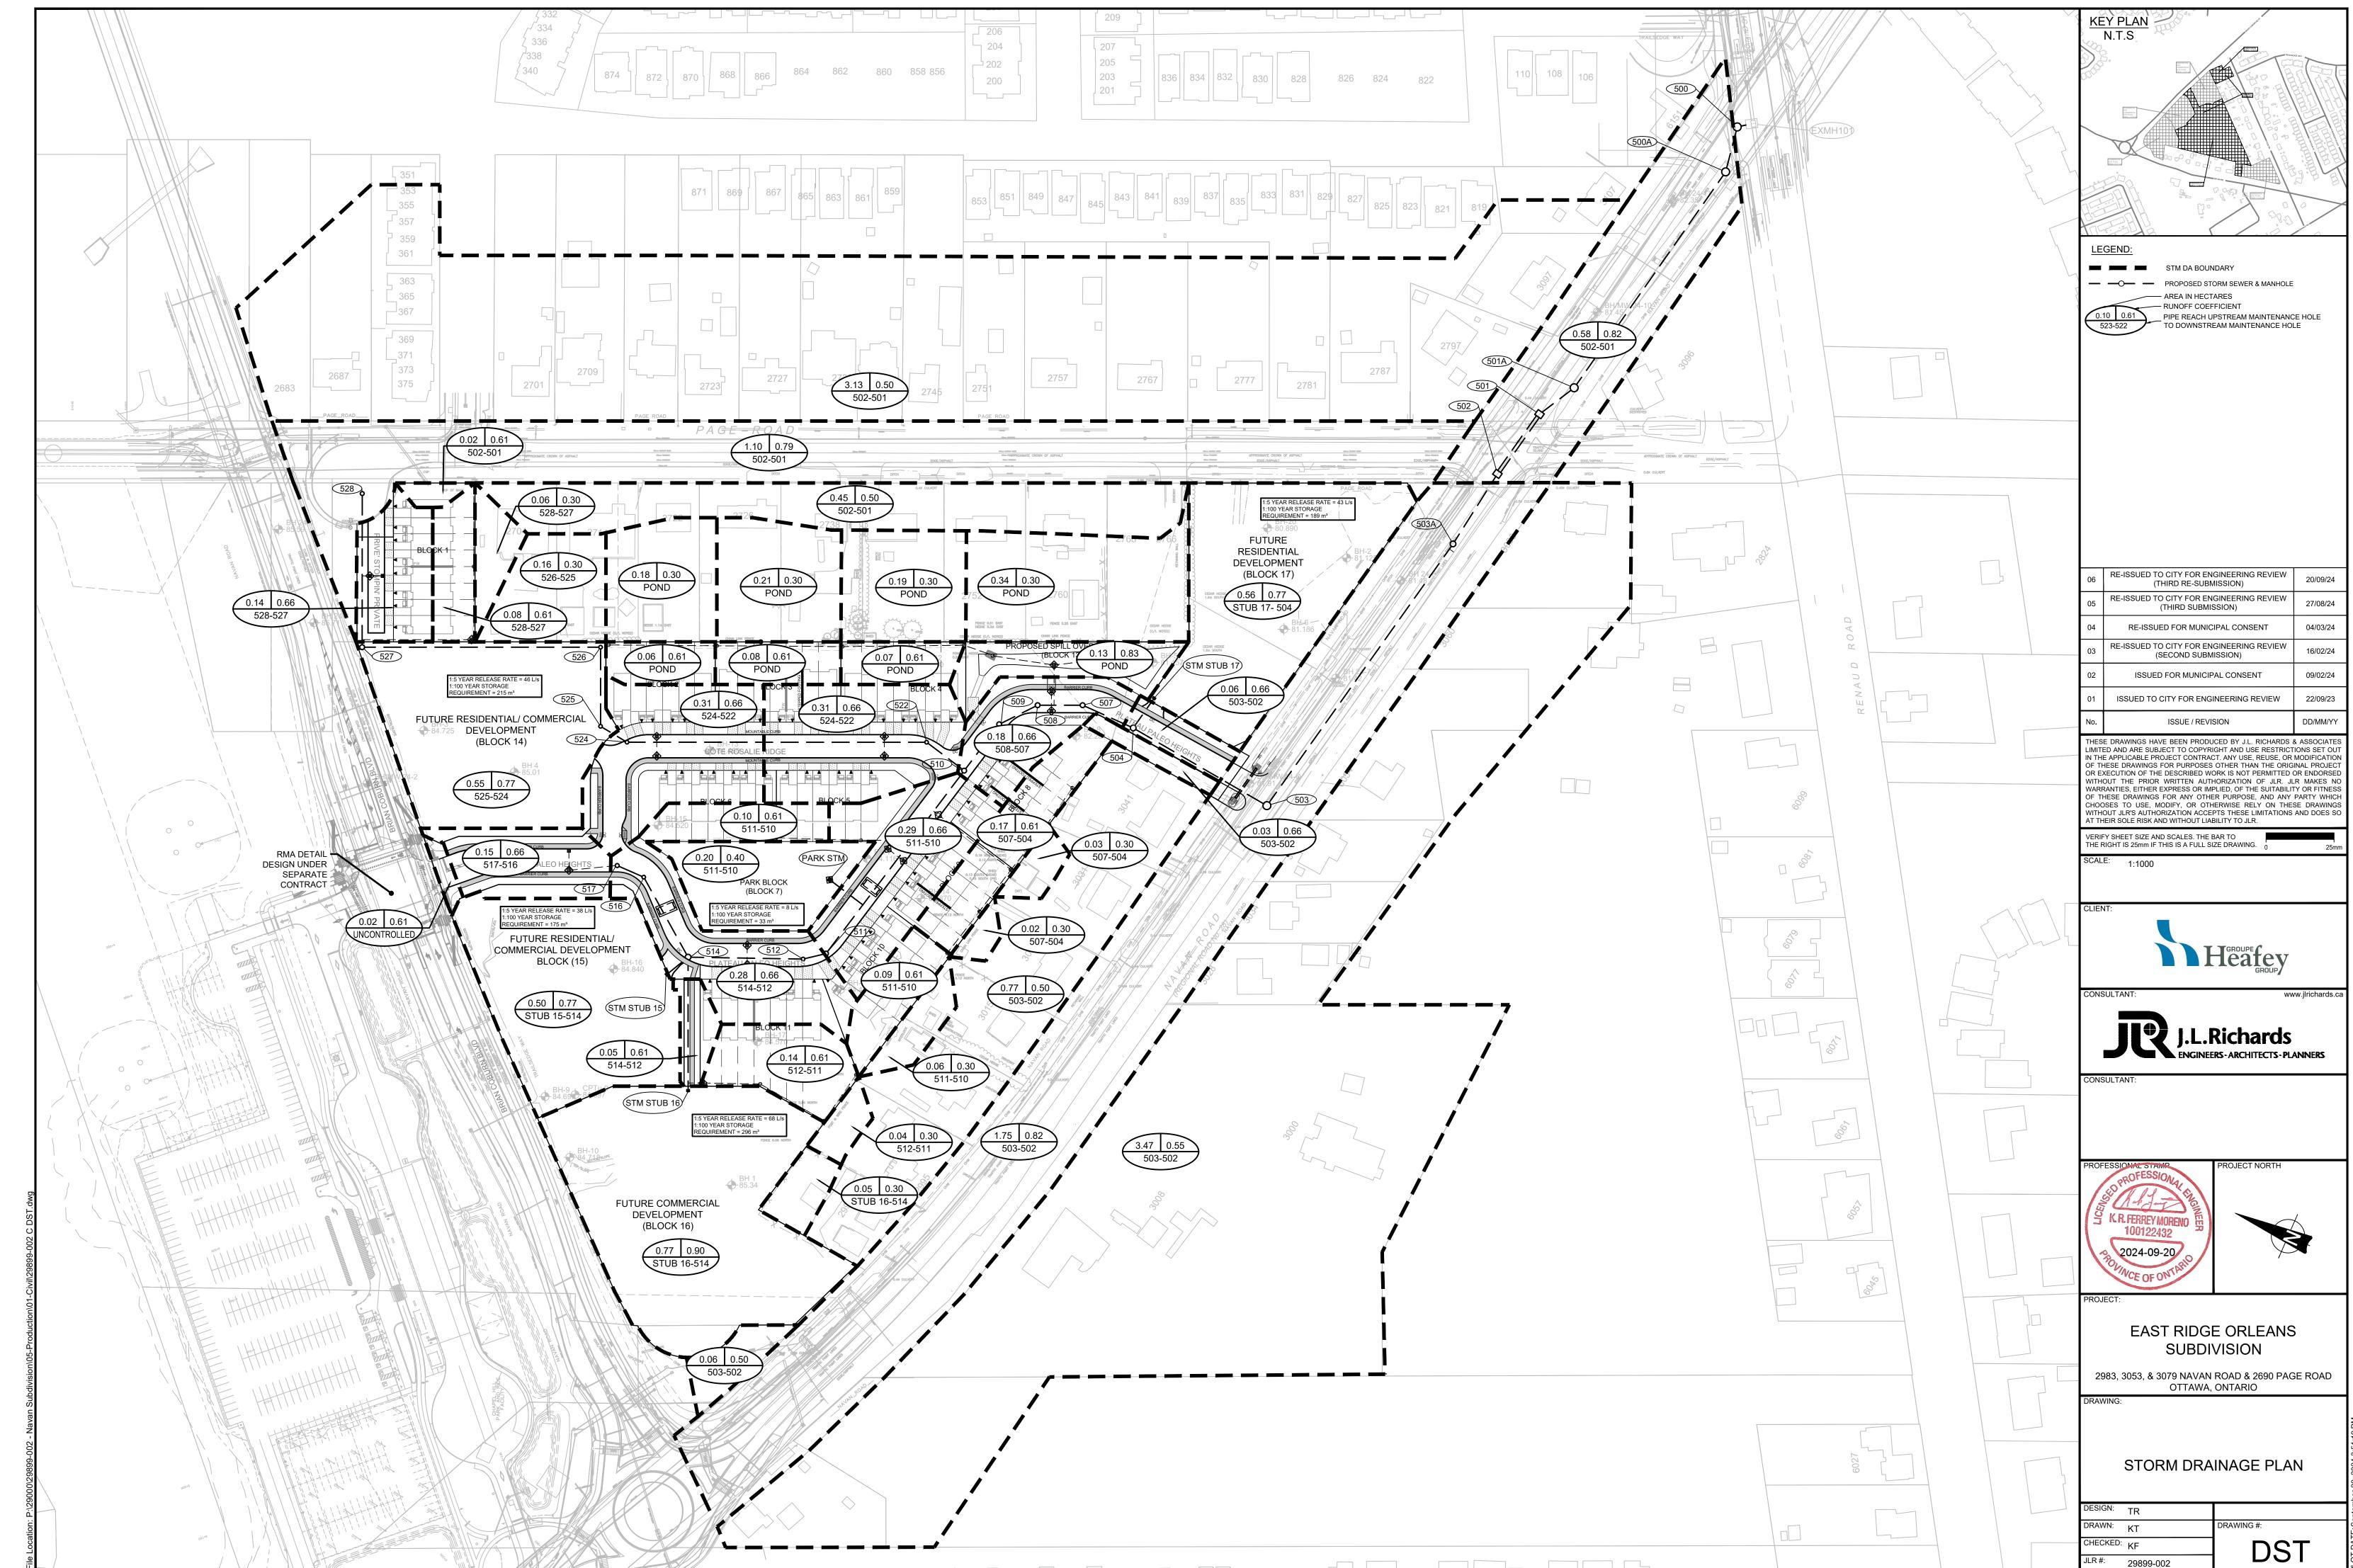


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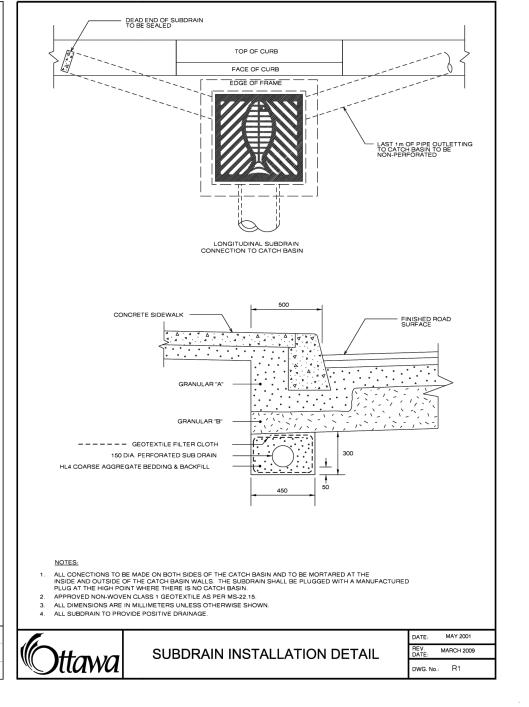


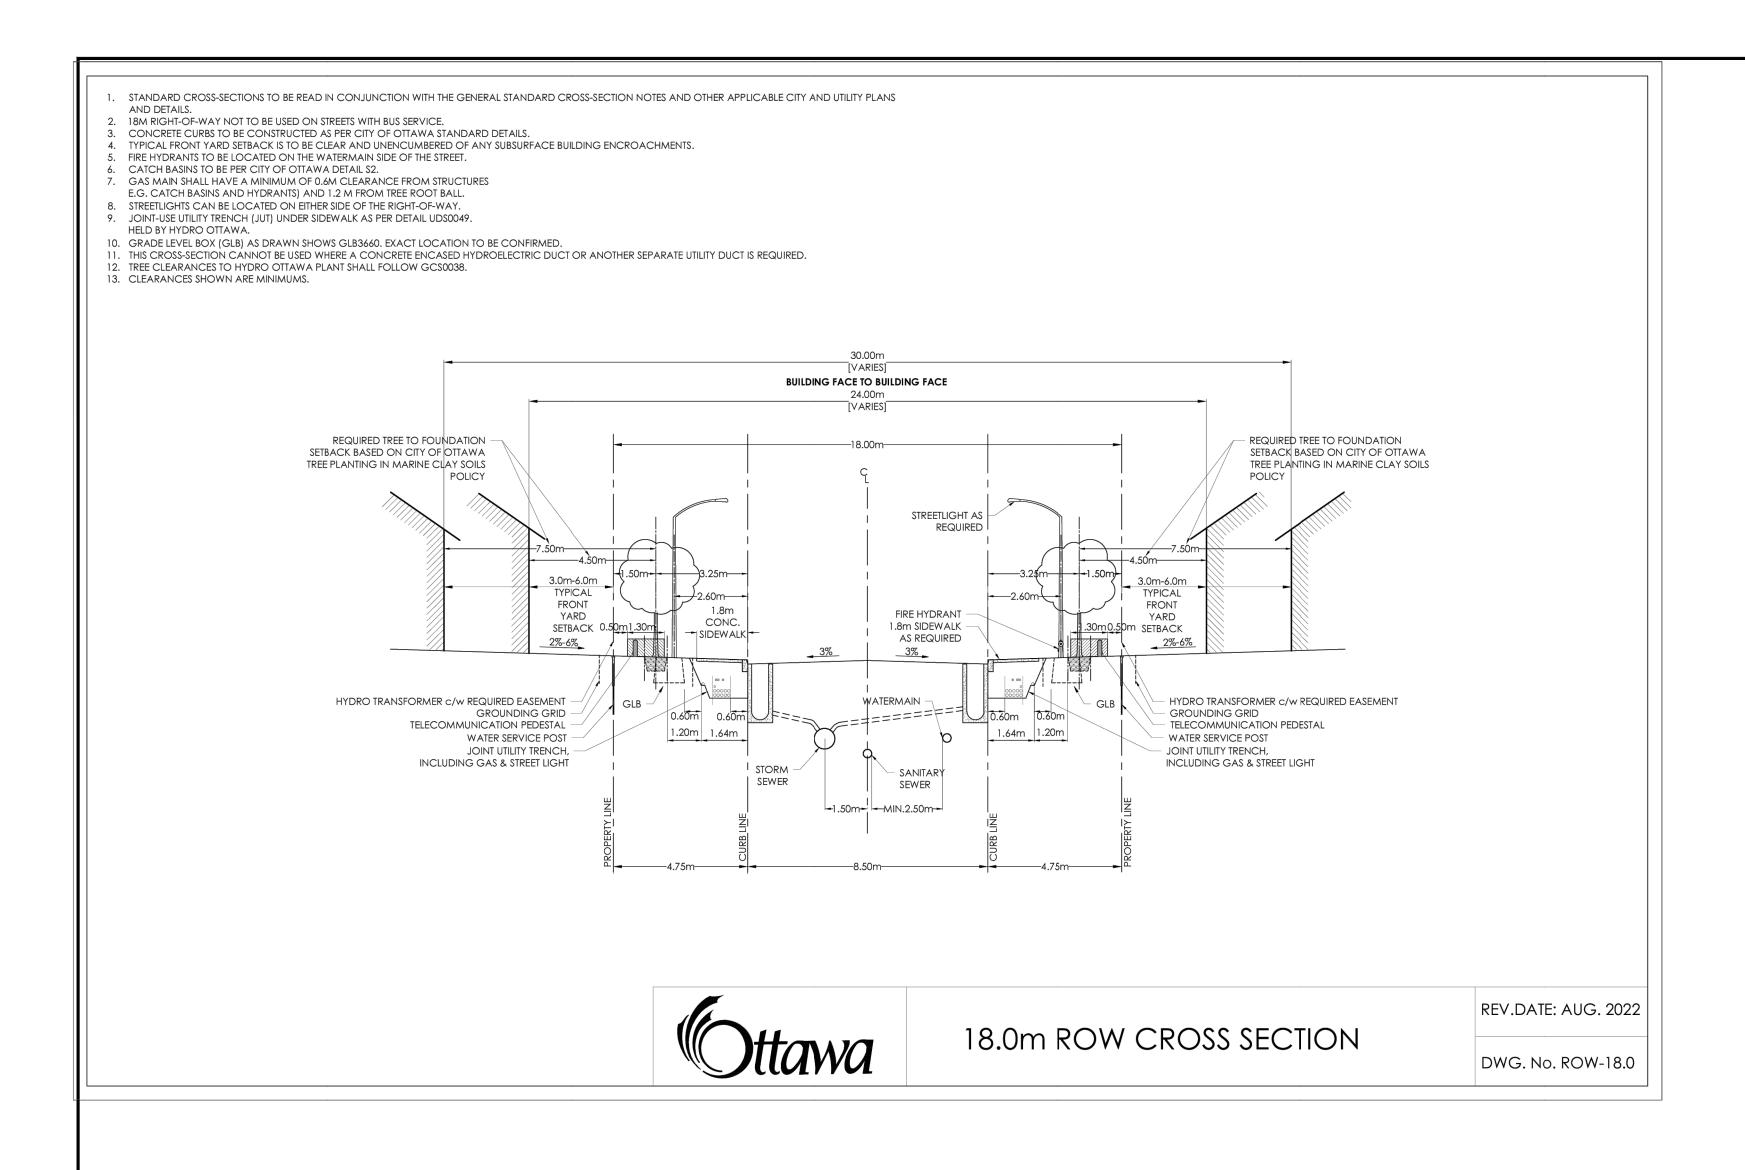


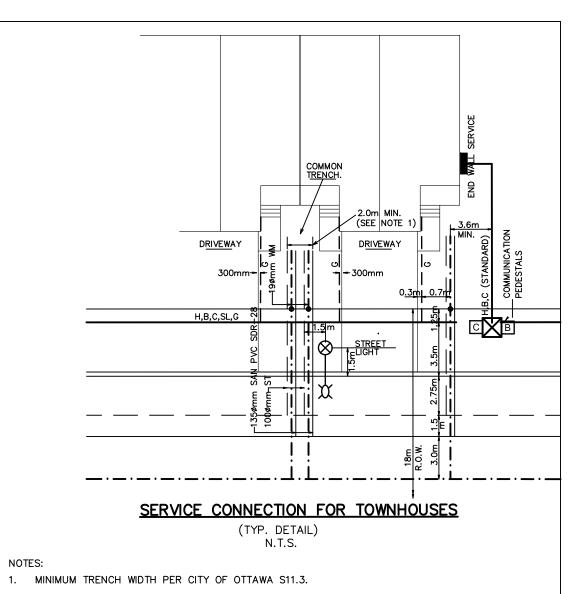


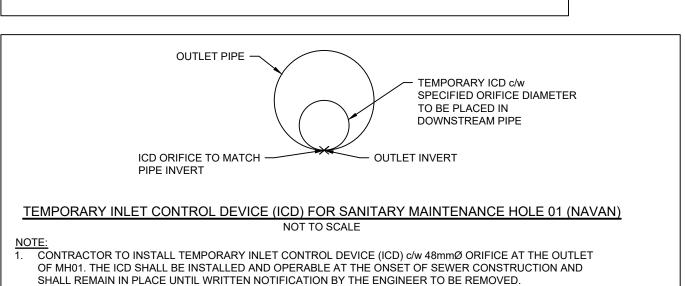ICD TO BE INSTALLED ON OUTLET PIPE



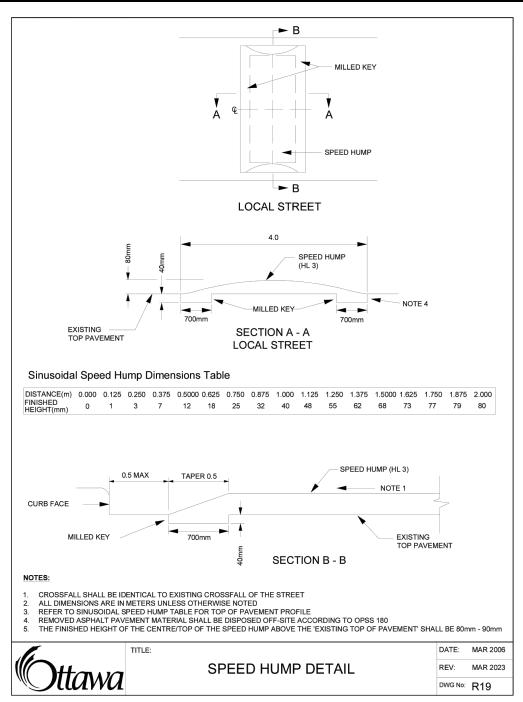

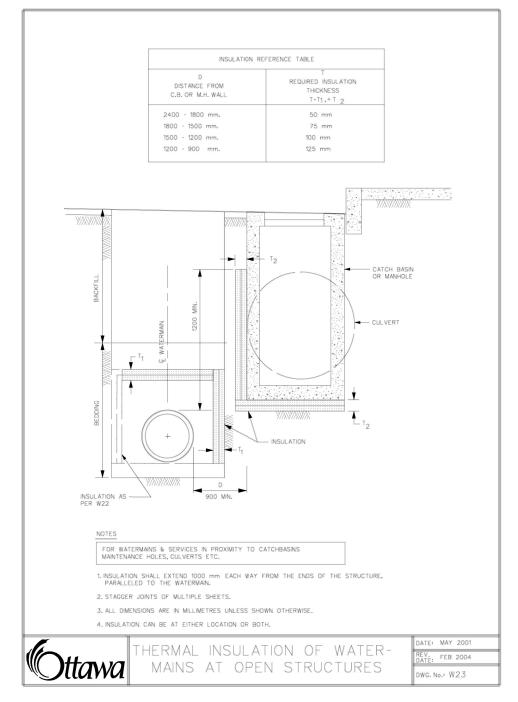

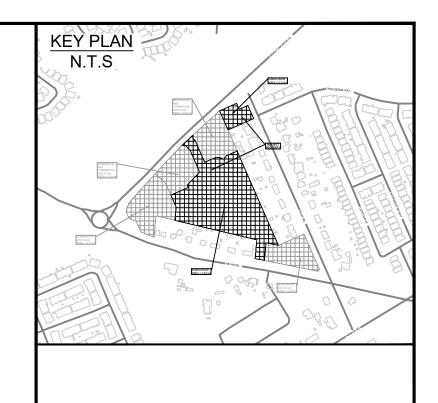

06	RE-ISSUED TO CITY FOR ENGINEERING REVIEW (THIRD RE-SUBMISSION)	20/09/24						
05	RE-ISSUED TO CITY FOR ENGINEERING REVIEW (THIRD SUBMISSION)	27/08/24						
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No.	ISSUE / REVISION	DD/MM/YY						
THES	THESE DRAWINGS HAVE BEEN PRODUCED BY J.L. RICHARDS & ASSOCIATES							

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VERIFY SHEET SIZE AND SCALES. THE BAR TO THE RIGHT IS 25mm IF THIS IS A FULL SIZE DRAWING.

SCALE:

Heafey GROUP

CONSULTANT:



CONSULTANT:



PROJECT:


EAST RIDGE ORLEANS SUBDIVISION

2983, 3053, & 3079 NAVAN ROAD & 2690 PAGE ROAD OTTAWA, ONTARIO

WING:


DETAILS AND CROSS SECTIONS

DESIGN:	TR	
DRAWN:	KT	DRAWING #:
CHECKED:	KF	D1
JLR #:	29899-002	

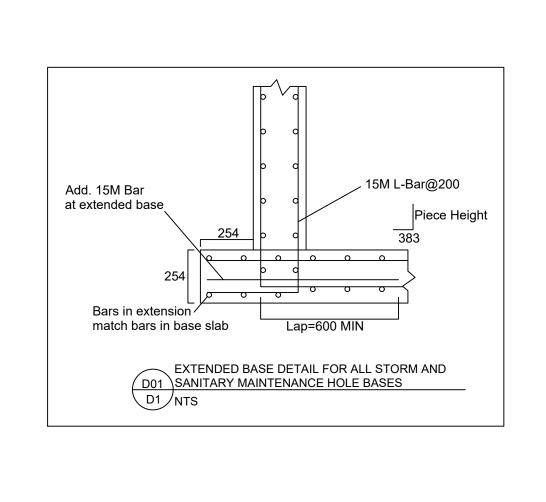

STREET CATCHBASINS											
Street Name	CB ID Number	T/G	Inlet		Ou	tlet	Rational Method Capture Rate	Max Depth (100 yr) (m)	1:100 Yr Restricted Capture Rate	ICD TYPE	
			Pipe Dia. (mm)	Invert	Pipe Dia. (mm)	Invert	(85 L/s/ha)	(Excel)	(L/s)		
	CB01	85.37	-	-	200	84.07	-	-	-	NO ICD	
	CBMH517A	85.37	200	84.00	250	83.94	13.00	1.61	12.00	Vortex_ICD_105	
	CB02	84.58	-	-	200	83.18	11.00	1.59	11.00	Vortex_ICD_100	
PALEO DRIVE	CB03	84.58	-	-	200	83.18	16.00	1.59	23.00	MHF_IPEX_TYPE_A	
PALEO DRIVE	CB04	83.87	-	_	200	82.47	12.50	1.64	13.00	Vortex_ICD_105	
	CB05	83.87	-	_	200	82.47	12.50	1.64	13.00	Vortex_ICD_105	
	CB06	82.3	-	_	200	80.90	7.50	1.54	12.00	Vortex_ICD_105	
	CB07	82.3	-	_	200	80.90	7.50	1.54	12.00	Vortex_ICD_105	
	CB09	84.82	-	-	200	83.42	13.00	1.63	12.00	Vortex_ICD_105	
ROSALIA	CB10	84.82	-	-	200	83.42	13.00	1.63	12.00	Vortex_ICD_105	
STREET	CB11	83.85	-	-	200	82.45	13.00	1.64	13.00	Vortex_ICD_105	
	CB12	83.85	-	-	200	82.45	13.00	1.64	13.00	Vortex_ICD_105	
STOMPIN' TOM	CB13	85.21	-	_	200	83.81	-	-	-	NO ICD	
LANE	CB14	85.21	200	83.76	250	83.70	20.00*	1.67	23.00	MHF_IPEX_TYPE_A	
EASEMENT	STOMP_TOM_ICD	85.68	675	81.53	300	81.53	22.00	3.89	14.00	Vortex_ICD_95	
*The Rational Metho	od Capture Rate alon	g Stompin'	Tom Lane	is based or	n the 2-yr Fl	ows					

REAR YARD CATCH BASIN TABLE														
Street Name	CB ID Number	T/G	Inlet					Outlet				Drop (m)	1:100 Yr Restricted Capture Rate	ICD TYPE
			Pipe Dia. (mm)	Pipe Length (m)	Slope	Invert	Cover	Pipe Dia. (mm)	Pipe Length (m)	Invert	COVER (m)		(L/s)	
	CB15B	85.33	-	-	-	-	-	250	30.41	83.880	1.20		-	NO ICD
BLOCK 1	CB15A	85.78	250	30.41	0.5%	83.728	1.80	250	27.48	83.728	1.80		-	NO ICD
	CB15	85.50	250	27.48	0.5%	83.591	1.66	250	40.83	83.591	1.66		14.00	Vortex_ICD_105
	CB100A	86.08	-	-	-	-	-	250	20.91	84.330	1.50		-	NO ICD
BLOCK 11	CB100B	85.70	250	20.91	1.0%	84.118	1.33	250	27.56	84.118	1.33		-	NO ICD
BLOCK 11	CB100C	85.53	250	27.56	0.8%	83.885	1.40	250	21.46	83.885	1.40		-	NO ICD
	CB100	85.30	250	21.46	1.2%	83.627	1.42	250	5.50	83.627	1.42		47.00	MHF_IPEX_TYPE
BLOCK 2, 3, 4	CB104C	85.50	-	-	-	-	-	250	40.46	83.650	1.60		-	NO ICD
	CB104B	85.10	250	40.46	1.0%	83.226	1.62	250	46.92	83.226	1.62		-	NO ICD
	CB104A	84.00	250	46.92	2.0%	82.288	1.46	250	46.44	82.288	1.46		-	NO ICD
	CB104	82.70	250	46.44	1.5%	81.587	0.86	250	10.05	81.587	0.86		-	NO ICD
	CB08A	81.44	-	-	-	-		250	23.18	79.940	1.25		-	NO ICD
POND	CB08B	81.46	-	-	-	-		250	29.52	79.960	1.25		-	NO ICD
FOND	CBMH08	CBMH08 81.32	250	23.18	0.9%	79.728	1.34	250 14.99 79.55	79.558	79.558 1.51	0.17	6.00		
			250	29.52	0.8%	79.728	1.34	200	7	70.000	1.01	0.17	0.00	Vortex_ICD_65
	CB102B	84.62	-	-	-	-		250	31.60	82.970	1.40		-	NO ICD
BLOCK 5	CB102A	84.38	250	31.60	1.0%	82.654	1.48	250	11.77	82.654	1.48		-	NO ICD
	CB102	83.89	250	11.77	2.0%	82.419	1.22	250	4.51	82.419	1.22		8.00	Vortex_ICD_80
BLOCK 8 & 9	CB101A	85.15	-	-	-	-		900	19.61	81.490	2.76		-	NO ICD
	CB101B	83.86	900	19.61	1.0%	81.294	1.67	900	19.48	81.294	1.67		-	NO ICD
	CB103A	81.90	-	-	-	-		300	17.39	80.650	0.95		-	NO ICD
	CB103C	82.08	300	17.39	0.5%	80.563	1.21	300	20.77	80.563	1.21		-	NO ICD
	CB103B	82.25	900	19.48 20.77	1.0% 0.5%	81.099 80.459	0.25 1.49	250	33.45	80.399	1.60	0.06	-	NO ICD
	CB103	84.01	250	33.45	1.0%	80.057	3.70	250	1.60	80.057	3.70		59.00	MHF_IPEX_TYPE

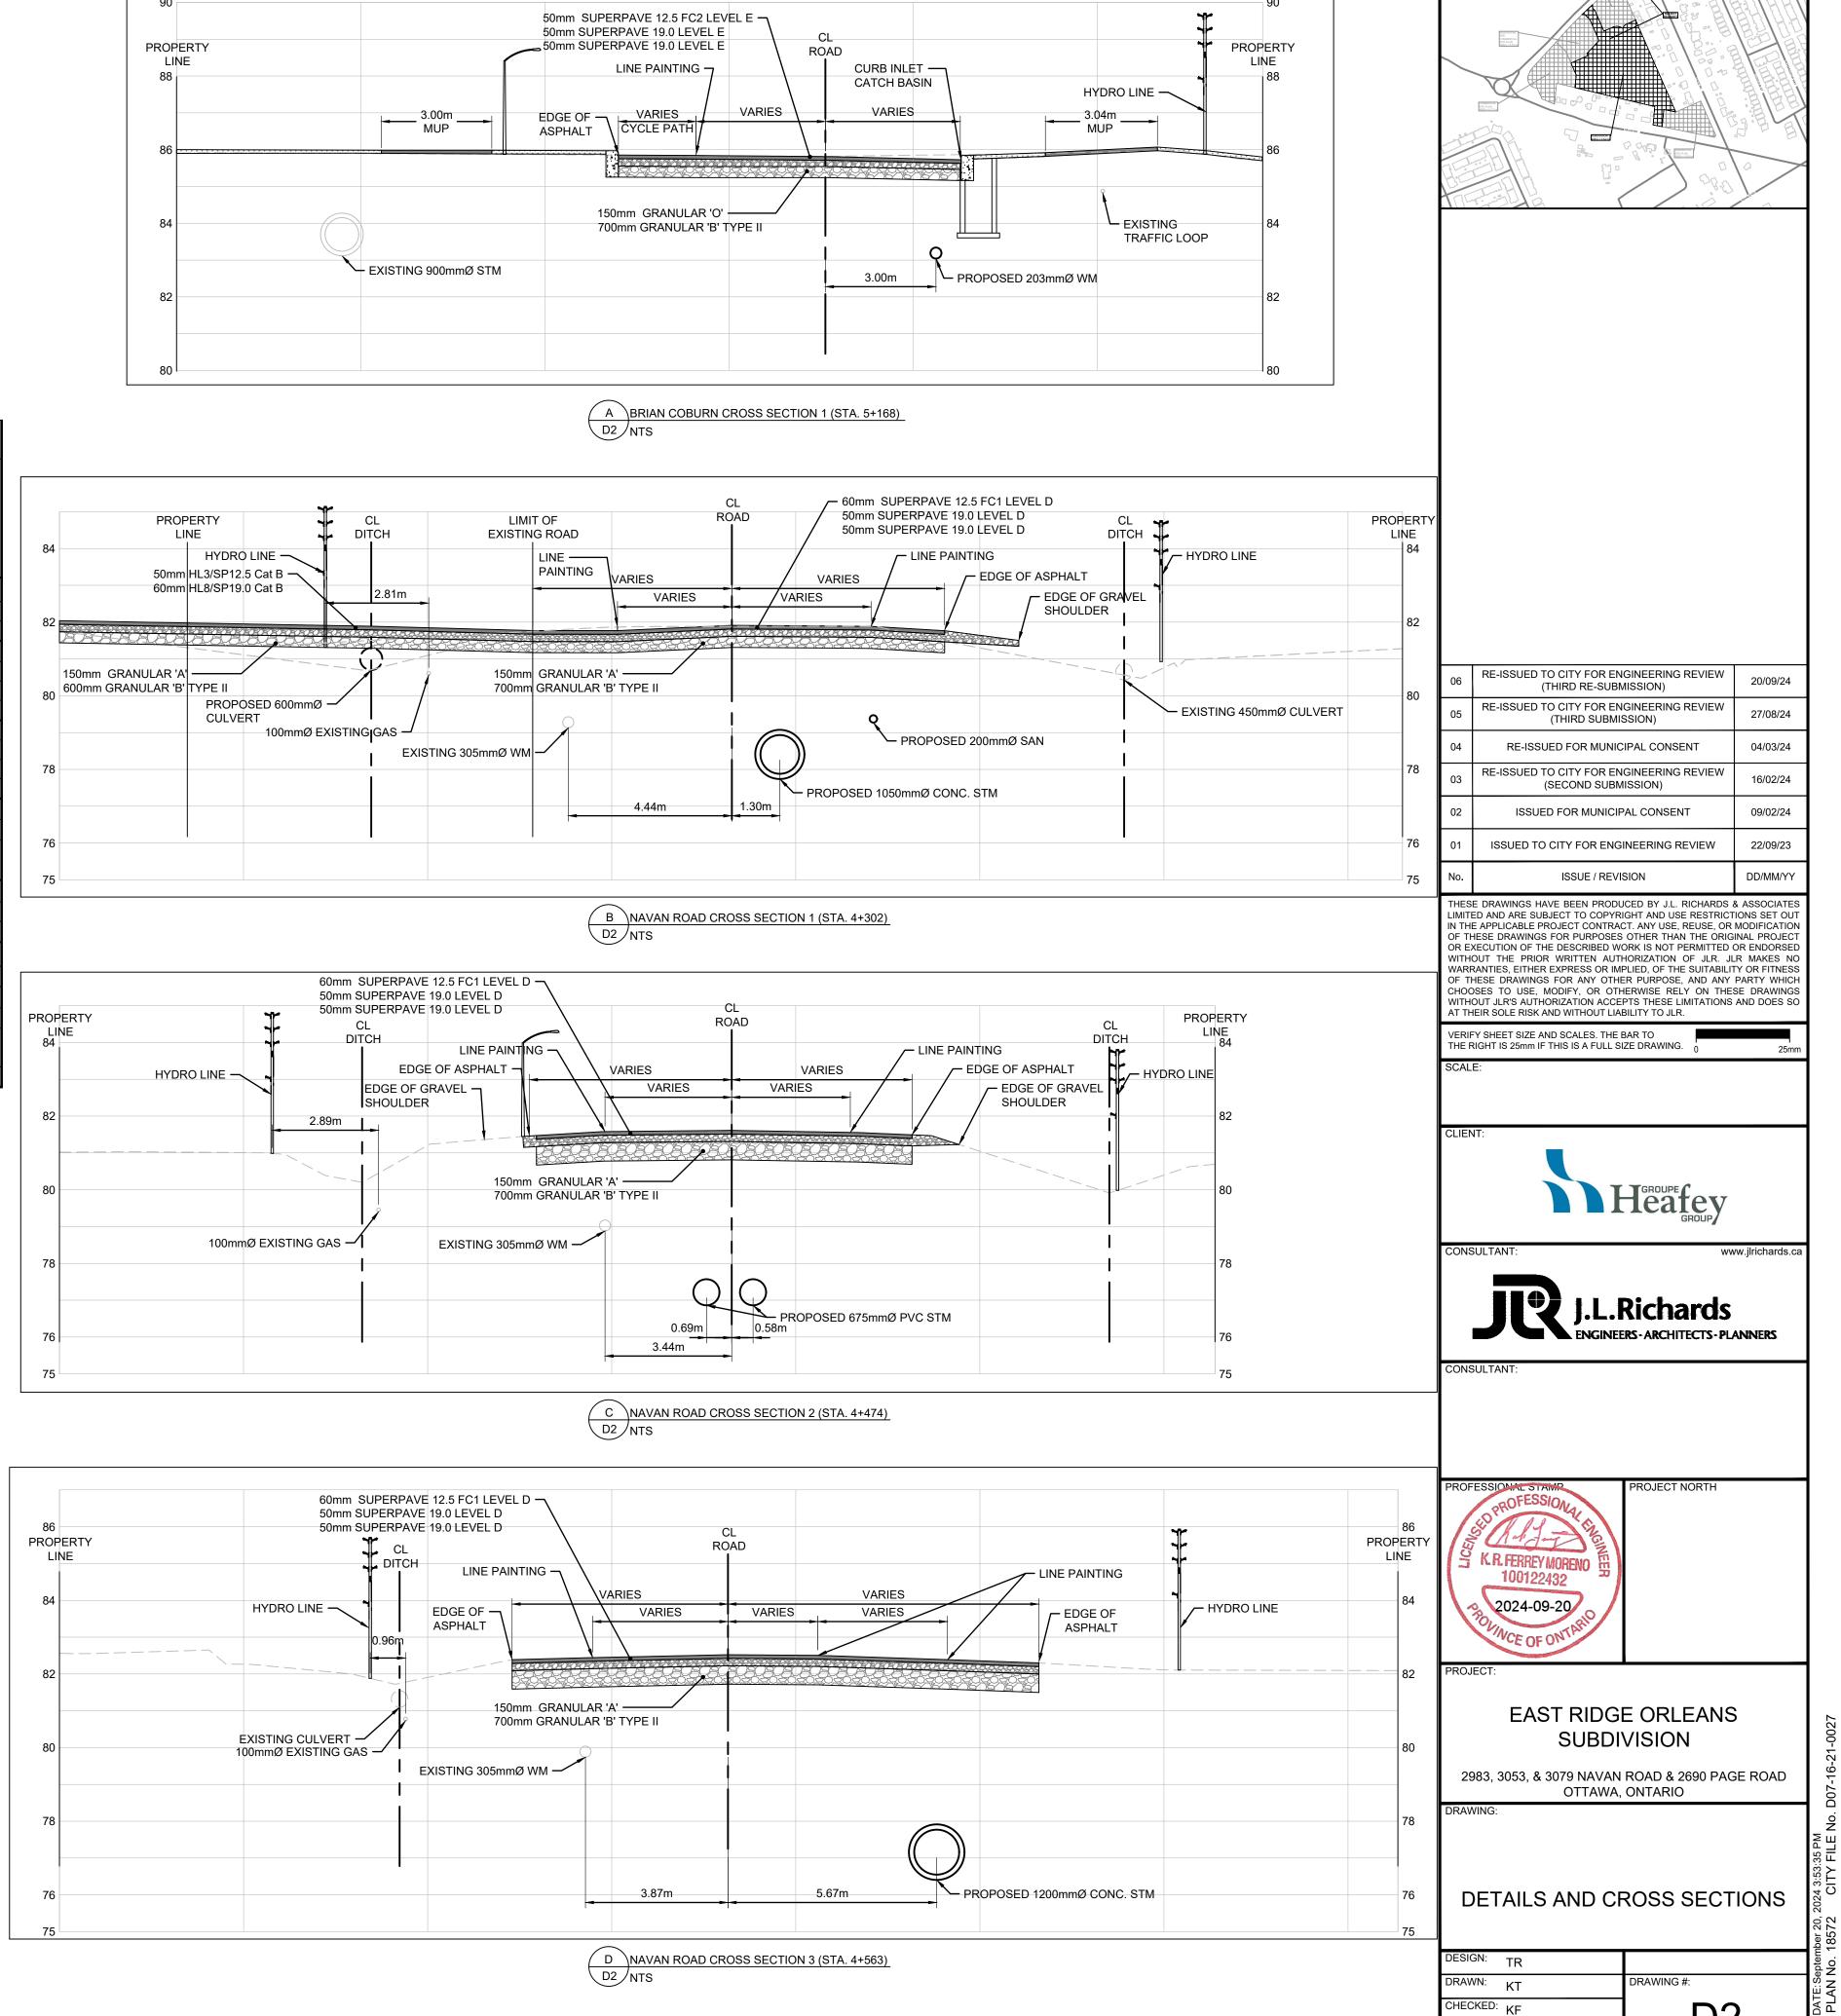

KEY PLAN N.T.S